

SITE ID: SAL EL MONTE SITE ID NUMBER: 5000232110 SITE ADDRESS: 1851 VALLEY DR.

OGDEN, UT 84404-6061 SITE COORDINATES: 41.23956911, -111.92802336

SITE CONFIGURATION: MW ADD

SAL EL MONTE

SAL EL MONTE, UT

OGDEN, UT 84404-6061

1851 VALLEY DR.

WEBER COUNTY

WEBER COUNTY

**FOUIPMENT SHELTER** 

PACIFICORP 1.888.221.7070

13-071-0010

41.23956911

5000232110

	SHEET INDEX		
SHEET	DESCRIPTION		
T1.0	COVER SHEET		
T2.0	OVERALL SITE PLAN		
T2.1	ENLARGED SITE PLAN		
T3.0	ex. & new equipment layouts		
T4.0	ex. & new elevations		
T5.0	EQUIPMENT DETAILS		
T5.1	EQUIPMENT DETAILS		



SAL EL MONTE SITE ADDRESS:

1851 VALLEY DR. OGDEN, UT 84404-6061

SITE COUNTY:

WEBER COUNTY

SITE ID:

5000232110

REVISIONS

## SITE INFORMATION

SITE INFORMATION SITE NAME: SITE ID: ATC SITE NAME ATC SITE NUMBER SITE ADDRESS:

COUNTY: JURISDICTION ASSESSOR'S PARCEL # LATITUDE:

STRUCTURE TYPE: STRUCTURE HEIGHT

POWER PROVIDER:

PROJECT DESCRIPTION MODIFICATION OF AN EXISTING "NON-INHABITABLE" VERIZON TELECOMMUNICATIONS SITE CONSISTING OF:

- (2) NEW BALLAST MOUNTS
- (2) NEW MICROWAVE ANTENNAS (2) NEW MICROWAVE RADIOS
- (1) NEW RACK MOUNTED RADIO LINK
- (1) NEW RACK MOUNTED OVP

WITHIN THE EXISTING EQUIPMENT SHELTER.

INSTALLATION IS UNMANNED AND NOT FOR HUMAN HABITATION PUBLIC ACCESS IS RESTRICTED A.D.A. ACCESSIBILITY NOT REQUIRED

## PROJECT TEAM

PROPERTY OWNER:

1851 VALLEY DR.

OGDEN, UT 84404

WOBURN, MA 01801

RAINBOW GARDENS CORP.

TOWER OWNER: AMERICAN TOWER CORP. 10 PRESIDENTIAL WAY

10000 PARK MEADOWS DR.

LONE TREE, COLORADO 80124

1S660 MIDWEST RD. SUITE 140

OAKBROOK TERRACE, IL 60181

A&E PROJECT MANAGER INSITE INC. 1S660 MIDWEST RD. SUITE 140 OAKBROOK TERRACE, IL 60181

E-MAIL: DIBONA@INSITE-INC.COM

E-MAIL: MOSSMAN@INSITE-INC.COM

GREG DIBONA

PH: 847.257.2489

COLE MOSSMAN

PH: 970.819.0335

SITE ACQUISITION CONSULTANT

ENGINEER OF RECORD INSITE INC. 1S660 MIDWEST RD. SUITE 140 RYAN GUERRERO

OAKBROOK TERRACE, IL 60181 PH: 970.690.6921 E-MAIL: GUERRERO@INSITE-INC.COM

## FROM SALT LAKE CITY INTERNATIONAL AIRPORT:

GET ON I-80 E FROM N 3700 W AND W CROSSBAR RD. 7 MIN (3.2 MI). HEAD SOUTH ON N 3700 W TOWARD 510 N. 0.9 MI. N 3700 W TURNS SLIGHTLY RIGHT AND BECOMES W CROSSBAR RD. 0.7 MI. TAKE THE RAMP ONTO TERMINAL DR. 0.5 MI. USE THE LEFT 2 LANES TO TAKE THE I-80 E RAMP TO CITY CTR/OGDEN/PROVO. 0.7 MI. USE THE RIGHT LANE TO KEEP LEFT AT THE FORK, FOLLOW SIGNS FOR I-80 E AND MERGE ONTO I-80 E. 0.4 MI. TAKE UT-67 N/LEGACY PKWY AND US-89 N/N HWY 89 TO S 1200 E ST/HARRISON BLVD IN SOUTH OGDEN. 29 MIN (30.2 MI). MERGE ONTO I-80 E. 0.6 MI. USE THE RIGHT 2 LANES TO TAKE EXIT 117 TO MERGE ONTO I-215 N TOWARD OGDEN. 5.0 MI. USE THE LEFT 2 LANES TO TAKE EXIT 26 FOR LEGACY PKWY N. 0.5 MI. CONTINUE ONTO UT-67 N/LEGACY PKWY. 11.0 MI. USE THE LEFT 2 LANES TO TAKE EXIT 11 TO MERGE ONTO JS-89 N/N HWY 89 TOWARD SO OGDEN. 13.1 MI. CONTINUE ON S 1200 E ST/HARRISON BLVD. DRIVE TO 1420 ST S/OLD CANYON RD. 14 MIN (7.1 MI). TURN RIGHT ONTO S 1200 E ST/HARRISON BLVD. PASS BY WENDY'S (ON THE RIGHT IN 0.3 MI). 6.1 MI. TURN RIGHT ONTO 1420 ST S/OLD CANYON RD. 285 FT.

**DRIVING DIRECTIONS** 

ESTIMATED DISTANCE: 40.5 MILES STIMATED TIME: 47 MINUTES

### APPLICABLE CODES

ALL CONSTRUCTION, ALTERATION, OR DEMOLITION SHALL BE PERFORMED AND MATERIALS INSTALLED IN ACCORDANCE WITH THE CURRENT EDITIONS OF THE FOLLOWING CODES AS ADOPTED BY THE LOCAL GOVERNING AUTHORITIES TO INCLUDE COMPLIANCE WITH THE LATEST FEDERAL STATE, AND LOCAL AMENDMENTS,

2021 IECC, 2021 IBC, 2021 IEBC, 2021, IRC, 2021 IMC, 2021 IPC, 2021 IFGC, 2020 NEC



Call before you dig.

UTILITIES, AT LEAST TWO WORKING DAYS PRIOR BEFORE YOU DIG, CALL: 1-800-662-4111 ITTP://CALL811.COM/MAP-PAGE/UTAH

MANDATORY: CONTRACTOR TO CALL TO VERIFY

THE INFORMATION CONTAINED IN THIS SET OF DOCLIMENTS IS PROPRIETARY BY NATURE ANY USE OR DISCLOSURE OTHER THAN THAT WHICH RELATES TO VERIZON SERVICES IS STRICTLY PROHIBITED.

# VICINITY MAP



# SITE PHOTO



### REFERENCE DOCUMENTS

**DOCUMENT NAME** DATE

EX. CONSTRUCTION DRAWINGS; LAB


**COVER SHEET** 

SHEET TITLE

SHEET NUMBER:			)
	T1.0		
DRAWN BY:	CHK BY:	APV BY:	
GW	СМ	СМ	

07.28.23 100% CONSTRUCTION GW STAMPING ŞIGNATURE

**RYAN THOMAS GUERRERO** 

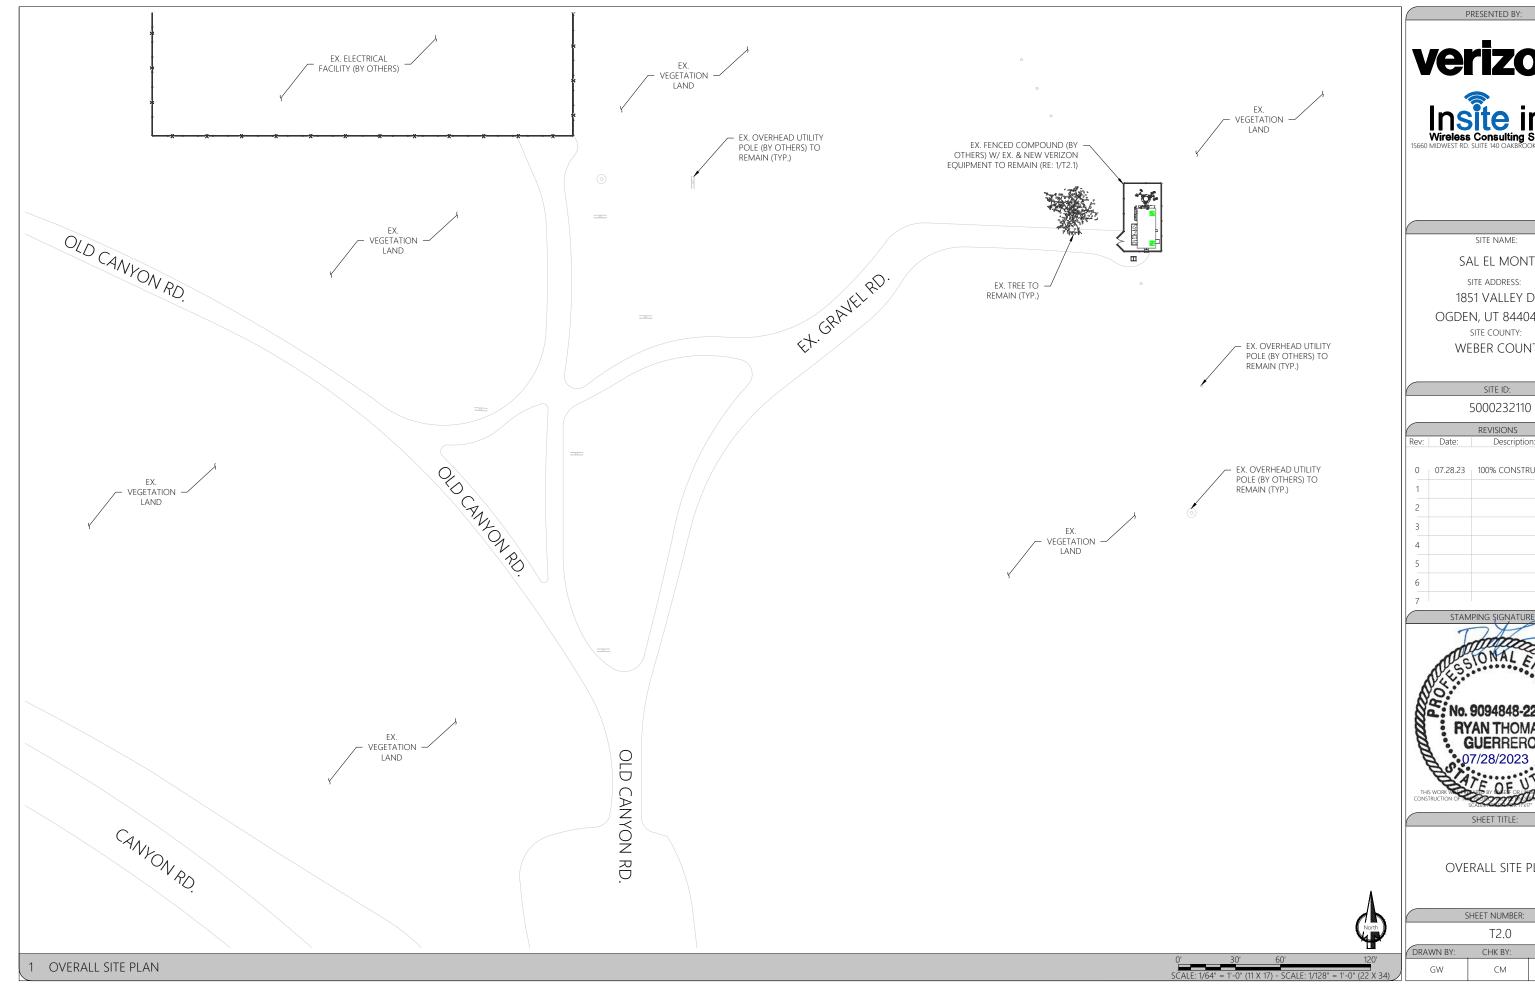



SAL EL MONTE SITE ADDRESS: 1851 VALLEY DR.

OGDEN, UT 84404-6061


WEBER COUNTY

(		REVISIONS	
Rev:	Date:	Description:	By:
0	07.28.23	100% CONSTRUCTION	GW
1			
2			
3			
4			
5			
6			
7			



OVERALL SITE PLAN

SHEET NUMBER:			
	T2.0		
DRAWN BY:	CHK BY:	APV BY:	
GW	СМ	СМ	

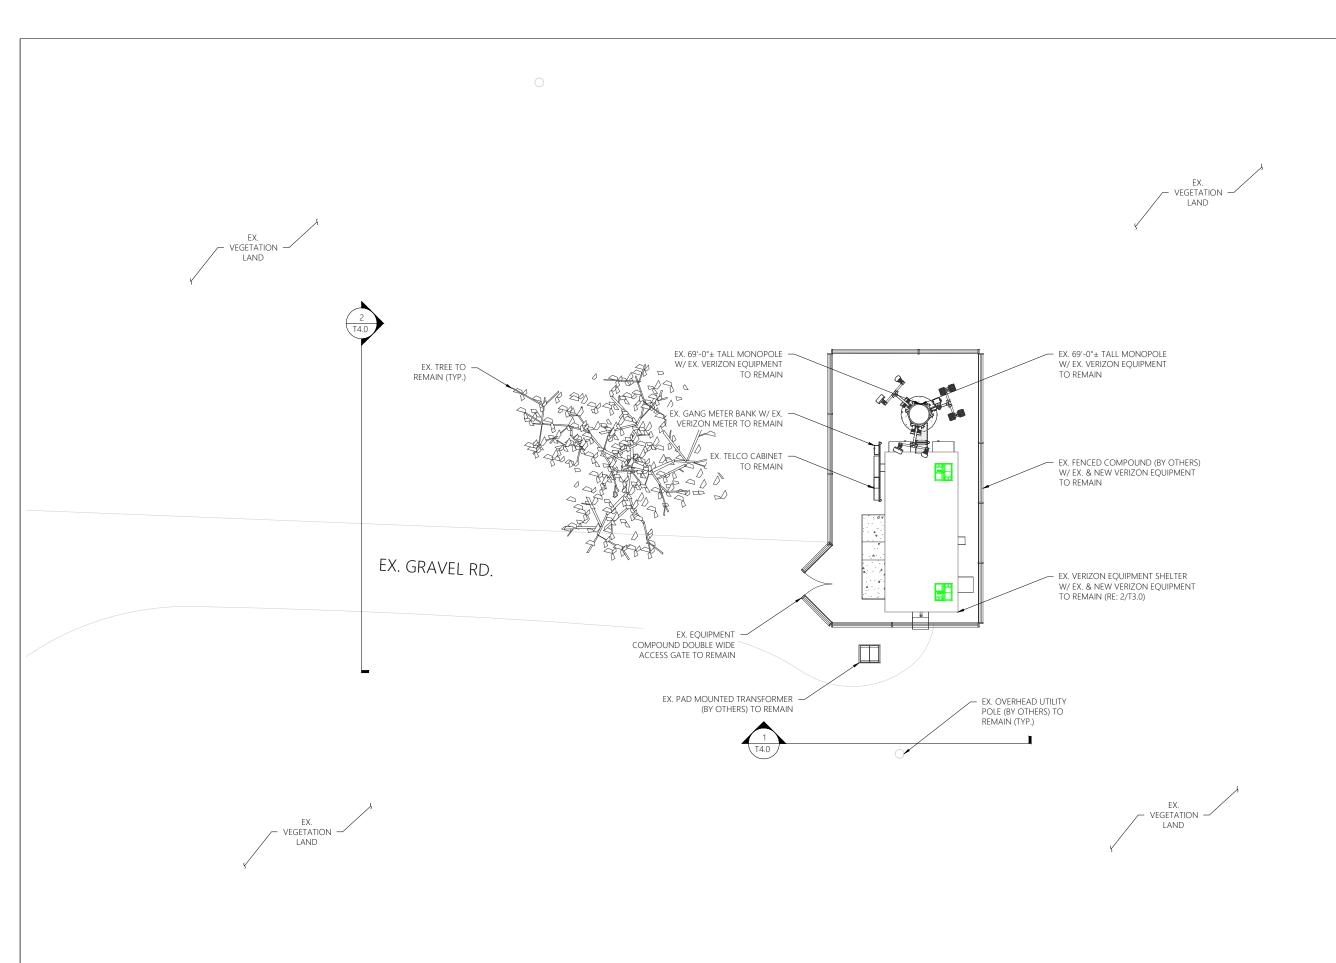





SITE NAME:

SAL EL MONTE

SITE ADDRESS:

1851 VALLEY DR.

OGDEN, UT 84404-6061

SITE COUNTY:

WEBER COUNTY

SITE ID: 5000232110




SHEET TITLE:


ENLARGED SITE PLAN

SHEET NUMBER:			
	T2.1		
DRAWN BY:	CHK BY:	APV BY:	
GW	СМ	СМ	

1 ENLARGED SITE PLAN

0' 8' 16' 32' SCALE: 1/16" = 1'-0" (11 X 17) - SCALE: 1/8" = 1'-0" (22 X 34)

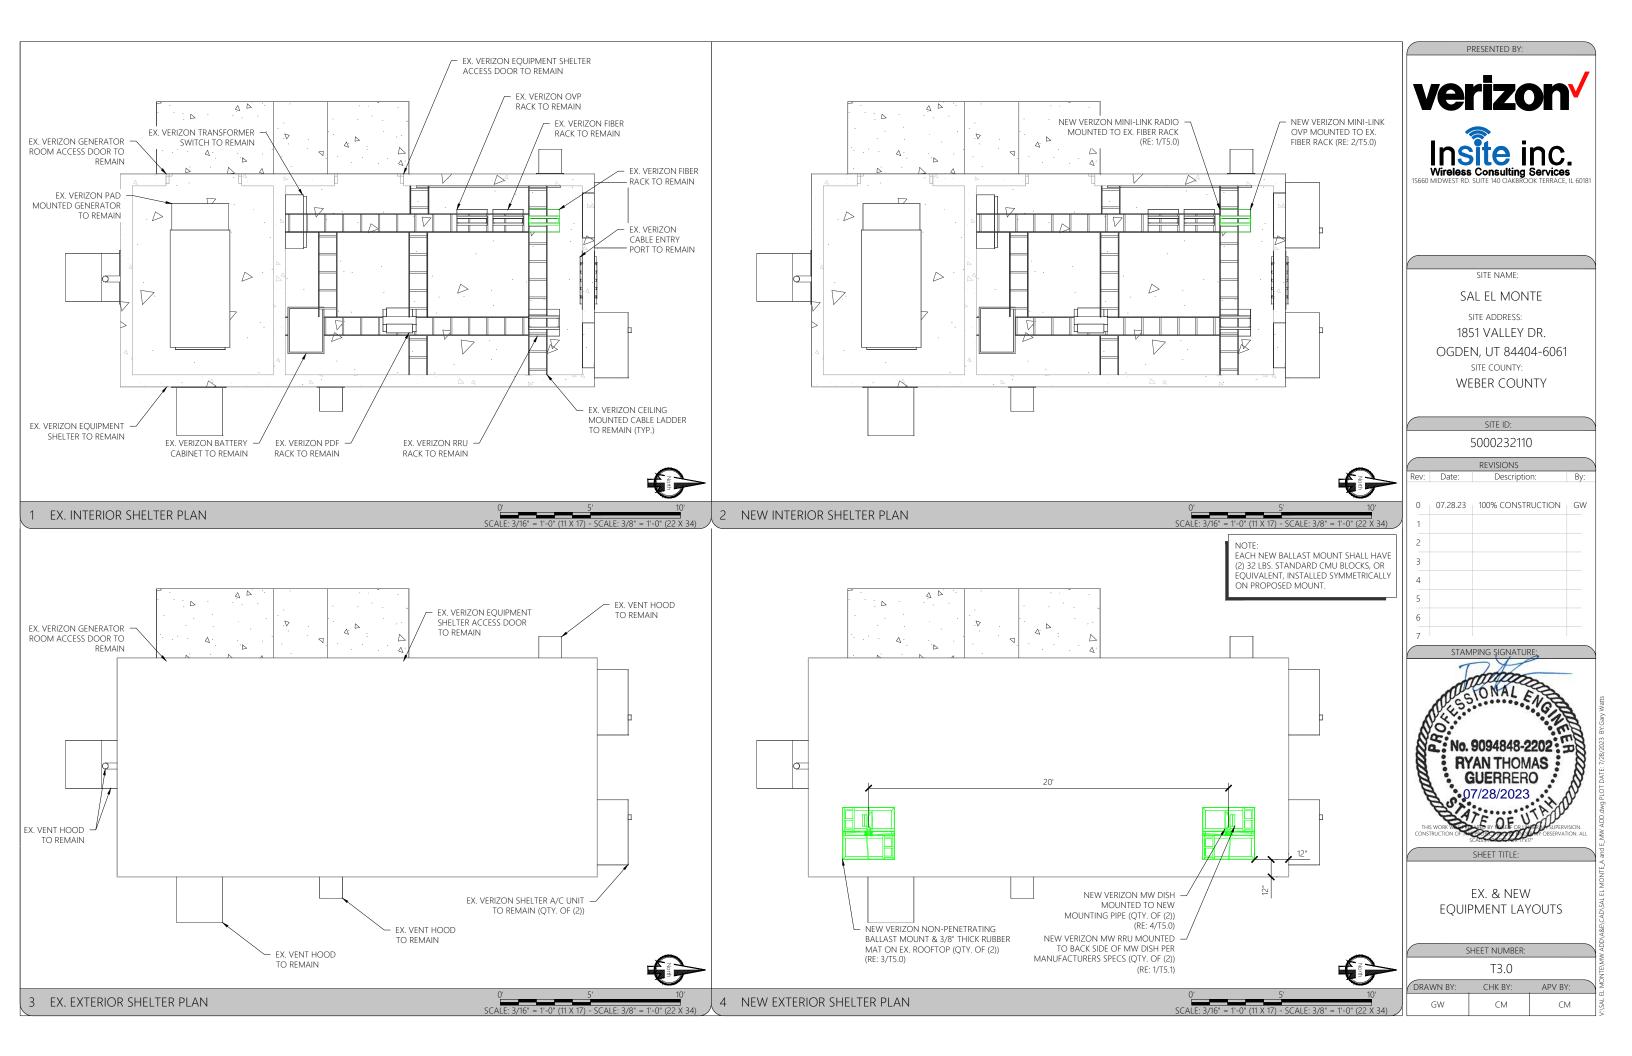

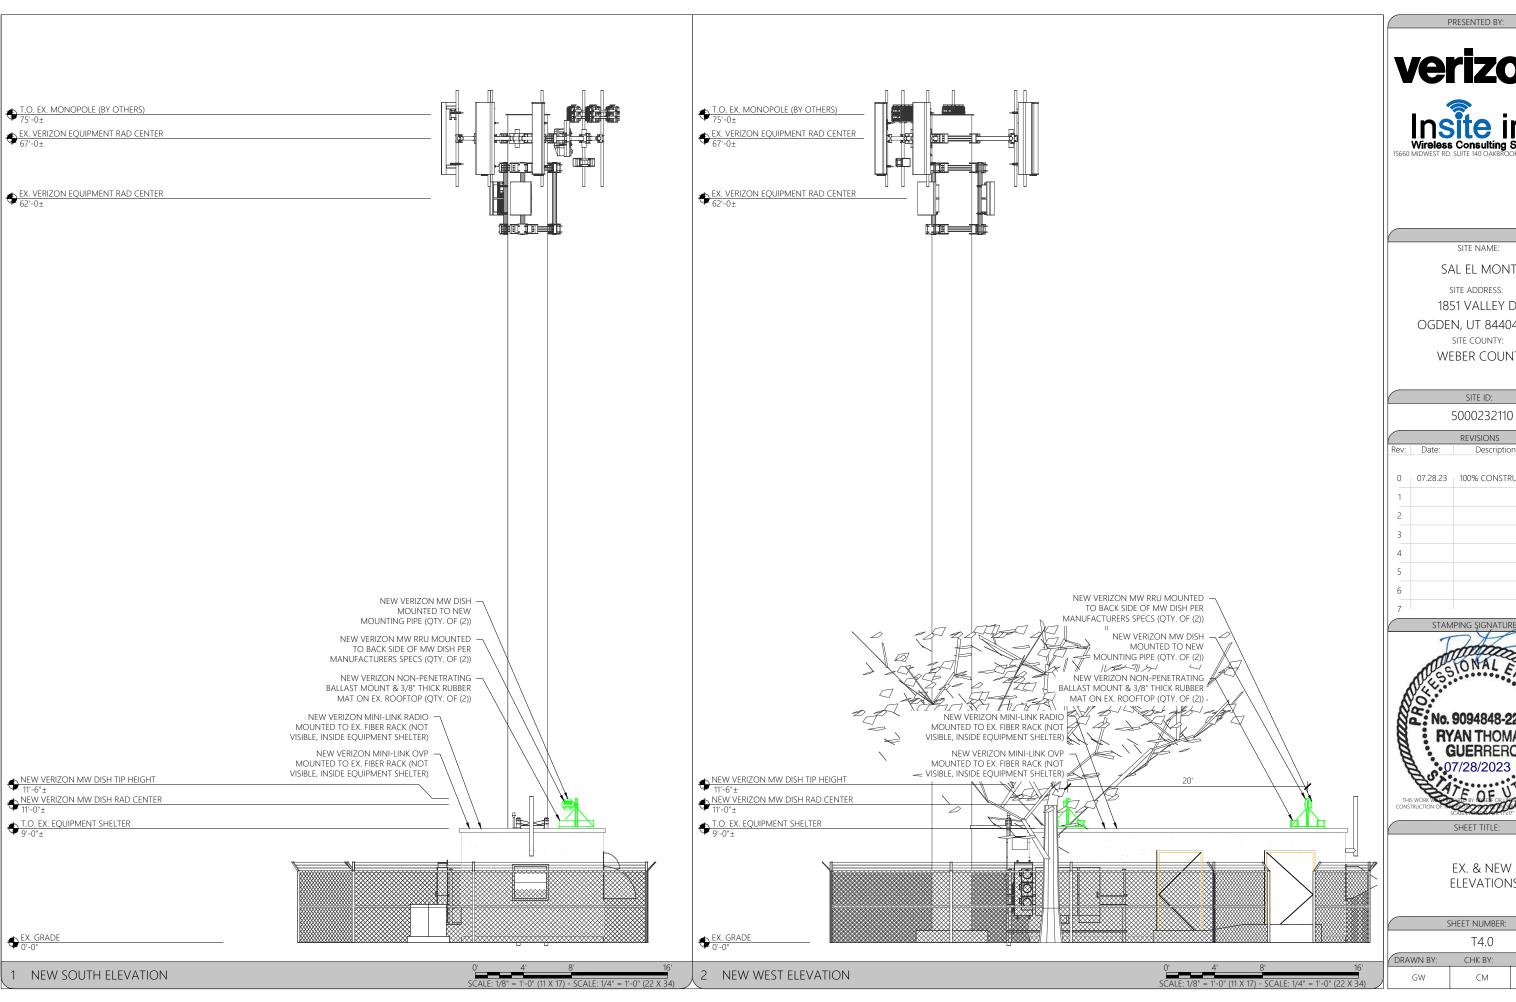



SITE NAME:

SAL EL MONTE SITE ADDRESS: 1851 VALLEY DR. OGDEN, UT 84404-6061 SITE COUNTY: WEBER COUNTY

> SITE ID: 5000232110

REVISIONS Rev: Date: Description 0 | 07.28.23 | 100% CONSTRUCTION | GW



SHEET TITLE:

EX. & NEW **ELEVATIONS** 

SHEET NUMBER: T4.0 DRAWN BY: CHK BY: APV BY: CM CM

# MINI-LINK 6651/3 Compact end node



MINI-LINK 6651/3

Compact high performance 1 RU radio link

Fanless design

Support for up to 7-112MHz channel bandwidth and up to 4096QAM modulation

> EACH NEW BALLAST MOUNT SHALL HAVE (2) 32 LBS. STANDARD CMU BLOCKS, OR EQUIVALENT, INSTALLED SYMMETRICALLY

> > INSTALL NEW ROHN R-FRMP 3/8" RUBBER PADS BETWEEN ROOF AND BALLAST MOUNT

ON PROPOSED MOUNT

Radio link capacity up to 1.4Gbps in a 112 MHz channel Supports Adaptive Code Modulation

- Built in 14.5 Gbps Ethernet switch/router
- Customer and Provider bridge, QoS, HQoS
- Support for up to 128 L3 VPNs
- Synchronous Ethernet, 1588v2 Time/Phase sync

1 coax interfaces for Radio Link connection using RAU2X or MINI-LINK 6363/6364/6365

- 4 x 1G/2.5 G SFP
- 2 x FE/1G RJ45 8xE1
- Local Management
- Power supply: -48V



# Power 6393

POWER 6393, MODULAR POWER SUPPLY POWER 3693 IS A MODULAR POWER SUPPLY CONCEPT. THAT CAN SUPPORT WITHER AC OR DC INPUT POWER, FOR LOW POWER APPLICATIONS UP TO 200W. THE MODULAR SOLUTION CONTAINS OF TWO MAIN UNIT:

POWER 6393 DC MAIN UNIT

THE MAIN UNITS CAN BE CONFIGURED WITH EITHER ONE OR TWO OUTPUT MODULES (PDUs). THE PDU'S ARE AVAILABLE IN THREE VARIANTS:

PDU 40 02: 1 PORT POWER OVER ETHERNET WITH LIGHTNING PROTECTION

PDU 40 03: 2 PORT -48 VDC WITH LIGHTNING PROTECTION

THE OUTPUT DC POWER CAN BY FED THROUGH POWER CABLE OR BY POWER OVER ETHERNET (POE) THROUGH AN ETHERNET

THE COMPACT POWER 6393 FOLLOWS ERICSSON RADIO

TO SUPPORT VARIOUS INSTALLATION SCENARIOS, A WIDE RANGE OF CABLE DIAMETERS ARE SUPPORTED. POWER 6393 IS PROTECTED FOR OVER VOLTAGE EXPOSURES AND IS POSSIBLE TO BE EQUIPPED WITH LIGHTNING PROTECTED MODULES.



PDU 40 01





PDU 40 03



### Technical specification for Power 6393



1-port PoE Injector with lightning protection on PoE port 2-port 55 VDC module with lightning

OLITPLIT MODULE CAPACITY

POWER 6393 total output PDU 40 01 IEEE 802.3at: ≤31 W or ERICSSON proprietary: ≤100 W PDU 40 02 IEEE 802.3at: ≤31 W or ERICSSON proprietary: ≤100 W

PDU 40 03 Power ≤200 W (each port can handle all available power)

All modules

PROTECTION Short Circuit Protection

Yes (PDU 40 02 and PDU 40 03)

CLASS B, EN 55022


LED indicators Power, fault, warning

Channel Link Class D according to ISO 11801

200 x 200 x 100 mm 3 kg Indoor, Outdoor Wall. Pole IP66 (IEC 60529) Type 3 (LIL 50F)

## 1 ERICSSON MINI-LINK 6651 RADIO DETAIL

# SCALE: NTS SCALE: NTS

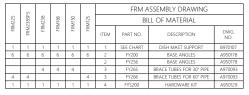


FYS200 BILL OF MATERIAL			
QTY.	PART NO.	DESCRIPTION	
3	220390	BOLT 5/16" x 3-1/2" (CARRIAGE)	
12	220205	BOLT 5/16" x 3/4" (CARRIAGE)	
15	240014	NUT 5/16"	
15	250060	LOCK WASHER 5/16"	

- SE MALAST DATA SHOULD BE DETERMINED BY A LOCAL PROFESSIONAL 
  BRILAST DATA SHOULD BE DETERMINED BY A LOCAL PROFESSIONAL 
  PROVIDED BY O'HERS OF PREVENT OVERTURNING AND DRY 
  PROVIDED BY O'HERS TO PREVENT O'HER VIRTURNING AND SUBMOR AT THE 
  DESIGN WIND LOAD (REER TO SHEET 2) 
  PRINCE TO INSTALLATION VERBY THAT THE INSTALLATION, ROOF MATERIAL 
  AND SUPPORTING STRUCTURE HAVE BEEN INVESTIGATED AND FOUND 
  ACAPIBLE OF WITH TAXIONING ALL LOADS MINOSES BY THE PROPOSED 
  AND ACREASE TO SHAP THAN ON THE ALL THAT 
  ON THAT THE PROPOSED 
  IN THE SHAPE SHAPE SHAPE SHAPE SHAPE AND THAT THE 
  INSTALLATION WILL BE IN COMPLIANCE WITH ALL APPLICABLE LOCAL STATE 
  AND FEBRAR ARCHIOMS FROM THE ANTENNA SYSTEM AND THAT THE 
  INSTALLATION WILL BE IN COMPLIANCE WITH ALL APPLICABLE LOCAL STATE 
  ALL ANTENNA INSTALLATIONS MUST BE GROUNDED TO MEET APPLICABLE 
  COOSES.

PART NUMBER SAFETY CABLE LENGTH

WHEN ASSEMBLING THE FRAMES IT IS BEST TO ASSEMBLE ALL TURES AND ANGLES LOOSE, AFTER THE TUBE BRACES ARE IN PLACE AND SQUARE, THEN GO BACK AND INGERIEN DOWN ALL BOLTS.
ROHN RECOMMENDS THAT ALL BALLAST MATERIAL ALWAYS BE PLACED PRIOR TO MOLUTHING ANTENNAS AND THAT THE MOUNT BE SCURED TO PREVENT HAZARDS FROM OCCURRING UNDER EXTREME WIND LOADING CONDITIONS. PRECAUTIONS SHOULD BE TAKEN TO PREVENT HAD AND TO INSURE THAT THE MOST BOUND THE THE NOT ALLAST MATERIAL AFTER INSTALLATION AND TO INSURE THAT THE SESSIOLTS ARE PROVIDED WITH THE NOT ALLAST MATERIAL AFTER INSTALLATION AND TO INSURE THAT THE ASSEMBLY AND THE MATERIAL AFTER INSTALLATION AND TO DISCUSS THAT THE ASSEMBLY AND THE MATERIAL AFTER INSTALLATION AND TO DISCUSS THAT THE ASSEMBLY AND THE MATERIAL AFTER INSTALLATION AND TO DISCUSS THAT THE ASSEMBLY AND THE MATERIAL AFTER INSTALLATION AND TO DISCUSS THE PROVIDED WITH ACKNOR DEVICES. INSPECT MOUNT, ANTENNA AND TIGHTNESS OF NUTS AT SIX MONTH MAXIMUM INTERVALS.

# ERICSSON POWER 6393 OVP DETAIL

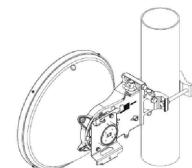

# ANT3 B 0.3 28 HP

BOX CONTAINING BOTH THE ANTENNA MODULE AND THE INTERFACE MODULE. THE TWO MODULES ARE EASILY ASSEMBLED AT SITE. THE INTERFACE MODULE IS REPLACEABLE, ENABLING EASY FIELD UPGRADES. MAJOR BENEFITS INCLUDE:

NO ANTENNA RE-ALIGNMENT

### Technical Specifications for ANT3 B 0.3 28 HP

MECHANICAL SPECIFICATIONS	Weight	5 kg
	Dimensions	387 mm ( Product Height ) 387 mm ( Product Width ) 220 mm ( Product Depth )
	Mounting options	Pole/Mast
	Volume	33 I
CERTIFICATIONS	Encapsulation class	IP65
INTERFACES	Input connector	154 IEC-UBR 260
ANTENNA	Antenna type	HP
	Antenna diameter	0.3 m
	Antenna polarization	Single polarization - Vertical or Horizon
RADIO SPECIFICATIONS	Antenna frequency band	27500 MHz ( Frequency Min ) 29500 MHz ( Frequency Max )
	Antenna gain	38.2 dBi ( Low Band Gain ) 38.4 dBi ( Mid Band Gain ) 38.8 dBi ( High Band Gain )
	Antenna half power beam width	2.2 *
	Antenna cross polar discrimination (XPD)	30 dB
	Return loss, minimum	14 dB
	Minimum front to back ratio (F/B)	64 dB
RADIO SPECIFICATIONS	Frequency	27.5-29.5 GHz
ADDITIONAL INFORMATION	Frequency	28 GHz

MECHANICAL SPECIFICATIONS	Weight	5 kg
	Dimensions	387 mm ( Product Height ) 387 mm ( Product Width ) 220 mm ( Product Depth )
	Mounting options	Pole/Mast
	Volume	33
CERTIFICATIONS	Encapsulation class	IP65
INTERFACES	Input connector	154 IEC-UBR 260
ANTENNA	Antenna type	HP
	Antenna diameter	0.3 m
	Antenna polarization	Single polarization - Vertical or Horizontal
RADIO SPECIFICATIONS	Antenna frequency band	27500 MHz ( Frequency Min ) 29500 MHz ( Frequency Max )
	Antenna gain	38.2 dBi ( Low Band Gain ) 38.4 dBi ( Mid Band Gain ) 38.8 dBi ( High Band Gain )
	Antenna half power beam width	2.2 *
	Antenna cross polar discrimination (XPD)	30 dB
	Return loss, minimum	14 dB
	Minimum front to back ratio (F/B)	64 dB
RADIO SPECIFICATIONS	Frequency	27.5-29.5 GHz
ADDITIONAL INFORMATION	Frequency	28 GHz
	Integration interface	ANT3

PRESENTED BY: verizon<sup>/</sup>

SITE NAME:

SAL EL MONTE

SITE ADDRESS:

1851 VALLEY DR. OGDEN, UT 84404-6061

SITE COUNTY:


WEBER COUNTY

SITE ID: 5000232110

REVISIONS Date: Description

SCALE: NTS

0 + 07 28 23 + 100% CONSTRUCTION + GW

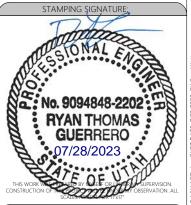

SHEET TITLE:

**EQUIPMENT DETAILS** 

SHEET NUMBER: T5.0

DRAWN BY: CHK BY: APV BY: СМ

BFZ62251/3S09H


0.3 M 28 GHz, HIGH PERFORMANCE, SINGLE POLARIZED ANTENNA

INTEGRATED ANTENNA FOR MINI-LINK 6363.

THIS IS A COMPLETE MODULAR ANTENNA DELIVERED IN A SINGLE

- EASY UPGRADE FROM SINGLE POLARIZED TO DUAL POLARIZED
- REDUCED TRAFFIC DISTURBANCE

BALLAST MATERIAL DETAIL

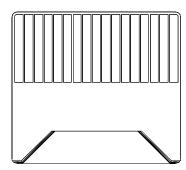

# MINI-LINK 6363

### MINI-LINK 6000

MINIT-LINAR DUDU
WITH LINAR CHED FLEMBLITY, MINI-LINK 6000 PROVIDES THE RIGHT SOLUTION FOR EACH PART OF THE NETWORK, ALL
DEPLOYMENT SCENARIOS AND SITE TYPES, ENABLING SOUND INVESTMENTS IN LINE WITH THE SERVICE PROVIDERS'
NEEDS. THE PORTFOLIO GFERES BOTH SPLIT MOUTAT AND ALL OUTDOOR SHORTHALL AS WELL AS LONG HAUL
SOLUTIONS COVERING THE COMPLETE MICROWAVE SPECTRUM FROM 4 UP TO 80 GHz, MINI-LINK 6000 OFFERS
ADVANCED PACKET FULNCTIONALITY INCLIDIONS AD ADVANCED SYNC AND 13 YPM, LISING IPMPLS, AS WELL AS 12. ALL
NETWORK SCENARIOS ARE SUPPORTED WITH SUPERIOR PERFORMANCE COMBINED WITH THE LOWEST POSSIBLE COST

INCREASED INGRESS PROTECTION
THE RADIO LINIT CAN BE INSTALLED IN VERY HAS COMBINATIONS WITH A TRADITIONAL FREQUENCY BAND. OF OWNERSHIP.

ERICSSON IS THE MARKET LEADER IN MICROWAVE TRANSMISSION AND HAS OVER 40 YEARS OF MICROWAVE EXPERIENCE WITH MORE THEN 4.5 MILLION RADIO UNITS DELIVERED TO OVER 180 COUNTRIES.

HIGH CAPACITIES IN A COMPACT FORMAT

THE MINI LINK 5000, MINI-LINK TH AND MINI-LINK KDN IT CONNECTS TO THE NODE VIA A COAXIAL CABLE. IN A VERY
HIGH COTPUT POWER CATES FOR THE NEED OF HIGH CAPACITIES AND HIGH AVAILABILITY, PROVIDING SUPERIOR

ATEX CERTIFIED

WITH ATEX CERTIFICATION MINI-LINK 6363 CAN BE USED IN POTENTIALLY EXPLOSIVE

ATMOSPHERES (ZONE 2).

ATMOSPHERES (ZONE 2).

### WORLD'S SMALLEST HIGH POWER RADIO

WUNCLD 3 SIMALLEST FIIGHT POWER RADIO

MINI-LINK 6363 BUILDS ON THE STRENGTHS FROM THE WORLD'S MOST WIDELY DEPLOYED MICROWAVE RADIO

MINI-LINK RAUZ X. THE FOOTPRINT HAS BEEN REDUCED BY 65%, AND WEIGHT BY 35% COMPARED TO RAUZ X. THIS

ENABLES EASIER AND FASTER INSTALLATIONS AS WELL AS LESS WIND LOAD ON TOWERS.

MINI-LINK 6363 COMES IN TWO VERSIONS. MINI-LINK 6363, OPTIMIZED FOR HIGHEST SYSTEM GAIN, AND MINI-LINK 636/2 OPTIMIZED FOR LOWEST POWER CONSUMPTION.

SUPERIOR OUTPUT POWER

MINI-LINK 583 HAS THE HIGHEST OUTPUT POWER IN THE SPLIT MOUNT RADIO

MARKET, THAT IS MAINTAINED ALSO FOR HIGHER MODULATIONS. FOR 24-42 GHZ THE

OUTPUT POWER HAS BEEN INCREASED WITH UP TO 4 dB COMPARED TO RAUZ X.'S

ALREADY HIGH SPECIFICATION. THIS MEANS MORE CAPACITY, HIGH AVAILABILITY AND

SMALLER ANTENNAS. IN COMBINATION WITH FUNCTIONALITY IN THE MODE, A

SUPERIOR SYSTEM GAIN IS OBTAINED. HIGH OUTPUT POWER IS AVAILABLE AS A SW

LICENSE, WHICH MAKES IF POSSIBLE TO STEP UP IN MODULATION AND CAPACITY

WHEN NEEDED, FOLLOWING A PAY AS YOU GROW APPROACH.

BEST IN CLASS DYNAMIC RANGE
MINI-LINK 6363 HAS BEST IN CLASS DYNAMIC RANGE, WHICH IS CRUCIAL TO REDUCE
INTERFERENCE (USING ATPC), REDUCE POWER CONSUMPTION AND BE ABLE TO
INSTALL SHORT HOPS.

Frequencies

REDUCED POWER CONSUMPTION
THE POWER CONSUMPTION IN MINI-LINK 6363 HAS BEEN REDUCED COMPARED TO
RAULZ K. FOR 6-11 CHz BY UP TO 10 W. FOR MINI-LINK 6363/2 THE POWER
CONSUMPTION HAS BEEN OPTIMIZED EVEN FURTHER, TYPICALLY BY AN ADDITIONAL
25% vs MINI-LINK 6363.

Weight
Weight
Weight
Pomer Supply

# HIGH CAPACITIES IN TRADITIONAL FREQUENCY BANDS THE RADIO UNIT ALSO SUPPORTS 112 MHz WIDE CHANNELS AND A MODULATION OF 8K QAM (8192 QAM), WHICH PROVIDES CAPACITIES OVER 1 Gbps.

WORLDS FIRST SPLIT MOUNT E-BAND RADIO WORLDS FIRST SPLIT MOUNT E-BAND RADIO
MIN-LINK G363 OFFERS A COST EFFCIENT ACCESS TO THE E-BAND SPECTRUM, WITH
REUSE OF NODES AND COAVALL CABLING. IT SUPPORTS BOTH TDM AND PACKET
TRANSPORT. GIGABIT CAPACITY IS PROVIDED THROUGH 1024 OAM MODULATION
SUPPORT. IT ENABLES MULTI-BAND BOOSTER IN SPLIT MOUNT CONFIGURATIONS, IN

THE RADIO UNIT CAN BE INSTALLED IN VERY HARSH ENVIRONMENTS AS IT FULFILLS

Standards and recommendations IP66 PROTECTION AGAINST DUST AND WATER.

### BACKWARD COMPATIBILITY

MODULAR ANTENNAS AND FLAT PANEL ANTENNAS
MINI-LINK 6363 JUSES THE SAME ANTENNA PORTFOLIO AS MINI-LINK 6364 AND
MINI-LINK 6365. THE 0.3-1.8m REFLECTOR ANTENNAS ARE MODULAR, MAKING THEM
UPGRADEABLE FROM SINGLE TO DUAL POLARIZATION WITHOUT THE NEED FOR
REALIGNMENT. THIS IS DONE BY REPLACING THE INTERFACE ONLY. WITH HIGH FOCUS
ON VISUAL APPERANCE AND MINIMIZED SIZE, ERCSSON HAS CREATED THE
WORLD'S SMALLEST OUTDOOR UNIT (RADIO+ANTENNA) IN TRADITIONAL BANDS WITH A RANGE OF FLAT PANEL ANTENNAS. SINCE ANTENNA PERFORMANCE IS KEY TO SECURE NETWORK PERFORMANCE, THE FLAT PANEL ANTENNAS ARE GUARANTEED TO BE ETSI CLASS 3 COMPLIANT AND TYPICALLY CLOSE TO ETSI CLASS 4 COMPLIANCE.

# Technical specification

Channels: 7 - 112/125 MHz

TX power: -10 to +30 dBm

2.5 kg / 5.5 lbs

+57 VDC

0.1 m / 5 in SHP

1+0 to 4+0

-45 to +60 °C / -49 to +140 °F

PRESENTED BY: verizon

SITE NAME:

SAL EL MONTE

SITE ADDRESS:

1851 VALLEY DR.

OGDEN, UT 84404-6061

SITE COUNTY:

WEBER COUNTY

SITE ID:

5000232110 REVISIONS

Rev: Date: Description 0 07.28.23 100% CONSTRUCTION GW

SCALE: NTS SCALE: NTS

SCALE: NTS

SCALE: NTS

STAMPING ŞIGNATURE **RYAN THOMAS** GUERRERO : 07/28/2023 JRK W. THE BY OLE OF HYDE J. THOM OF SCALE STATES AND THE STATES OF SCALE STATES AND THE SCALE STATES AND THE STATES OF SCALE STATES AND THE SCALE STATES AN

SHEET TITLE:

**EQUIPMENT DETAILS** 

SHEET NUMBER: T5.1

DRAWN BY: CHK BY: APV BY: GW СМ CM

2 NOT USED

1 ERICSSON MINI-LINK MW RADIO DETAIL