



LEFT (WEST) ONTO UT-97 [W 5600 S] TURN RIGHT (NORTH) ONTO

(SOUTH) ONTO LOCAL ROAD ARRIVE AT SITE

UT-126 [S 1900 W] TURN LEFT (WEST) ONTO W 4000 S TURN LEFT

2.5 EQUIPMENT DEPLOYMENT

RF MGR

RF ENGINEER

PROPERTY OWNER

SPRINT REP.

AW MGR.

# KWIK CITY MUFFLER

SITE NUMBER / CROWN CASTLE BU#

SL03XC136 / 880534

SITE ADDRESS

2449 WEST 4000 SOUTH **ROY, UT 84067** 

SITE TYPE

**EXISTING 132' MONOPOLE** 

DEVELOPMENT LLC

PROJECT MANAGER



6100 SPRINT PARKWAY OVERLAND PARK, KS 66251





SHEET NUMBER

14013

801-298-5777 FAX 801-298-1677

**ENGINEER** 

#### 801-298-5777 FAX 801-298-1677 PROJECT SUMMARY SHEET INDEX CODE AREA MAP SHEET DESCRIPTION CHECKED BY: JRC KWIK CITY MUFFLER SITE NAME: **UTAH STATE CODE COMPLIANCE:** T-1 TITLE SHEET TGS APPROVED BY: ALL WORK AND MATERIALS SHALL BE PERFORMED AND INSTALLED SP-1 SPRINT SPECIFICATION # DATE SITE NUMBER: SL03XC136 DESCRIPTION IN ACCORDANCE WITH THE CURRENT EDITIONS OF THE FOLLOWING CODES AS ADOPTED BY THE LOCAL GOVERNING AUTHORITIES. CROWN CASTLE BU# 880534 SP-2 SPRINT SPECIFICATION 90% REVIEW 01/24/14 2449 WEST 4000 SOUTH SITE ADDRESS: A-1 OVERALL SITE PLAN NOTHING IN THIS PLANS NEEDS TO BE CONSTRUCTED TO PERMIT WORK NOT CONFORMING TO THESE CODES. 02/05/14 STAMPED ROY, UTAH 84067 A-2 ENLARGED SITE PLAN A-2A EQUIPMENT LAYOUT ZONING JURISDICTION: IB-INDUSTRIAL GENERAL A-3 TOWER ELEVATION AND ANTENNA LAYOUT ZONING DISTRICT: A-4 SITE DETAILS BUILDING CODE: A-5 RF DATA SCHEMATIC SOURCE: SITE AUDIT 2012 INTERNATIONAL BUILDING CODE LATITUDE: 41.1896' (NAD 83) A-6 NOT USED WITH ALL LATEST/LOCAL AMENDMENTS -112.0392 (NAD 83) LONGITUDE: A-7 CABLE AND COLOR CODING GROUND ELEVATION: 4374 A-8 EQUIPMENT DETAILS ELECTRICAL CODE: E-1 AC POWER DISTRIBUTION PROPERTY/TOWER OWNER: 2011 NATIONAL ELECTRIC CODE SITE E-2 AC & DC POWER DISTRIBUTION AND SCHEDULE COMPANY: CROWN CASTLE USA, INC WITH ALL LATEST/LOCAL AMENDMENTS E-3 GROUNDING DETAILS CONTACT: CUSTOMER SERVICE 5350 NORTH 48TH STREET, SUITE 305 ADDRESS: ACCESSIBILITY REQUIREMENTS: CHANDLER, AZ 85226-5141 FACILITY IS UNMANNED AND NOT FOR HUMAN HABITATION. EMAIL: Thomas G HANDICAP ACCESS REQUIREMENTS ARE NOT REQUIRED. (480) 735-6900 Smith VICINITY MAP PROJECT DESCRIPTION SITE CONSTRUCTION MANAGER: THE WIRELESS COMMUNICATIONS FACILITY IS NOT INTENDED COMPANY: SPRINT SITE DEVELOPMENT/UTAH TATE OF UT FOR HUMAN OCCUPANCY CONTACT: JUSTIN R. NELSON THIS FACILITY DOES NOT REQUIRE POTABLE WATER AND CELL #: (435) 232-5459 WILL NOT PRODUCE ANY SEWAGE. SIGNED DATE: 02/05/14 OFFICE #: (801) 685-5809 THE SCOPE OF WORK CONSISTS OF MODIFYING THE SITE CERTIFICATION STATEMENT: SITE NAME EXISTING WIRELESS INSTALLATION: **ENGINEERING FIRM:** CERTIFY THAT THESE DRAWINGS WERE PREPARED BY ME OR UNDER MY DIRECT SUPERVISION AND CONTROL, AND TO THE BEST OF MY SMITH HYATT ARCHITECTS INSTALL (3) PANEL ANTENNAS COMPANY: KNOWLEDGE AND BELIEF COMPLY WITH THE REQUIREMENTS OF THE KWIK CITY INSTALL (3) NEW RRUS (REMOTE RADIO UNITS) CONTACT: TOM SMITH 2012 INTERNATIONAL BUILDING CODE. EMAIL: tom@smithhyatt.com **MUFFLER** MAIN OFFICE: (801) 298-5777 LICENSED ARCHITECT - STATE OF UTAH SITE I.D. POWER COMPANY COMPANY: **PACIFICORP** SL03XC136 CUSTOMER SERVICE CONTACT: 1-888-221-7070 PHONE: 880534 AAV PROVIDER: COMPANY: SITE ADDRESS DATE SIGNED: **EXPIRES:** LICENSE#: CONTACT: CUSTOMER SERVICE NOTE: DRAWING SCALES ARE FOR 11"X17" SHEETS UNLESS OTHERWISE NOTED. PHONE: (XXX) XXX-XXXX sign date 2449 WEST 4000 SOUTH **PROJECT TEAM** ROY, UTAH 84067 SIGNATURE BLOCK DRIVING DIRECTIONS APPROVAL DATE SIGNATURE DEPART FROM SALT LAKE INTERNATIONAL AIRPORT SHEET NAME SITE ACQ. MGR DEPART SALT LAKE INTERNATIONAL AIRPORT ON TERMINAL DR (WEST) Sprint CONSTRUCTION MGR ROAD NAME CHANGES TO LOCAL ROAD(S) KEEP LEFT ONTO RAMP TITLE SHEET TAKE RAMP (LEFT) ONTO I-80 AT EXIT 117 TURN RIGHT ONTO RAMP A&E MGR TAKE RAMP (LEFT) ONTO 1-215 TAKE RAMP ONTO 1-15 AT EXIT 338 PLANNING CONS. TURN RIGHT ONTO RAMP KEEP STRAIGHT ONTO LOCAL ROAD TURN 6100 SPRINT PARKWAY 845 SOUTH MAIN, BOUNTIFUL, UTAH 84010 OVERLAND PARK, KS 66251

TEL: (913) 624-6000

**APPLICANT** 

THESE OUTLINE SPECIFICATIONS IN CONJUNCTION WITH THE SPRINT STANDARD CONSTRUCTION SPECIFICATIONS, INCLUDING CONTRACT DOCUMENTS AND THE CONSTRUCTION DRAWINGS DESCRIBE THE WORK TO BE PERFORMED BY THE CONTRACTOR. THE CONTRACTOR IS RESPONSIBLE FOR MEETING THE REQUIREMENTS OF SPRINT'S "STANDARD CONSTRUCTION SPECIFICATIONS FOR WIRELESS SITES" IN REGARDS TO ALL WORK COMPLETED

## SECTION 01 100 - SCOPE OF WORK

#### THE WORK:

SHALL COMPLY WITH APPLICABLE NATIONAL CODES AND STANDARDS, LATEST EDITION. AND PORTIONS THEREOF.

#### PRECEDENCE:

SHOULD CONFLICTS OCCUR BETWEEN THE STANDARD CONSTRUCTION SPECIFICATIONS FOR WIRELESS SITES INCLUDING THE STANDARD CONSTRUCTION DETAILS FOR WIRELESS SITES AND THE CONSTRUCTION DRAWINGS, INFORMATION ON THE CONSTRUCTION DRAWINGS SHALL TAKE PRECEDENCE.

## SITE FAMILIARITY:

CONTRACTOR SHALL BE RESPONSIBLE FOR FAMILIARIZING HIMSELF WITH ALL CONTRACT DOCUMENTS, FIELD CONDITIONS AND DIMENSIONS PRIOR TO PROCEEDING

## ON-SITE SUPERVISION:

THE CONTRACTOR SHALL SUPERVISE AND DIRECT THE WORK AND SHALL BE RESPONSIBLE FOR CONSTRUCTION MEANS, METHODS, TECHNIQUES, SEQUENCES, AND PROCEDURES IN ACCORDANCE WITH THE CONTRACT DOCUMENTS.

#### DRAWINGS. SPECIFICATIONS AND DETAILS REQUIRED AT JOBSITE THE CONSTRUCTION CONTRACTOR SHALL MAINTAIN A FULL SET OF THE CONSTRUCTION DRAWINGS AT THE JOBSITE FROM MOBILIZATION THROUGH CONSTRUCTION COMPLETION.

- A. DETAILS ARE INTENDED TO SHOW DESIGN INTENT. PROVIDE ALL MATERIALS AND LABOR AS REQUIRED TO PROVIDE A COMPLETE AND FUNCTIONING SYSTEM. MODIFICATIONS MAY BE REQUIRED TO SUIT JOB DIMENSIONS OR CONDITIONS, AND SUCH MODIFICATIONS SHALL BE INCLUDED AS PART OF THE WORK.
- CONTRACTOR SHALL NOTIFY SPRINT CONSTRUCTION MANAGER OF ANY VARIATIONS PRIOR TO PROCEEDING WITH THE WORK.DIMENSIONS SHOWN ARE TO FINISH SURFACES UNLESS NOTED OTHERWISE. MODIFICATIONS MAY BE REQUIRED TO SUIT JOB DIMENSIONS OR CONDITIONS, AND SUCH MODIFICATIONS SHALL BE INCLUDED
- MARK THE FIELD SET OF DRAWINGS IN RED, DOCUMENTING ANY CHANGES FROM THE CONSTRUCTION DOCUMENTS.
- D. GROUNDING NE-312-201
- E. SPRINT INTEGRATED CONSTRUCTION STANDARDS VERSION 4.0

## METHODS OF PROCEDURE (MOPS) FOR CONSTRUCTION: CONTRACTOR SHALL PERFORM WORK AS DESCRIBED IN

- A. COAX COLOR CODING SWEEPS AND FIBER TESTING TS-0200 AND EL-0568
- B. CABLE LABELING EN-2012-00
- C. APPLICABLE INSTALLATION MOPS IDENTIFIED ELSEWHERE IN THE CONTRACT

## SECTION 01 200 - COMPANY FURNISHED MATERIAL AND EQUIPMENT

COMPANY FURNISHED MATERIAL AND EQUIPMENT IS IDENTIFIED ON THE RF DATA SHEET IN THE CONSTRUCTION DRAWINGS.

CONTRACTOR IS RESPONSIBLE FOR SPRINT PROVIDED MATERIAL AND EQUIPMENT TO ENSURE IT IS PROTECTED AND HANDLED PROPERLY THROUGHOUT THE CONSTRUCTION DURATION.

CONTRACTOR RESPONSIBLE FOR RECEIPT OF SPRINT FURNISHED EQUIPMENT AT CELL SITE OR CONTRACTORS LOCATION. CONTRACTOR TO COMPLETE SHIPPING AND RECEIPT DOCUMENTATION IN ACCORDANCE WITH COMPANY PRACTICE.

## SECTION 01 300 - CELL SITE CONSTRUCTION

## NOTICE TO PROCEED:

NO WORK SHALL COMMENCE PRIOR TO COMPANY'S WRITTEN NOTICE TO PROCEED AND THE ISSUANCE OF WORK ORDER.

CONTRACTOR SHALL KEEP THE SITE FREE FROM ACCUMULATING WASTE MATERIAL, DEBRIS, AND TRASH, AT THE COMPLETION OF THE WORK, CONTRACTOR SHALL REMOVE FROM THE SITE ALL REMAINING RUBBISH, IMPLEMENTS, TEMPORARY FACILITIES, AND SURPLUS MATERIALS.

## ALTERNATES: SECTION 01 400 - SUBMITTALS & TESTS

AT THE COMPANY'S REQUEST, ANY ALTERNATIVES TO THE MATERIALS OR METHODS SPECIFIED SHALL BE SUBMITTED TO SPRINTS CONSTRUCTION MANAGER FOR APPROVAL. SPRINT WILL REVIEW AND APPROVE ONLY THOSE REQUESTS MADE IN WRITING. NO VERBAL APPROVALS WILL BE CONSIDERED,

## TESTS AND INSPECTIONS:

- A. THE CONTRACTOR SHALL BE RESPONSIBLE FOR ALL CONSTRUCTION TESTS, INSPECTIONS AND PROJECT DOCUMENTATION.
- CONTRACTOR SHALL ACCOMPLISH TESTING INCLUDING BUT NOT LIMITED TO THE В. FOLLOWING:
- 1. COAX SWEEPS AND FIBER TESTS PER TS-0200 REV 4 ANTENNA LINE ACCEPTANCE STANDARDS.
- 2. AGL, AZIMUTH AND DOWNTILT PROVIDE AN AUTOMATED REPORT UPLOADED TO SITERRA USING A COMMERCIAL MADE-FOR THE PURPOSE ELECTRONIC ANTENNA ALIGNMENT TOOL (AAT). INSTALLED AZIMUTH, CENTERLINE AND DOWNTILT MUST CONFORM WITH RF CONFIGURATION DATA
- 3. CONTRACTOR SHALL BE RESPONSIBLE FOR ANY AND ALL CORRECTIONS TO ANY WORK IDENTIFIED AS UNACCEPTABLE IN SITE INSPECTION ACTIVITIES AND/OR AS A RESULT OF TESTING.
- 4. ALL TESTING REQUIRED BY APPLICABLE INSTALLATION MOPS.
- C. REQUIRED CLOSEOUT DOCUMENTATION INCLUDES, BUT IS NOT LIMITED TO THE FOLLOWING:
- 1. AZIMUTH, DOWNTILT, AGL FROM SUNSIGHT INSTRUMENTS ANTENNALIGN ALIGNMENT TOOL (AAT)
- 2. SWEEP AND FIBER TESTS
- 3. SCALABLE BARCODE PHOTOGRAPHS OF TOWER TOP AND INACCESSIBLE SERIALIZED EQUIPMENT
- 4. ALL AVAILABLE JURISDICTIONAL PERMIT AND OCCUPANCY INFORMATION
- 5. PDF SCAN OF REDLINES PRODUCED IN FIELD
- 6. A PDF SCAN OF REDLINE MARK-UPS SUITABLE FOR USE IN ELECTRONIC AS-BUILT DRAWING PRODUCTION
- 7 LIFN WAIVERS
- 8. FINAL PAYMENT APPLICATION
- 9. REQUIRED FINAL CONSTRUCTION PHOTOS
- 10. CONSTRUCTION AND COMMISSIONING CHECKLIST COMPLETE WITH NO DEFICIENT ITEMS
- 11. APPLICABLE POST NTP TASKS INCLUDING DOCUMENT UPLOADS COMPLETED IN SITERRA (SPRINTS DOCUMENT REPOSITORY OF RECORD).
- 12. CLOSEOUT PHOTOGRAPHS AND CLOSEOUT CHECKLIST: SPRINT WILL PROVIDE SEPARATE GUIDANCE

## SECTION 11 700 - ANTENNA ASSEMBLY, REMOTE RADIO UNITS AND CABLE INSTALLATION SUMMARY:

THIS SECTION SPECIFIES INSTALLATION OF ANTENNAS, RRU'S, AND CABLE EQUIPMENT, INSTALLATION, AND TESTING OF COAXIAL FIBER CABLE.

#### ANTENNAS AND RRU'S:

THE NUMBER AND TYPE OF ANTENNAS AND RRU'S TO BE INSTALLED IS DETAILED ON THE CONSTRUCTION DRAWINGS.

#### HYBRID CABLE:

HYBRID CABLE WILL BE DC/FIBER AND FURNISHED FOR INSTALLATION AT EACH SITE. CABLE SHALL BE INSTALLED PER THE CONSTRUCTION DRAWINGS AND THE APPLICABLE MANUFACTURER'S REQUIREMENTS.

## JUMPERS AND CONNECTORS:

FURNISH AND INSTALL 1/2" COAX JUMPER CABLES BETWEEN THE RRU'S AND ANTENNAS. JUMPERS SHALL BE TYPE LDF 4, FLC 12-50, CR 540, OR FXL 540. SUPER-FLEX CABLES ARE NOT ACCEPTABLE, JUMPERS BETWEEN THE RRU'S AND ANTENNAS OR TOWER TOP AMPLIFIERS SHALL CONSIST OF 1/2 INCH FOAM DIELECTRIC, OUTDOOR RATED COAXIAL CABLE, MIN LENGTH FOR JUMPER SHALL BE 10"-0"

## REMOTE ELECTRICAL TILT (RET) CABLES:

INSTALL SPLITTERS, COMBINERS, FILTERS PER RF DATA SHEET, FURNISHED BY

## ANTENNA INSTALLATION:

THE CONTRACTOR SHALL ASSEMBLE ALL ANTENNAS ONSITE IN ACCORDANCE WITH THE INSTRUCTIONS SUPPLIED BY THE MANUFACTURER. ANTENNA HEIGHT, AZIMUTH, AND FEED ORIENTATION INFORMATION SHALL BE A DESIGNATED ON THE CONSTRUCTION DRAWINGS.

- A. THE CONTRACTOR SHALL POSITION THE ANTENNA ON TOWER PIPE MOUNTS SO THAT THE BOTTOM STRUT IS LEVEL. THE PIPE MOUNTS SHALL BE PLUMB TO 1 DEGREE
- B. ANTENNA MOUNTING REQUIREMENTS: PROVIDE ANTENNA MOUNTING HARDWARE AS INDICATED ON THE DRAWINGS.

- HYBRID CABLE INSTALLATION:
  A. THE CONTRACTOR SHALL ROUTE, TEST, AND INSTALL ALL CABLES AS INDICATED ON THE CONSTRUCTION DRAWINGS AND IN ACCORDANCE WITH THE MANUFACTURER'S RECOMMENDATIONS.
- B. THE INSTALLED RADIUS OF THE CABLES SHALL NOT BE LESS THAN THE MANUFACTURER'S SPECIFICATIONS FOR BENDING RADII.
- C. EXTREME CARE SHALL BE TAKEN TO AVOID DAMAGE TO THE CABLES DURING HANDLING AND INSTALLATION.
- 1. FASTENING MAIN HYBRID CABLES: ALL CABLES SHALL BE INSTALLED INSIDE MONOPOLE WITH CABLE SUPPORT GRIPS AS REQUIRED BY THE MANUFACTURER.
- 2. FASTENING INDIVIDUAL FIBER AND DC CABLES ABOVE BREAKOUT ENCLOSURE (MEDUSA), WITHIN THE MMBS CABINET AND ANY INTERMEDIATE DISTRIBUTION BOXES:
- a. FIBER: SUPPORT FIBER BUNDLES USING 1/2" VELCRO STRAPS OF THE REQUIRED LENGTH @ 18" OC. STRAPS SHALL BE UV, OIL AND WATER RESISTANT AND SUITABLE FOR INDUSTRIAL INSTALLATIONS AS MANUFACTURED BY TEXTOL OR APPROVED EQUAL.
- b. DC: SUPPORT DC BUNDLES WITH ZIP TIES OF THE ADEQUATE LENGTH. ZIP TIES TO BE UV STABILIZED, BLACK NYLON, WITH TENSILE STRENGTH AT 12,000 PSI AS MANUFACTURED BY NELCO PRODUCTS OR FOUAL.
- 3. FASTENING JUMPERS: SECURE JUMPERS TO THE SIDE ARMS OR HEAD FRAMES USING STAINLESS STEEL TIE WRAPS OR STAINLESS STEEL BUTTERFLY CLIPS.
- 4. CABLE INSTALLATION:
  - a. INSPECT CABLE PRIOR TO USE FOR SHIPPING DAMAGE, NOTIFY THE CONSTRUCTION MANAGER.
  - CABLE ROUTING: CABLE INSTALLATION SHALL BE PLANNED TO ENSURE THAT THE LINES WILL BE PROPERLY ROUTED IN THE CABLE ENVELOP AS INDICATED ON THE DRAWINGS. AVOID TWISTING AND CROSSOVERS.
  - c. HOIST CABLE USING PROPER HOISTING GRIPS. DO NOT EXCEED MANUFACTURES RECOMMENDED MAXIMUM BEND RADIUS.
- 5. GROUNDING OF TRANSMISSION LINES: ALL TRANSMISSION LINES SHALL BE GROUNDED AS INDICATED
- 6. HYBRID CABLE COLOR CODING: ALL COLOR CODING SHALL BE AS REQUIRED IN TS 0200 REV 4.
- 7. HYBRID CABLE LABELING: INDIVIDUAL HYBRID AND DC BUNDLES SHALL BE LABELED ALPHA-NUMERICALLY ACCORDING TO SPRINT CELL SITE ENGINEERING NOTICE - EN 2012-001,

## WEATHERPROOFING EXTERIOR CONNECTORS AND HYBRID CABLE GROUND KITS: A. ALL FIBER & COAX CONNECTORS AND GROUND KITS SHALL BE WEATHERPROOFED.

- WEATHERPROOFED USING ONE OF THE FOLLOWING METHODS. ALL INSTALLATIONS MUST BE DONE IN ACCORDANCE WITH THE MANUFACTURER'S RECOMMENDATIONS AND INDUSTRY BEST PRACTICES.
- 1. COLD SHRINK: ENCOMPASS CONNECTOR IN COLD SHRINK TUBING AND PROVIDE A DOUBLE WRAP OF 2" ELECTRICAL TAPE EXTENDING 2" BEYOND TUBING. PROVIDE 3M COLD SHRINK CXS SERIES OR EQUAL.
- 2. SELF-AMALGAMATING TAPE: CLEAN SURFACES. APPLY A DOUBLE WRAP OF SELF-AMALGAMATING TAPE 2" BEYOND CONNECTOR, APPLY A SECOND WRAP OF SELF-AMALGAMATING TAPE IN OPPOSITE DIRECTION. APPLY DOUBLE WRAP OF 2" WIDE ELECTRICAL TAPE EXTENDING 2" BEYOND THE SELF-AMALGAMATING TAPE.
- 3. 3M SLIM LOCK CLOSURE 716: SUBSTITUTIONS WILL NOT BE ALLOWED.
- 4. OPEN FLAME ON JOB SITE IS NOT ACCEPTABLE

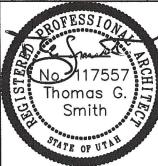




OVERLAND PARK, KS 66251



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| APPROVED BY: |            | TGS         |      |  |
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SIGNED DATE: \_\_\_\_02/05/14

SITE NAME

KWIK CITY **MUFFLER** 

SITE ID

SL03XC136 880534

SITE ADDRESS

2449 WEST 4000 SOUTH ROY, UTAH 84067

SHEET NAME

SPRINT **SPECIFICATION** 

SHEET NUMBER

#### SPRINT SPECIFICATIONS

## SECTION 11 800 - INSTALLATION OF MULTIMODAL BASE STATIONS (MMBS) AND RELATED EQUIPMENT

#### SUMMARY:

- A. THIS SECTION SPECIFIES MMBS CABINETS, POWER CABINETS, AND INTERNAL EQUIPMENT INCLUDING BY NOT LIMITED TO RECTIFIERS, POWER DISTRIBUTION UNITS, BASE BAND UNITS. SURGE ARRESTORS, BATTERIES, AND SIMILAR EQUIPMENT FURNISHED BY THE COMPANY FOR INSTALLATION BY THE CONTRACTOR (OFCI).
- CONTRACTOR SHALL PROVIDE AND INSTALL ALL MISCELLANEOUS MATERIALS AND PROVIDE D. ENSURE THAT THE LOAD APPLIED BY ANY FASTENER DOES NOT EXCEED 25 ALL LABOR REQUIRED FOR INSTALLATION EQUIPMENT IN EXISTING CABINET OR NEW CABINET AS SHOWN ON DRAWINGS AND AS REQUIRE BY THE APPLICABLE INSTALLATION
- C. COMPLY WITH MANUFACTURERS INSTALLATION AND START-UP REQUIREMENTS

### DC CIRCUIT BREAKER LABELING

A. NEW DC CIRCUIT IS REQUIRED IN MMBS CABINET SHALL BE CLEARLY IDENTIFIED AS TO RRU BEING SERVICED

## SECTION 26 100 - BASIC ELECTRICAL REQUIREMENTS

SUMMARY:
THIS SECTION SPECIFIES BASIC ELECTRICAL REQUIREMENTS FOR SYSTEMS AND COMPONENTS.

## QUALITY ASSURANCE:

- A. ALL EQUIPMENT FURNISHED UNDER DIVISION 26 SHALL CARRY UL LABELS AND LISTINGS WHERE SUCH LABELS AND LISTINGS ARE AVAILABLE IN THE INDUSTRY
- MANUFACTURERS OF EQUIPMENT SHALL HAVE A MINIMUM OF THREE YEARS EXPERIENCE WITH THEIR EQUIPMENT INSTALLED AND OPERATING IN THE FIELD IN A USE SIMILAR TO THE PROPOSED USE FOR THIS PROJECT.
- C. MATERIALS AND EQUIPMENT: ALL MATERIALS AND EQUIPMENT SPECIFIED IN DIVISION 26 OF THE SAME TYPE SHALL BE OF THE SAME MANUFACTURER AND SHALL BE NEW, OF THE BEST QUALITY AND DESIGN, AND FREE FROM DEFECTS

#### SUPPORTING DEVICES:

- A. ALL EQUIPMENT FURNISHED UNDER DIVISION 26 SHALL CARRY UL LABELS AND LISTINGS WHERE SUCH LABELS AND LISTINGS ARE AVAILABLE IN THE INDUSTRY.
- B. MANUFACTURERS OF EQUIPMENT SHALL HAVE A MINIMUM OF THREE YEARS EXPERIENCE WITH THEIR EQUIPMENT INSTALLED AND OPERATING IN THE FIELD IN A USE SIMILAR TO

## MATERIALS AND EQUIPMENT:

ALL MATERIALS AND EQUIPMENT SPECIFIED IN DIVISION 26 OF THE SAME TYPE SHALL BE OF THE SAME MANUFACTURER AND SHALL BE NEW, OF THE BEST QUALITY AND DESIGN, AND FREE FROM DEFECTS

## SUPPORTING DEVICES:

- MANUFACTURED STRUCTURAL SUPPORT MATERIALS: SUBJECT TO COMPLIANCE WITH REQUIREMENTS, PROVIDE PRODUCTS BY THE FOLLOWING:
- 1. ALLIED TUBE AND CONDUIT
- 2. B-LINE SYSTEM
- 3. SUNISTRUT DIVERSIFIED PRODUCTS
- 4. THOMAS & BETTS
- B. FASTENERS: TYPES, MATERIALS, AND CONSTRUCTION FEATURES AS FOLLOWS:
- 1. EXPANSION ANCHORS: CARBON STEEL WEDGE OR SLEEVE TYPE.
- 2. POWER-DRIVEN THREADED STUDS: HEAT-TREATED STEEL, DESIGNED SPECIFICALLY FOR THE INTENDED SERVICE
- 3. FASTEN BY MEANS OF WOOD SCREWS ON WOOD.
- 4. TOGGLE BOLTS ON HOLLOW MASONRY UNITS
- 5. CONCRETE INSERTS OR EXPANSION BOLTS ON CONCRETE OR SOLID MASONRY.
- 6. MACHINE SCREWS, WELDED THREADED STUDS, OR SPRING-TENSION CLAMPS ON STEEL.
- 7. EXPLOSIVE DEVICES FOR ATTACHING HANGERS TO STRUCTURE SHALL NOT BE
- 8. DO NOT WELD CONDUIT, PIPE STRAPS, OR ITEMS OTHER THAN THREADED STUDS TO STEEL STRUCTURES.
- 9. IN PARTITIONS OF LIGHT STEEL CONSTRUCTION, USE SHEET METAL SCREWS.

### SUPPORTING DEVICES:

- INSTALL SUPPORTING DEVICES TO FASTEN ELECTRICAL COMPONENTS SECURELY AND PERMANENTLY IN ACCORDANCE WITH NEC.
- B. COORDINATE WITH THE BUILDING STRUCTURAL SYSTEM AND WITH OTHER TRADES.
- C. UNLESS OTHERWISE INDICATED ON THE DRAWINGS, FASTEN ELECTRICAL ITEMS AND THEIR SUPPORTING HARDWARE SECURELY TO THE STRUCTURE IN ACCORDANCE WITH
- PERCENT OF THE PROOF TEST LOAD.
- E. USE VIBRATION AND SHOCK-RESISTANT FASTENERS FOR ATTACHMENTS TO CONCRETE

### **ELECTRICAL IDENTIFICATION:**

- UPDATE AND PROVIDE TYPED CIRCUIT BREAKER SCHEDULES IN THE MOUNTING BRACKET, INSIDE DOORS OF AC PANEL BOARDS WITH ANY CHANGES MADE TO THE
- B. BRANCH CIRCUITS FEEDING AVIATION OBSTRUCTION LIGHTING EQUIPMENT SHALL BE CLEARLY IDENTIFIED AS SUCH AT THE BRANCH CIRCUIT PANELBOARD.

## SECTION 26 200 - ELECTRICAL MATERIALS AND EQUIPMENT CONDUIT:

- A. RIGID GALVANIZED STEEL (RGS) CONDUIT SHALL BE USED FOR EXTERIOR LOCATIONS ABOVE GROUND AND IN UNFINISHED INTERIOR LOCATIONS AND FOR ENCASED RUNS IN CONCRETE. RIGID CONDUIT AND FITTINGS SHALL BE STEEL, COATED WITH ZINC EXTERIOR AND INTERIOR BY THE HOT DIP GALVANIZING PROCESS. CONDUIT SHALL BE PRODUCED TO ANSI SPECIFICATIONS C80.1, FEDERAL SPECIFICATION WW-C-581 AND SHALL BE LISTED WITH THE UNDERWRITERS' LABORATORIES. FITTINGS SHALL BE THREADED - SET SCREW OR COMPRESSION FITTINGS WILL NOT BE ACCEPTABLE. RGS CONDUITS SHALL BE MANUFACTURED BY ALLIED, REPUBLIC OR WHEATLAND.
- UNDERGROUND CONDUIT IN CONCRETE SHALL BE POLYVINYLCHLORIDE (PVC) SUITABLE FOR DIRECT BURIAL AS APPLICABLE. JOINTS SHALL BE BELLED, AND FLUSH SOLVENT WELDED IN ACCORDANCE WITH MANUFACTURER'S INSTRUCTIONS. CONDUIT SHALL BE CARLON ELECTRICAL PRODUCTS OR APPROVED EQUAL
- C. TRANSITIONS BETWEEN PVC AND RIGID (RGS) SHALL BE MADE WITH PVC COATED METALLIC LONG SWEEP RADIUS ELBOWS.
- D. EMT OR RIGID GALVANIZED STEEL CONDUIT MAY BE USED IN FINISHED SPACES CONCEALED IN WALLS AND CEILINGS. EMT SHALL BE MILD STEEL, ELECTRICALLY WELDED, ELECTRO-GALVANIZED OR HOT-DIPPED GALVANIZED AND PRODUCED TO ANSI SPECIFICATION C80.3, FEDERAL SPECIFICATION WW-C-563, AND SHALL BE UL LISTED. EMT SHALL BE MANUFACTURED BY ALLIED, REPUBLIC OR WHEATLAND, OR APPROVED EQUAL. FITTINGS SHALL BE METALLIC COMPRESSION. SET SCREW CONNECTIONS SHALL NOT BE ACCEPTABLE.
- E. LIQUID TIGHT FLEXIBLE METALLIC CONDUIT SHALL BE USED FOR FINAL CONNECTION TO EQUIPMENT. FITTINGS SHALL BE METALLIC GLAND TYPE COMPRESSION FITTINGS, MAINTAINING THE INTEGRITY OF CONDUIT SYSTEM. SET SCREW CONNECTIONS SHALL NOT BE ACCEPTABLE. MAXIMUM LENGTH OF FLEXIBLE CONDUIT SHALL NOT EXCEED 6-FEET. LFMC SHALL BE PROTECTED AND SUPPORTED AS REQUIRE BY NEC. MANUFACTURERS OF FLEXIBLE CONDUITS SHALL BE CAROL, ANACONDA METAL HOSE OR UNIVERSAL METAL HOSE, OR APPROVED EQUAL
- F. MINIMUM SIZE CONDUIT SHALL BE 3/4 INCH (21MM)

## HUBS AND BOXES:

- A. AT ENTRANCES TO CABINETS OR OTHER EQUIPMENT NOT HAVING INTEGRAL THREADED HUBS PROVIDE METALLIC THREADED HUBS OF THE SIZE AND CONFIGURATION REQUIRED HUB SHALL INCLUDE LOCKNUT AND NEOPRENE O-RING SEAL. PROVIDE IMPACT RESISTANT 105 DEGREE C PLASTIC BUSHINGS TO PROTECT CABLE INSULATION.
- B. CABLE TERMINATION FITTINGS FOR CONDUIT
- 1. CABLE TERMINATORS FOR RGS CONDUITS SHALL BE TYPE CRC BY O-Z/GEDNEY OR EQUAL BY ROX TEC.
- 2. CABLE TERMINATORS FOR LFMC SHALL BE ETCO CL2075; OR MADE FOR THE PURPOSE PRODUCTS BY ROXTEC.
- C. EXTERIOR PULL BOXES AND PULL BOXES IN INTERIOR INDUSTRIAL AREAS SHALL BE PLATED CAST ALLOY, HEAVY DUTY, WEATHERPROOF, DUST PROOF, WITH GASKET, PLATED IRON ALLOY COVER AND STAINLESS STEEL COVER SCREWS, CROUSE-HINDS WAB SERIES OR EQUAL.
- D. CONDUIT OUTLET BODIES SHALL BE PLATED CAST ALLOY WITH SIMILAR GASKETED COVERS. OUTLET BODIES SHALL BE OF THE CONFIGURATION AND SIZE SUITABLE FOR THE APPLICATION. PROVIDE CROUSE-HINDS FORM 8 OR EQUAL
- E. MANUFACTURER FOR BOXES AND COVERS SHALL BE HOFFMAN, SQUARE "D", CROUSE-HINDS, COOPER, ADALET, APPLETON, O-Z GEDNEY, RACO, OR APPROVED EQUAL.

## SUPPLEMENTAL GROUNDING SYSTEM

- A. FURNISH AND INSTALL A SUPPLEMENTAL GROUNDING SYSTEM TO THE EXTENT INDICATED ON THE DRAWINGS. SUPPORT SYSTEM WITH NON-MAGNETIC STAINLESS STEEL CLIPS WITH RUBBER GROMMETS. GROUNDING CONNECTORS SHALL BE TINNED COPPER WIRE, SIZES AS INDICATED ON THE DRAWINGS. PROVIDE STRANDED OR SOLID BARE OR INSULATED CONDUCTORS EXCEPTED AS OTHERWISE NOTED.
- SUPPLEMENTAL GROUNDING SYSTEM: ALL CONNECTIONS TO BE MADE WITH CAD WELDS, EXCEPT AT EQUIPMENT USE LUGS OR OTHER AVAILABLE GROUNDING MEANS AS REQUIRED BY MANUFACTURER; AT GROUND BARS USE TWO HOLE SPADES WITH
- C. STOLEN GROUND-BARS: IN THE EVENT OF STOLEN GROUND BARS, CONTACT SPRINT CM FOR REPLACEMENT INSTRUCTION USING THREADED ROD KITS.

## **EXISTING STRUCTURE:**

A. EXISTING EXPOSED WIRING AND ALL EXPOSED OUTLETS, RECEPTACLES, SWITCHES, DEVICES, BOXES, AND OTHER EQUIPMENT THAT ARE NOT TO BE UTILIZED IN THE COMPLETED PROJECT SHALL BE REMOVED OR DE-ENERGIZED AND CAPPED IN THE WALL, CEILING, OR FLOOR SO THAT THEY ARE CONCEALED AND SAFE. WALL, CEILING, OR FLOOR SHALL BE PATCHED TO MATCH THE ADJACENT CONSTRUCTION.

## CONDUIT AND CONDUCTOR INSTALLATION:

- CONDUITS SHALL BE FASTENED SECURELY IN PLACE WITH APPROVED NON-PERFORATED STRAPS AND HANGERS. EXPLOSIVE DEVICES FOR ATTACHING HANGERS TO STRUCTURE WILL NOT BE PERMITTED. CLOSELY FOLLOW THE LINES OF THE STRUCTURE, MAINTAIN CLOSE PROXIMITY TO THE STRUCTURE AND KEEP CONDUITS IN TIGHT ENVELOPES. CHANGES IN DIRECTION TO ROUTE AROUND OBSTACLES SHALL BE MADE WITH CONDUIT OUTLET BODIES. CONDUIT SHALL BE INSTALLED IN A NEAT AND WORKMANLIKE MANNER, PARALLEL AND PERPENDICULAR TO STRUCTURE WALL AND CEILING LINES. ALL CONDUIT SHALL BE FISHED TO CLEAR OBSTRUCTIONS. ENDS OF CONDUITS SHALL BE TEMPORARILY CAPPED TO PREVENT CONCRETE, PLASTER OR DIRT FROM ENTERING. CONDUITS SHALL BE RIGIDLY CLAMPED TO BOXES BY GALVANIZED MALLEABLE IRON BUSHING ON INSIDE AND GALVANIZED MALLEABLE IRON LOCKNUT ON OUTSIDE AND INSIDE.
- B. CONDUCTORS SHALL BE PULLED IN ACCORDANCE WITH ACCEPTED GOOD PRACTICE.

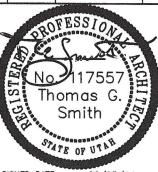


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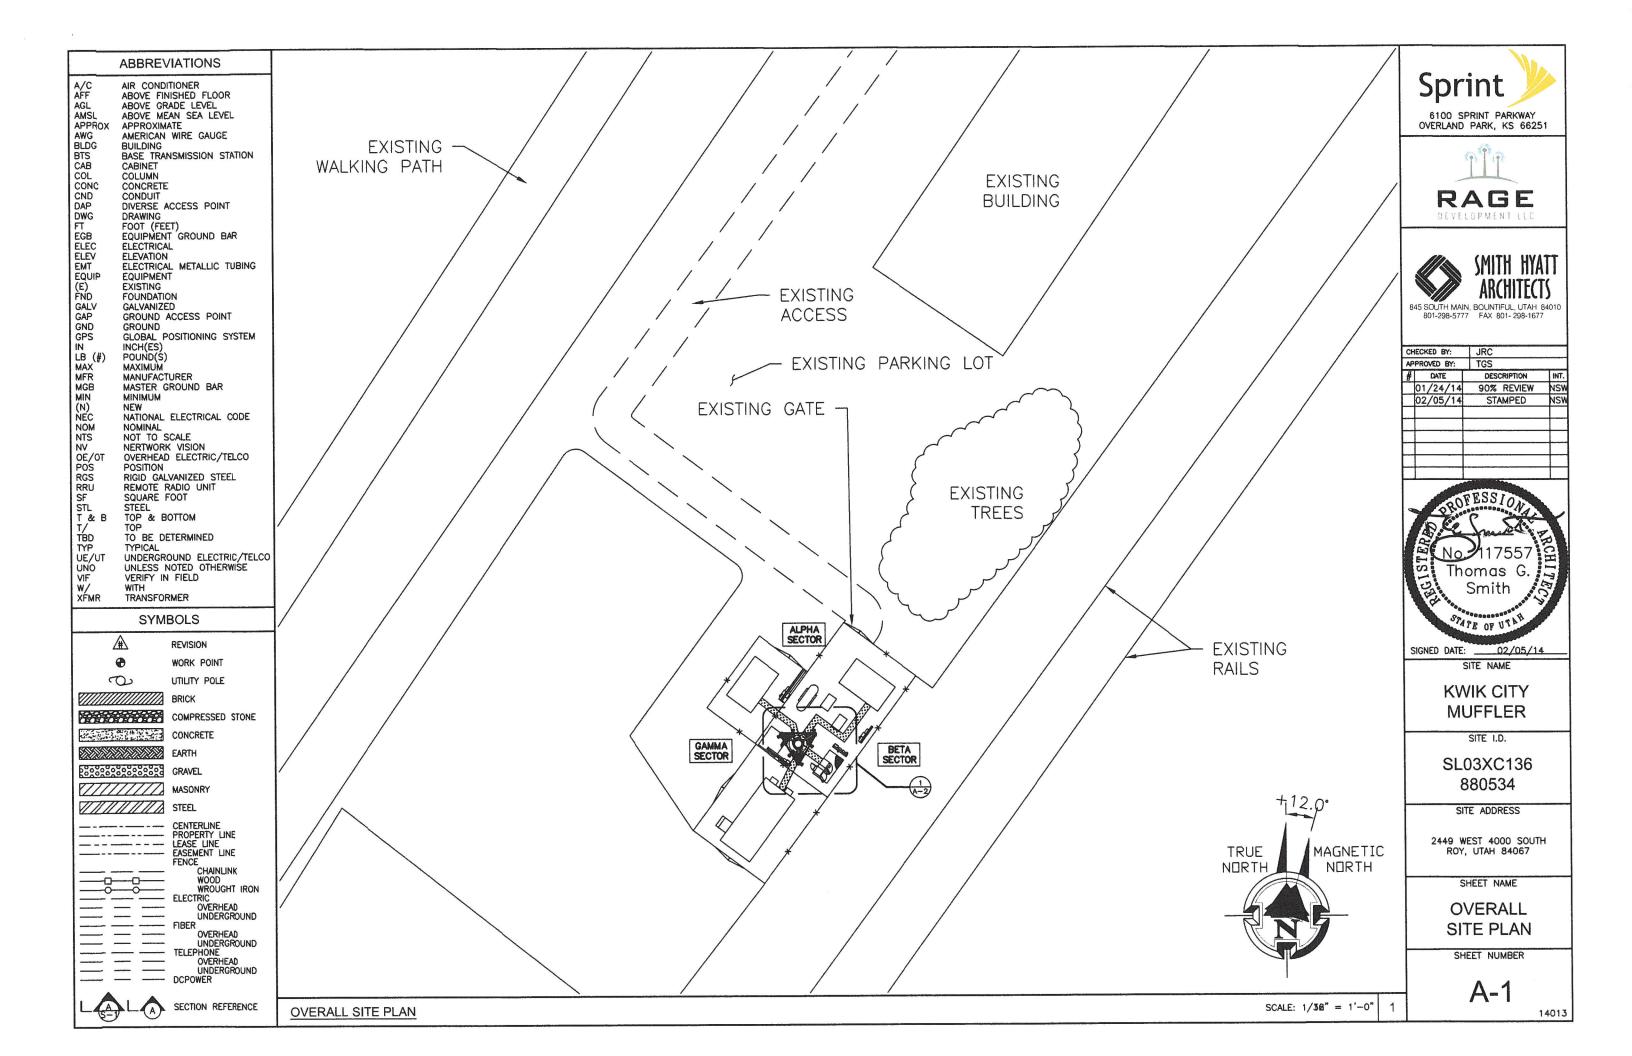
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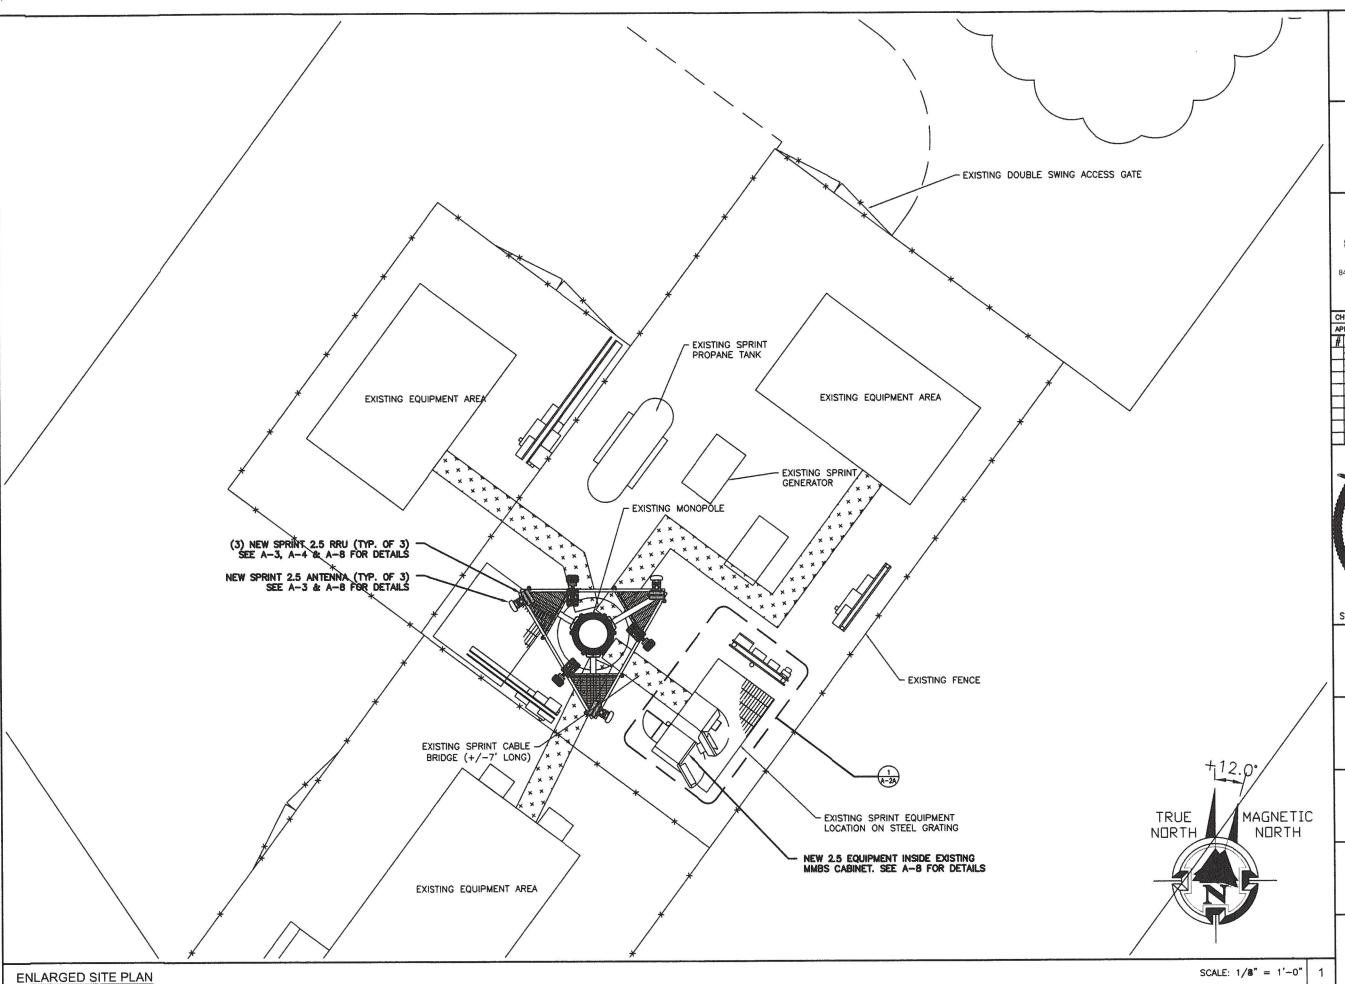
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SPRINT SPECIFICATION

SHEET NUMBER





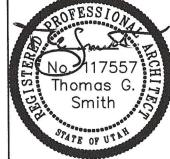


6100 SPRINT PARKWAY OVERLAND PARK, KS 66251





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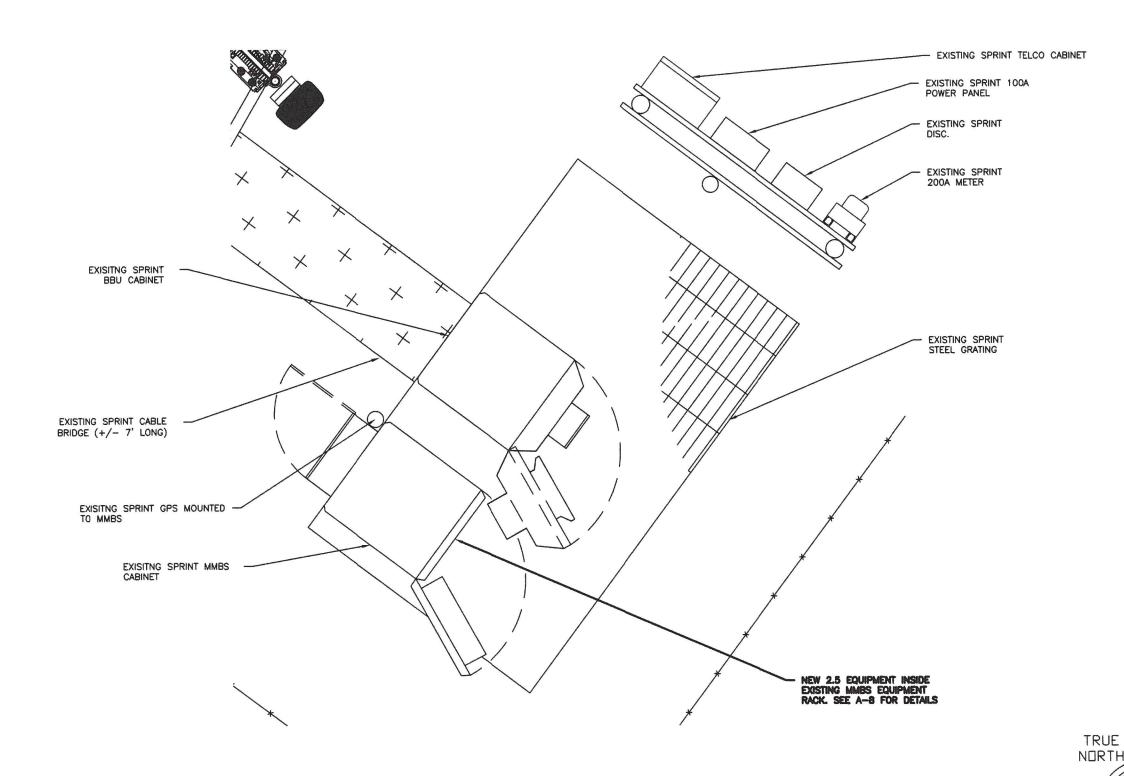
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ENLARGED SITE PLAN

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A-2

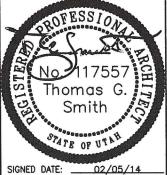








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SHEET NAME

**EQUIPMENT** LAYOUT

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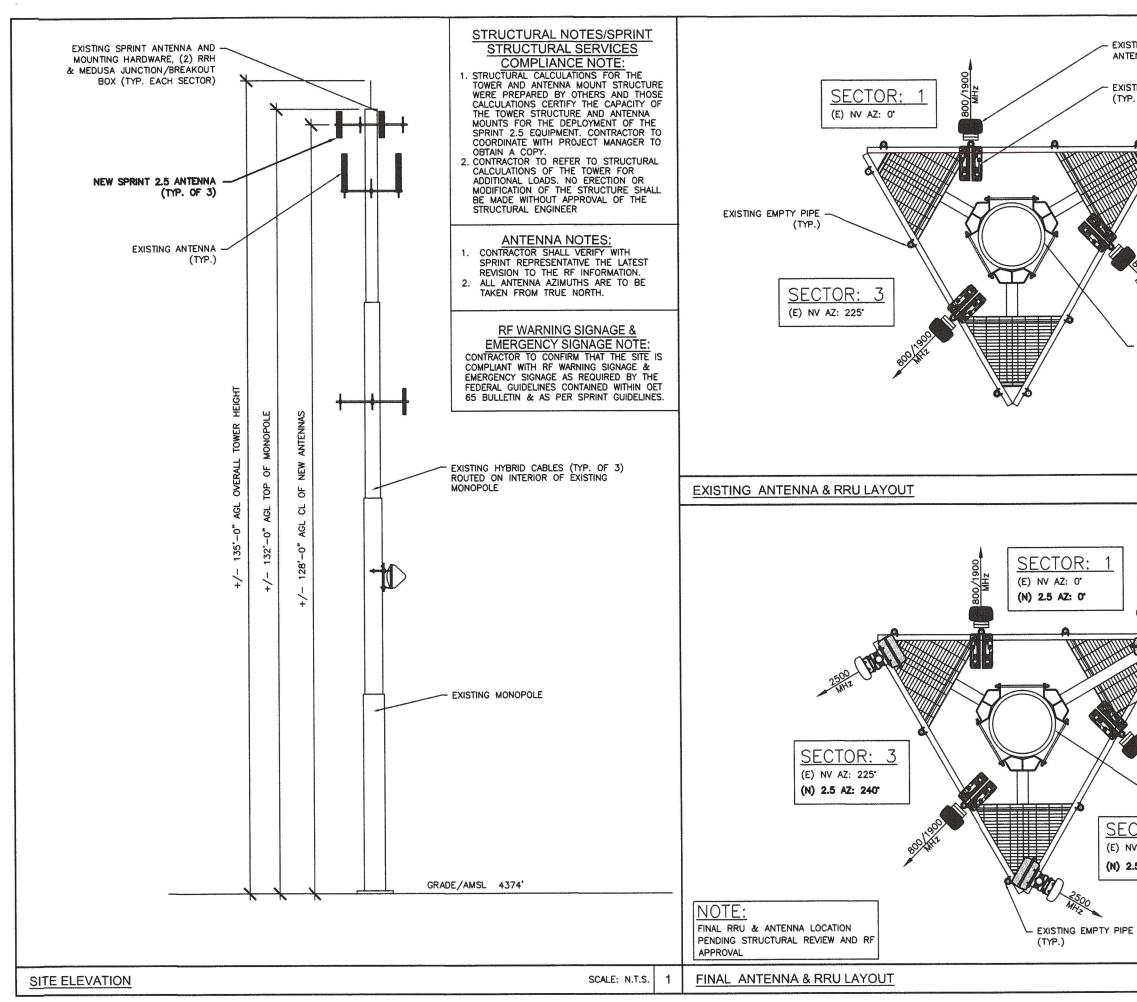
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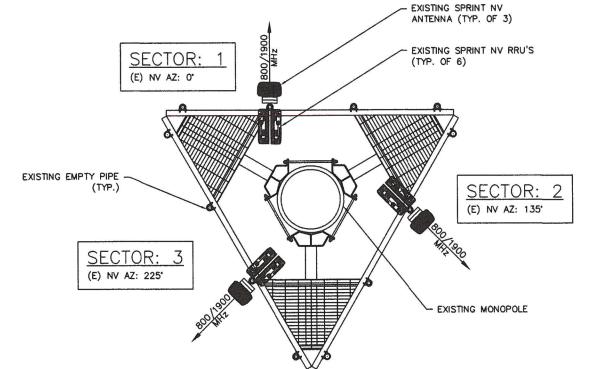
+12.0°

MAGNETIC

NORTH

TRUE



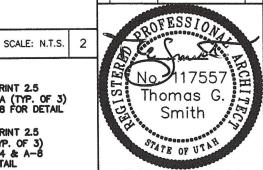


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NEW SPRINT 2.5

NEW SPRINT 2.5

RRU (TYP. OF 3) SEE A-4 & A-8 FOR DETAIL

(TYP. OF 6)

EXISTING MONOPOLE

SECTOR: (E) NV AZ: 135°

(N) 2.5 AZ: 120°

ANTENNA (TYP. OF 3) SEE A-8 FOR DETAIL

EXISTING SPRINT NV RRU'S

EXISTING SPRINT NV

ANTENNA (TYP. OF 3)

SIGNED DATE: 02/05/14

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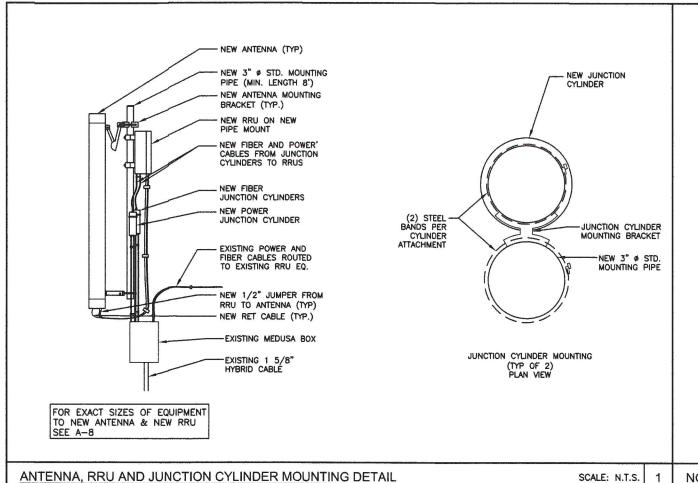
SHEET NAME **TOWER ELEVATION &** ANTENNA LAYOUT

SHEET NUMBER

A-3

3

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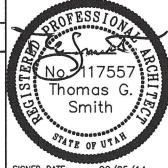








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SHEET NAME

SITE DETAILS

SHEET NUMBER

A-4

NOT USED SCALE: N.T.S. 2

**NOT USED** 

NOT USED

SCALE: N.T.S. 3

SCALE: N.T.S.

## **RFDS Sheet**

## **General Site Information**

| Site ID   | SL03XC136 |  |
|-----------|-----------|--|
| Market    | Utah      |  |
| Region    | West      |  |
| MLA       | Crown     |  |
| Structure | MONOPOLE  |  |
| BTS Type  | STANDARD  |  |

Transmit 2496 Mhz - 2690 Mhz

2496 Mhz - 2690 Mhz

Equipment Vendor Samsung
Lattitude 41.1896
Longitude -112.03831
LLSITE ID 880534

Incremental Power Draw needed by added Equipme 0

**Base Equipment** 

Receive

BBU Kit BBU Kit Qty BBU Dimensions Growth Cabinet

Growth Cabinet Oty Growth Cabinet Dimensions Growth Cabinet Weight 3.5° x 17.1° x 15.2°

RRH-V3

UADU

Top Hat
Top Hat Qty
Top Hat Dimenstions
Top Hat Weight (lbs)

**RF Path Information** 

RRH
RRH City
RRH Dimensions
RRH Weight. Ibs.
RRH Mount Weig
Power and Fiber

RRH Weight. Ibs.
RRH Mount Weight. Lbs.
Power and Fiber Cable
Cable Qty
Weight per foot. Lbs.

Diameter. Inches. Length Ft. Coax Jumper

Coax Jumper Qty

Coax Jumper Length. Feet.
Coax Jumper Weight
Coax Jumper Diameter. Inches
AISG Cable
AISG Cable Qty
AISG Diameter. Inches.
AISG Cable length.
Weight of entire AISG cable. Lbs.

15.5" x 18.6" x 7.48"

54

12.32

None. Bi-Wire Solution derived from existing Hybrid cable

NA

NA

NA

156

27

8

TBD

0.5

Commscope ATCB-801-006

3

0.315

8

1.3

(calculated as antenna height plus 20%)

## Antenna Sector Information

Antenna make/model
Antenna qty
Antenna Dimensions. Inches
Antenna Weight. Inches
Antenna Mounting Kit Weight. Lb
CL Height
Antenna Azimuth
Antenna Mechanical Downtilt
Antenna etilt

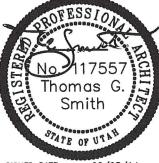
| Sector 1              | Sector 2              | Sector 3              |
|-----------------------|-----------------------|-----------------------|
| KMW ET-X-WM-18-65-8P  | KMW ET-X-WM-18-65-8P  | KMW ET-X-WM-18-65-8   |
| 1                     | 1                     | 1                     |
| 61" x 12" x 4"        | 61° x 12" x 4"        | 61" x 12" x 4°        |
| 36                    | 36                    | 36                    |
| ~11 lb estimate. TBD. | ~11 lb estimate, TBD. | "11 lb estimate. TBD. |
| 130                   | 130                   | 130                   |
| Ö                     | 120                   | 240                   |
| Ö                     | Ó                     | Ó                     |
| -2                    | -2                    | -2                    |
|                       |                       |                       |







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SITE I.D.

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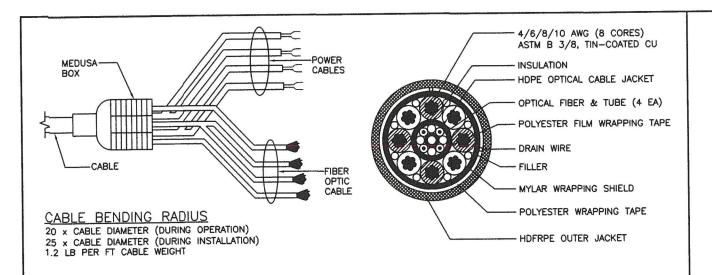
2449 WEST 4000 SOUTH ROY, UTAH 84067

SHEET NAME

RF DATA SHEET

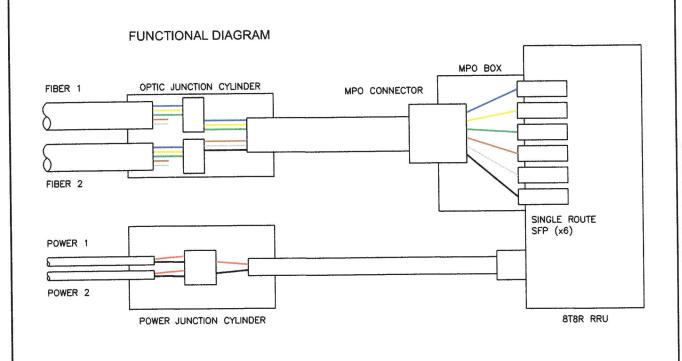
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A-5



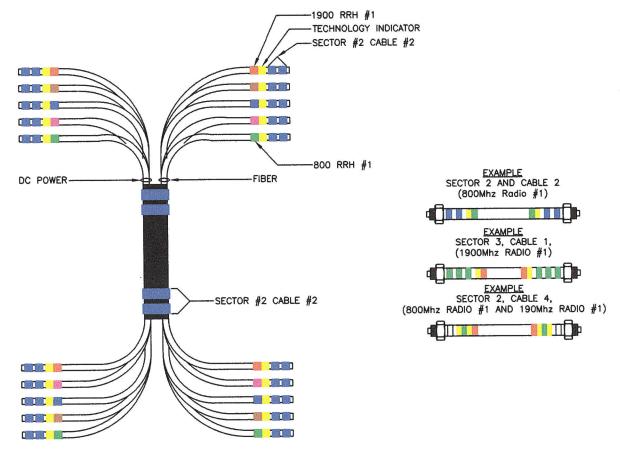
|  | TYPE 1                                       | TYPE 1                                       | TYPE 1                                       |
|--|--|--|--|
| TOTAL LENGTH                             | ~40m   | ~70m   | ~120m  |
| HYBRID POWER CABLE<br>CONFIGURATION      | AWG 8 1 PAIR,<br>AWG 10 3 PAIR               | AWG 6 1 PAIR,<br>AWG 8 3 PAIR                | AWG 4 1 PAIR,<br>AWG 6 3 PAIR                |
| CABLE DIAMETER                           | 32 mm  | 32 mm  | 36 mm  |
| BENDING RADIUS                           | 800 mm                                       | 800 mm                                       | 800 mm                                       |
| OPTIC CABLE                              | LC/PC-TO-LCPC<br>SINGLE MODE                 | LC/PC-TO-LCPC<br>SINGLE MODE                 | LC/PC-TO-LCPC<br>SINGLE MODE                 |
| RRU POWER CABLE SPEC                     | AWG 10, 4 PAIR                               | AWG 10, 4 PAIR                               | AWG 10, 4 PAIR                               |
| NON USE POWER AND OPTIC CABLE PROTECTION | 2 PAIR POWER AND OPTIC<br>CABLE WITH PE PIPE | 2 PAIR POWER AND OPTIC<br>CABLE WITH PE PIPE | 2 PAIR POWER AND OPTIC<br>CABLE WITH PE PIPE |

| HYBRID CABLE | SCALE: N.T.S. | 1 |
|--------------|---------------|---|
|              |               |   |



CYLINDER SCHMATIC DETAIL

| TECHNOLOGY<br>COLOR CODE | FIRST RING | SECOND RING |
|--------------------------|------------|-------------|
| 800 #1                   | YELLOW     | GREEN       |
| 1900 #1                  | YELLOW     | RED         |
| 1900 #2                  | YELLOW     | BROWN       |
| 1900 #3                  | YELLOW     | BLUE        |
| 1900 #4                  | YELLOW     | GREY        |
| 800 #1                   | YELLOW     | ORANGE      |
| 2500 #1                  | YELLOW     | WHITE       |
| 2500 #2                  | YELLOW     | PURPLE      |



## 2500MHz RADIO CALIBRATION CABLE COLOR CODE

| 2500MHz #1 CAL<br>CABLE — SECTOR | CABLE | FIRST RING  | SECOND RING  | THIRD RING | FOURTH RING   | FIFTH RING | SIXTH RING    |
|----------------------------------|-------|-------------|--------------|------------|---------------|------------|---------------|
| 1 ALPHA                          | 1     | YELLOW      |              | YELLOW     | WHITE         |            |               |
| 2 BETA                           | 2     | YELLOW      | YELLOW       |            | YELLOW        | WHITE      |               |
| 3 GAMMA                          | 3     | YELLOW      | YELLOW       | YELLOW     |               | YELLOW     | WHITE         |
| SANDANDE PARE PARE               |       |             |              |            |               |            |               |
| 2500MHz #2 CAL<br>CABLE - SECTOR | CABLE | FIRST RING  | SECOND RING  | THIRD RING | FOURTH RING   | FIFTH RING | SIXTH RING    |
| CABLE - SECTOR                   |       | 1 11.01 110 | BEOOMB Kills | THIRD KING | TOOKIII KII40 | TITTI KING | SIXTII TIIITO |
| 1 ALPHA                          | 1     | YELLOW      | SECOND PAINS | YELLOW     | PURPLE        | TH TH KING |               |
|                                  | 1 2   |             | YELLOW       |            |               | PURPLE     | John State    |

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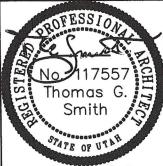
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SITE NAME

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SITE I.D.

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SHEET NAME

CABLE AND **COLOR CODING** 

SHEET NUMBER

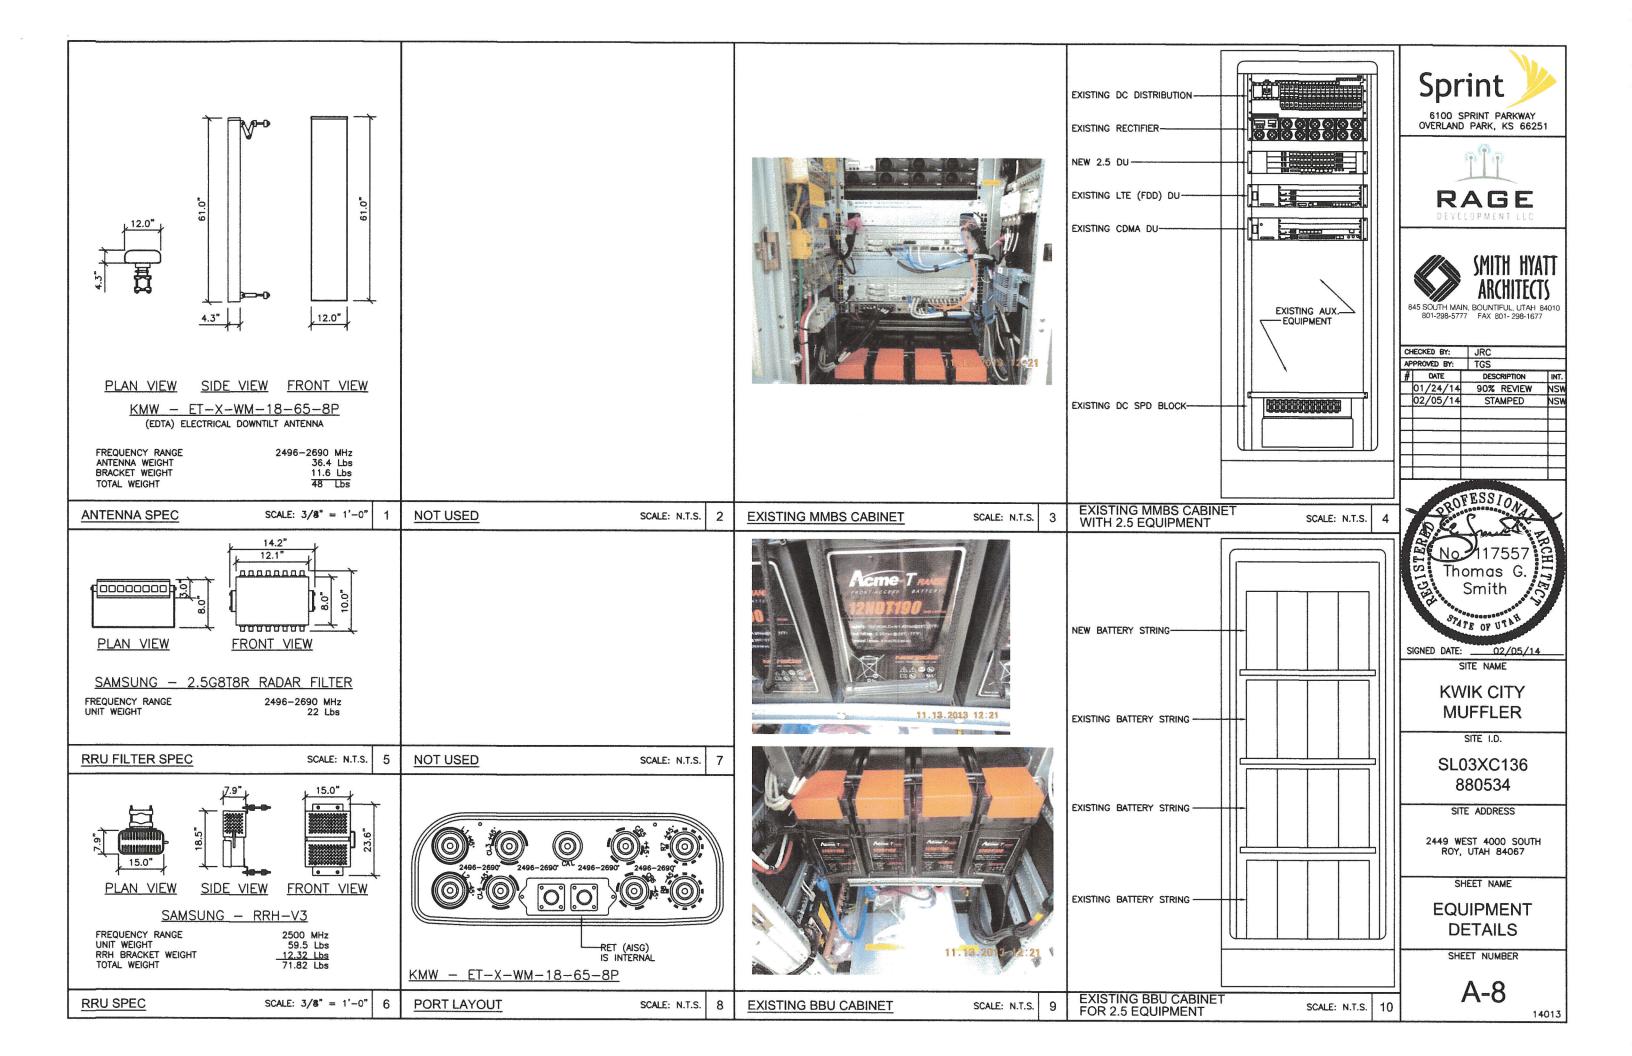
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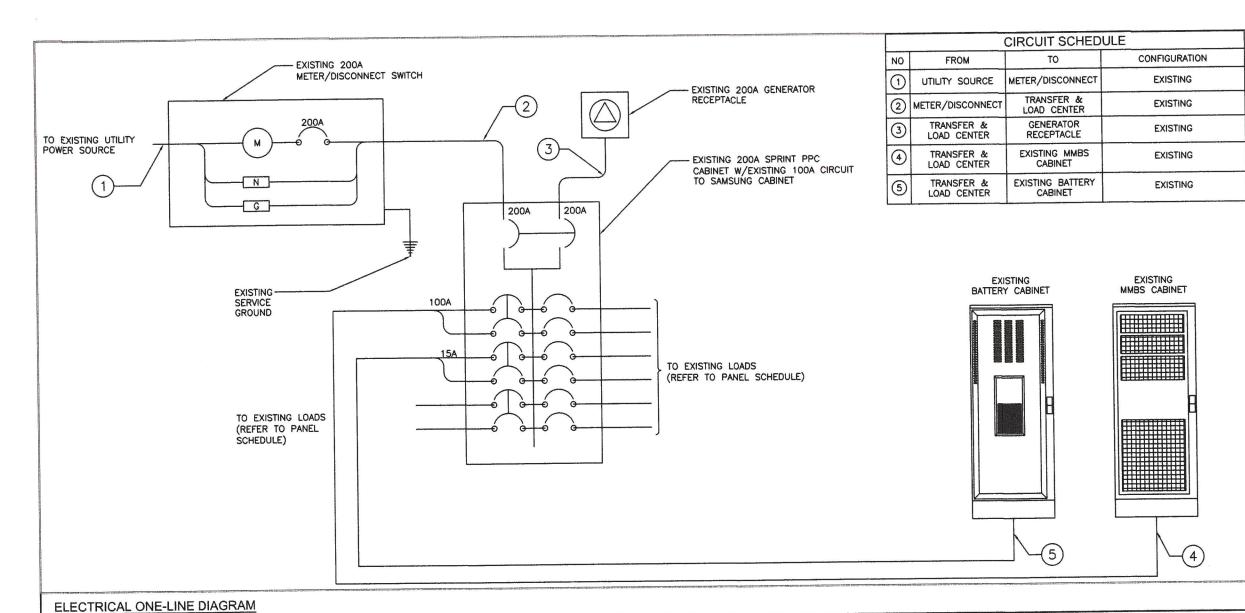
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**COLOR CODING** 

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## **ELECTRICAL NOTES**

- ALL ELECTRICAL WORK SHALL BE DONE IN ACCORDANCE WITH CURRENT NATIONAL ELECTRICAL CODES AND ALL LOCAL AND STATE CODE, LAWS, AND ORDINANCES. PROVIDE ALL COMPONENTS AND WIRING SIZES AS REQUIRED TO MEET NEC STANDARDS.
- CONTRACTOR SHALL COORDINATE WITH LOCAL POWER COMPANY FOR REQUIREMENTS OF POWER SERVICE LINE TO THE METER BASE. POWER SERVICE REQUIREMENT IS COMMERCIAL AC NOMINAL 120/208 VOLT OR 120/240 VOLT, SINGLE PHASE WITH 200 AMP RATING.
- CONTRACTOR SHALL COORDINATE WITH LOCAL TELEPHONE COMPANY FOR REQUIREMENTS OF "T1" SERVICE LINE TO TERMINATE AT THE PPC CABINET.
- UNDERGROUND POWER AND TELCO SERVICE LINES SHALL BE ROUTED IN A COMMON TRENCH. ALL UNDERGROUND CONDUIT SHALL BE PVC SCHEDULE 40 AND CONDUIT EXPOSED ABOVE GROUND SHALL BE RIGID GALVANIZED STEEL UNLESS OTHERWISE INDICATED.
- ALL TELCO CONDUIT LINES SHALL BE 4" SCH. 40 PVC CONDUIT UNLESS OTHERWISE INDICATED. THE TELCO CONDUIT FROM THE PPC SHALL BE ROUTED AND TERMINATED AT DESIGNATED TELCO DEMARCATION OR 2-FEET OUTSIDE FENCED AREA, NEAR UTILITY POLE (IN FENCED AREA), OR END CAP OFF AND PROVIDE MARKER STAKE PAINTED BRIGHT ORANGE WITH DESIGNATION FOR TELCO
- CONDUITS INSTALLED AT PCS EQUIPMENT ENDS PRIOR TO THE EQUIPMENT INSTALLATION SHALL BE STUBBED AND CAPPED AT 6" ABOVE GRADE OR PLATFORM. IF SERVICE LINES CAN'T BE INSTALLED NITIALLY, PROVIDE NYLON PULL CORD IN CONDUITS.
- THE SPRINT CABINET, INCLUDING 200 AMP LOAD PANEL AND TELCO PANEL, SHALL BE PROVIDED BY OWNER AND INSTALLED BY THE CONTRACTOR. CONTRACTOR IS TO INSTALL BREAKER(S) NOT PROVIDED BY MANUFACTURER. SEE PANEL SCHEDULE ON THIS SHEET FOR BREAKER
- LOCATION OF ELECTRIC METER AND DISCONNECT SWITCH TO BE COORDINATED BY ELECTRICAL CONTRACTOR AND FIELD CONSTRUCTION MANAGER.
- #2 WIRE TO BE UTILIZED IN ELECTRIC SERVICE RUNS EXCEEDING 100'.

- 10. CONTRACTOR SHALL INSPECT THE EXISTING CONDITIONS PRIOR TO SUBMITTING BID. ANY QUESTIONS ARISING DURING THE BID PERIOD IN REGARDS TO THE CONTRACTORS FUNCTIONS, THE SCOPE OF WORK, OR ANY OTHER ISSUE RELATED TO THIS PROJECT SHALL BE BROUGHT UP DURING THE BID PERIOD WITH THE PROJECT MANAGER FOR CLARIFICATION, NOT AFTER THE
- LOCATION OF EQUIPMENT, CONDUIT AND DEVICES SHOWN ON THE DRAWINGS ARE APPROXIMATE AND SHALL BE COORDINATED WITH FIELD CONDITIONS PRIOR TO ROUGH—IN.
- 12. THE CONDUIT RUNS AS SHOWN ON THE PLANS ARE APPROXIMATE. EXACT LOCATION AND ROUTING SHALL BE PER EXISTING FIELD CONDITIONS.
- PROVIDE PULL BOXES AND JUNCTION BOXES WHERE SHOWN OR REQUIRED BY NEC.
- 14. ALL CONDUITS SHALL BE MET WITH BENDS MADE IN ACCORDANCE WITH NEC TABLE 346-10. NO RIGHT ANGLE DEVICE OTHER THAN STANDARD CONDUIT ELBOWS WITH 12" MINIMUM INSIDE SWEEPS FOR ALL CONDUITS 2" OR LARGER.
- 15. ALL CONDUIT TERMINATIONS SHALL BE PROVIDED WITH PLASTIC THROAT INSULATING GROUNDING
- 16. ALL WIRE SHALL BE TYPE THWN, SOLID, ANNEALED COPPER UP TO SIZE #10 AWG (#8 AND LARGER SHALL BE CONCENTRIC STRANDED) 75 DEGREE C, (167 DEGREES F), 98% CONDUCTIVITY,
- 17. ALL WIRES SHALL BE TAGGED AT ALL PULL BOXES, J-BOXES, EQUIPMENT BOXES AND CABINETS WITH APPROVED PLASTIC TAGS, ACTION CRAFT, BRADY, OR APPROVED EQUAL.
- 18. ALL NEW MATERIAL SHALL HAVE A U.L. LABEL
- 19. CONDUIT ROUGH-IN SHALL BE COORDINATED WITH THE MECHANICAL EQUIPMENT TO AVOID LOCATION TO CONFLICTS. VERIFY WITH MECHANICAL CONTRACTOR AND COMPLY AS REQUIRED.
- 20. ALL PANEL DIRECTORIES SHALL BE TYPEWRITTEN NOT HAND WRITTEN.

- 21. INSTALL AN EQUIPMENT GROUNDING CONDUCTOR IN ALL CONDUITS PER THE SPECIFICATIONS AND NEC. THE EQUIPMENT GROUNDING CONDUCTORS SHALL BE BONDED AT ALL JUNCTION BOXES, PULL BOXES, AND ALL DISCONNECT SWITCHES, STARTERS, AND EQUIPMENT CABINETS.
- 22. THE CONTRACTOR SHALL PREPARE AS—BUILT DRAWINGS, DOCUMENT ANY AND ALL WIRING AND EQUIPMENT CONDITIONS AND CHANGES WHILE COMPLETING THIS CONTRACT. SUBMIT AT
- 23. ALL DISCONNECT SWITCHES AND OTHER CONTROLLING DEVICES SHALL BE PROVIDED WITH ENGRAVED PHENOLIC NAMEPLATES INDICATING EQUIPMENT CONTROLLED, BRANCH CIRCUITS INSTALLED ON, AND PANEL FIELD LOCATIONS FED FROM (NO EXCEPTIONS.)
- 24. ALL ELECTRICAL DEVICES AND INSTALLATIONS OF THE DEVICES SHALL COMPLY WITH (ADA) AMERICANS WITH DISABILITIES ACT AS ADOPTED BY THE APPLICABLE STATE.
- 25. PROVIDE CORE DRILLING AS NECESSARY FOR PENETRATIONS OR RISERS THROUGH BUILDING. DO PROVIDE CORE DRILLING AS NECESSARY FOR PENETRATIONS OR RISERS INKOUGH BUILDING, DO NOT PENETRATE STRUCTURAL MEMBERS WITHOUT CONSTRUCTION MANAGERS APPROVAL. SLEEVES AND/OR PENETRATIONS IN FIRE RATED CONSTRUCTION SHALL BE PACKED WITH FIRE RATED MATERIAL WHICH SHALL MAINTAIN THE FIRE RATING OF THE WALL OR STRUCTURE, FILL FOR FLOOR PENETRATIONS SHALL PREVENT PASSAGE OF WATER, SMOKE, FIRE AND FUMES. ALL MATERIAL SHALL BE UL APPROVED FOR THIS PURPOSE.
- 26. ELECTRICAL CHARACTERISTICS OF ALL EQUIPMENT (NEW AND EXISTING) SHALL BE FIELD VERIFIED WITH THE OWNER'S REPRESENTATIVE AND EQUIPMENT SUPPLIER PRIOR TO ROUGH-IN OF CONDUIT AND WIRE. ALL EQUIPMENT SHALL BE PROPERLY CONNECTED ACCORDING TO THE NAMEPLATE DATA FURNISHED ON THE EQUIPMENT (THE DESIGN OF THESE PLANS ARE BASED UPON BEST AVAILABLE INFORMATION AT THE TIME OF DESIGN AND SOME EQUIPMENT CHARACTERISTICS MAY VARY FROM DESIGN AS SHOWN ON THESE DRAWINGS)
- 27. LOCATION OF ALL OUTLET, BOXES, ETC., AND THE TYPE OF CONNECTION (PLUG OR DIRECT) SHALL BE CONFIRMED WITH THE OWNER'S REPRESENTATIVE PRIOR TO ROUGH-IN.
- 28. SPLIT BREAKERS SHALL BE USED ON 120V LOADS IN THE EVENT THAT ADDITIONAL CIRCUIT SPACE IS REQUIRED FOR NEW EQUIPMENT.
- 29. PANEL SCHEDULE LOADING AND CIRCUIT ARRANGEMENT ON E-1 REFLECTS MIGRATION PERIOD CIRCUMSTANCES. REFER TO E-4 FOR POST-MIGRATION PANEL SCHEDULE LOADING AND CIRCUIT ARRANGEMENT IN WHICH EXISTING LEGACY EQUIPMENT HAS BEEN REMOVED.

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OVERLAND PARK, KS 66251





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| #           | DATE       | DESCRIPTION | INT. |  |
| -           | 01/24/14   | 90% REVIEW  | NSV  |  |
|             | 02/05/14   | STAMPED     | NSV  |  |
|             |            |             |      |  |
|             |            |             |      |  |
| _           |            |             |      |  |
|             |            |             |      |  |
|             |            |             |      |  |



SIGNED DATE: 02/05/14

SITE NAME

**KWIK CITY MUFFLER** 

SITE I.D.

SL03XC136 880534

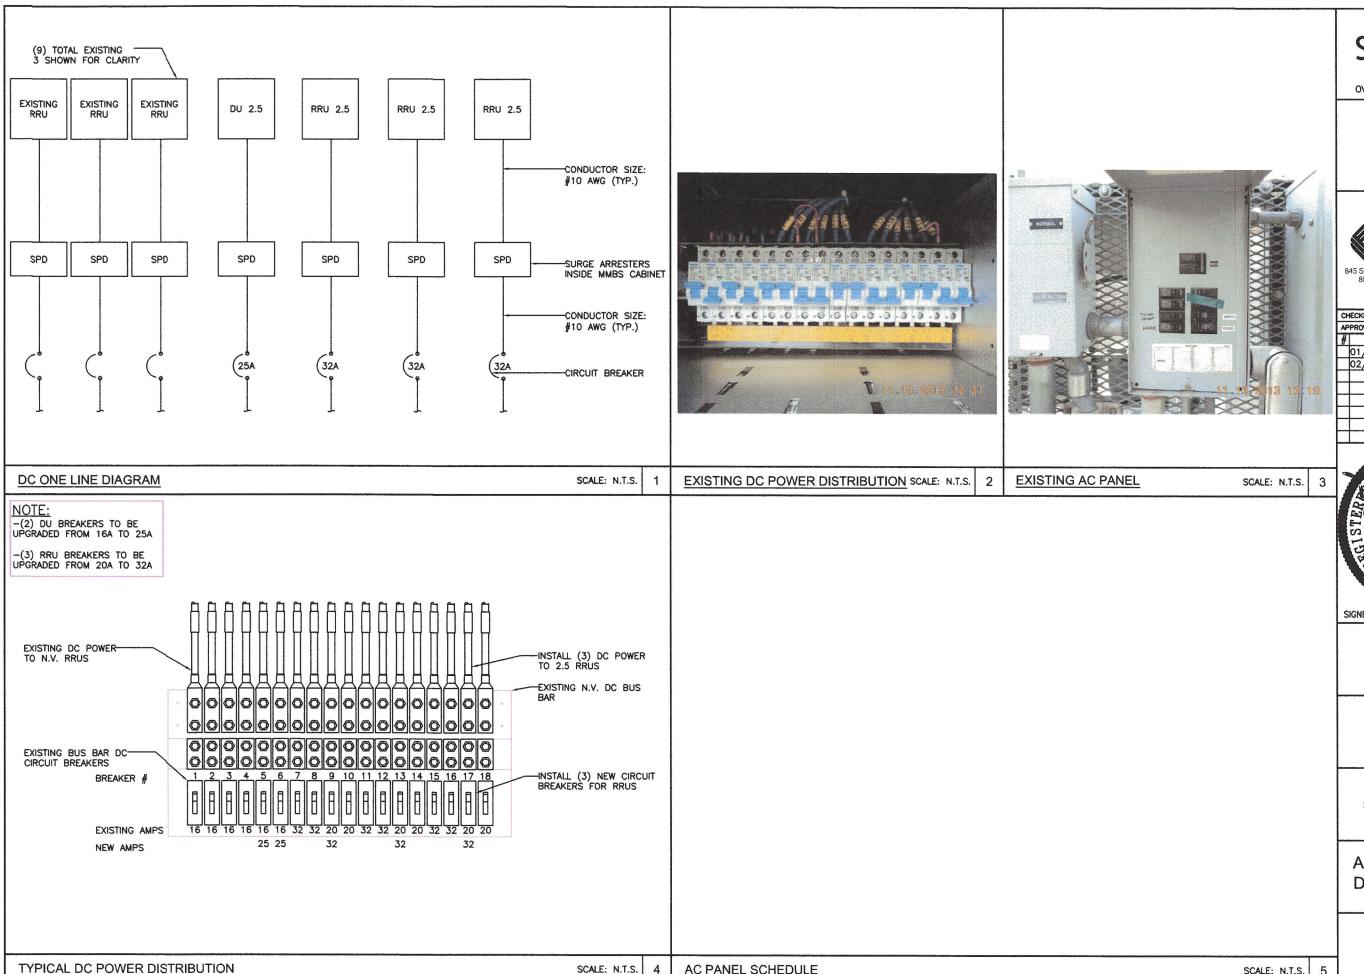
SITE ADDRESS

2449 WEST 4000 SOUTH ROY, UTAH 84067

SHEET NAME

**AC POWER** DISTRIBUTION

SHEET NUMBER



SCALE: N.T.S.

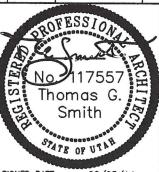
AC PANEL SCHEDULE

Sprint 6100 SPRINT PARKWAY OVERLAND PARK, KS 66251





| CH | HECKED BY: | JRC         |      |  |
|----|------------|-------------|------|--|
| AF | PROVED BY: | TGS         |      |  |
| #  | DATE       | DESCRIPTION | INT. |  |
|    | 01/24/14   | 90% REVIEW  | NSW  |  |
|    | 02/05/14   | STAMPED     | NSW  |  |
|    |            |             |      |  |
|    |            |             |      |  |
|    |            |             |      |  |
|    |            |             | _    |  |



SIGNED DATE: 02/05/14

SITE NAME

**KWIK CITY MUFFLER** 

SITE I.D.

SL03XC136 880534

SITE ADDRESS

2449 WEST 4000 SOUTH ROY, UTAH 84067

SHEET NAME AC & DC POWER **DISTRIBUTION & SCHEDULE** 

SHEET NUMBER

5

SCALE: N.T.S.

