

# The Barn at Terakee Farms® No. 1

A PRUD Subdivision

A part of Section 17, T6N, R2W, SLB&M, U.S. Survey

Weber County, Utah

July 2020

\* See All Sheets\*

**NOTES**

- All construction shall conform to Weber County standards and specifications.
- Underground utility piping materials will meet or exceed Weber County Standards.
- Culinary water services will be 3/4" Dia. C-900 DR14 PVC to be centered on the frontage and extended 10' beyond the right of way line.
- 4" Sanitary sewer laterals to be constructed 10' down slope from the center of the lot and extended 10' beyond the right of way line.
- All Utility trenches within the Street right of way shall have a County approved imported granular backfill.
- Thrust block all water line fittings.
- All inlet grates shall be bicycle safe.
- All fire hydrants and access roads shall be installed prior to any construction of any buildings.
- All fire hydrants shall be placed with 4 1/2 inch connections facing the point of access for the Fire Department Apparatus.
- Prior to the beginning of construction of any buildings, a fire flow test of new hydrants shall be conducted to verify the actual fire flow for this project. The Fire Prevention Division shall witness this test and shall be notified a minimum of 48 hours prior to the test.
- Curb & gutter installed along 900 South Street will be set to ensure a 1.5% minimum/3.0% Maximum cross slope from edge of asphalt. Contractor to verify prior to construction of curb.
- An excavation permit is required for all work done within the existing Right of Way.
- A Storm Water Construction Activity Permit is required for any construction that disturbs more than 5000 Sq. Ft. or 200 Cubic Yards.
- All improvements need to be either installed or escrowed prior to recording of the subdivision.
- If construction activity will disturb more than an acre then a State SWPPP will be required. This includes the construction of the homes etc. on each lot.
- Private Roads that are less than 32 feet in width shall be posted with "NO PARKING FIRE LANE" on the West and South sides as indicated on the Grading and Drainage plan. (Roadways and signage shall comply with appendix D of the 2015 International Fire Code as adopted by Weber Fire District).
- Construct ADA Ramps with Truncated Domes with detectable warning systems cast in place, gray in color per APWA Plan 235.1.

**GENERAL UTILITY NOTES:**

- Coordinate all utility connections to building with plumbing plans and building contractor.
- Verify depth and location of all existing utilities prior to constructing any new utility lines. Notify Civil Engineer of any discrepancies or conflicts prior to any connections being made.
- All catch basin and inlet box grates are to be bicycle proof.
- All inlet boxes located in curb and gutter are to be placed parallel to the curb and gutter and set under the frame and grate. Improperly placed boxes will be removed and replaced at no additional cost to the owner. Precast or cast in place boxes are acceptable.
- Refer to the site electrical plan for details and locations of electrical lines, transformers and light poles.
- Gas lines, telephone lines, and cable TV lines are not a part of these plans unless otherwise noted.
- Water meters are to be installed per water district standards and specifications. It will be the contractor's responsibility to install all items required.
- Water lines, valves, fire hydrants, fittings etc. are to be constructed as shown. Contractor is responsible to construct any vertical adjustments necessary to clear sewer, storm drain or other utilities as necessary including valve boxes and hydrant spools to proper grade.
- Field verify all existing and/or proposed Roof Drain/Roof Drain down spout connections to Storm Water System with Civil, Plumbing & Architectural plans. Notify Engineer of any discrepancies.
- All gravity flow utility lines shall be installed prior to any pressurized utilities unless written permission is obtained from the engineer of record before construction begins.

**UTILITY PIPING MATERIALS:**

All piping to be installed per manufacturers recommendations. Refer to project specifications for more detailed information regarding materials, installation, etc.

**CULINARY SERVICE LATERALS**

- 3/4" to 2" diameter pipe - copper tube ASTM B, Type K, Soft Temper
- Over 2" diameter pipe - AWWA C-900 Class 150 pipe

**WATER MAIN LINES AND FIRE LINES**

- Pipe material as shown on utility plan view or to meet County standards.

**SANITARY SEWER LINES**


- All sewer piping to be Polyvinyl Chloride (PVC) sewer pipe, ASTM D 3034, Type PSM, SDR 35

**STORM DRAIN LINES**


- 10" pipes or smaller - Polyvinyl Chloride (PVC) sewer pipe, ASTM D3034, Type PSM, SDR 35
- 12" to 21" pipes - Reinforced Concrete Pipe, ASTM C14, Class III up to 13' of cover. For greater than 13' feet of cover, use reinforced concrete pipe and classes listed below.
- 24" pipes or larger - Reinforced Concrete Pipe, ASTM C76, Class IV up to 13' of cover, Class IV for 13' to 21' of cover, Class V for 21' to 32' of cover, and Special Design for cover greater than 32 feet.

**CAUTION NOTICE TO CONTRACTOR**  
The contractor is specifically cautioned that the location and/or elevation of existing utilities as shown on these plans are based on records of the various utility companies and, where possible, measurements taken in the field. The information is not to be relied on as being exact or complete. The contractor must call the appropriate utility company at least 48 hours before any excavation to request exact field location of utilities. It shall be the responsibility of the contractor to relocate all existing utilities which conflict with the proposed improvements shown on the plans.

**PRIVATE ENGINEER'S NOTICE TO CONTRACTORS**  
The Contractor agrees that he shall assume sole and complete responsibility for job site conditions during the course of construction of this project, including safety of all persons and property; that this requirement shall apply continuously and not be limited to normal working hours; and that the contractor shall defend, indemnify, and hold the owner and the engineer harmless from any and all liability, real or alleged, in connection with the performance of work on this project, excepting for liability arising from the sole negligence of the owner or the engineer.



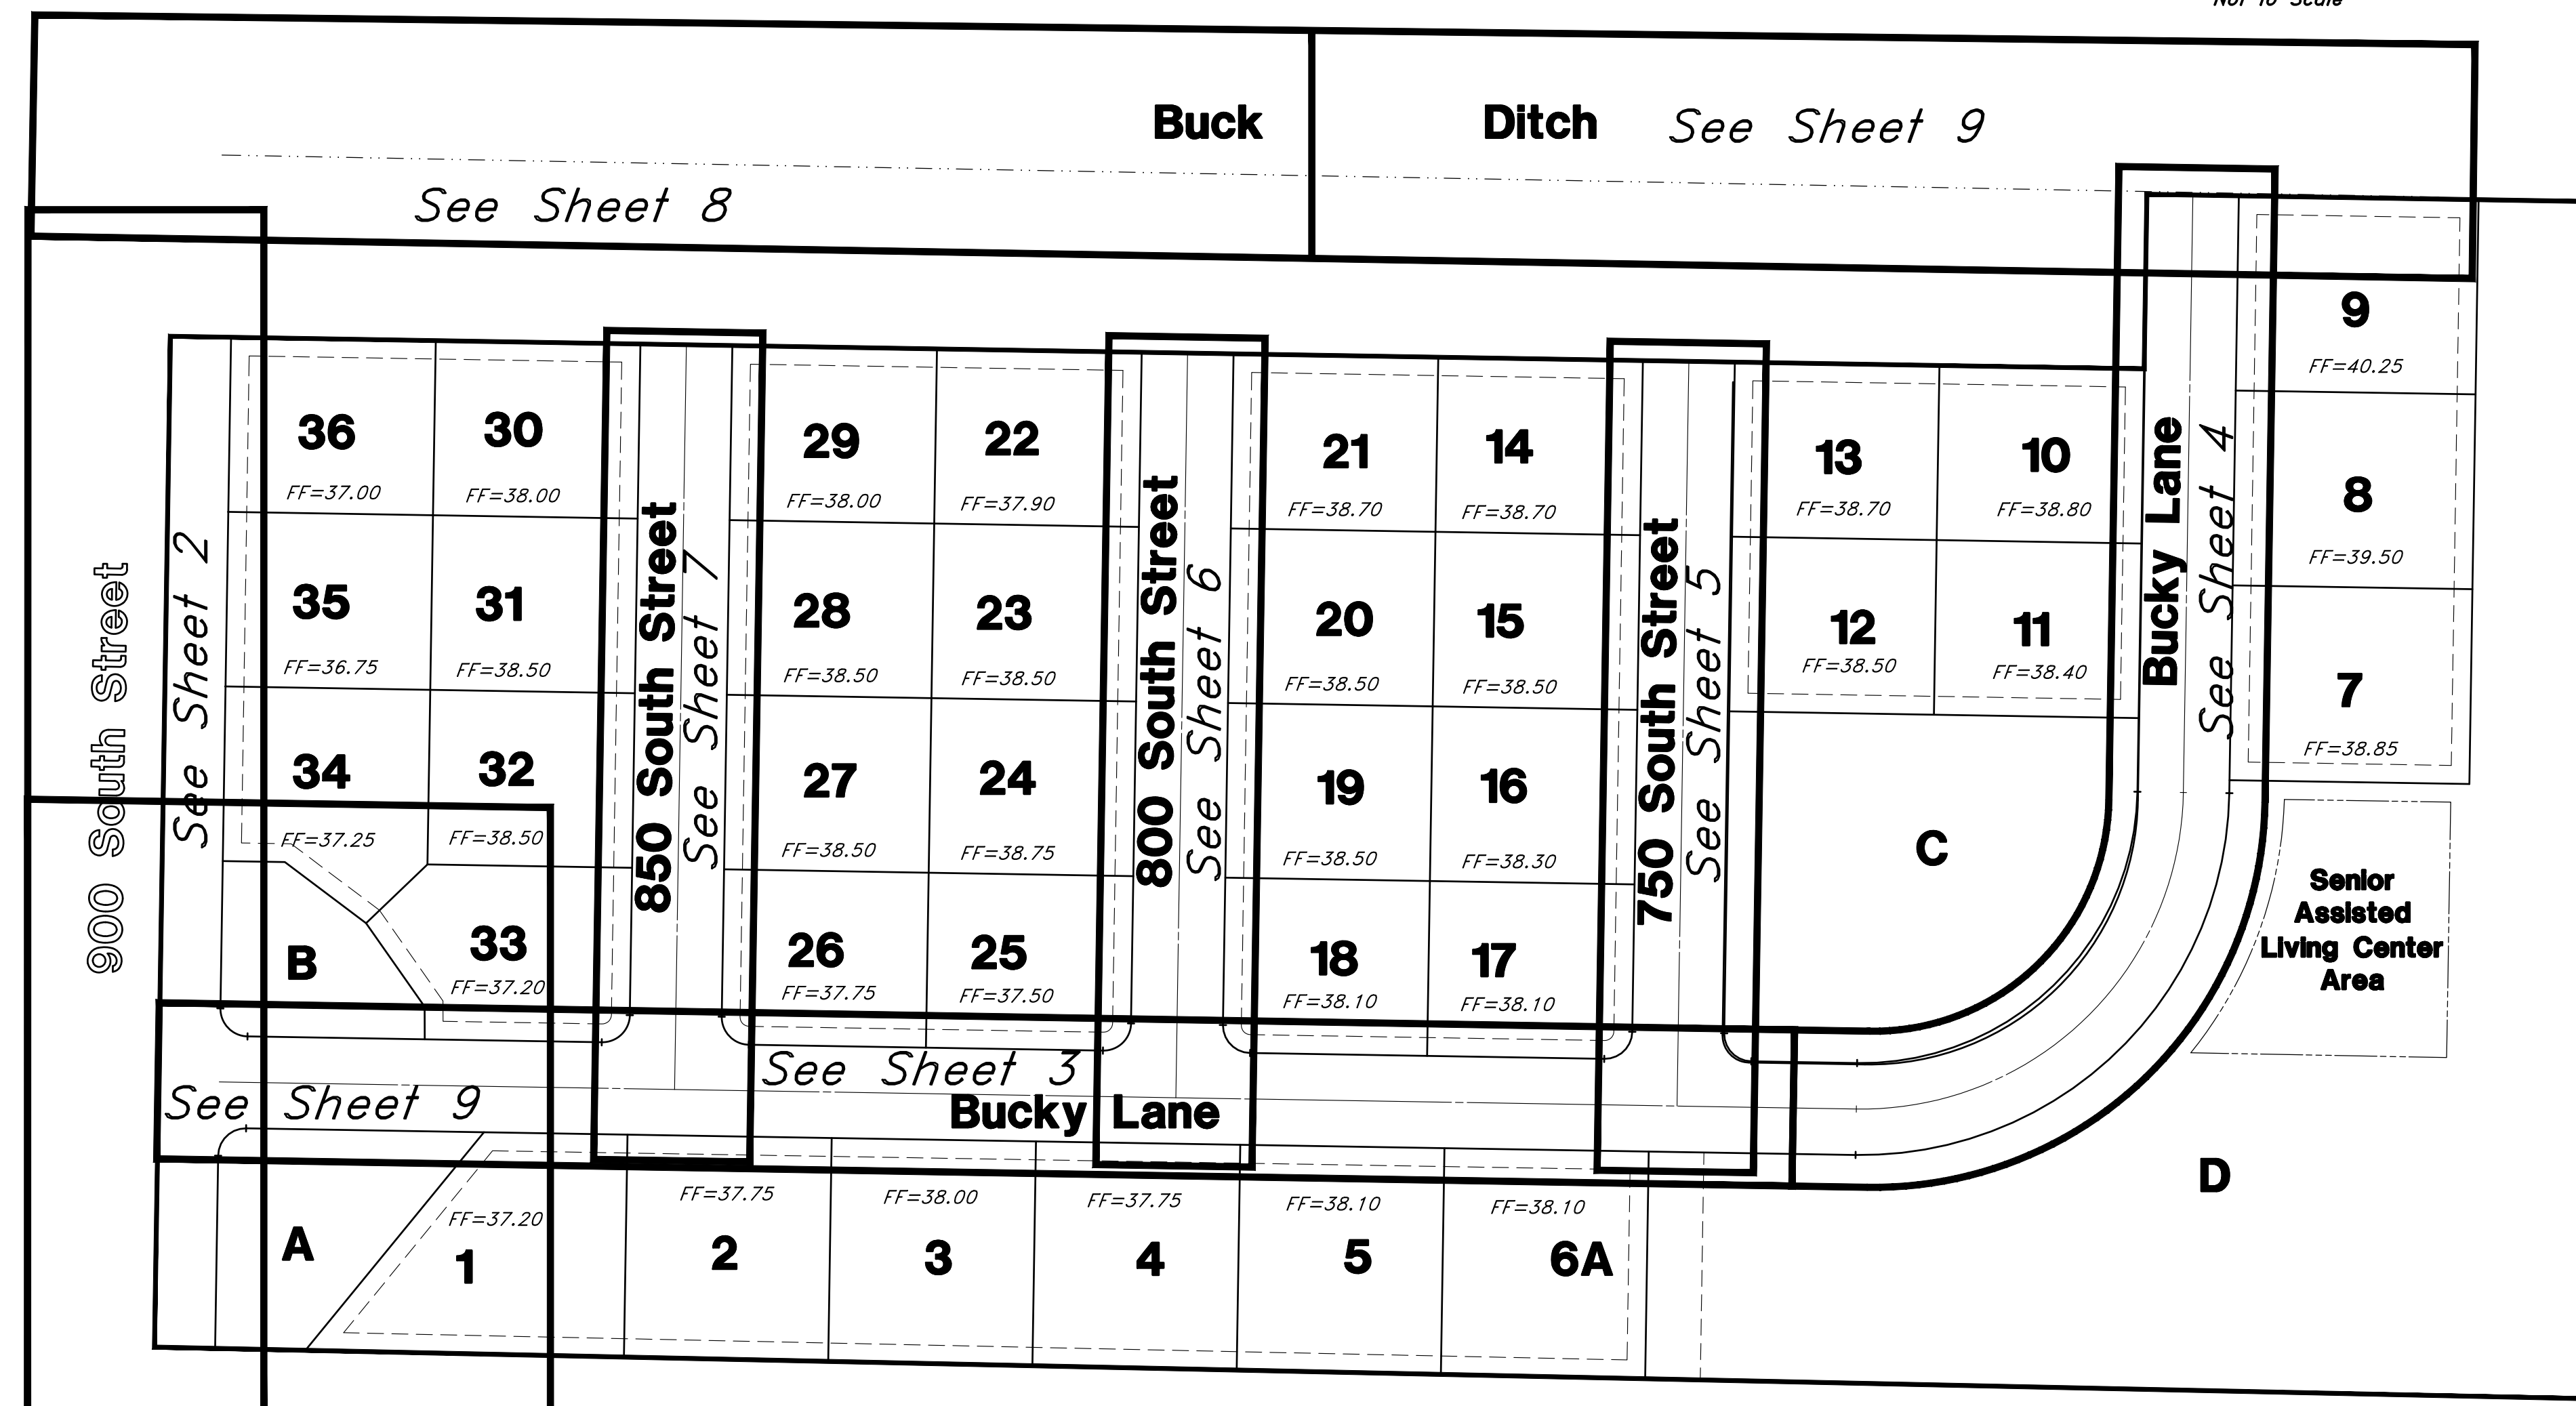


FF = Lowest allowable livable Finished Floor Elevation unless approved by Geotechnical Engineer and County Engineer due to ground water table.

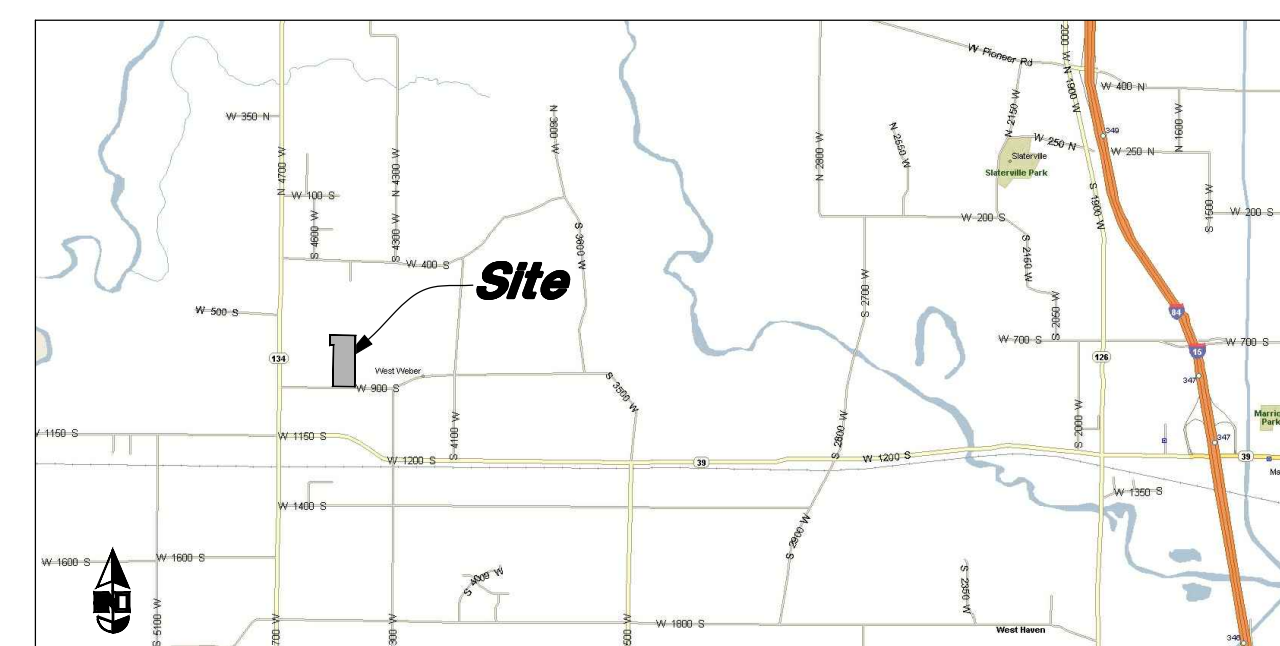

**Legend**

- (Note: All items may not appear on drawing)
- San. Sewer Manhole
  - Water Manhole
  - Storm Drain Manhole
  - Cleanout
  - Electrical Manhole
  - Catch Basins
  - Exist. Fire Hydrant
  - Exist. Water Valve
  - Water Valve
  - Sanitary Sewer
  - Culinary Water
  - Gas Line
  - Irrigation Line
  - Storm Drain
  - Telephone Line
  - Secondary Waterline
  - Power Line
  - Fire Line
  - Land Drain
  - Power pole
  - Power pole w/guy
  - Light Pole
  - Fence
  - Flowline of ditch
  - Overhead Power line
  - Corrugated Metal Pipe
  - Concrete Pipe
  - Reinforced Concrete Pipe
  - Ductile Iron
  - Polyvinyl Chloride
  - Top of Asphalt
  - Edge of Asphalt
  - Centerline
  - Centerline
  - Finish Floor
  - Top of Curb
  - Top of Wall
  - TWL
  - TW
  - Top of Concrete
  - Natural Ground
  - Finish Grade
  - Match Existing
  - Fire Department Connection
  - ME
  - Finish Contour
  - Exist. Contour
  - Finish Grade
  - Exist. Grade
  - Ridge Line
  - Direction of Flow

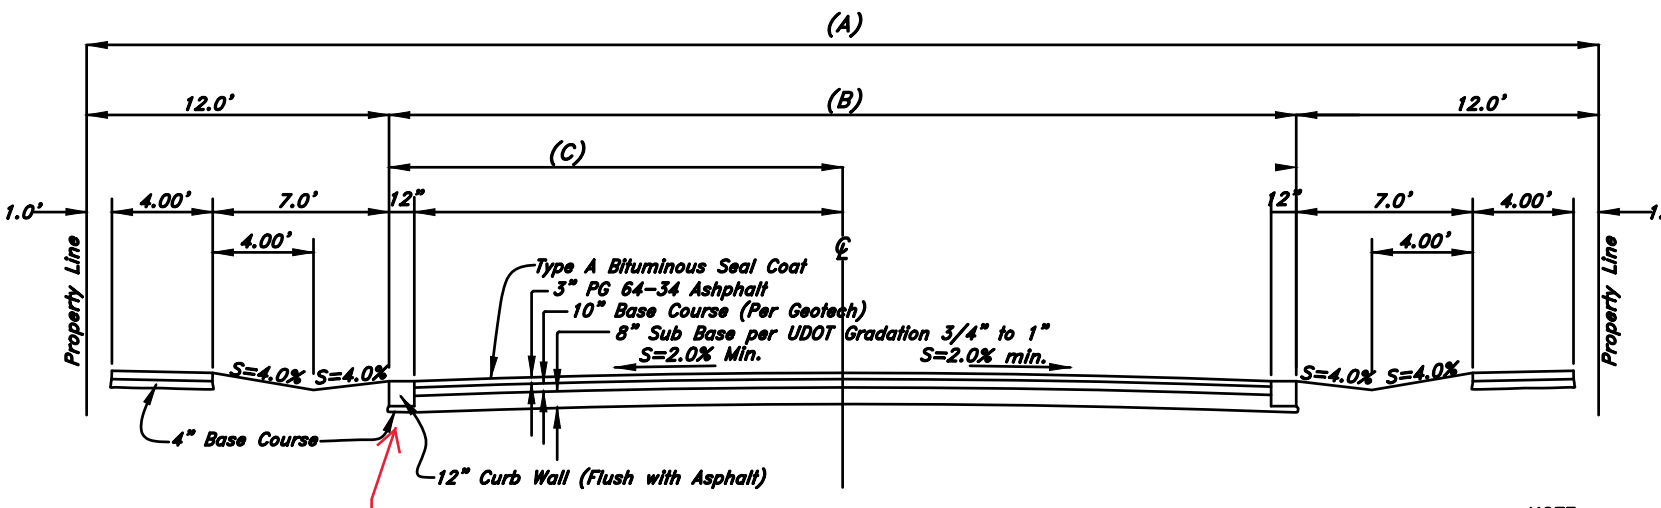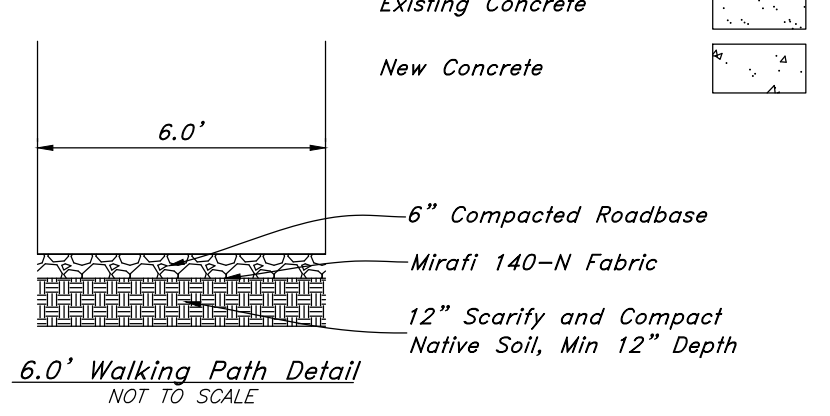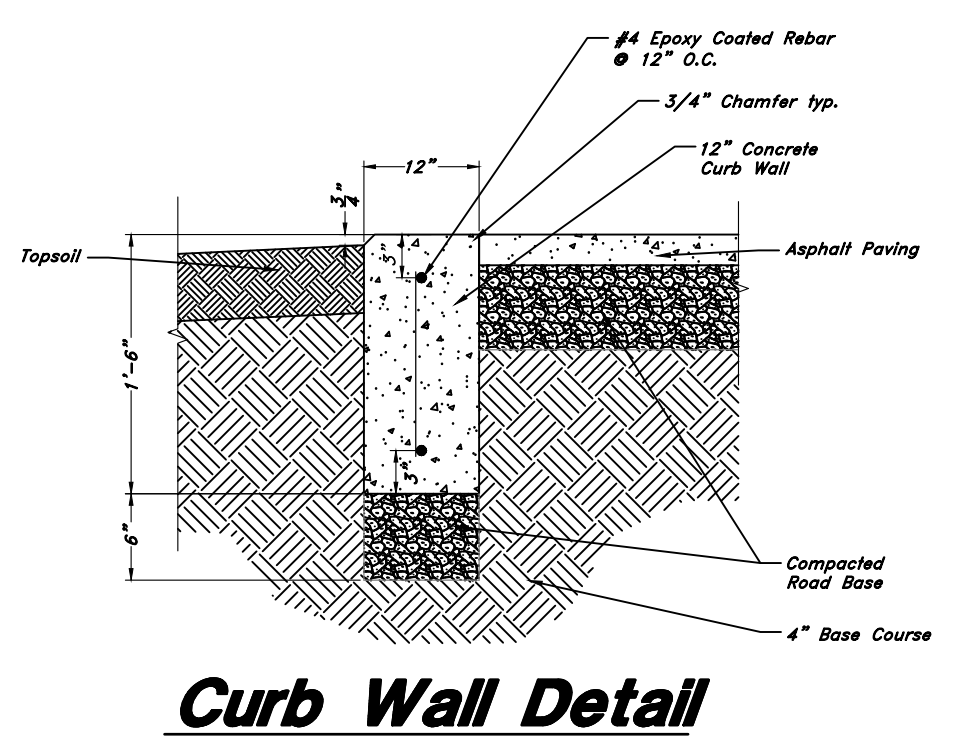

NOTE: County Engineer may specify use of standard high back curb & gutter on collector & arterials.

Street Designation	R.O.W. Width (A)	T.B.C. (B)	CL to T.B.C. (C)
Minor (Private)	50.0'	26.0'	15.0'
Collector	66.0'	47.0'	25.5'


NOTE: 1 - Maximum difference in elevation between curbs on opposite sides of street shall not exceed 1.0"

\*2- On arterial streets the County Engineer will provide a pavement design. Location of sidewalk and rolled curb & gutter may vary on individual arterial streets per direction of the County Engineer.

3 - See Geotechnical Engineering Study prepared by CMT Engineering Laboratories Project No. 10241, dated October 2018 for preparation of Sub Grade.

**FOR CONSTRUCTION**

REV	DATE	DESCRIPTION

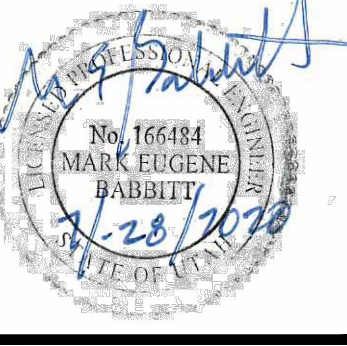

**GREAT BASIN ENGINEERING**  
 5746 SOUTH 1475 EAST, BODEN, UTAH 84403  
 801-392-7540  
 WWW.GREATBASINENGINEERING.COM

**Plan & Profile**  
**The Barn at Terakee Farms No. 1**  
 Approx. 900 South 4500 West  
 Weber County, Utah  
 A part of Section 17, T6N, R2W, SLB&M, U.S. Survey

20 July, 2020


SHEET NO. **1** of 11




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(Note: All items may not appear on drawing)


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- Secondary Waterline
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- Fire Line
- Land Drain
- Power pole
- Power pole w/guy
- Light Pole
- Fence
- Flawline of ditch
- Overhead Power line
- Corrugated Metal Pipe
- Concrete Pipe
- Reinforced Concrete Pipe
- Ductile Iron
- Polyvinyl Chloride
- PVC
- Top of Asphalt
- Edge of Asphalt
- Centerline
- Flowline
- Finish Floor
- Top of Curb
- TC
- Top of Wall
- TWN
- Top of Walk
- TCN
- Top of Concrete
- NG
- Natural Ground
- Finish Grade
- ME
- Match Existing
- Fire Department Connection
- Finish Contour
- Exist. Contour
- Finish Grade
- Exist. Grade
- Ridge Line
- Existing Asphalt
- New Asphalt
- Heavy Duty Asphalt
- Existing Concrete
- New Concrete
- Spill Curb & Gutter

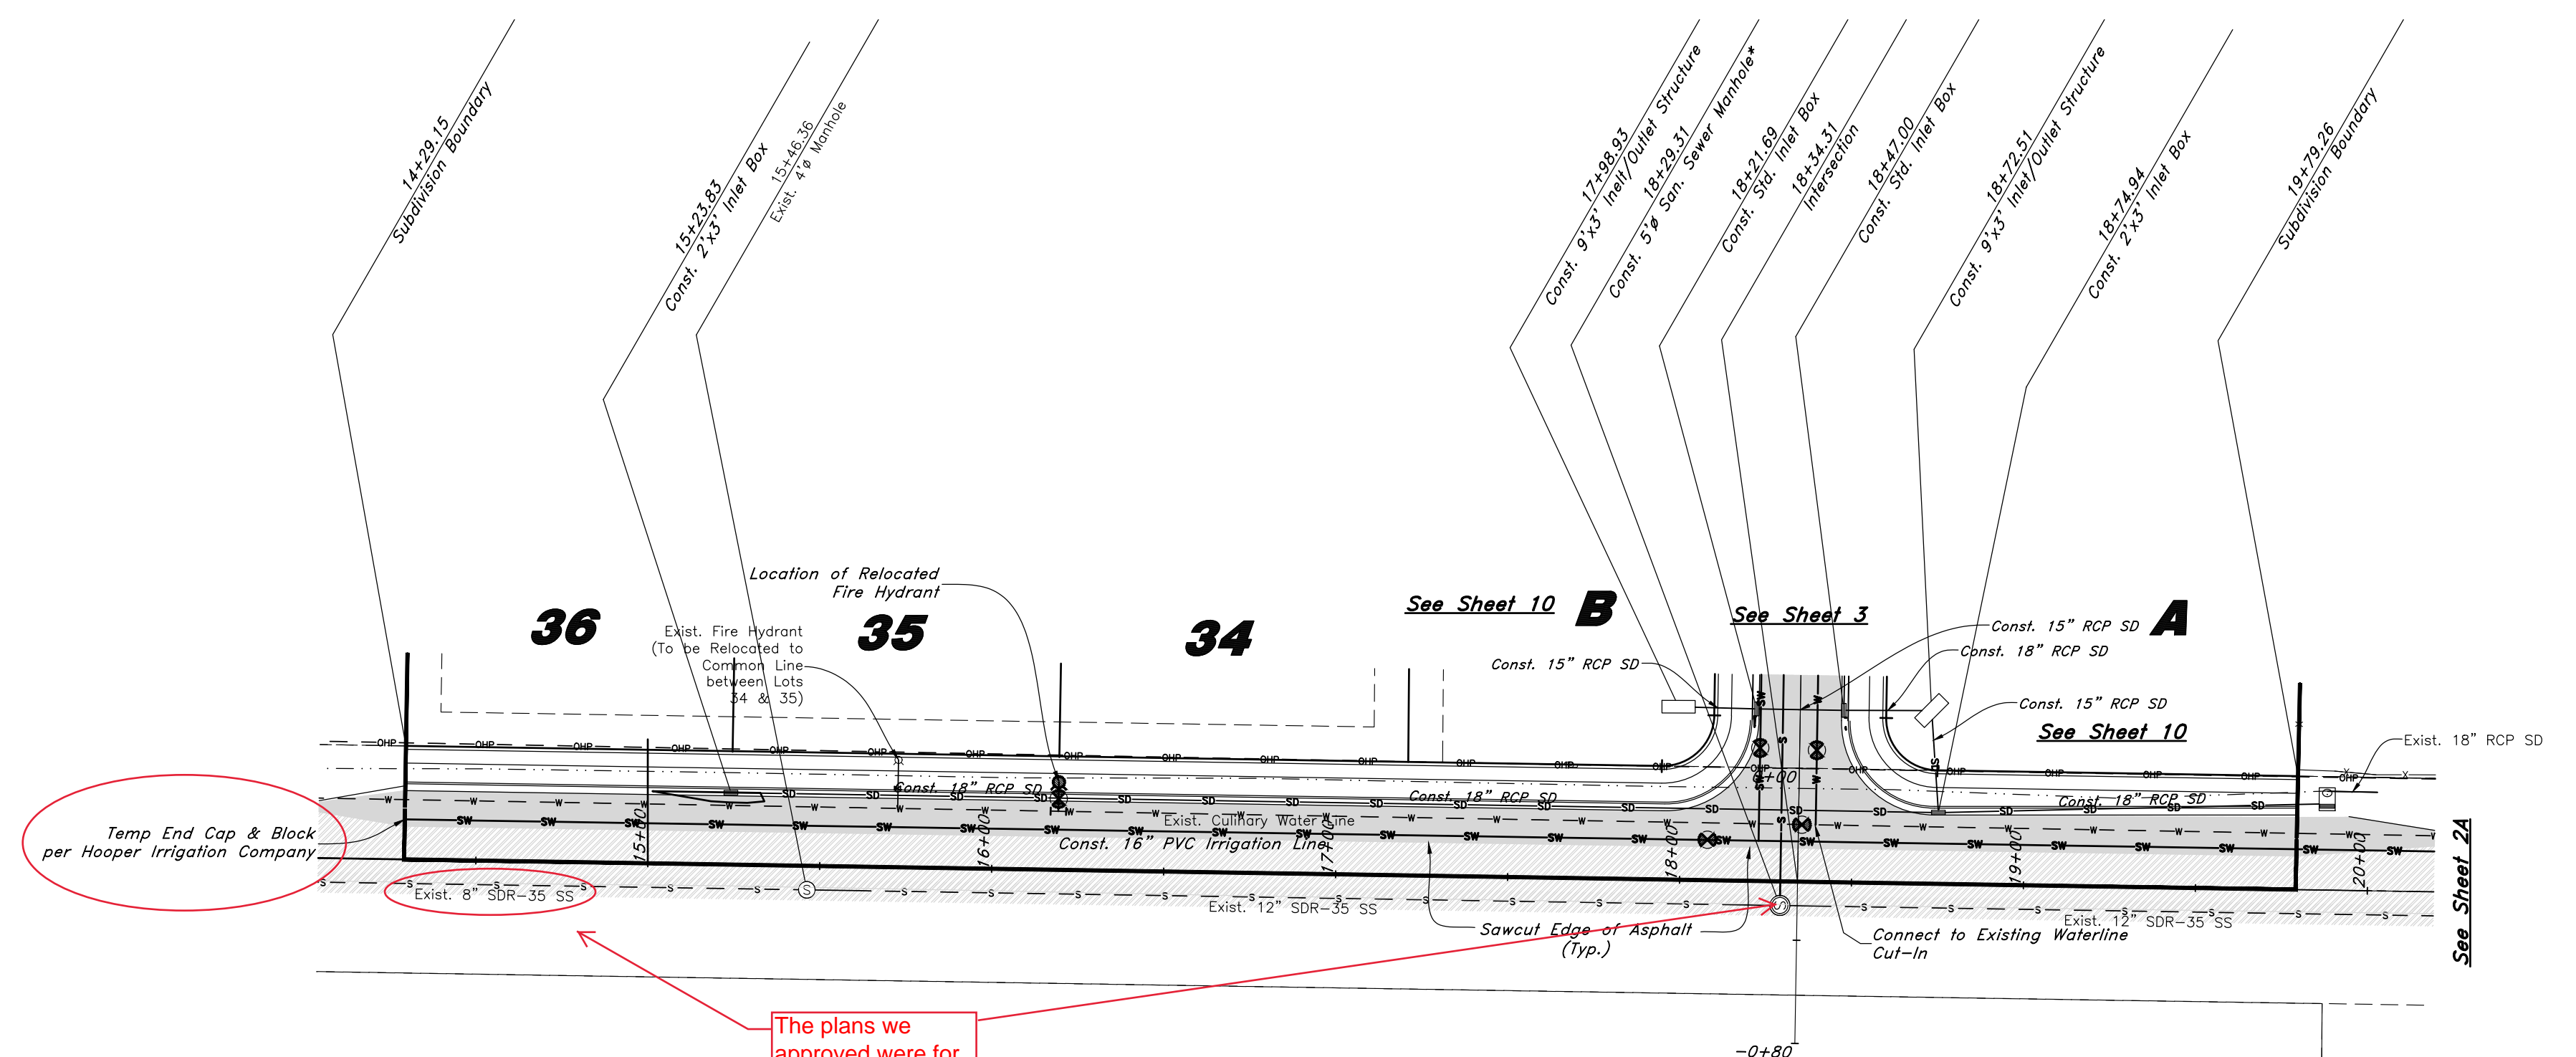


The plans we approved were for 12" all the way. But I believe the sewer was just installed to this manhole.

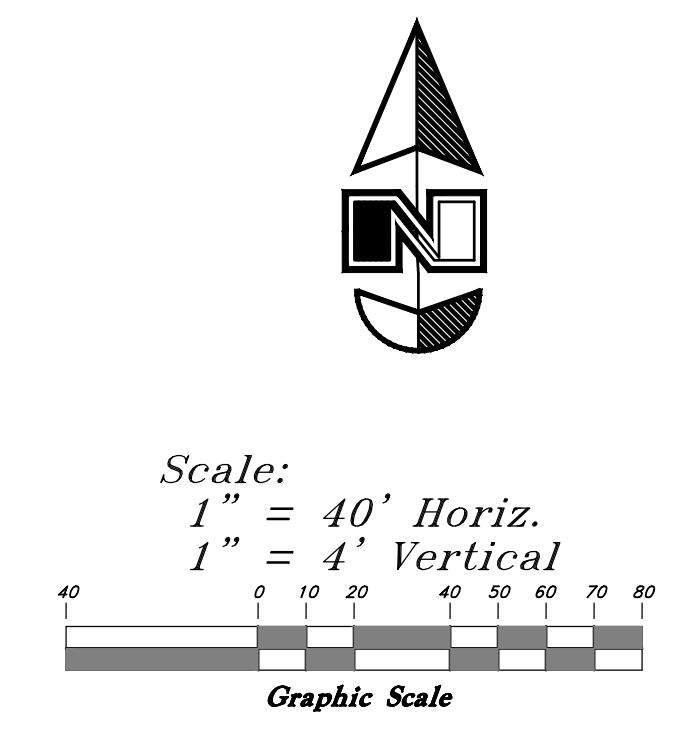

## 900 South Street

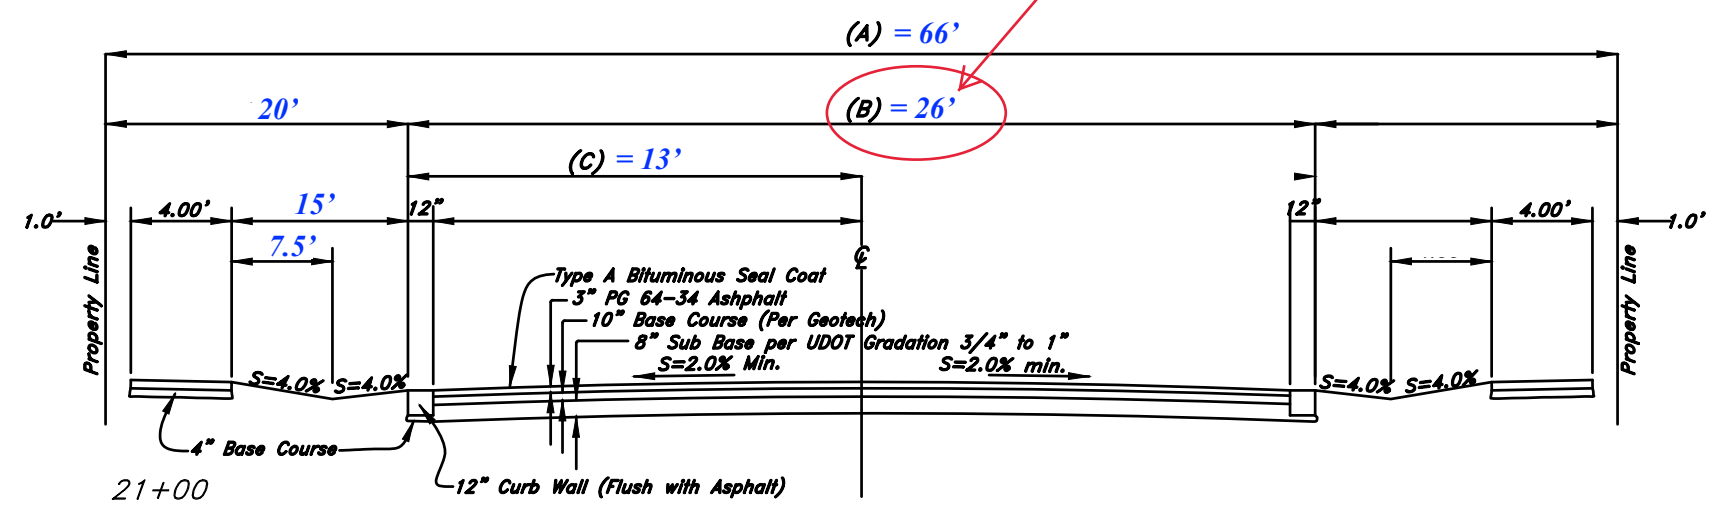

This will need to be at least 36ft. on 900 South.

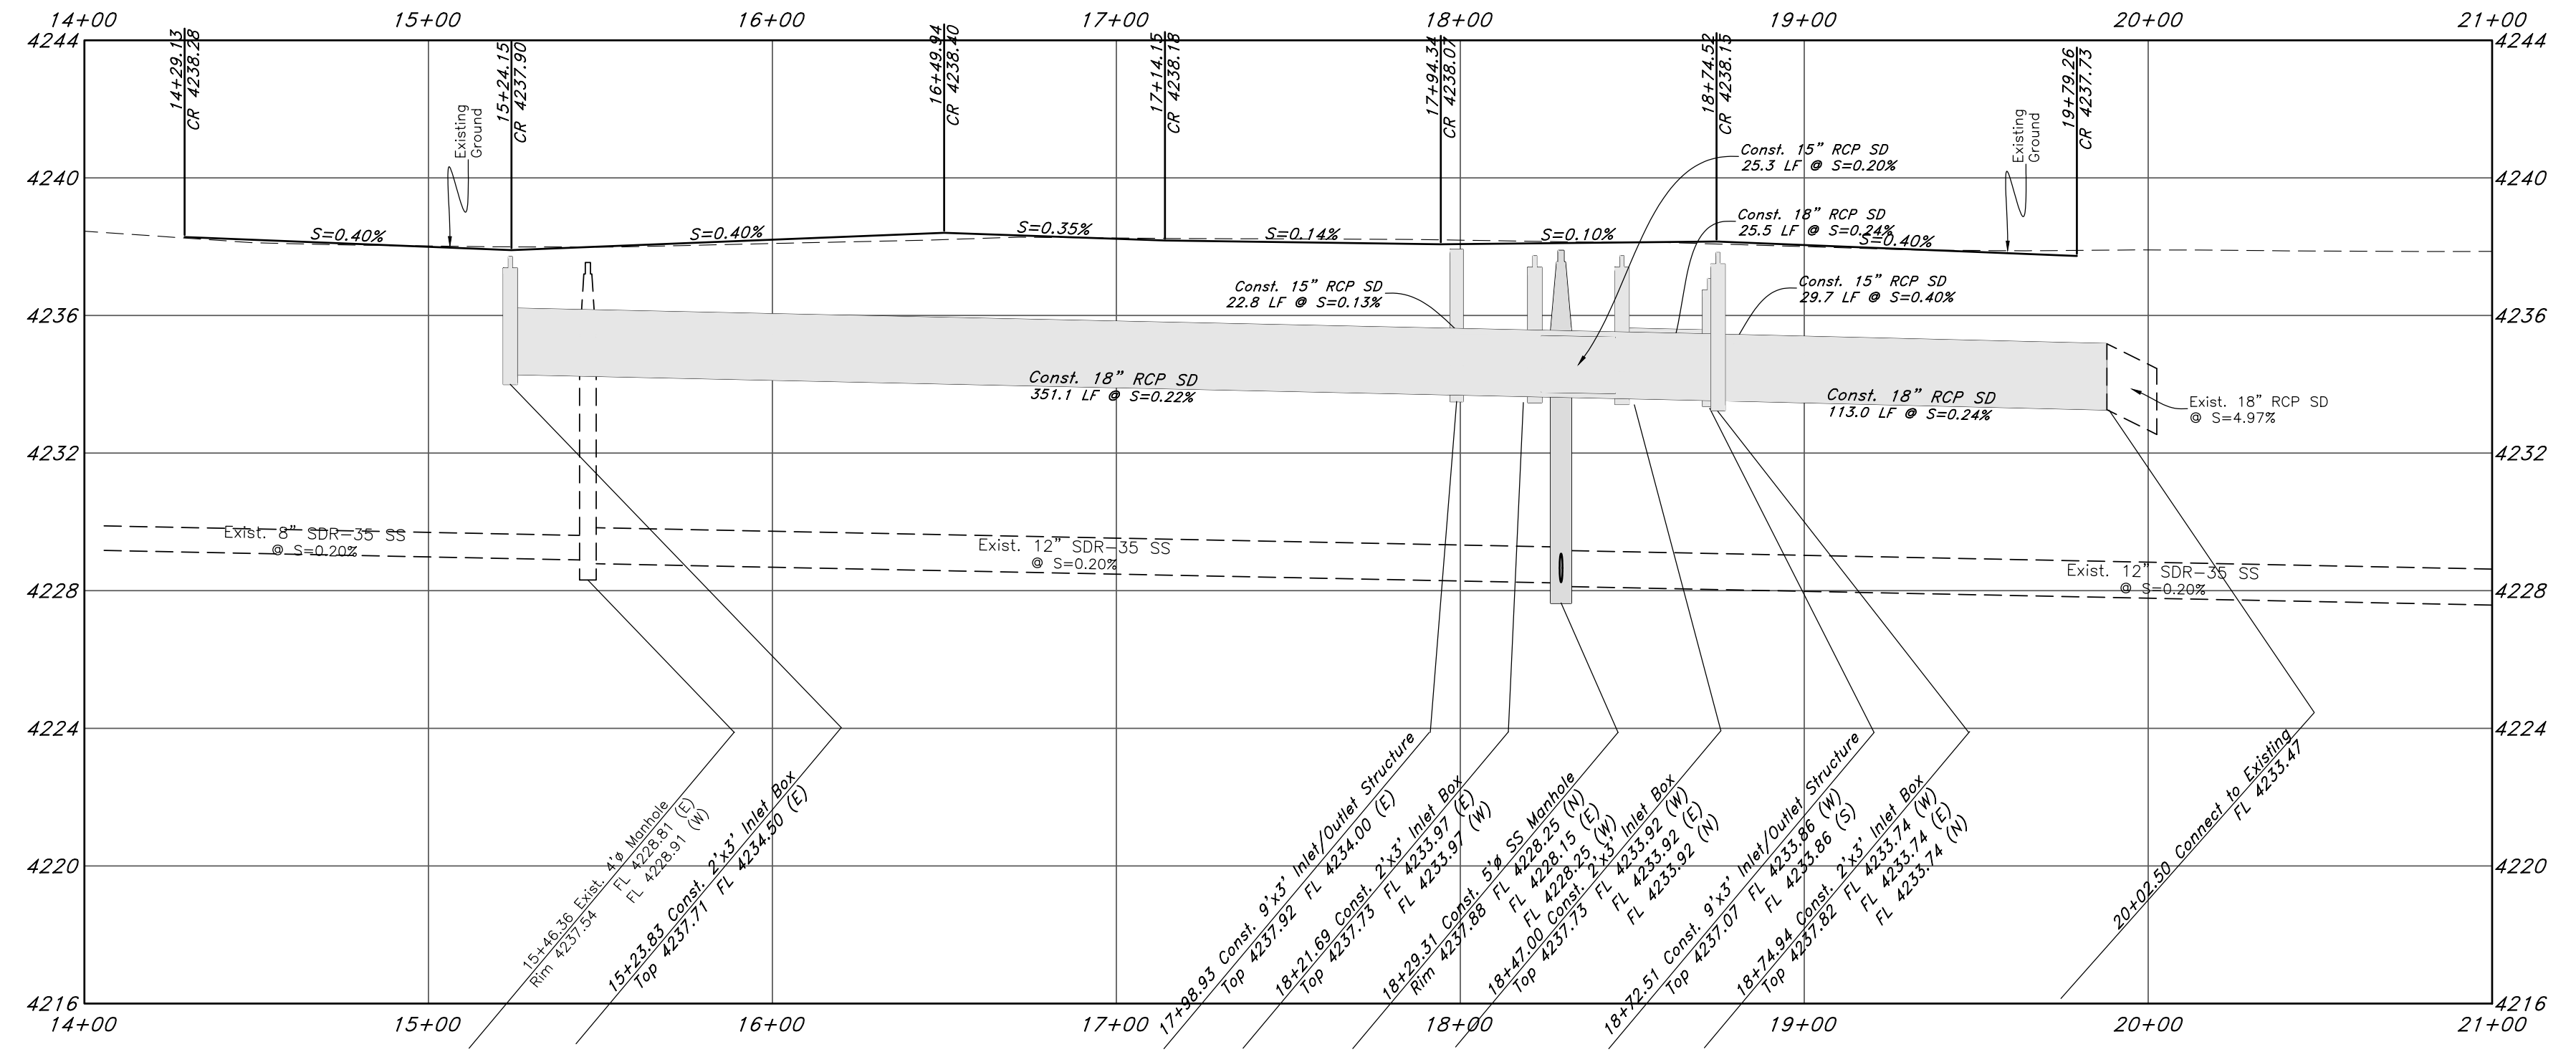


### Roadway Section

Not to Scale

NOTES:  
 1 - These pavement thicknesses shall be considered as minimums and may be increased by the County Engineer when the subgrade C.B.R. is less than 10 or when a greater depth is necessary to provide sufficient stability. Developer may submit and alternate pavement design based on a detailed soils analysis for approval by the County Engineer.  
 4 - Provide a thickness of 1/2" or 1" gravel base course under sidewalks, driveway approaches and curb & gutter when subgrade is clay or C.B.R. is less than 10 or as directed by the County Engineer.

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**Plan & Profile**
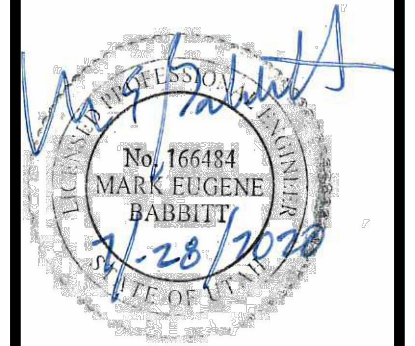
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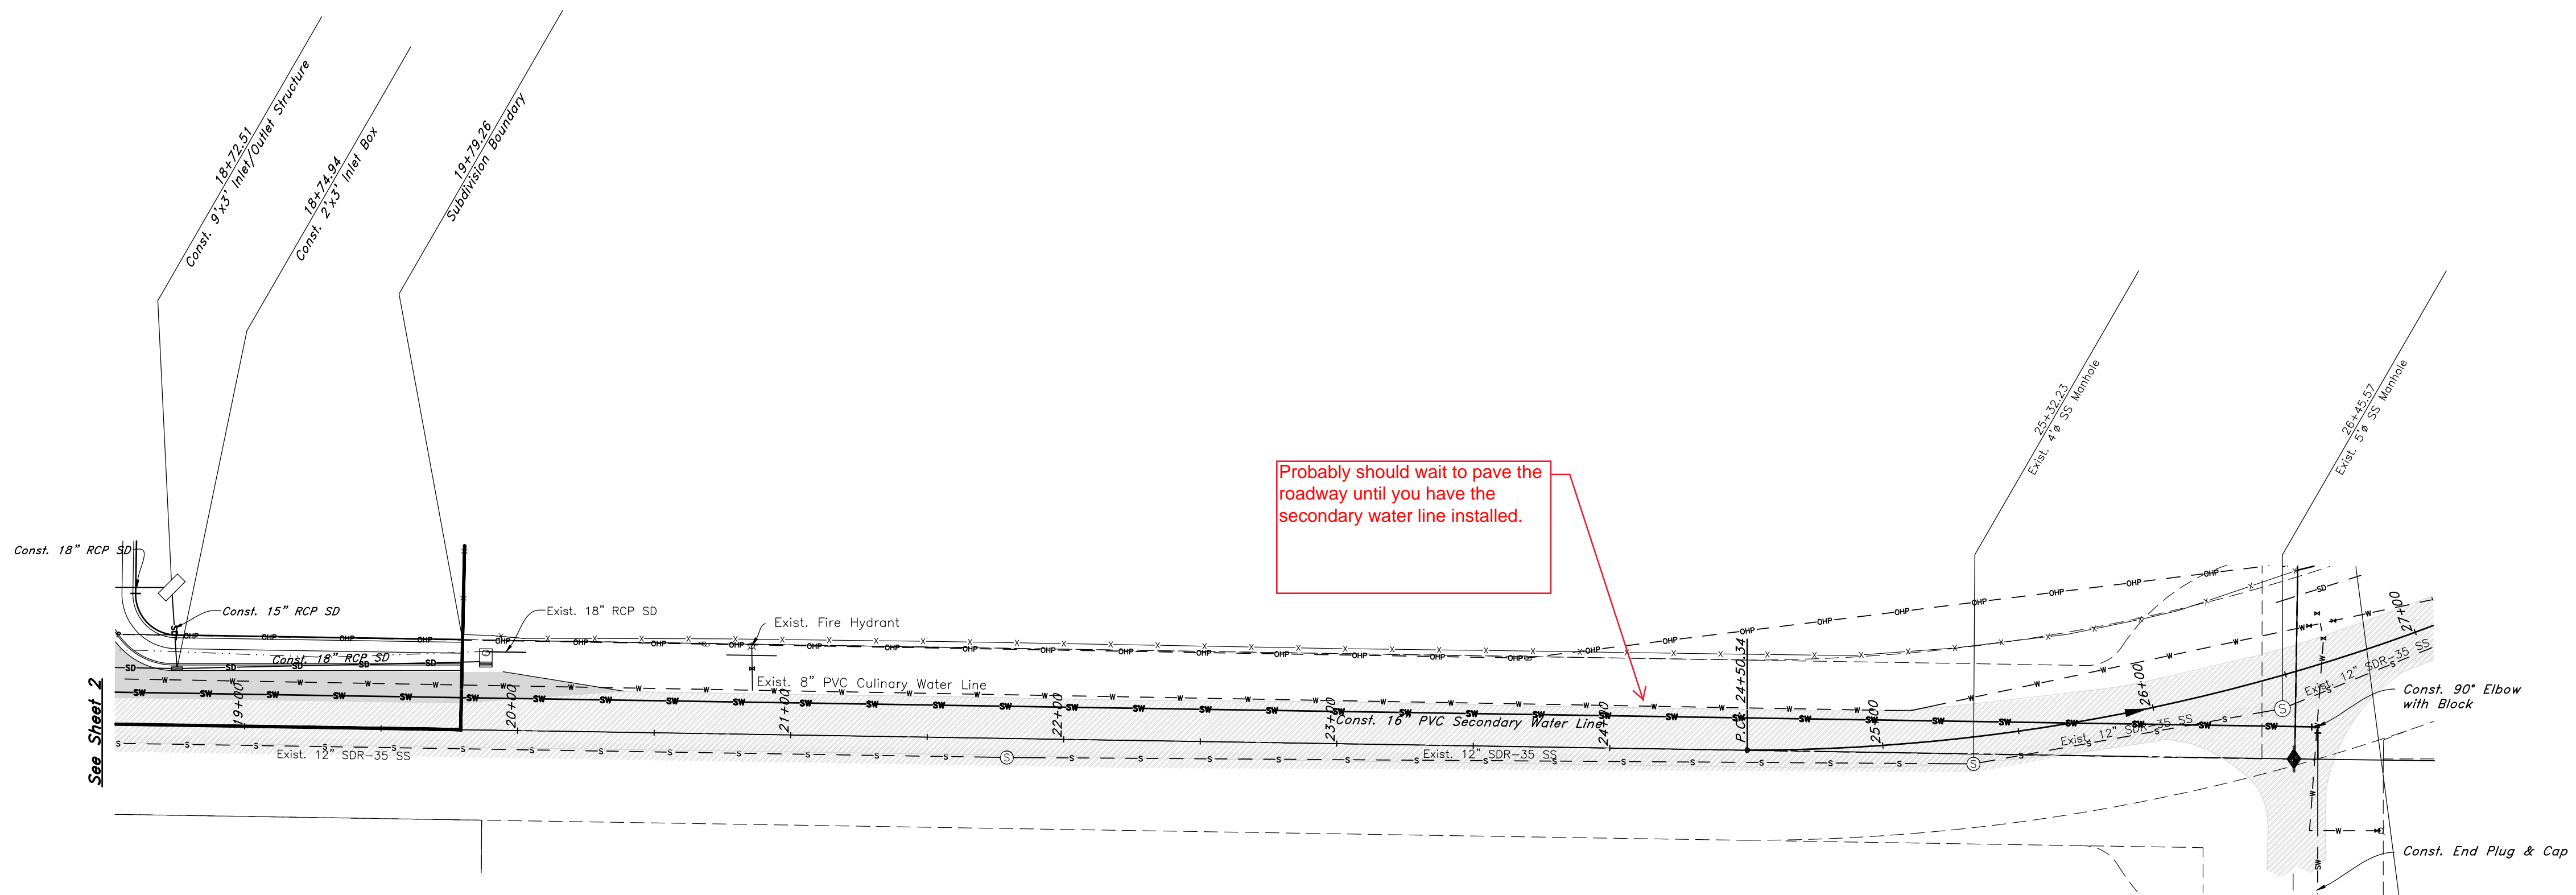
20 July, 2020

SHEET NO. **2** of 11


16N719 - AM

**FOR CONSTRUCTION**






Probably should wait to pave the roadway until you have the secondary water line installed.

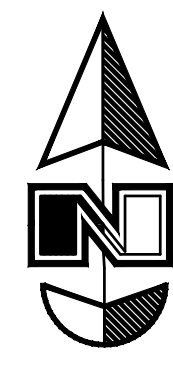

Scale:  
1" = 40' Horiz.  
1" = 4' Vertical

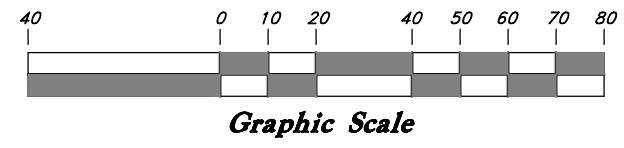


### Legend


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- Power Line
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- Power pole w/guy
- Light Pole
- Fence
- Flowline of ditch
- Overhead Power line
- Corrugated Metal Pipe
- Concrete Pipe
- Reinforced Concrete Pipe
- Ductile Iron
- Polyvinyl Chloride
- Top of Asphalt
- EA
- CL
- Edge of Asphalt
- Centerline
- Flowline
- Finish Floor
- Top of Curb
- Top of Wall
- TW
- Top of Walk
- Top of Concrete
- Natural Ground
- Finish Grade
- Match Existing
- MC
- Fire Department Connection
- FDC
- Finish Contour
- Exist. Contour
- Finish Grade
- Exist. Grade
- Ridge Line

# Secondary Water Extension 900 South Street

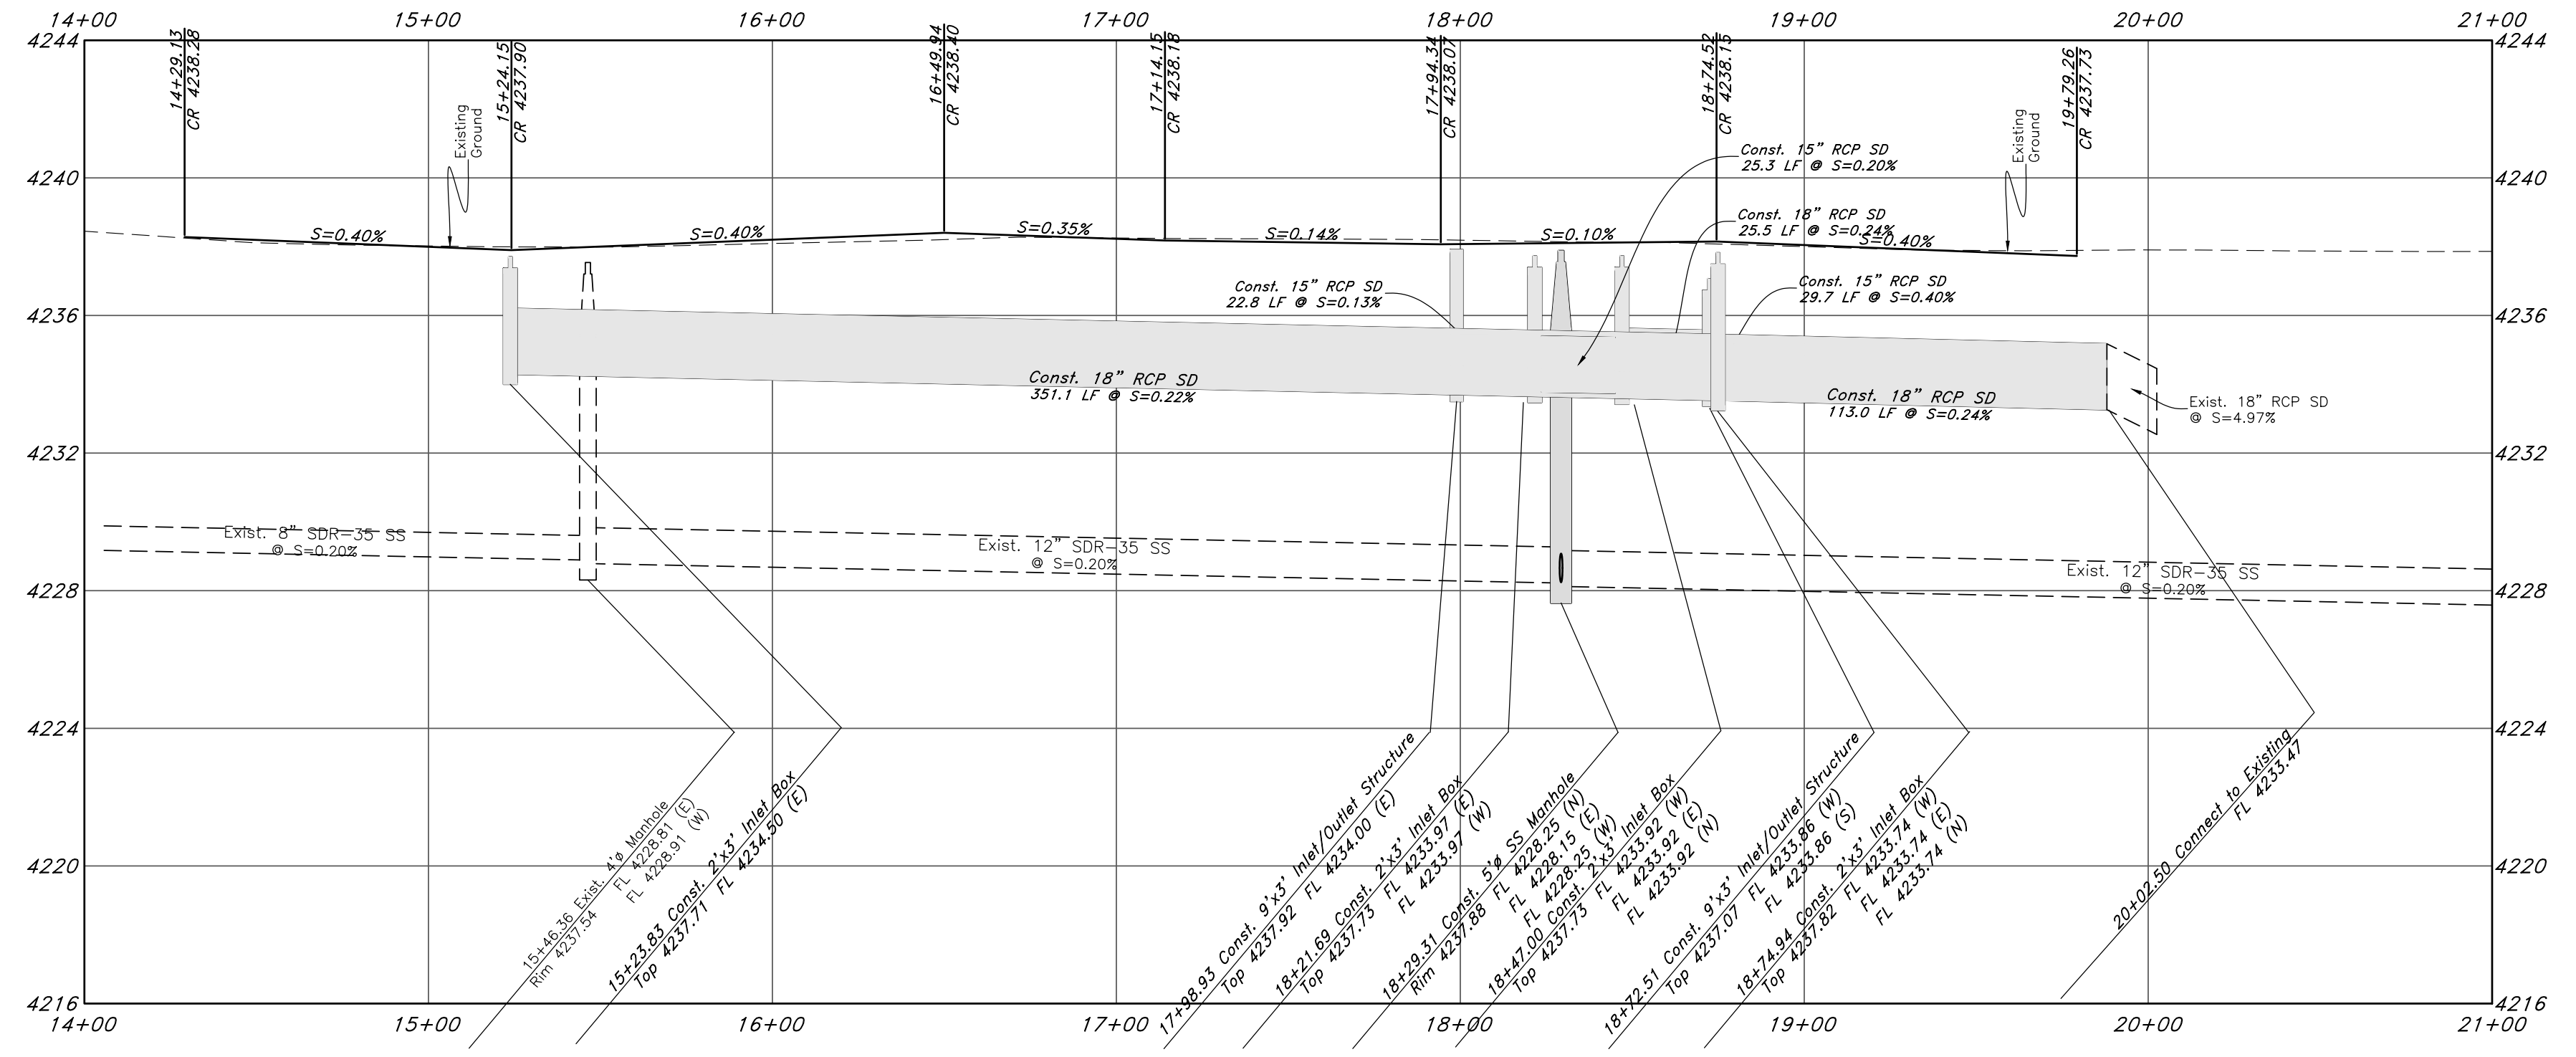

REV	DATE	DESCRIPTION

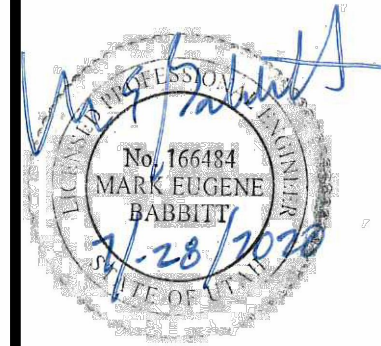

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**Plan & Profile**

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Call before you Dig  
 Avoid cutting underground utility lines. It's costly.



**FOR CONSTRUCTION**

20 July, 2020



SHEET NO. **2A** of 11

16N719 - AM


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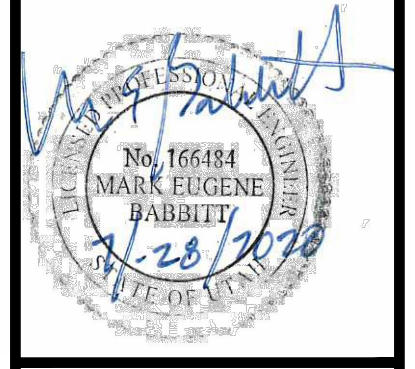
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- Fence
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- Overhead Power line
- Corrugated Metal Pipe
- Concrete Pipe
- Reinforced Concrete Pipe
- Ductile Iron
- PVC
- Polyvinyl Chloride
- Top of Asphalt
- Edge of Asphalt
- Centerline
- FL
- Finish Floor
- TC
- Top of Wall
- TW
- Top of Walk
- TCN
- Top of Concrete
- Natural Ground
- Finish Grade
- Match Existing
- Fire Department Connection
- FDC
- 90
- 95.337A
- 95.721A
- R
- Existing Asphalt
- New Asphalt
- Heavy Duty Asphalt
- Existing Concrete
- New Concrete
- Spill Curb & Gutter



## Bucky Lane

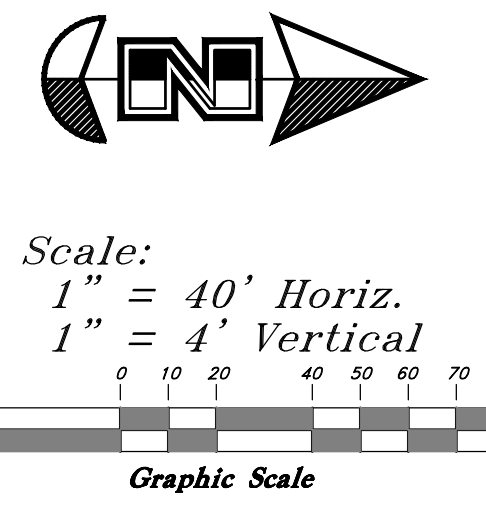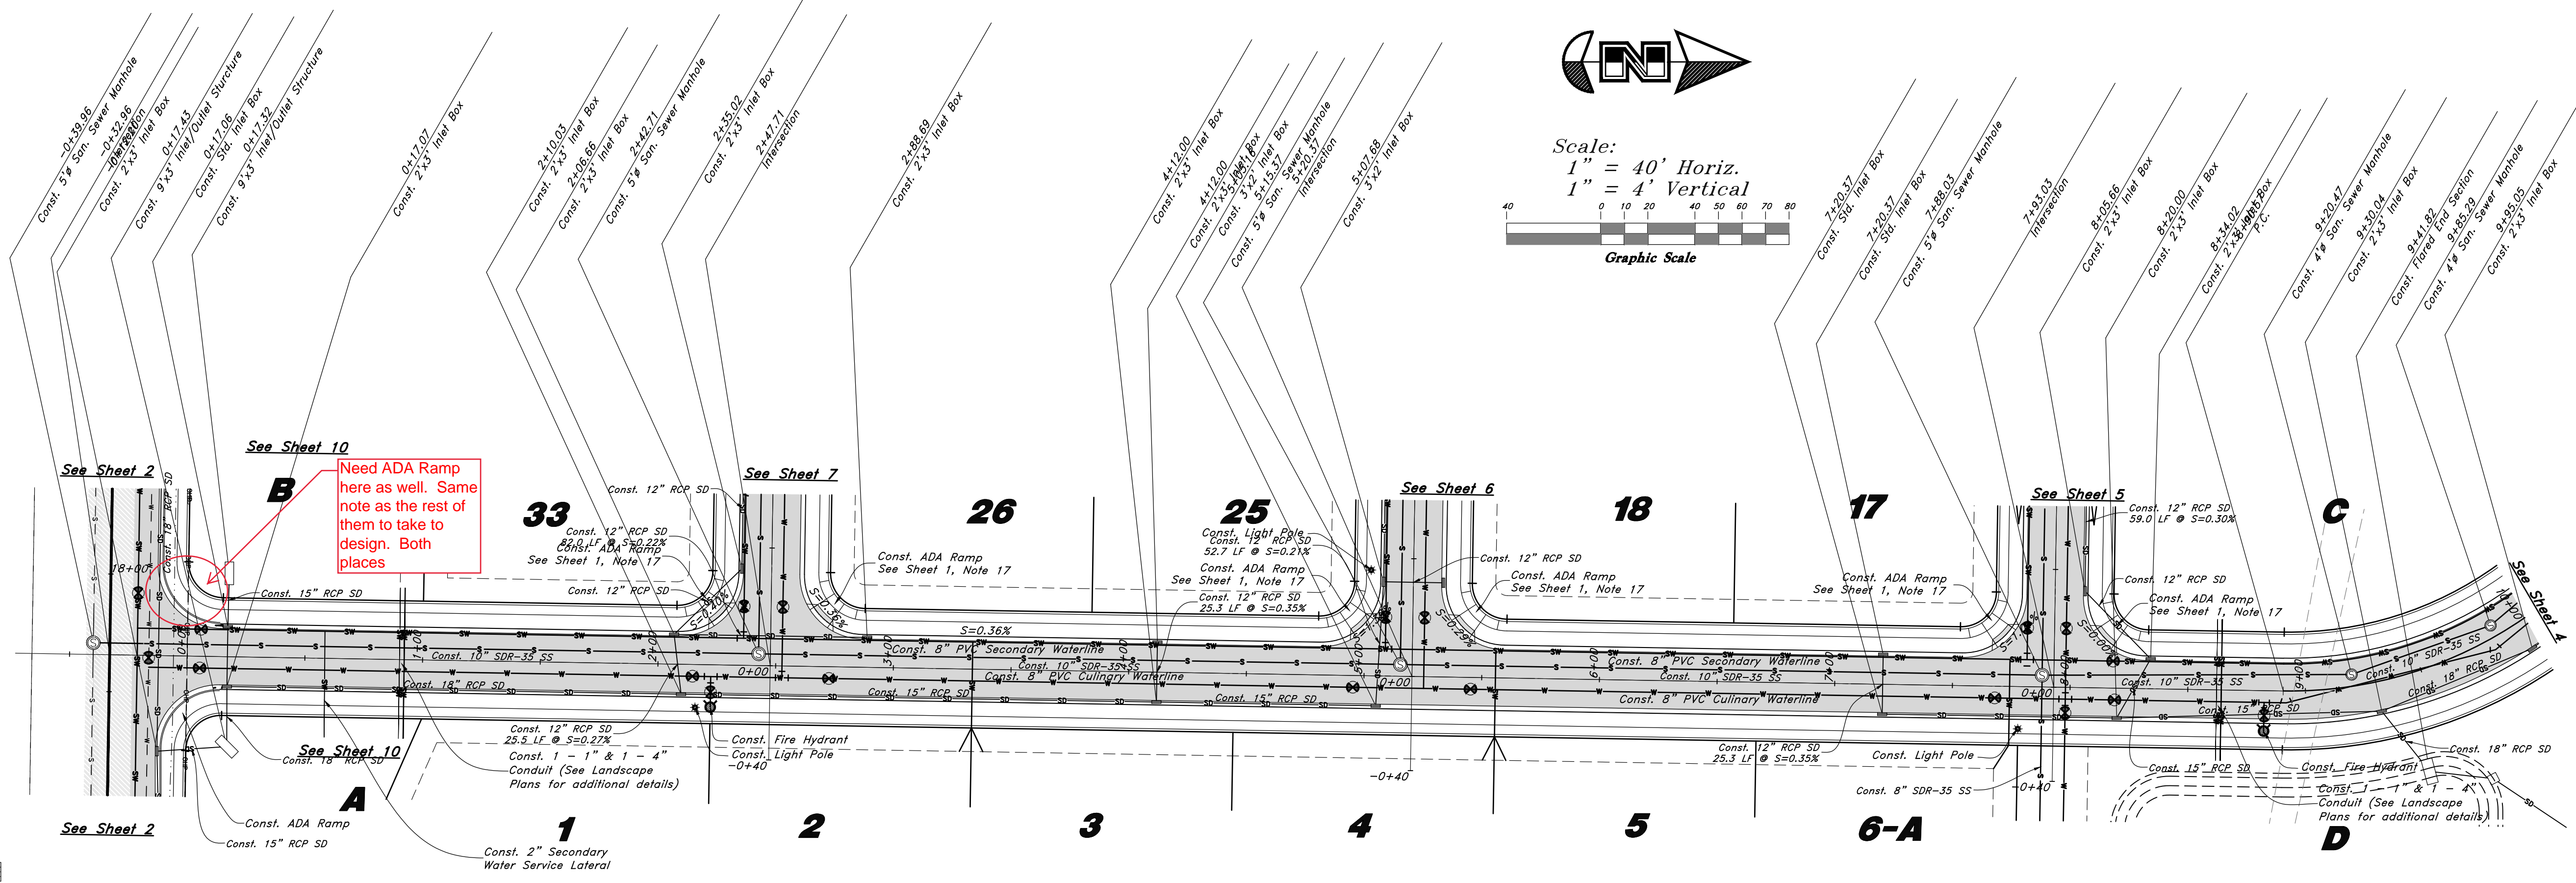

REV	DATE	DESCRIPTION

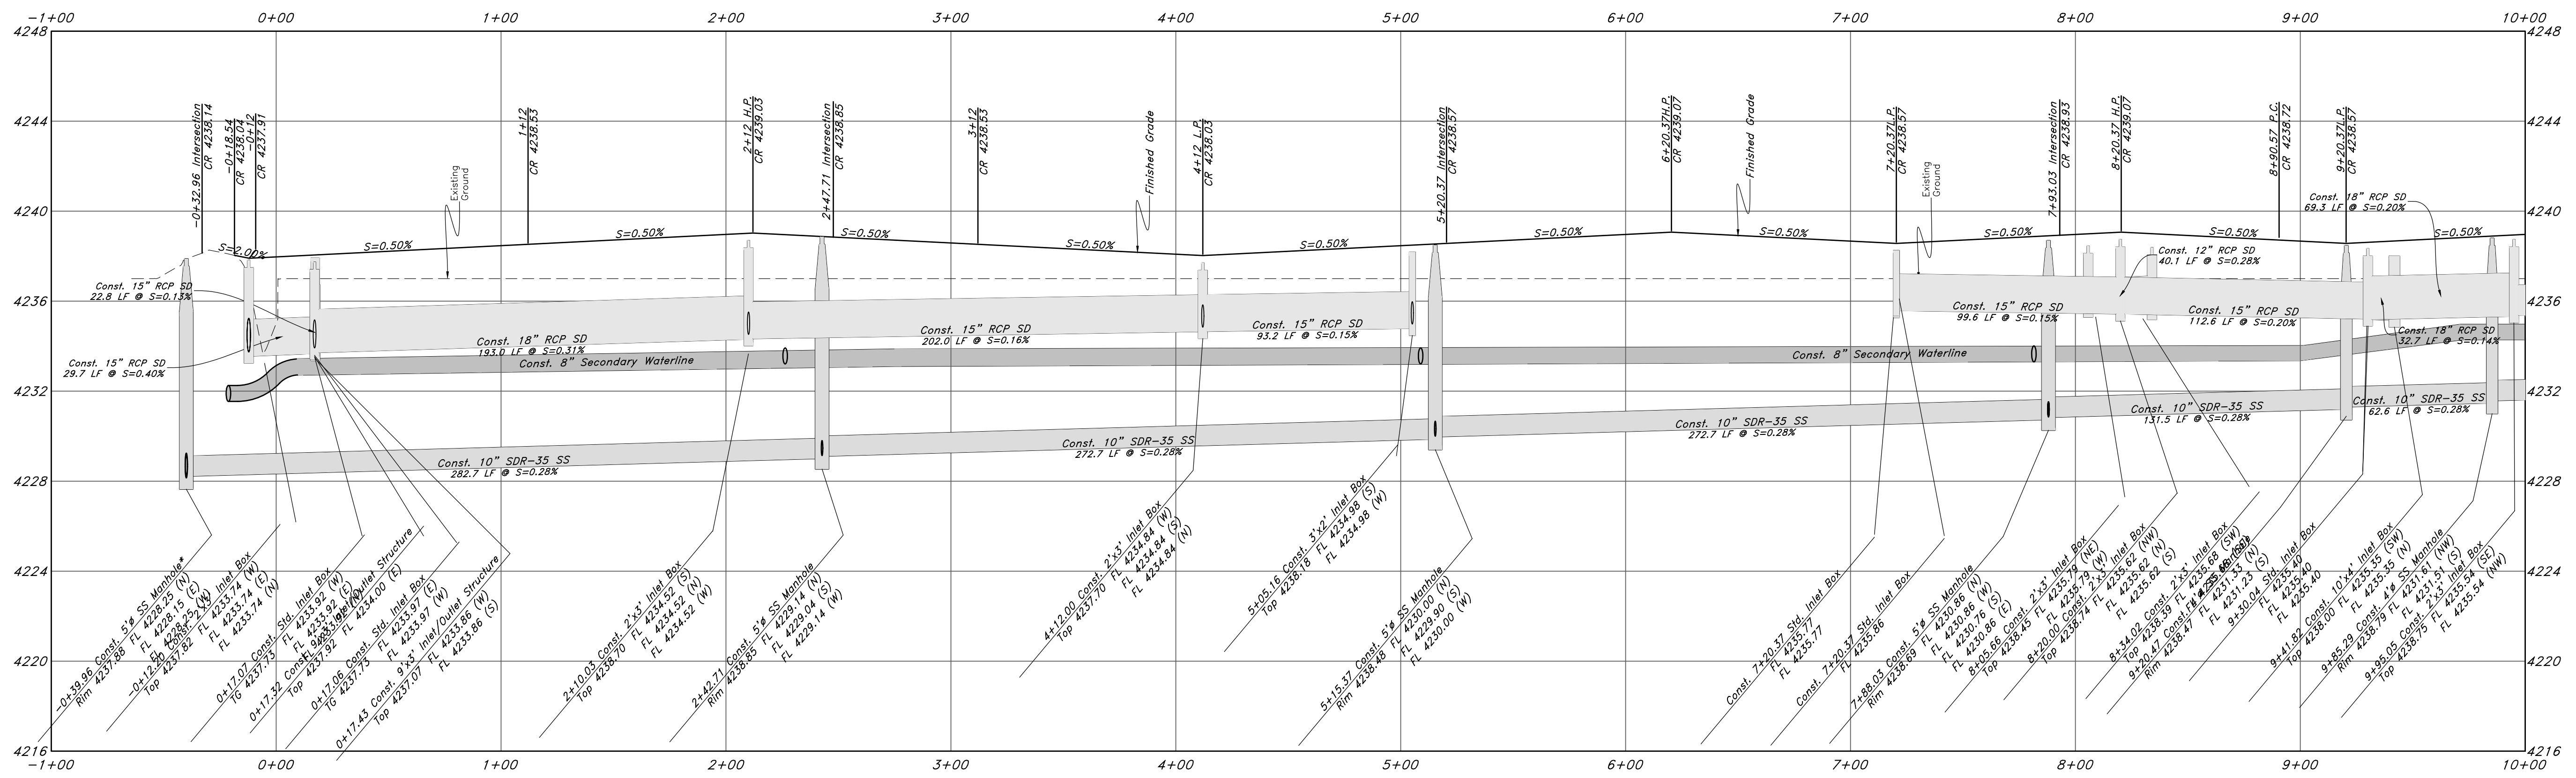

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**Plan & Profile**

**The Barn at Terakee Farms No. 1**



Approx. 900 South 4500 West  
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**FOR CONSTRUCTION**




20 July, 2020

SHEET NO. **3** of 11

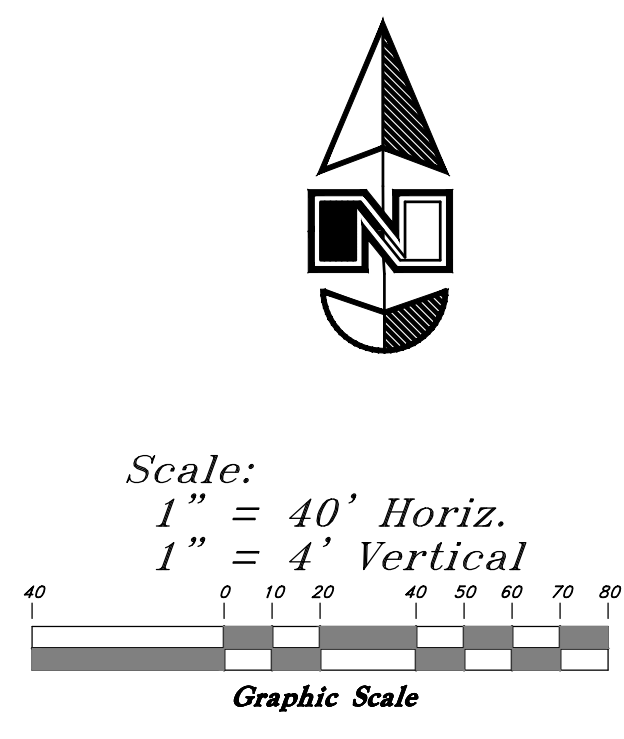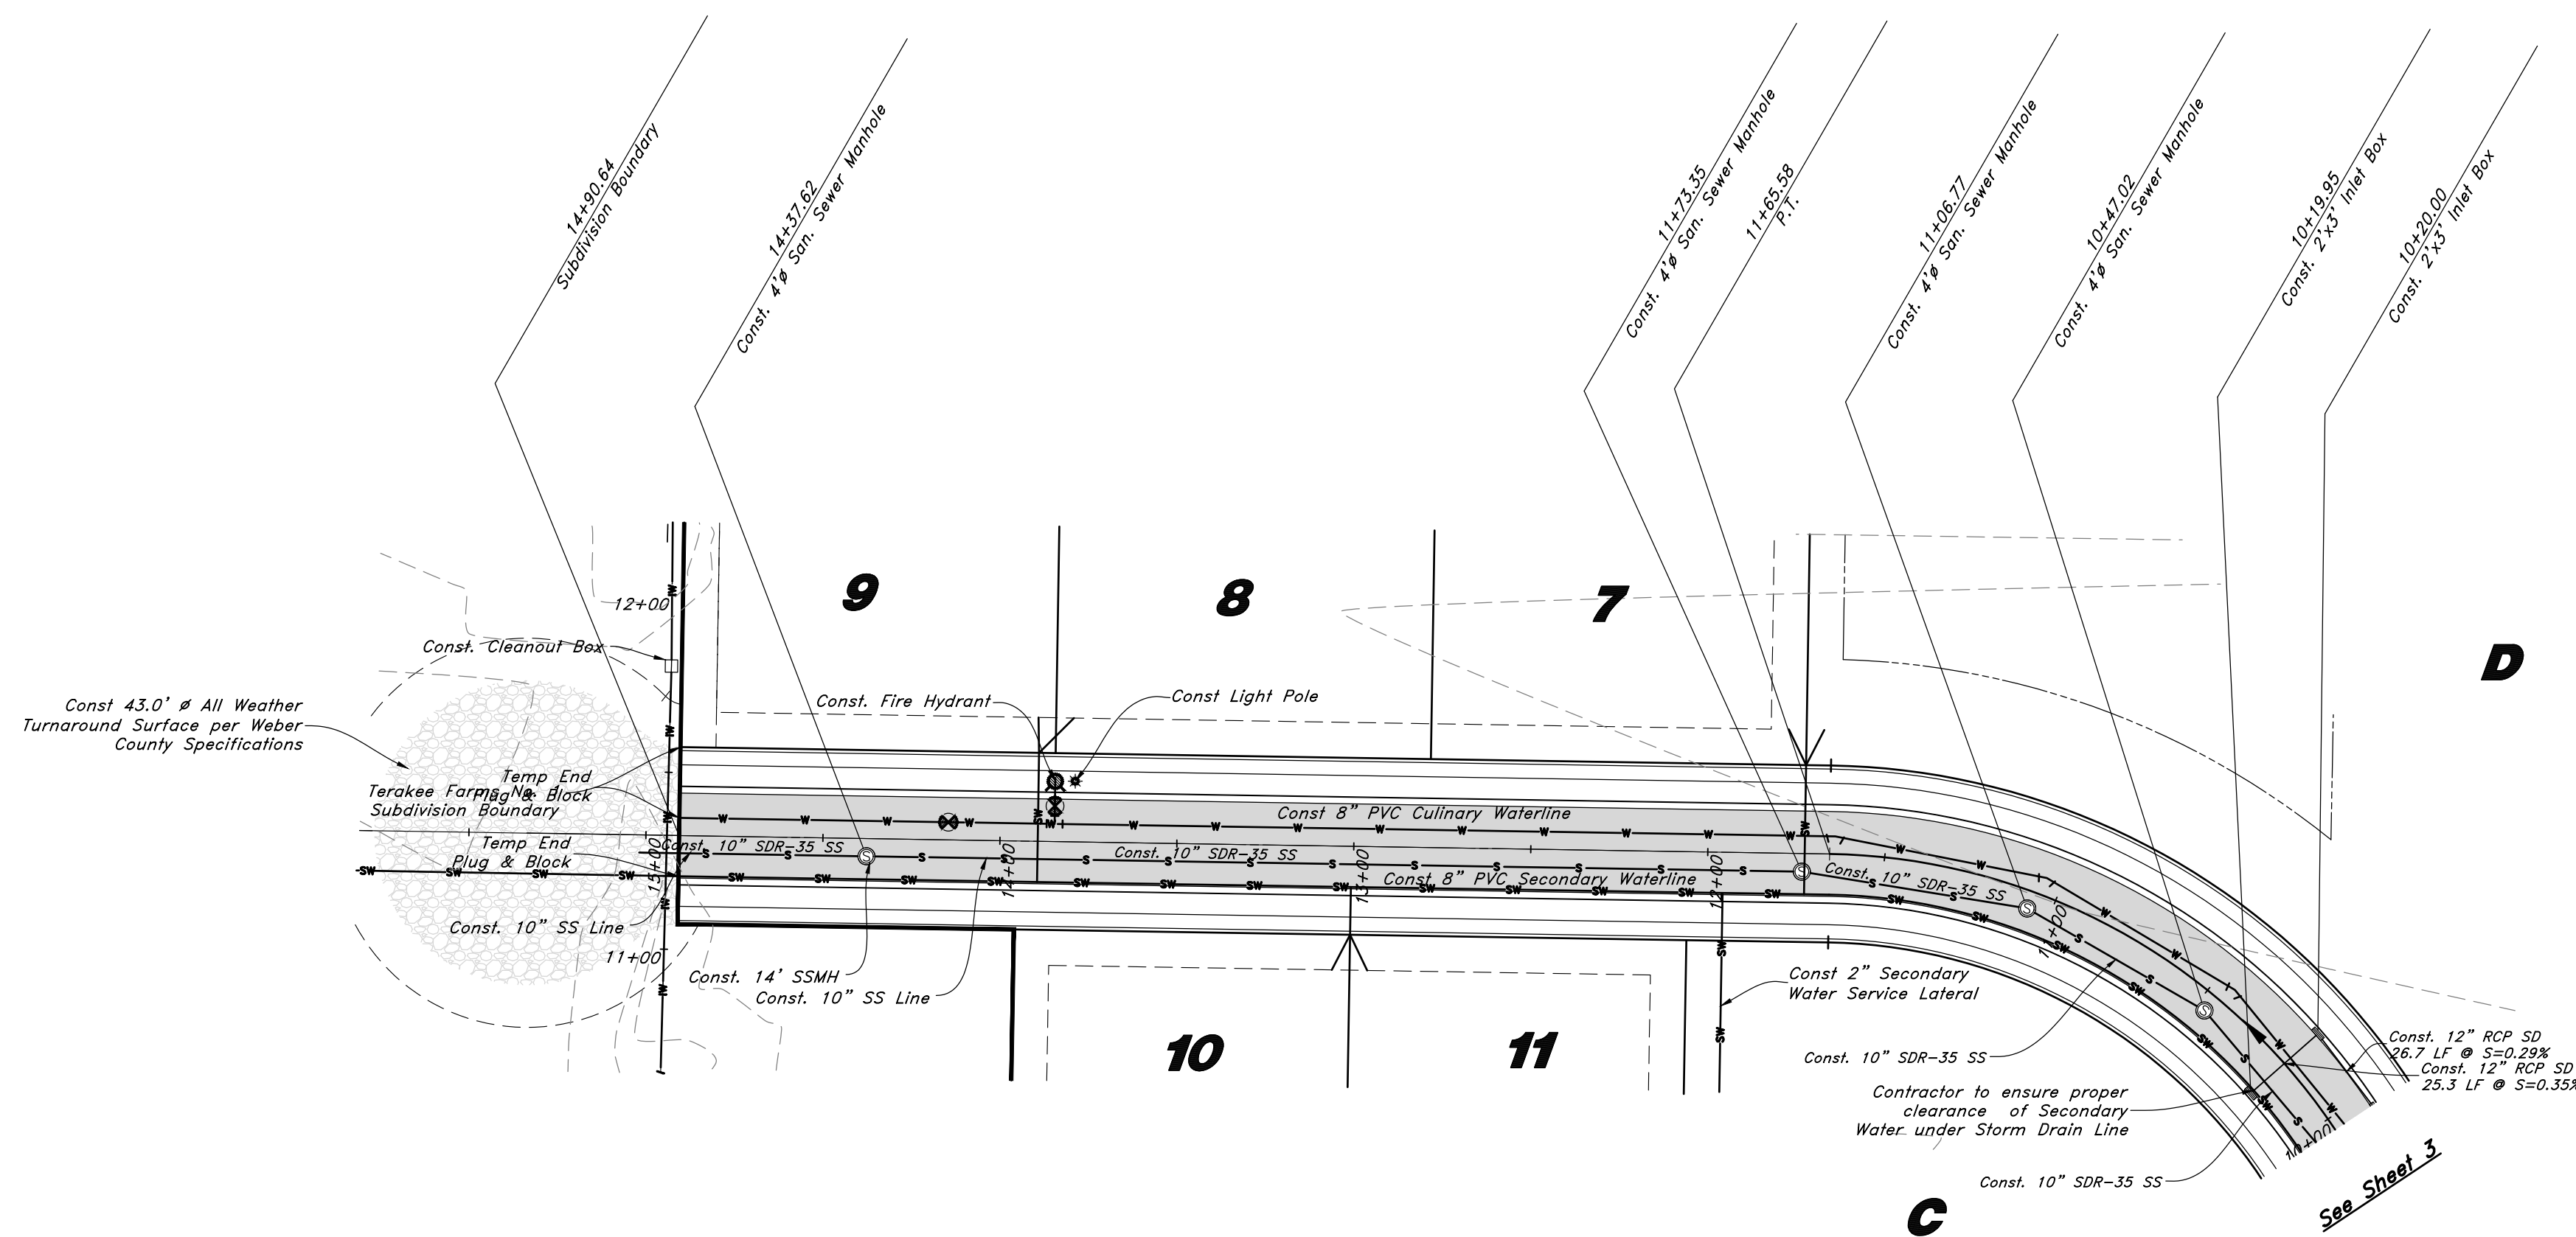

- Legend**  
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  - Top of Walk
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  - Natural Ground
  - NC
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  - Ridge Line
  - R
  - Existing Asphalt
  - New Asphalt
  - Heavy Duty Asphalt
  - Existing Concrete
  - New Concrete
  - Spill Curb & Gutter


# Bucky Lane

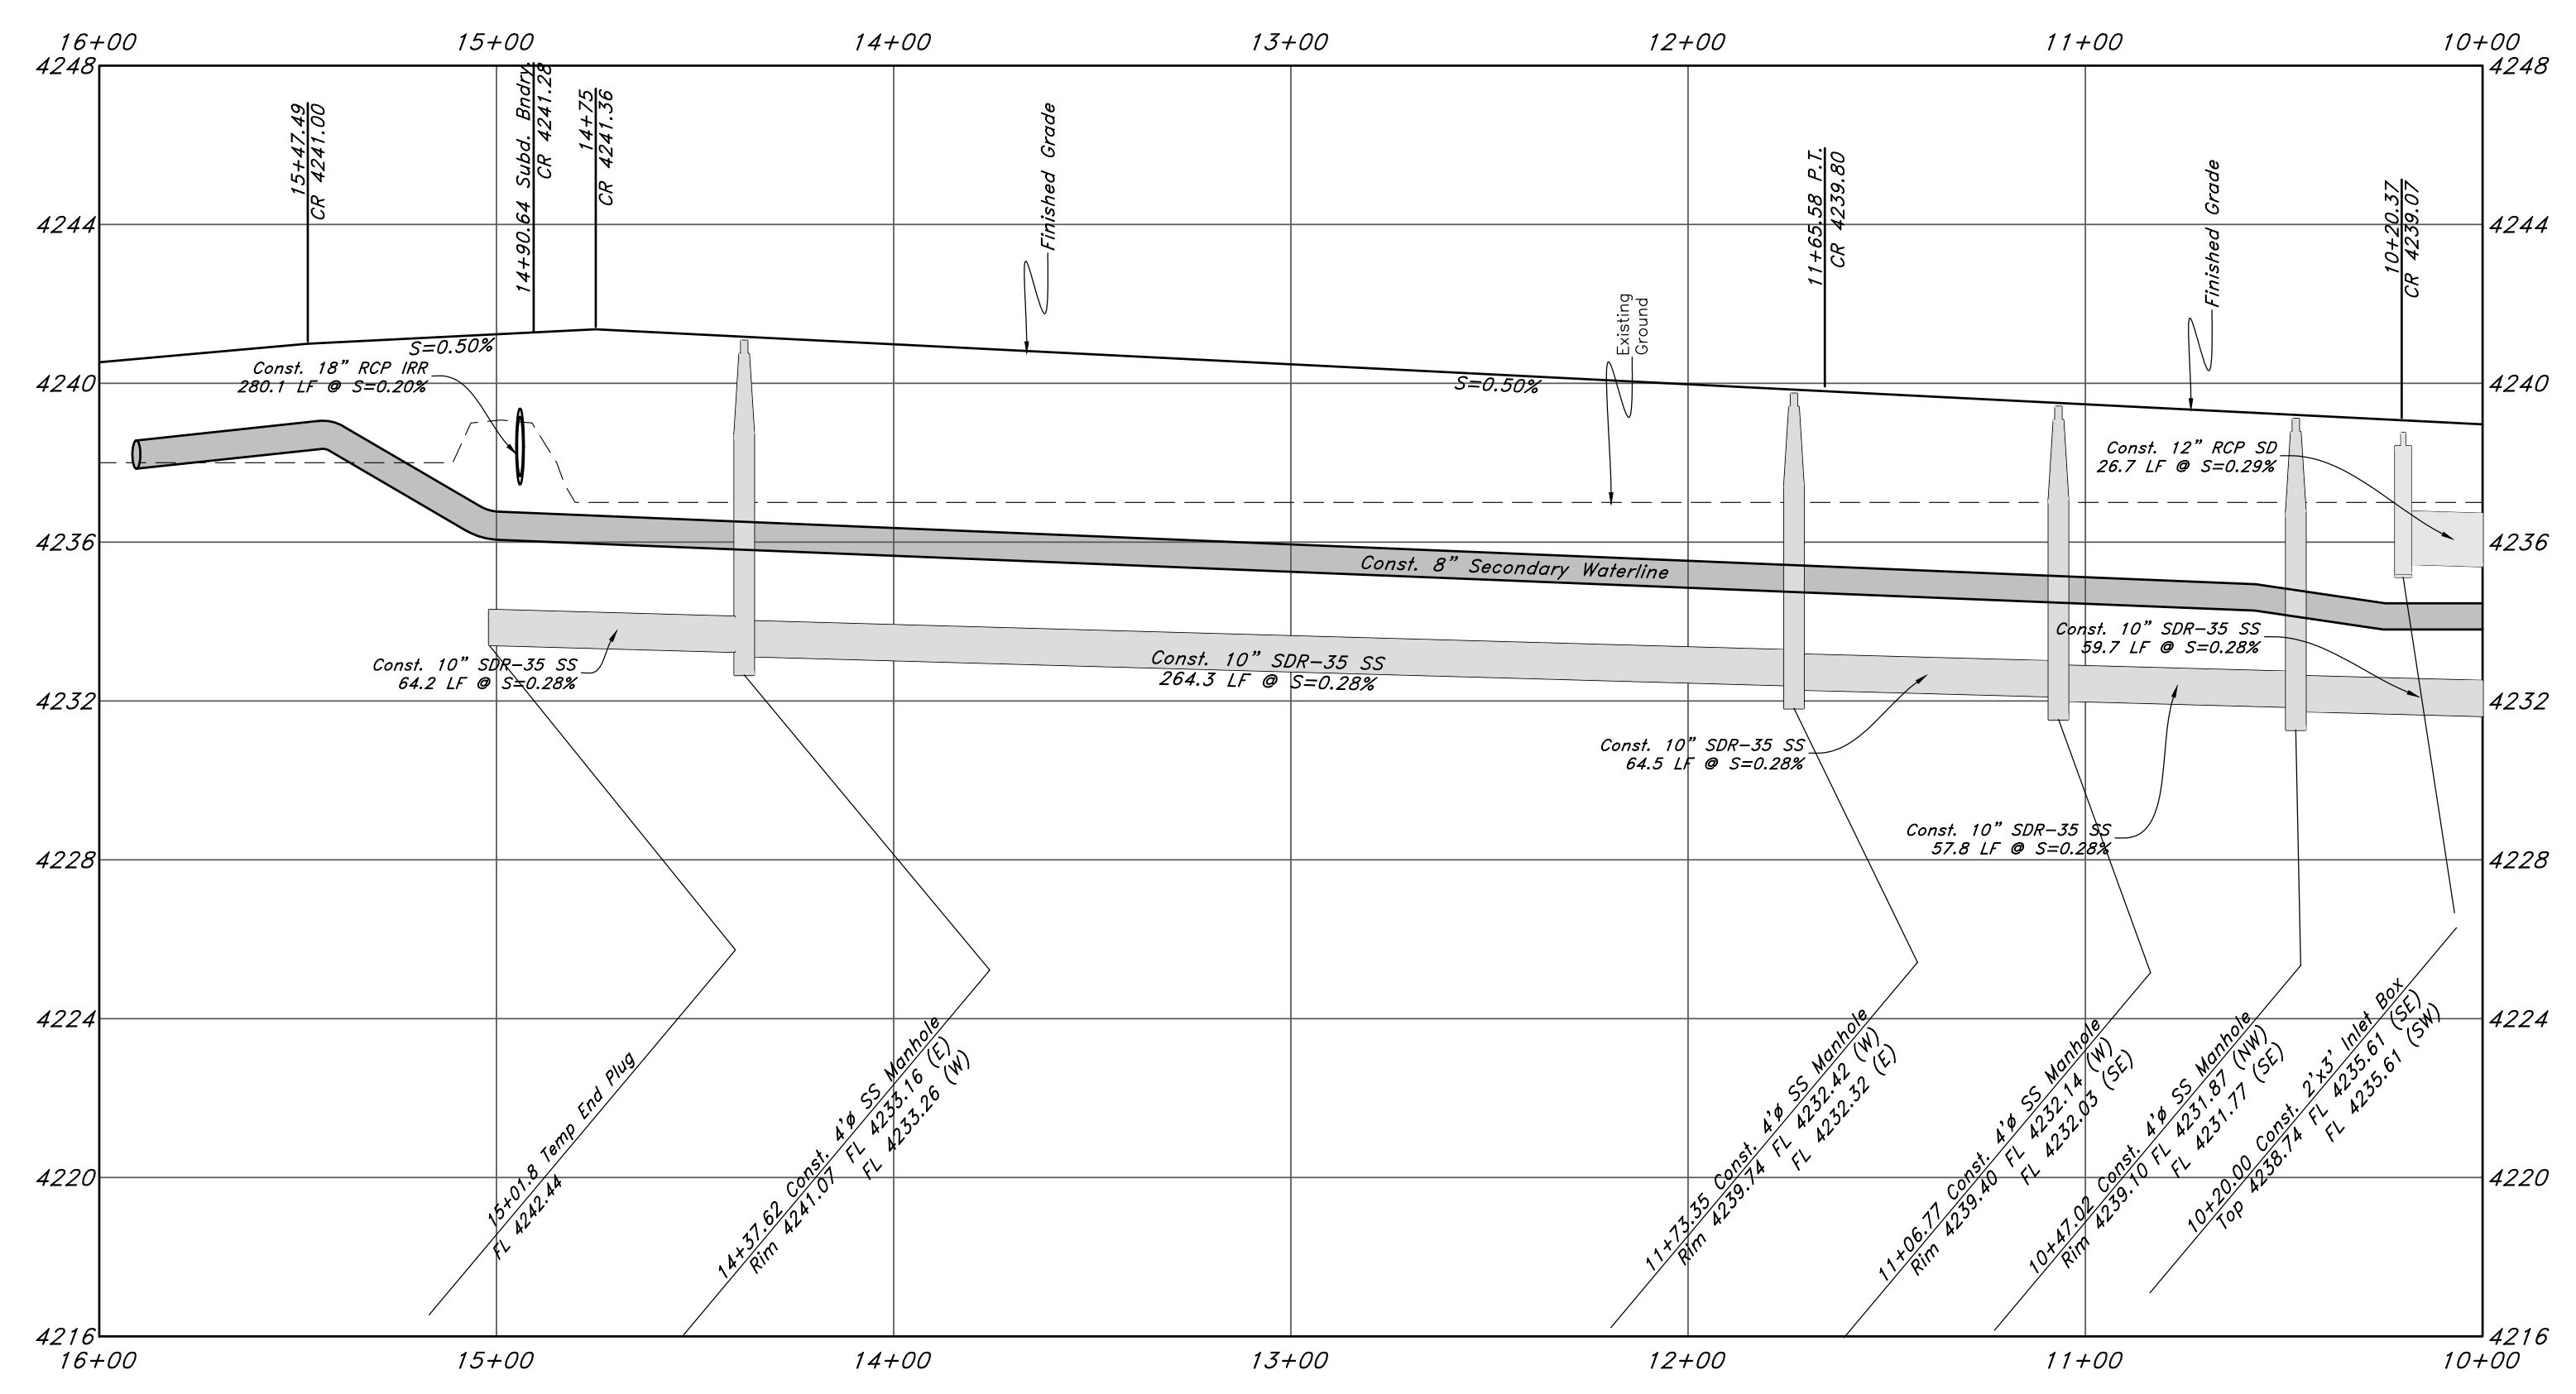

**FOR CONSTRUCTION**



REV	DATE	DESCRIPTION



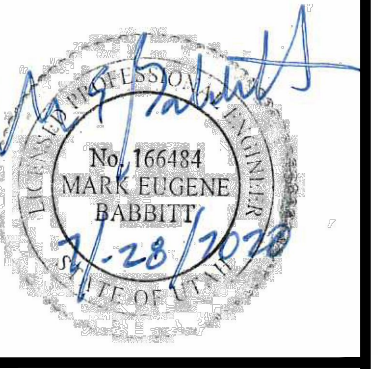


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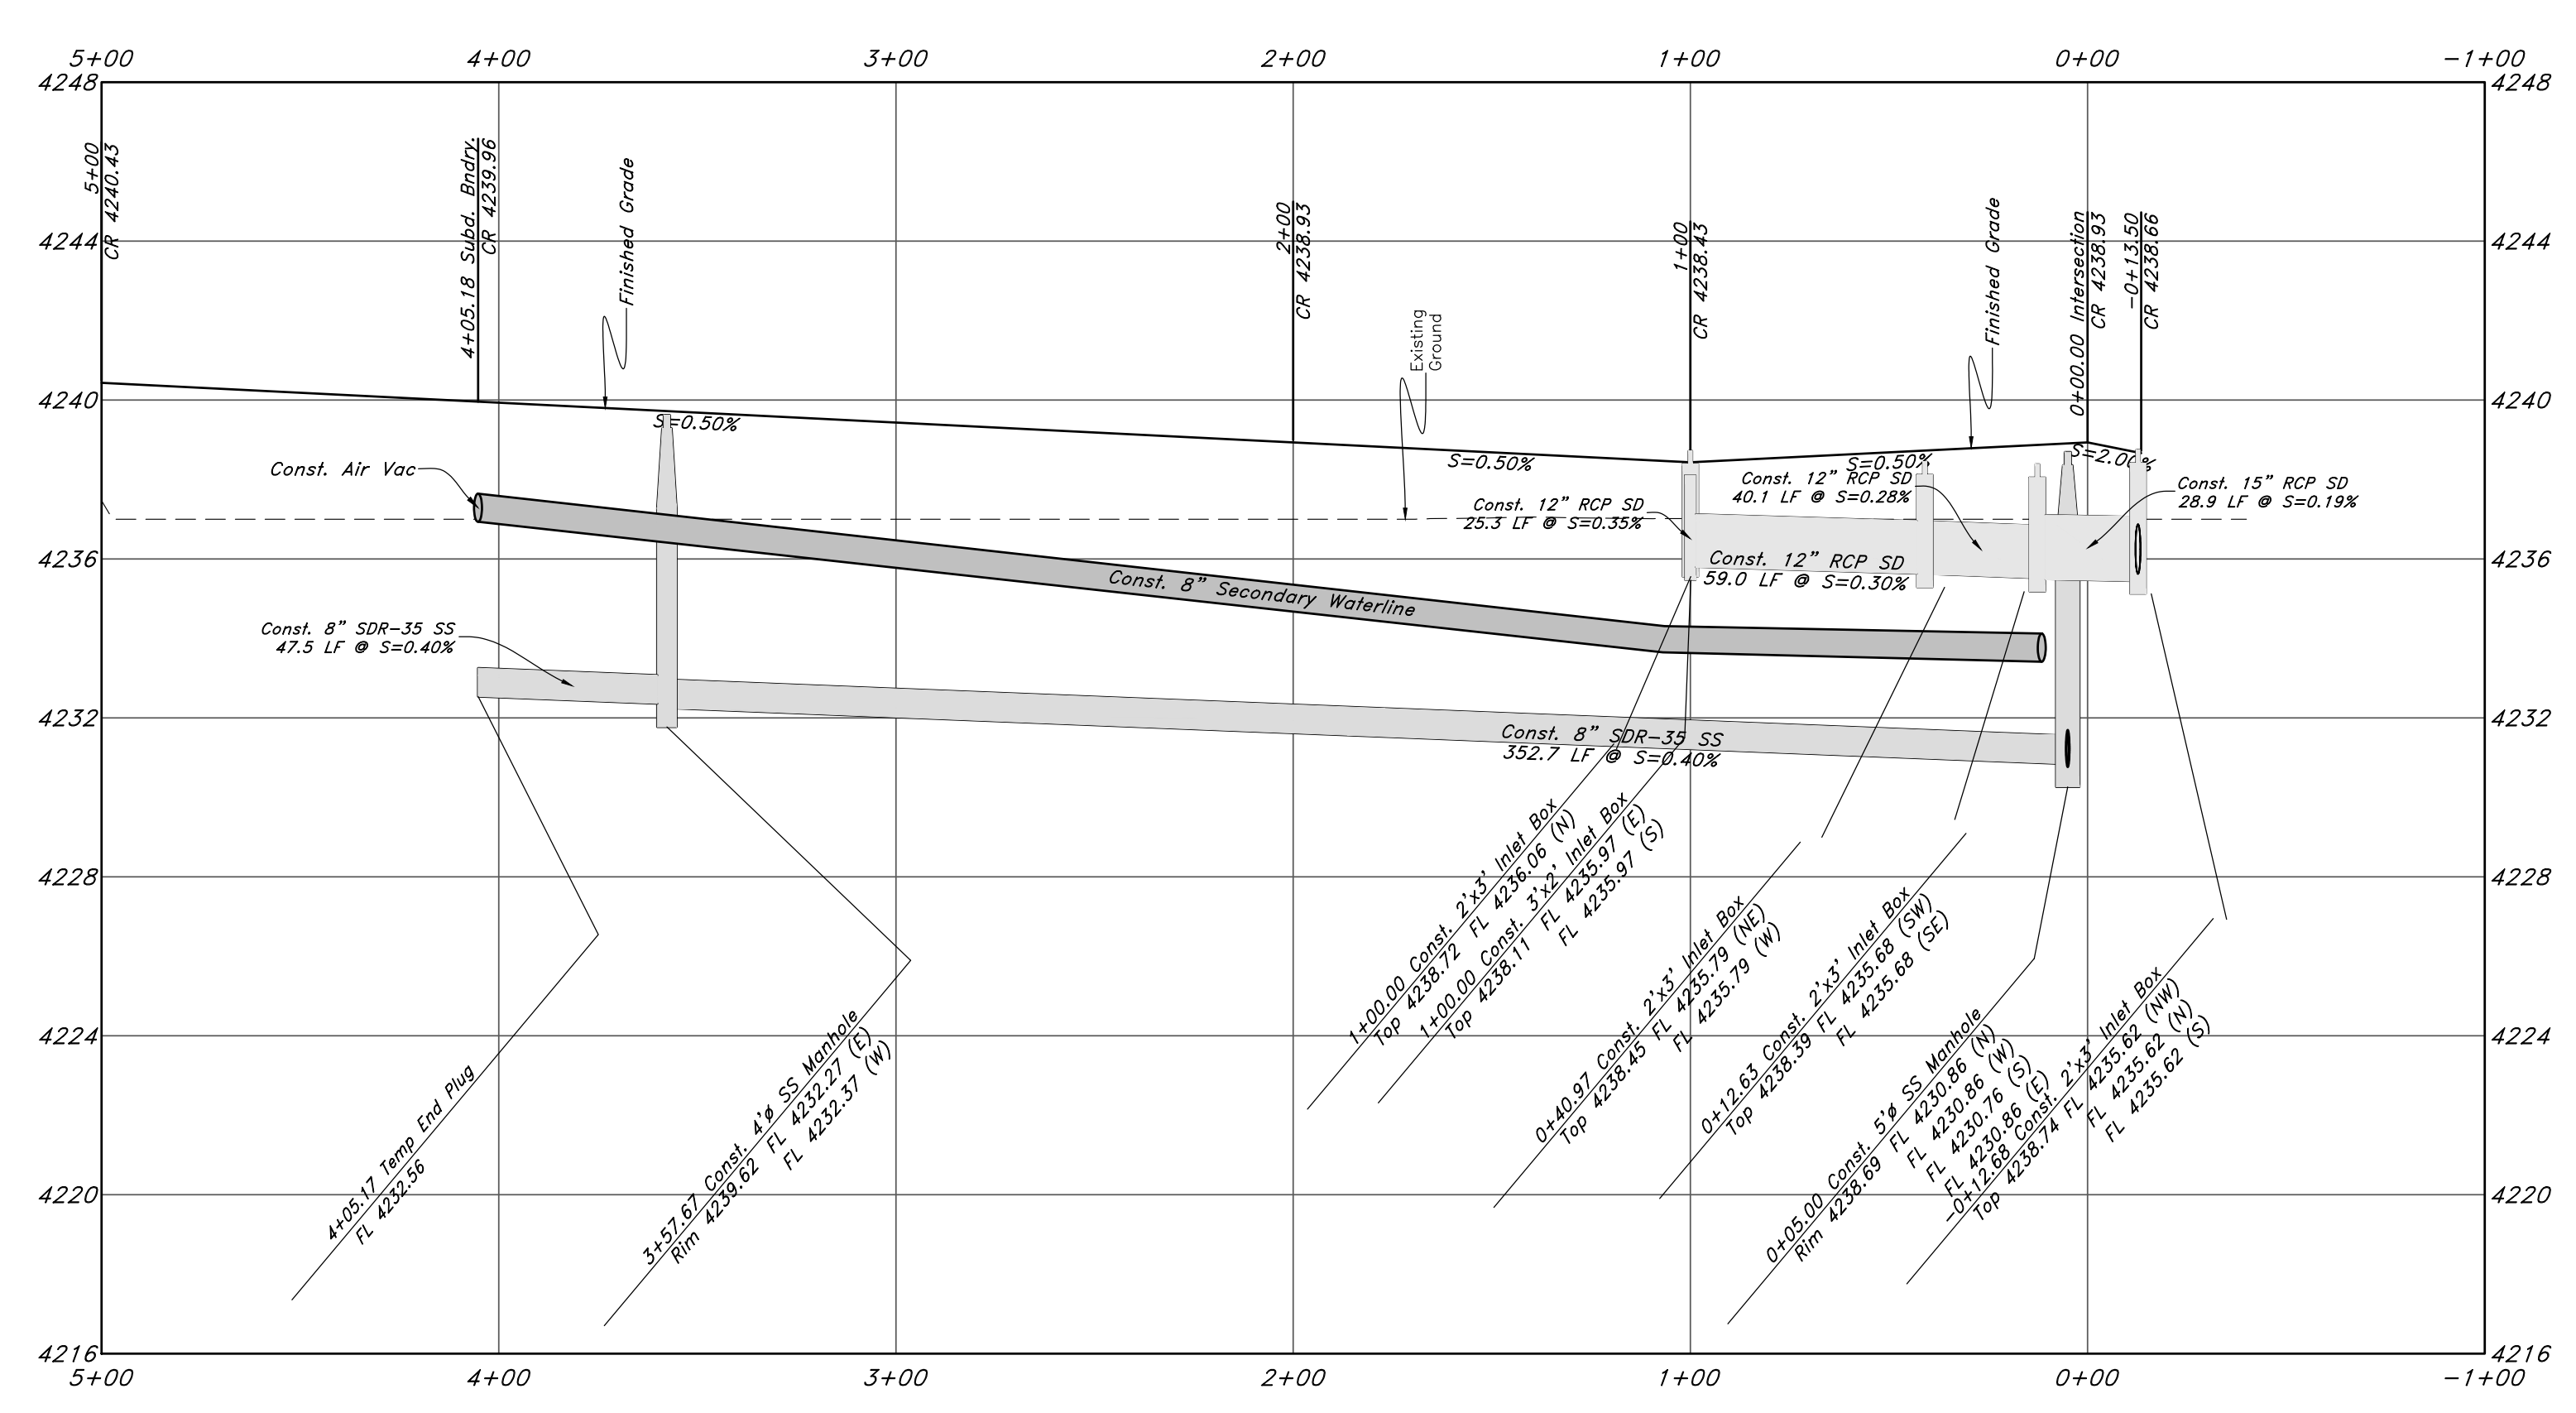
574 SOUTH 1475 EAST, BODEN, UTAH 84403  
 1360 SOUTH 4450 WEST, SUICEDALE, UTAH 84092  
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**Plan & Profile**  
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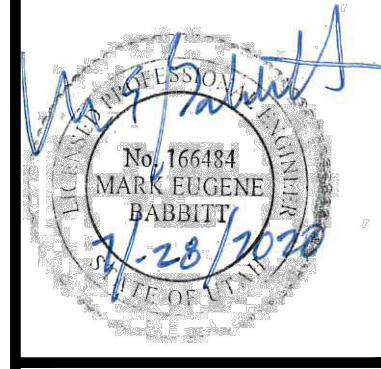
# 750 South Street



## Legend

(Note: All items may not appear on drawing)

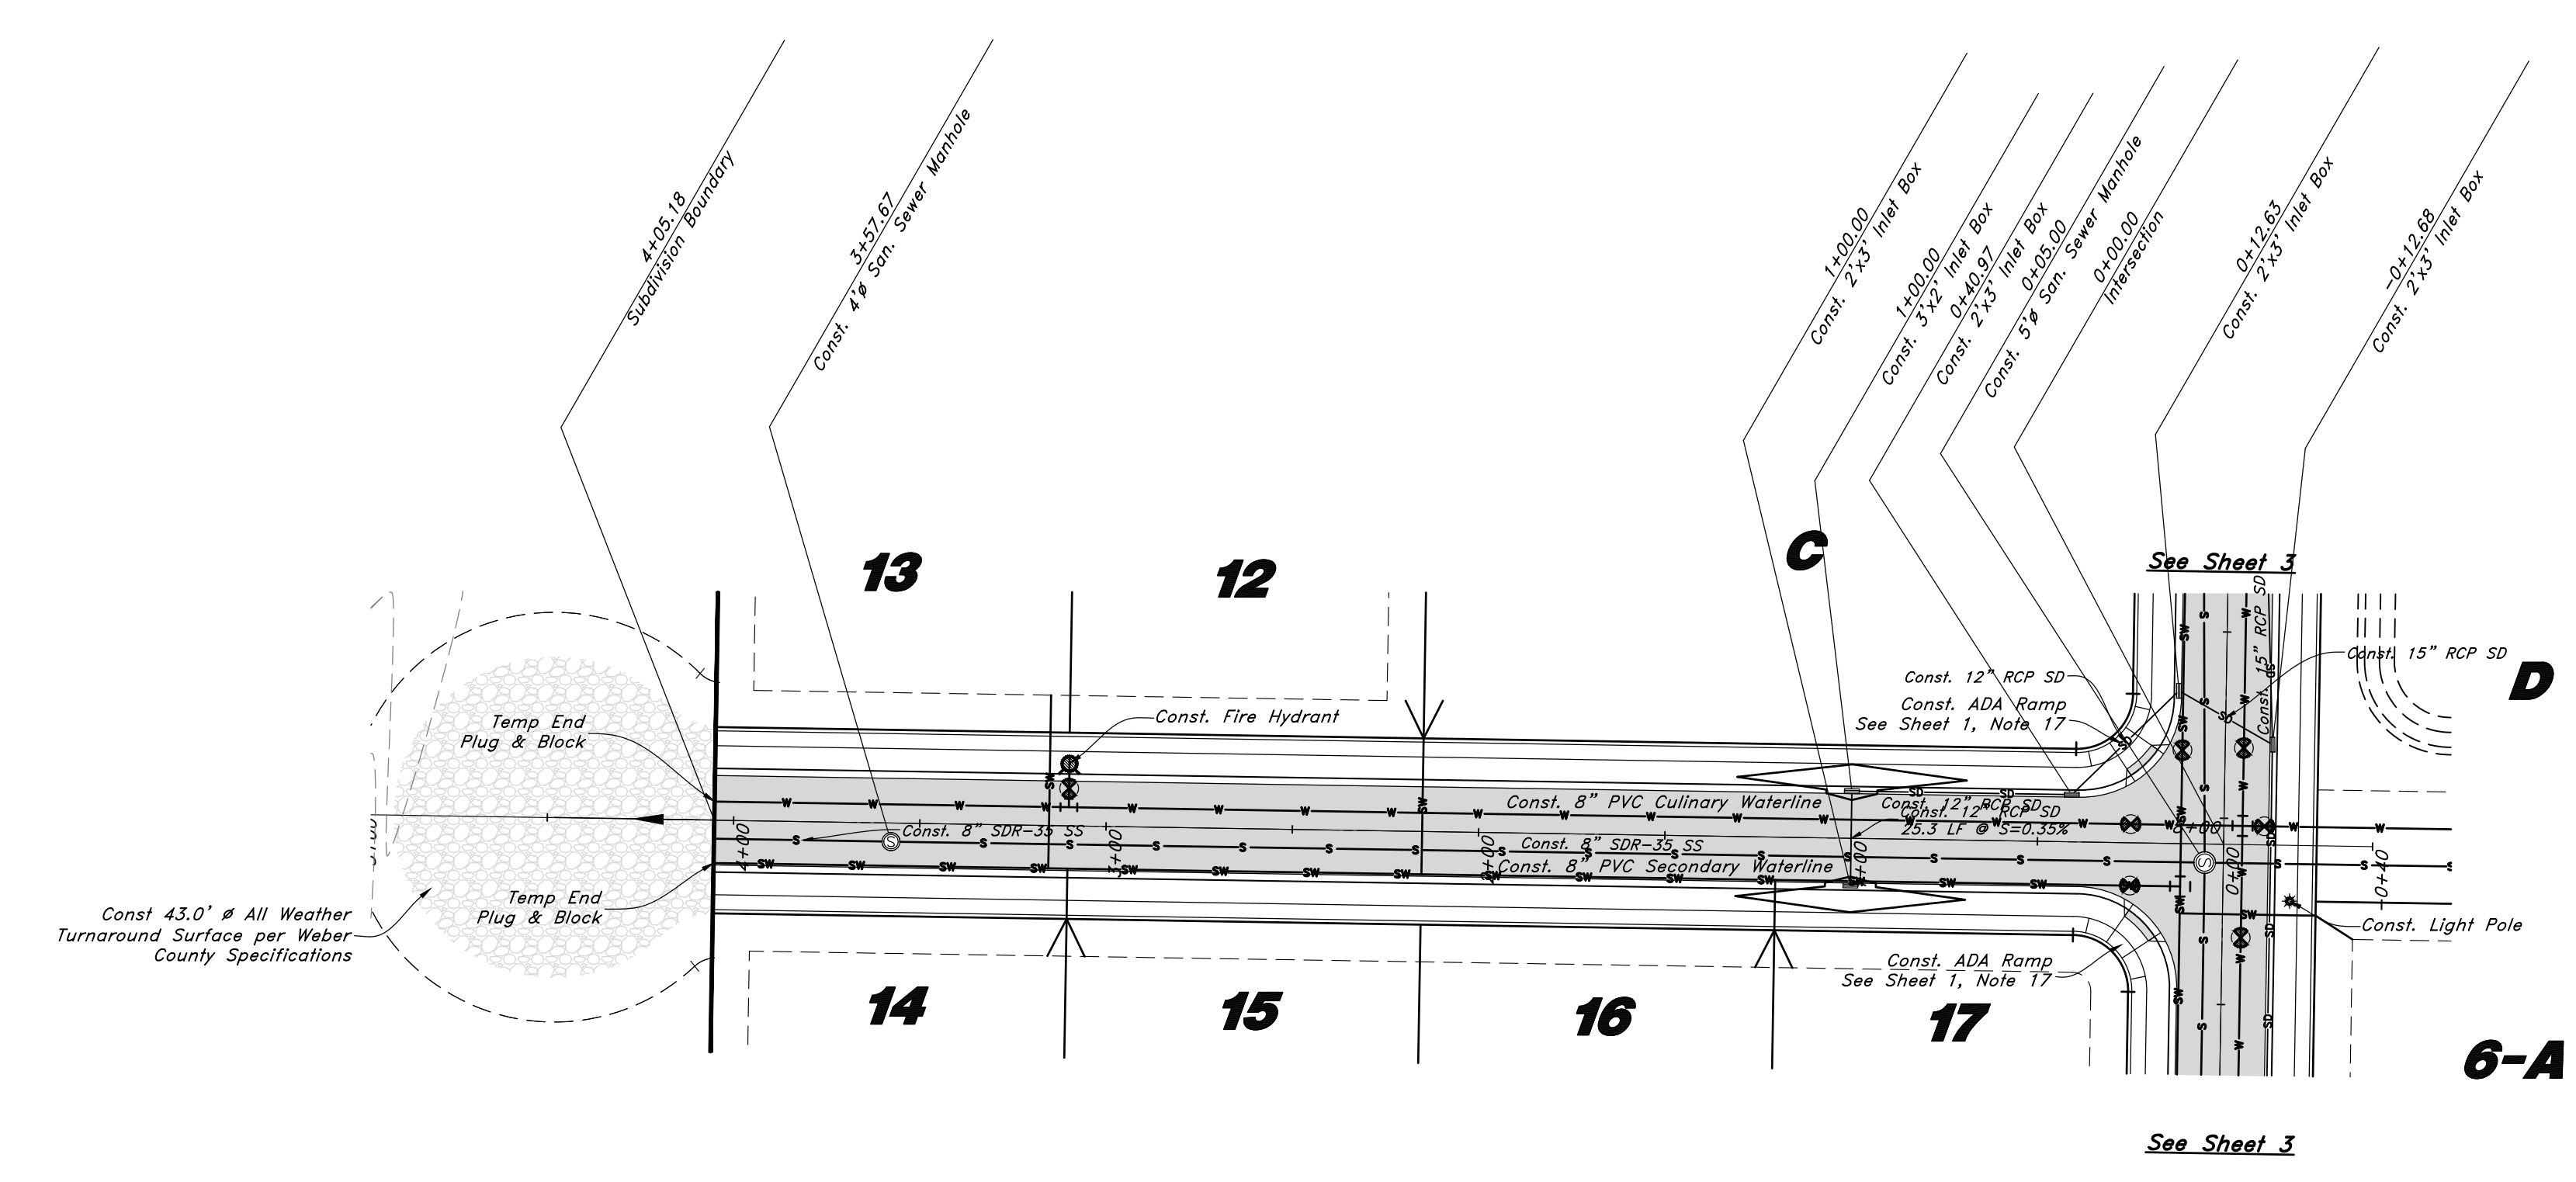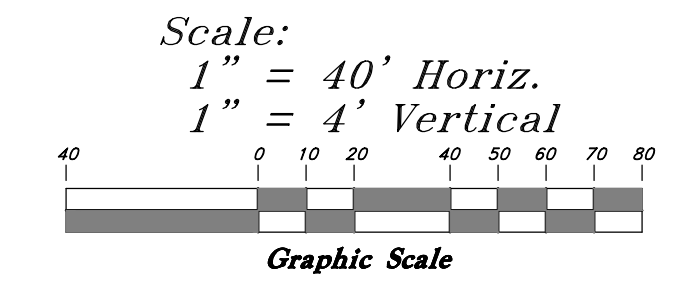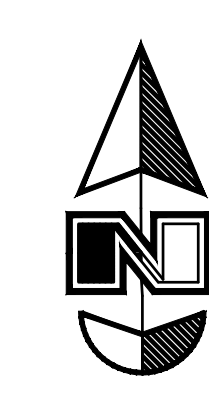- San. Sewer Manhole
- Water Manhole
- Storm Drain Manhole
- Cleanout
- Electrical Manhole
- Catch Basins
- Exist. Fire Hydrant
- Fire Hydrant
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- Water Valve
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- Heavy Duty Asphalt
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**GREAT BASIN ENGINEERING**

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**Plan & Profile**


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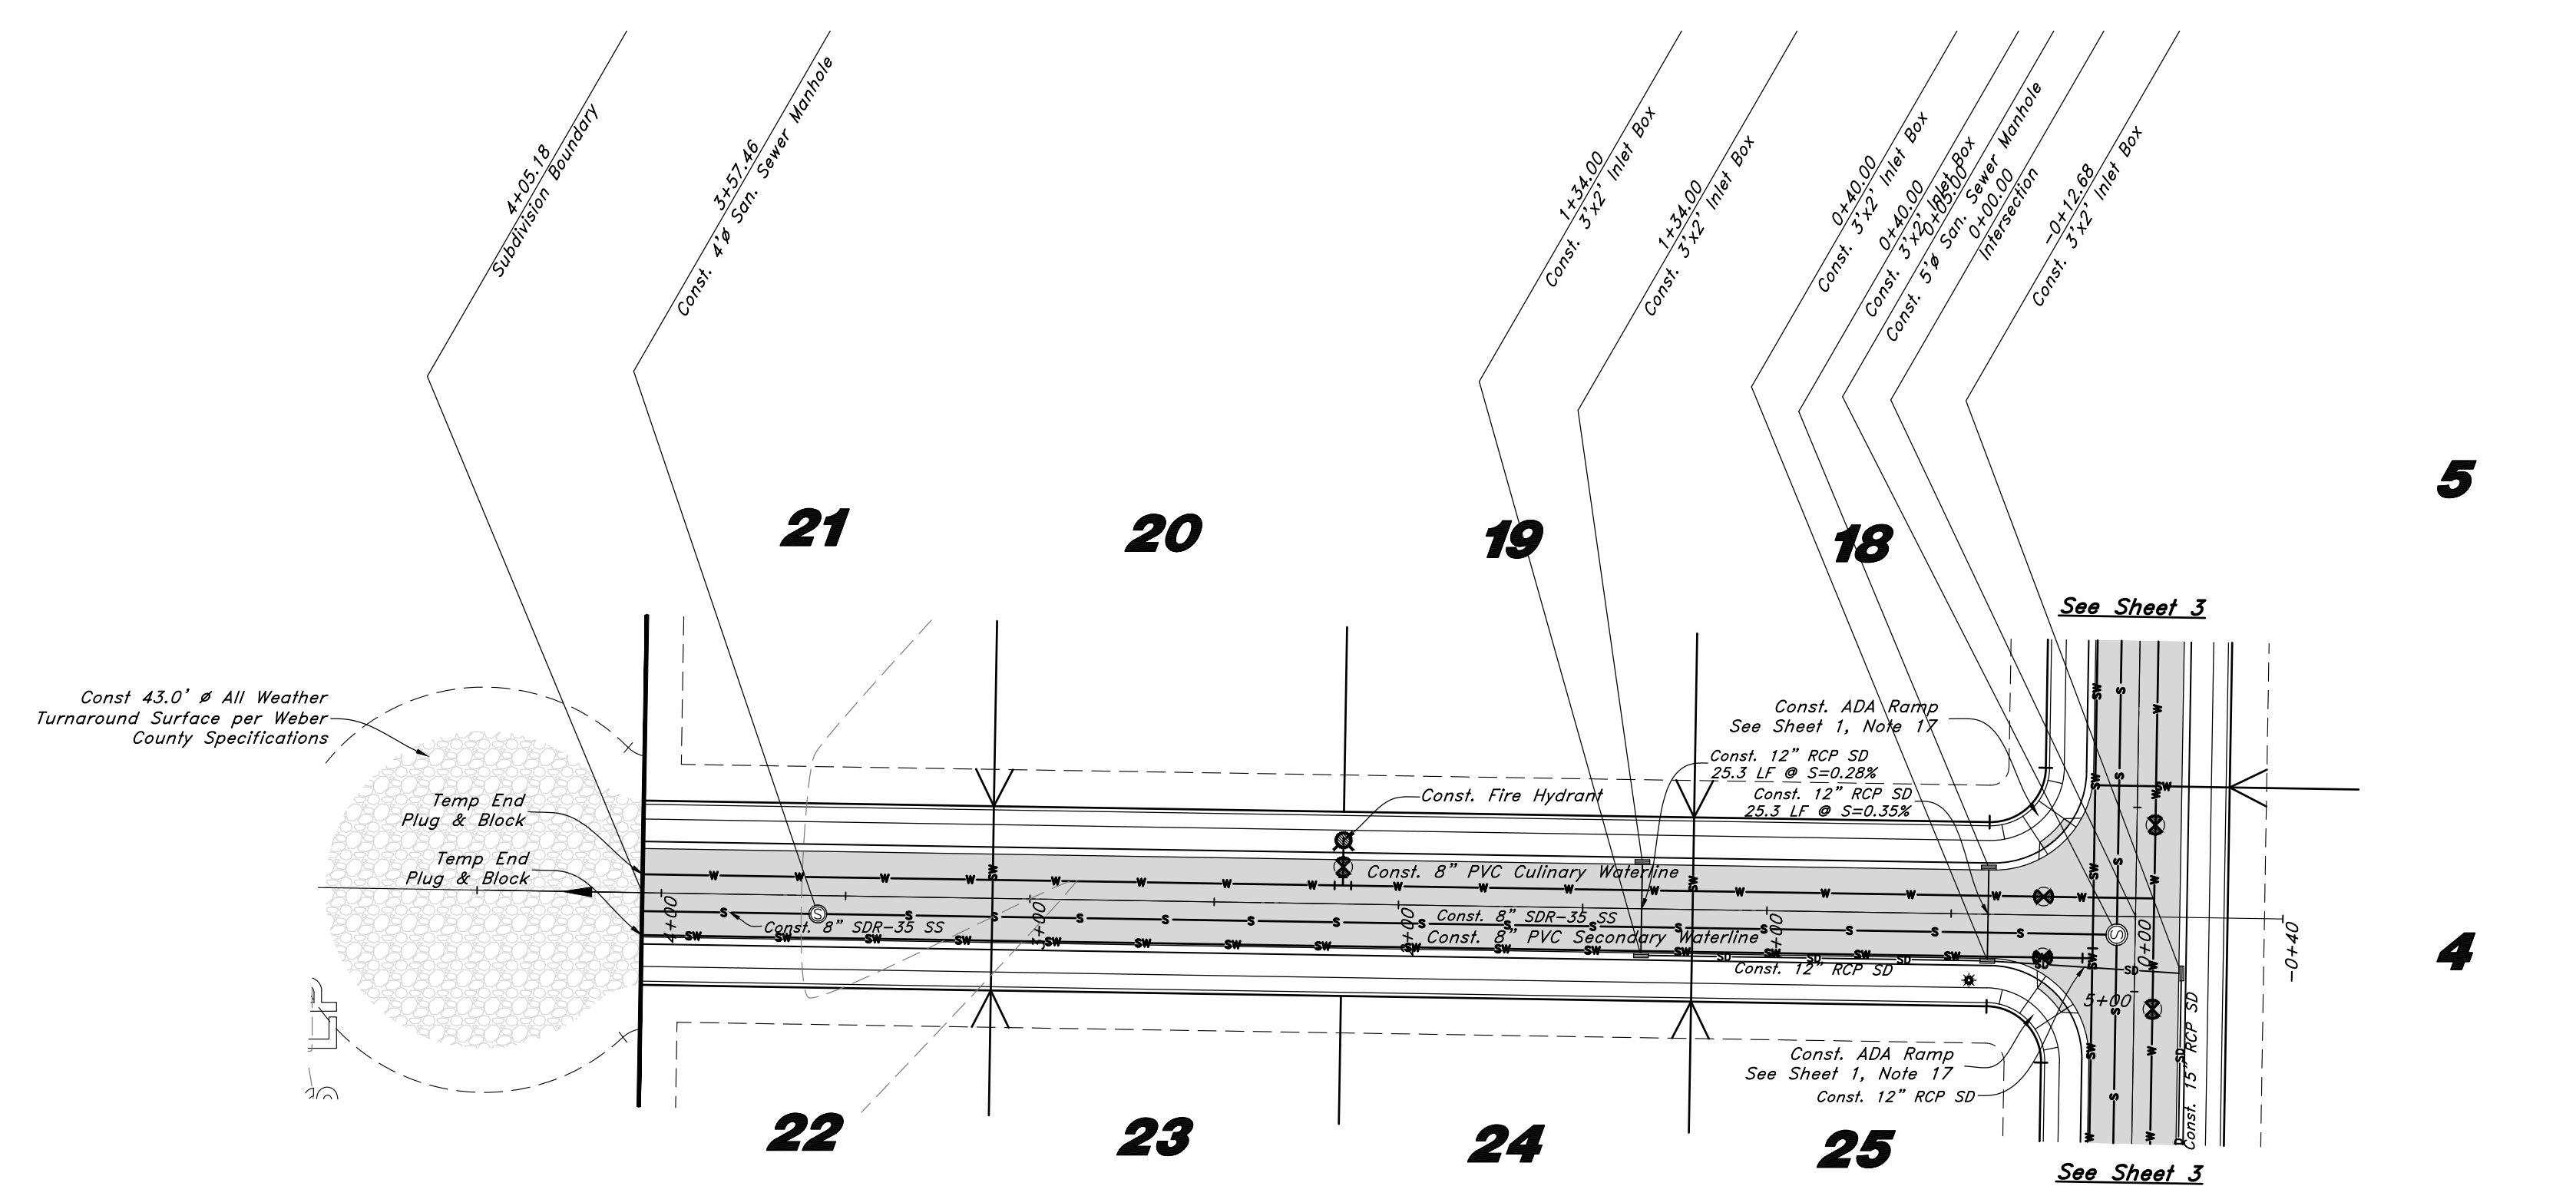
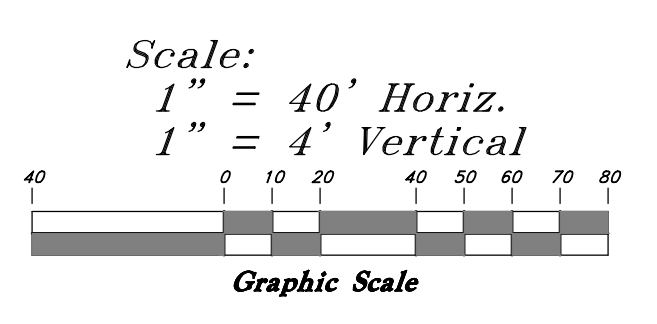
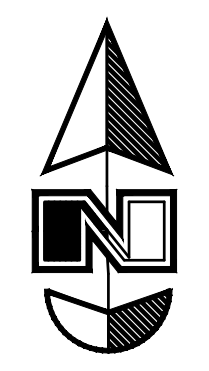
**FOR CONSTRUCTION**

REV	DATE	DESCRIPTION




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**Plan & Profile**  
**The Barn at Terakee Farms No. 1**  
 Approx. 900 South 4500 West  
 Weber County, Utah  
 A part of Section 17, T6N, R2W, S16&M, U.S. Survey

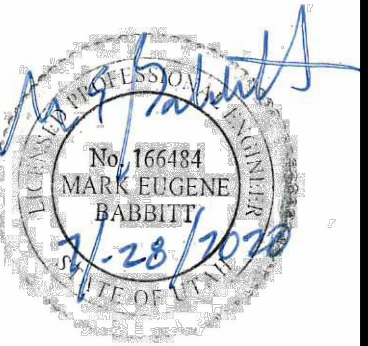

# 800 South Street

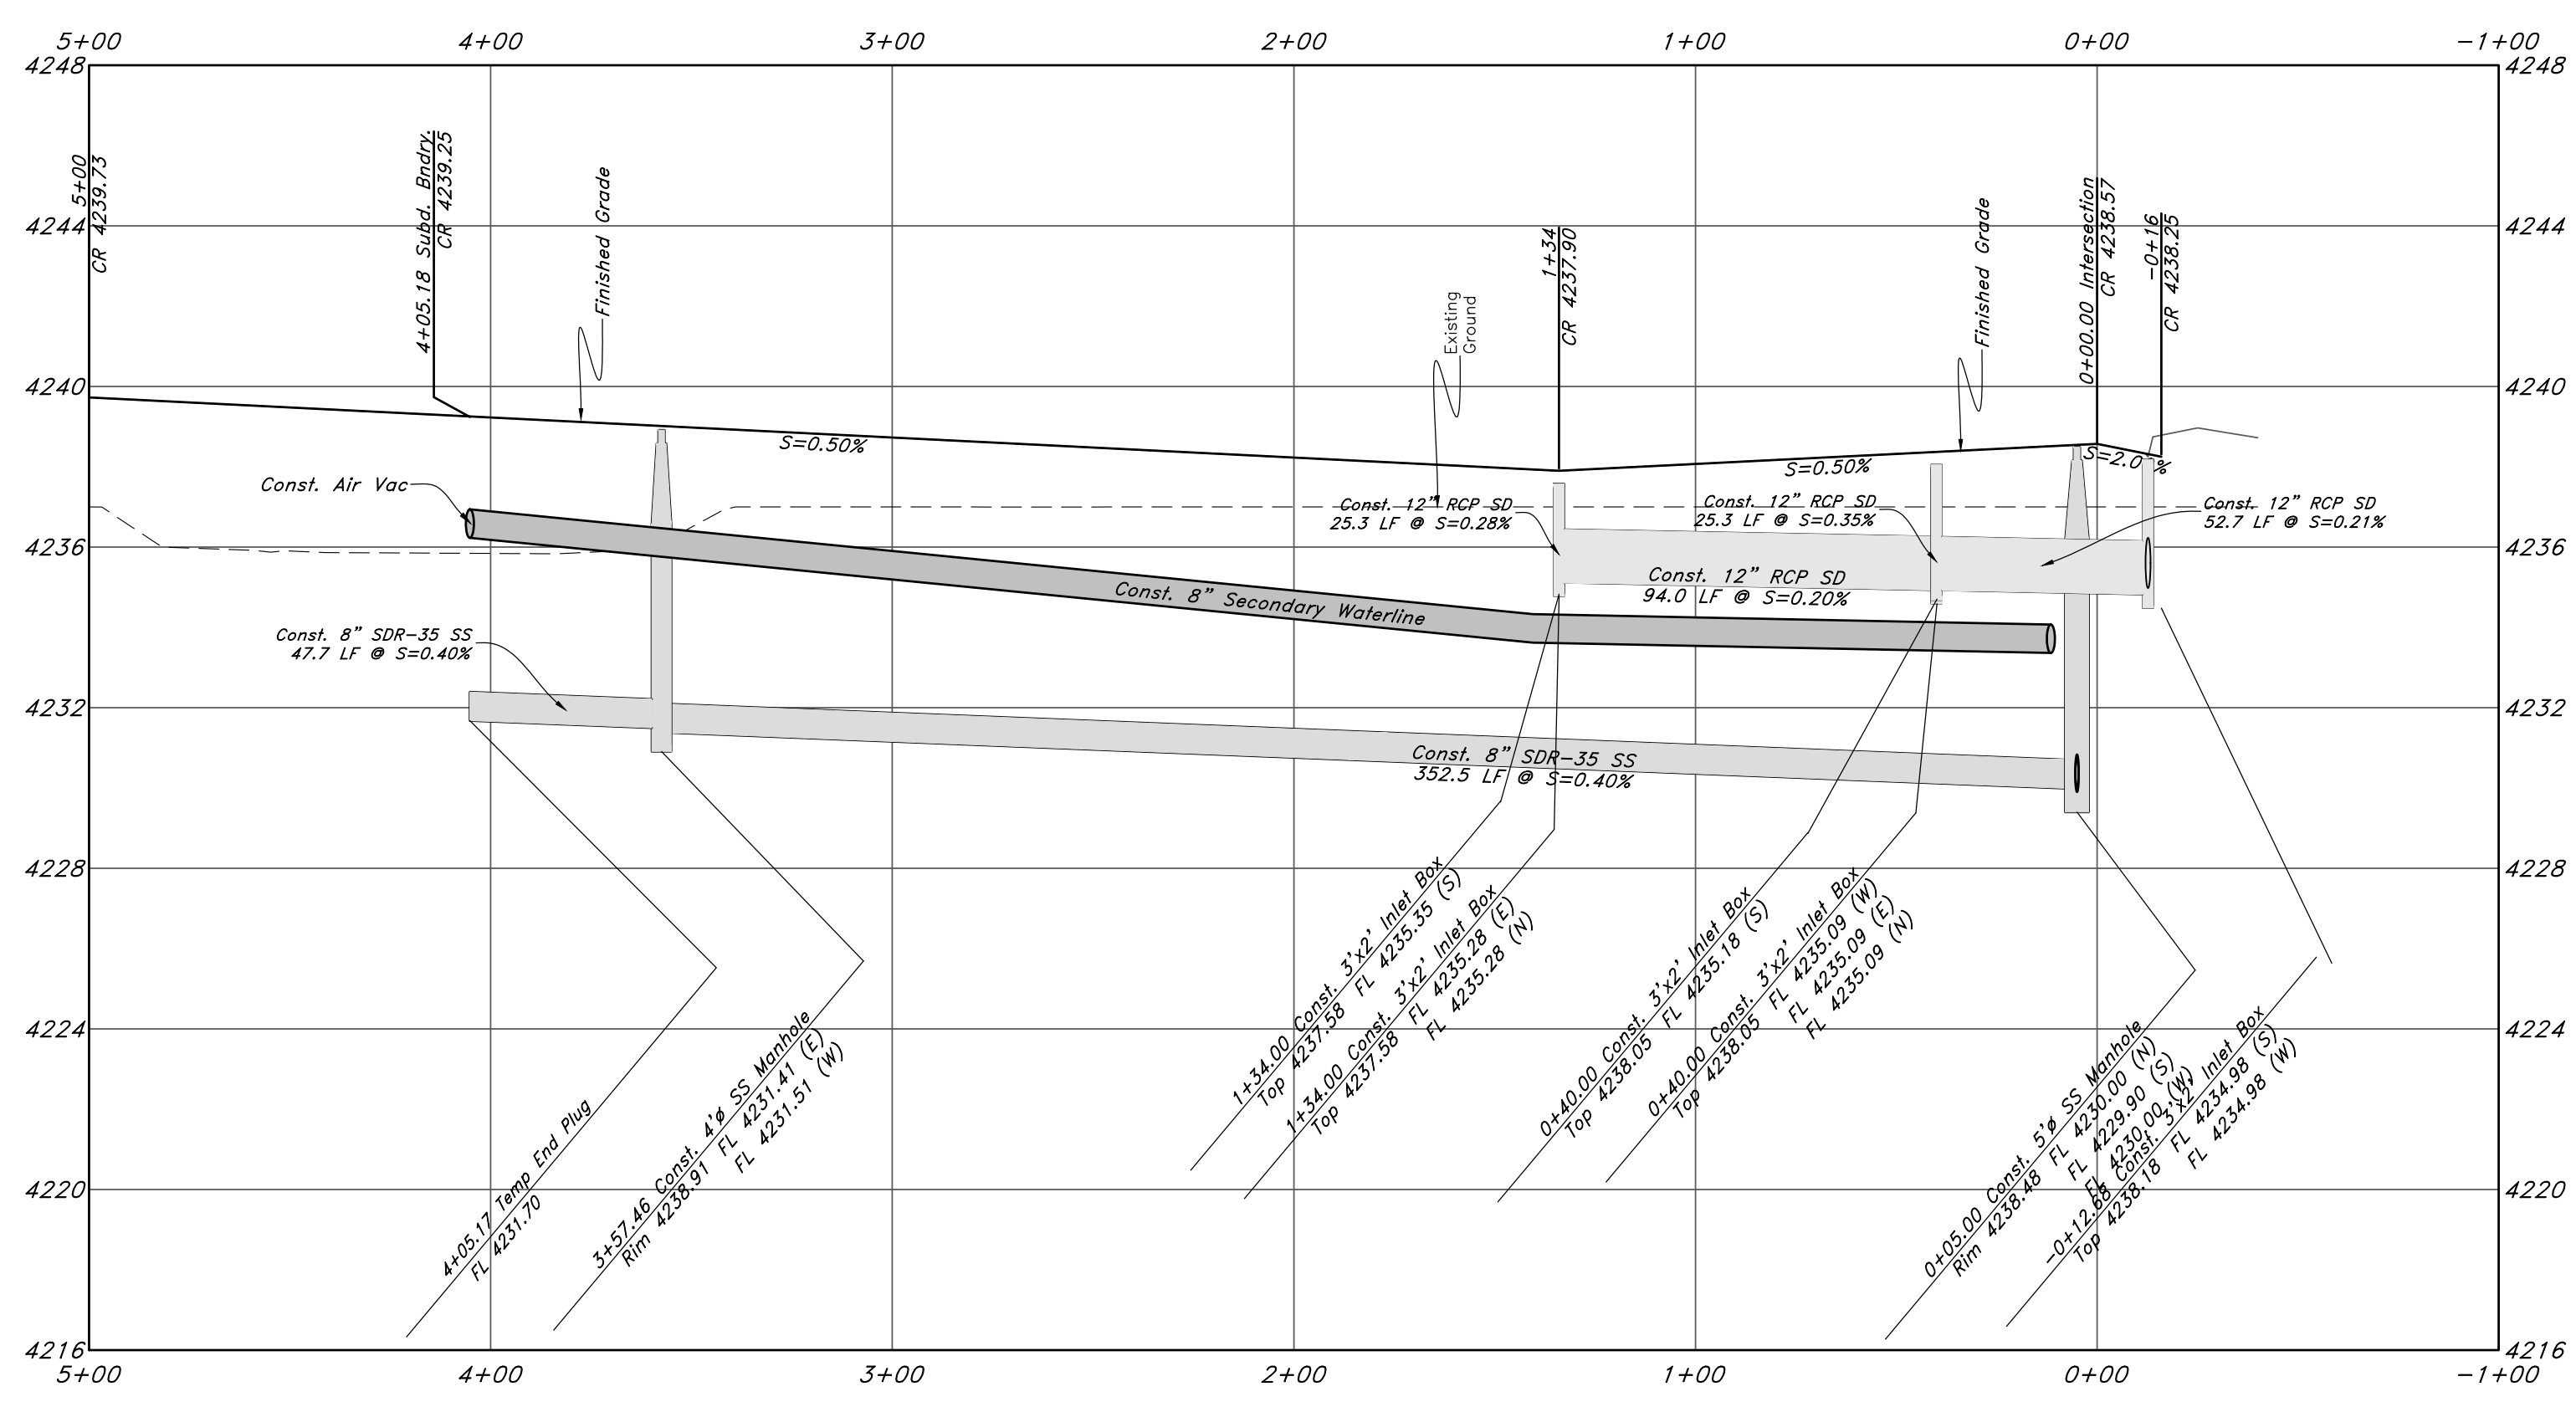

## Legend

(Note: All items may not appear on drawing)




- San. Sewer Manhole
- Water Manhole
- Storm Drain Manhole
- Cleanout
- Electrical Manhole
- Catch Basins
- Exist. Fire Hydrant
- Fire Hydrant
- Exist. Water Valve
- Water Valve
- Sanitary Sewer
- Culinary Water
- Gas Line
- Irrigation Line
- Storm Drain
- Telephone Line
- Secondary Waterline
- Power Line
- Fire Line
- Land Drain
- Power pole w/guy
- Light Pole
- Fence
- Flowline of ditch
- Overhead Power line
- Corrugated Metal Pipe
- Concrete Pipe
- Reinforced Concrete Pipe
- Ductile Iron
- Polyvinyl Chloride
- Top of Asphalt
- Edge of Asphalt
- Centerline
- Flowline
- Finish Floor
- Top of Curb
- Top of Wall
- Top of Walk
- Top of Concrete
- Natural Ground
- Finish Grade
- Match Existing
- Fire Department Connection
- Finish Contour
- Exist. Contour
- Finish Grade
- Exist. Grade
- Ridge Line
- Existing Asphalt
- New Asphalt
- Heavy Duty Asphalt
- Existing Concrete
- New Concrete
- Spill Curb & Gutter

**FOR CONSTRUCTION**



20 July, 2020  
 SHEET NO.  
**6**  
 of 11  
 16N719 - AM

REV	DATE	DESCRIPTION

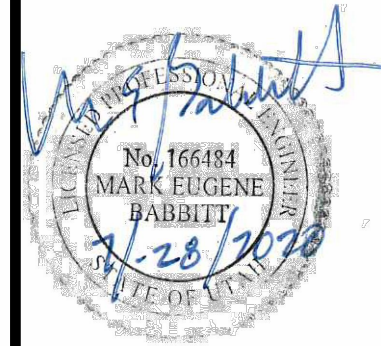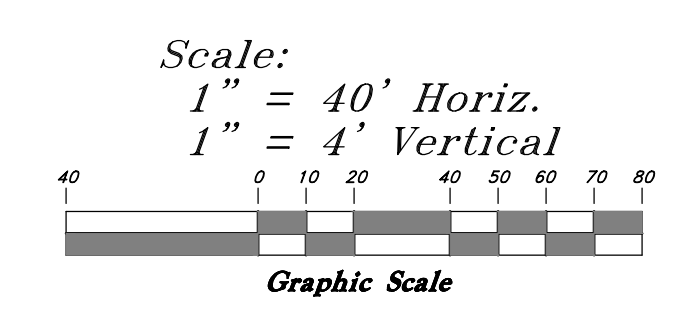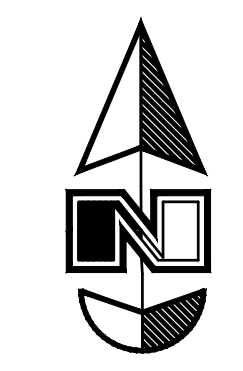

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**Plan & Profile**

**The Barn at Terakee Farms No. 1**  
 Approx. 900 South 4500 West  
 Weber County, Utah  
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20 July, 2020


SHEET NO. **7** of 11

16N719 - AM


### Legend

(Note: All items may not appear on drawing)

- San. Sewer Manhole
- Water Manhole
- Storm Drain Manhole
- Cleanout
- Electrical Manhole
- Catch Basins
- Exist. Fire Hydrant
- Fire Hydrant
- Exist. Water Valve
- Water Valve
- Sanitary Sewer
- Culinary Water
- Gas Line
- Irrigation Line
- Storm Drain
- Telephone Line
- Secondary Waterline
- Power Line
- Fire Line
- Land Drain
- Power pole
- Power pole w/guy
- Light Pole
- Fence
- Flowline of ditch
- Overhead Power line
- Corrugated Metal Pipe
- Concrete Pipe
- Reinforced Concrete Pipe
- Ductile Iron
- Polyvinyl Chloride
- PVC
- Top of Asphalt
- Edge of Asphalt
- Centerline
- Flowline
- Finish Floor
- Top of Curb
- Top of Wall
- Top of Walk
- TCN
- Top of Concrete
- Natural Ground
- Finish Grade
- Match Existing
- Fire Department Connection
- Finish Contour
- Exist. Contour
- Finish Grade
- Exist. Grade
- Ridge Line
- Existing Asphalt
- New Asphalt
- Heavy Duty Asphalt
- Existing Concrete
- New Concrete
- Spill Curb & Gutter

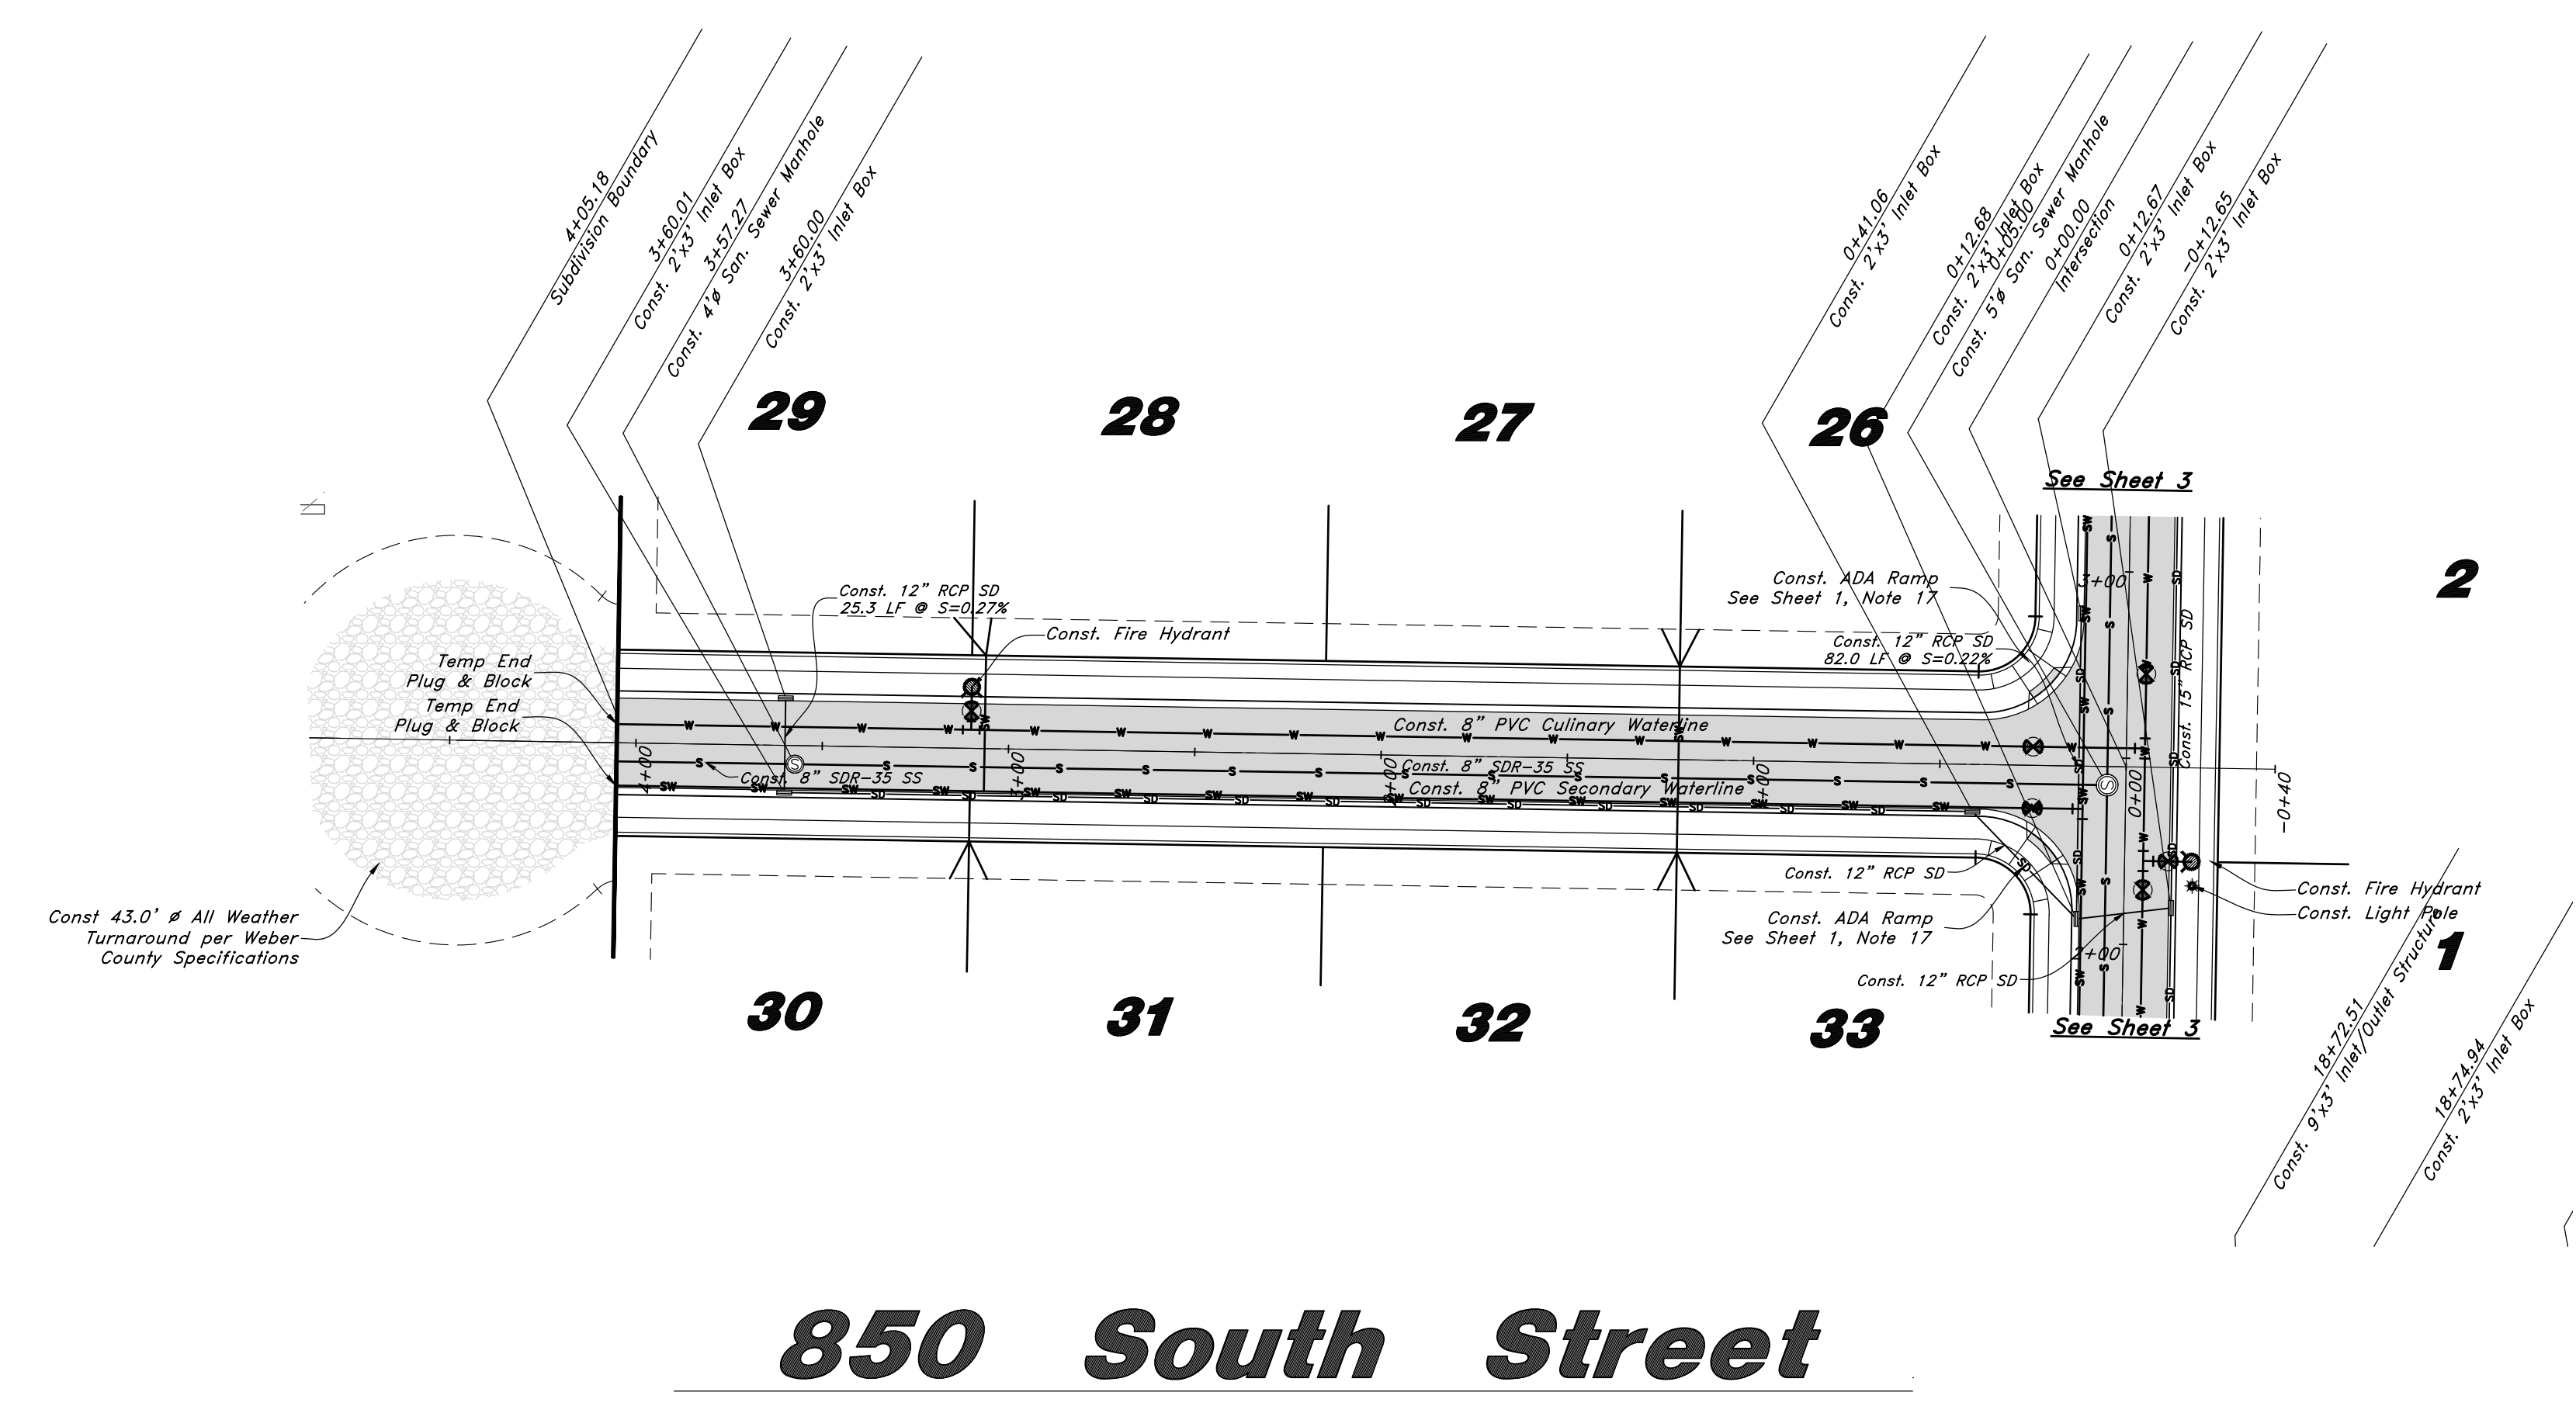



## 850 South Street

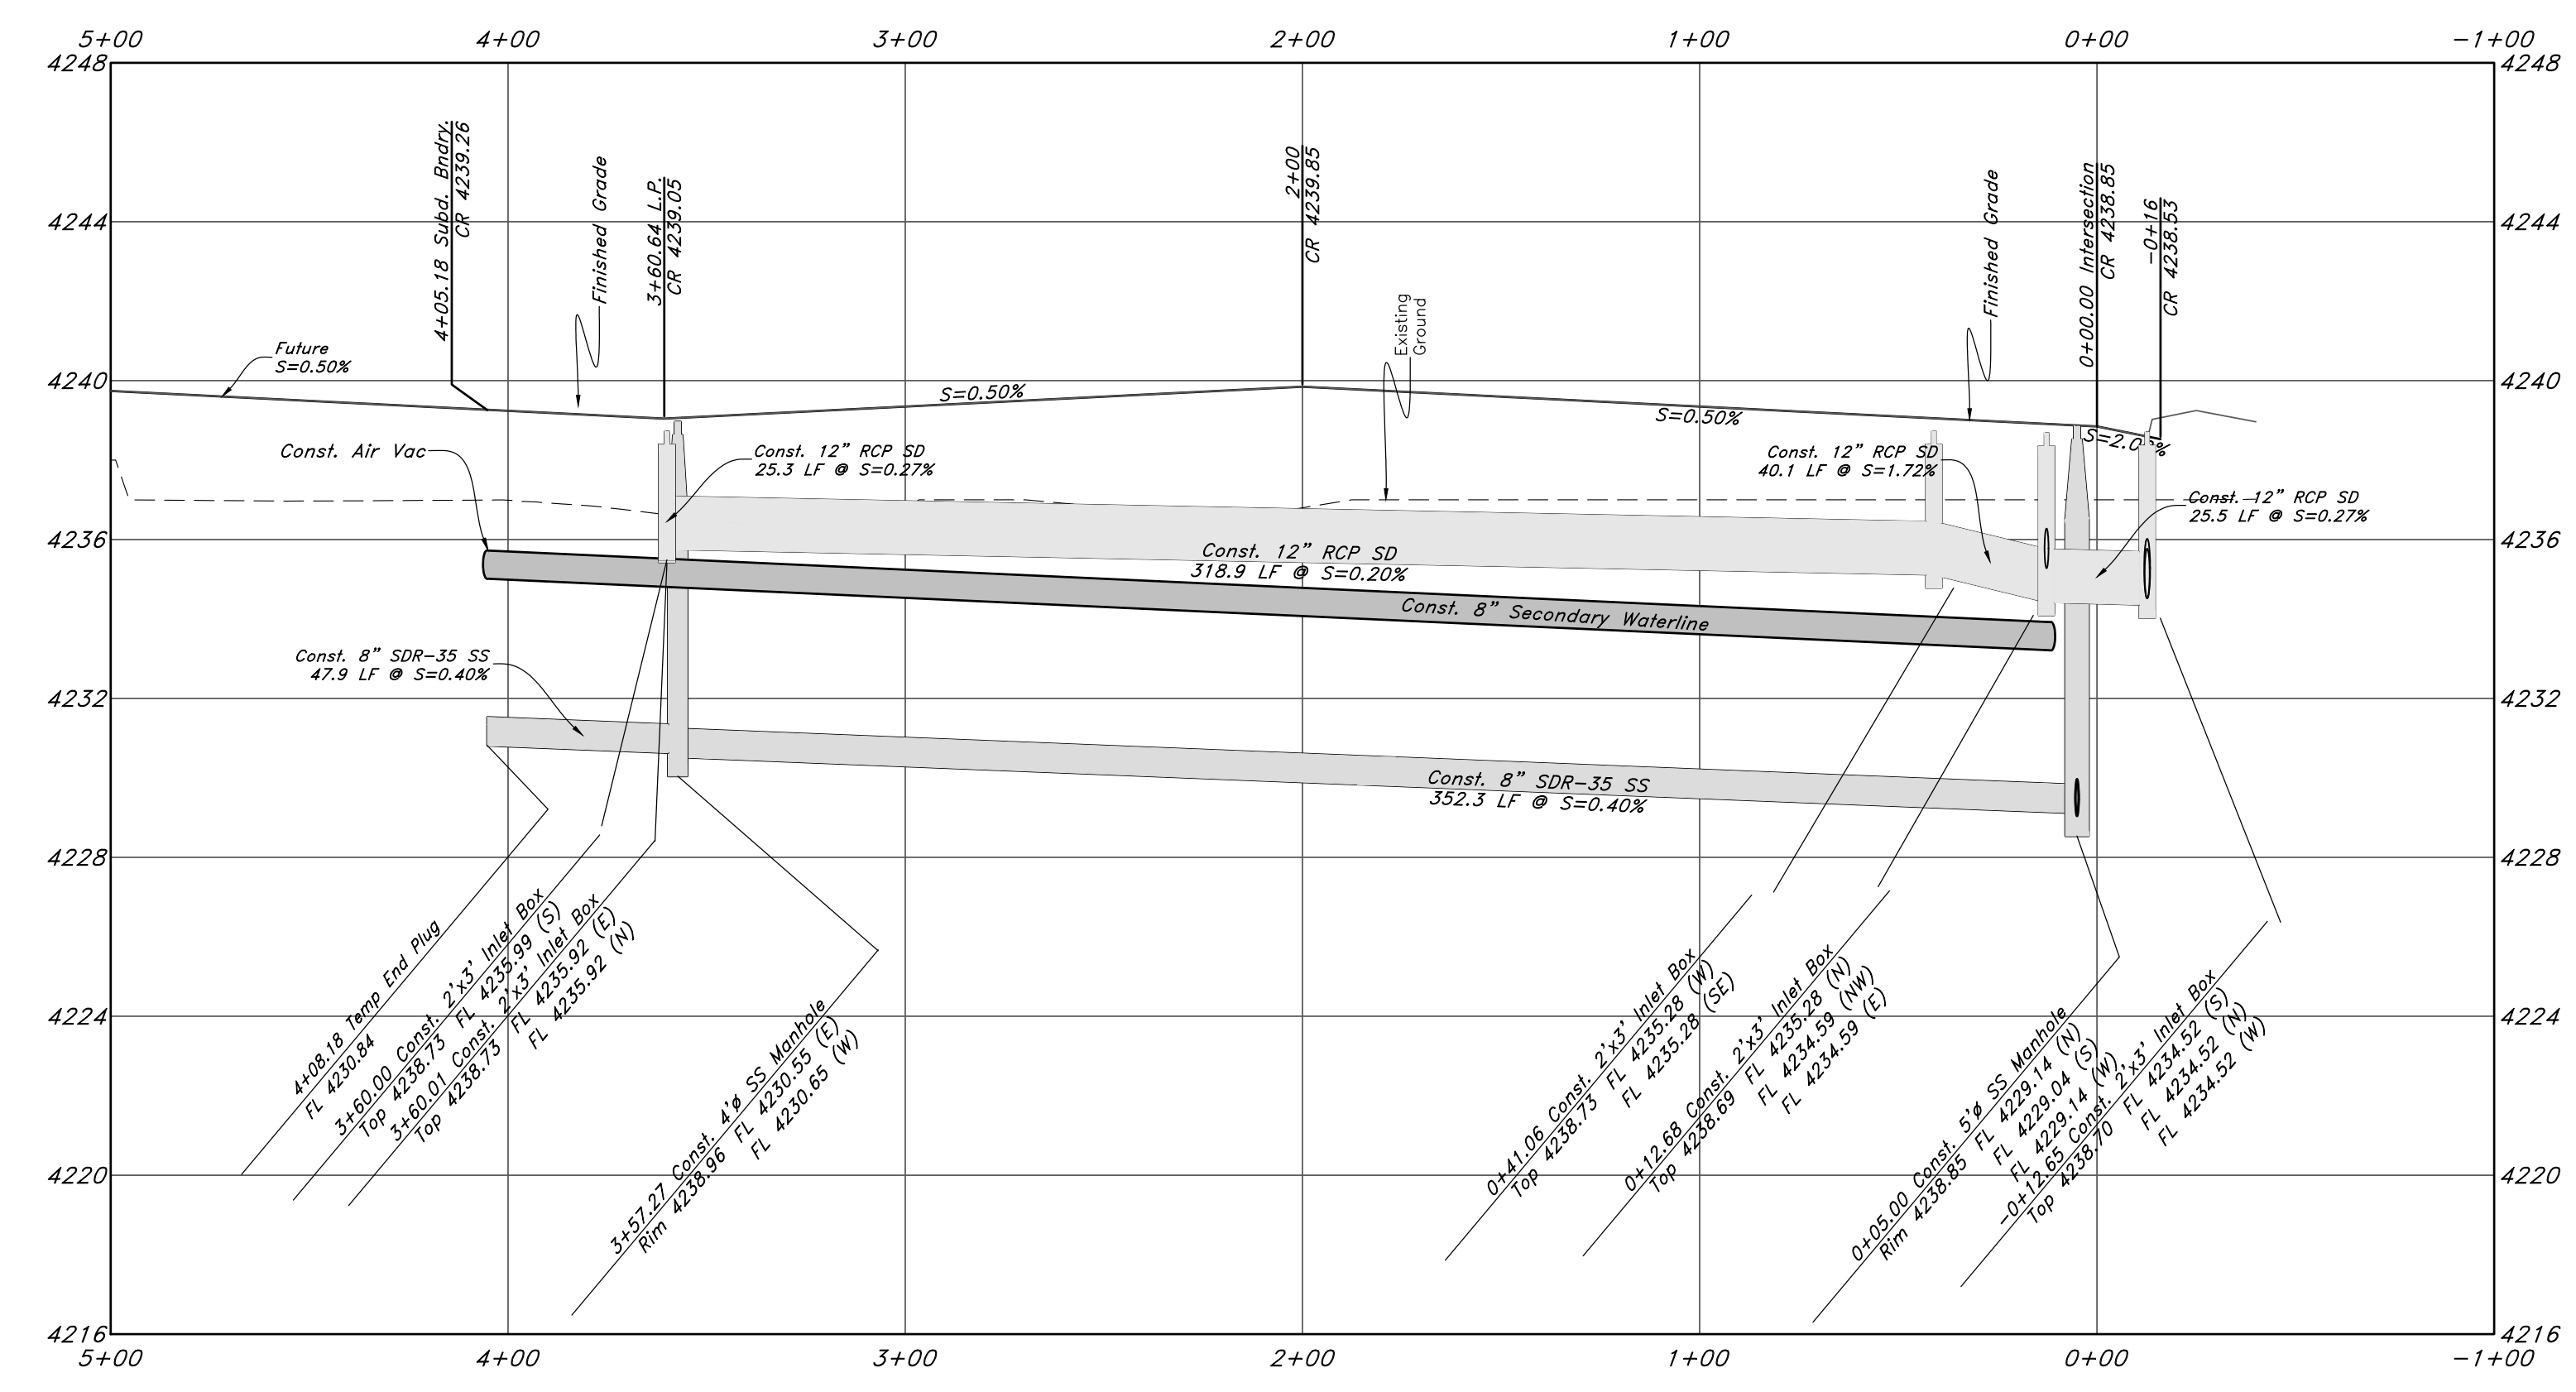

**FOR CONSTRUCTION**







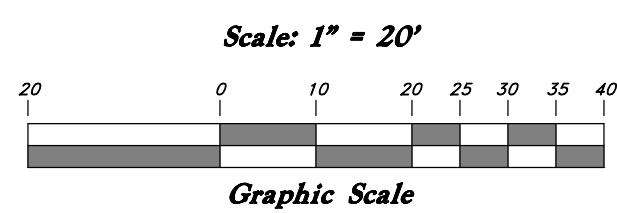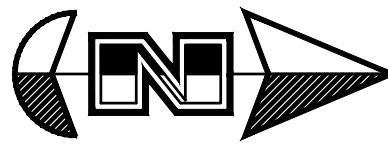

### Legend

(Note: All items may not appear on drawing)


- San. Sewer Manhole
- Water Manhole
- Storm Drain Manhole
- Cleanout
- Electrical Manhole
- Catch Basin
- Exist. Fire Hydrant
- Fire Hydrant
- Exist. Water Valve
- Water Valve
- Sanitary Sewer
- Culinary Water
- Gas Line
- Irrigation Line
- Storm Drain
- Telephone Line
- Secondary Waterline
- Power Line
- Fire Line
- Land Drain
- Power pole
- Power pole w/guy
- Light Pole
- Fence
- Flowline of ditch
- Overhead Power line
- CMP
- Corrugated Metal Pipe
- Concrete Pipe
- RCP
- Reinforced Concrete Pipe
- Ductile Iron
- Polyvinyl Chloride
- TA
- EA
- Edge of Asphalt
- Centerline
- FL
- Finish Floor
- Top of Curb
- Top of Wall
- TWL
- Top of Walk
- Top of Concrete
- Natural Ground
- FG
- Match Existing
- Fire Department Connection
- FD
- Finish Contour
- Exist. Contour
- Finish Grade
- Exist. Grade
- Ridge Line

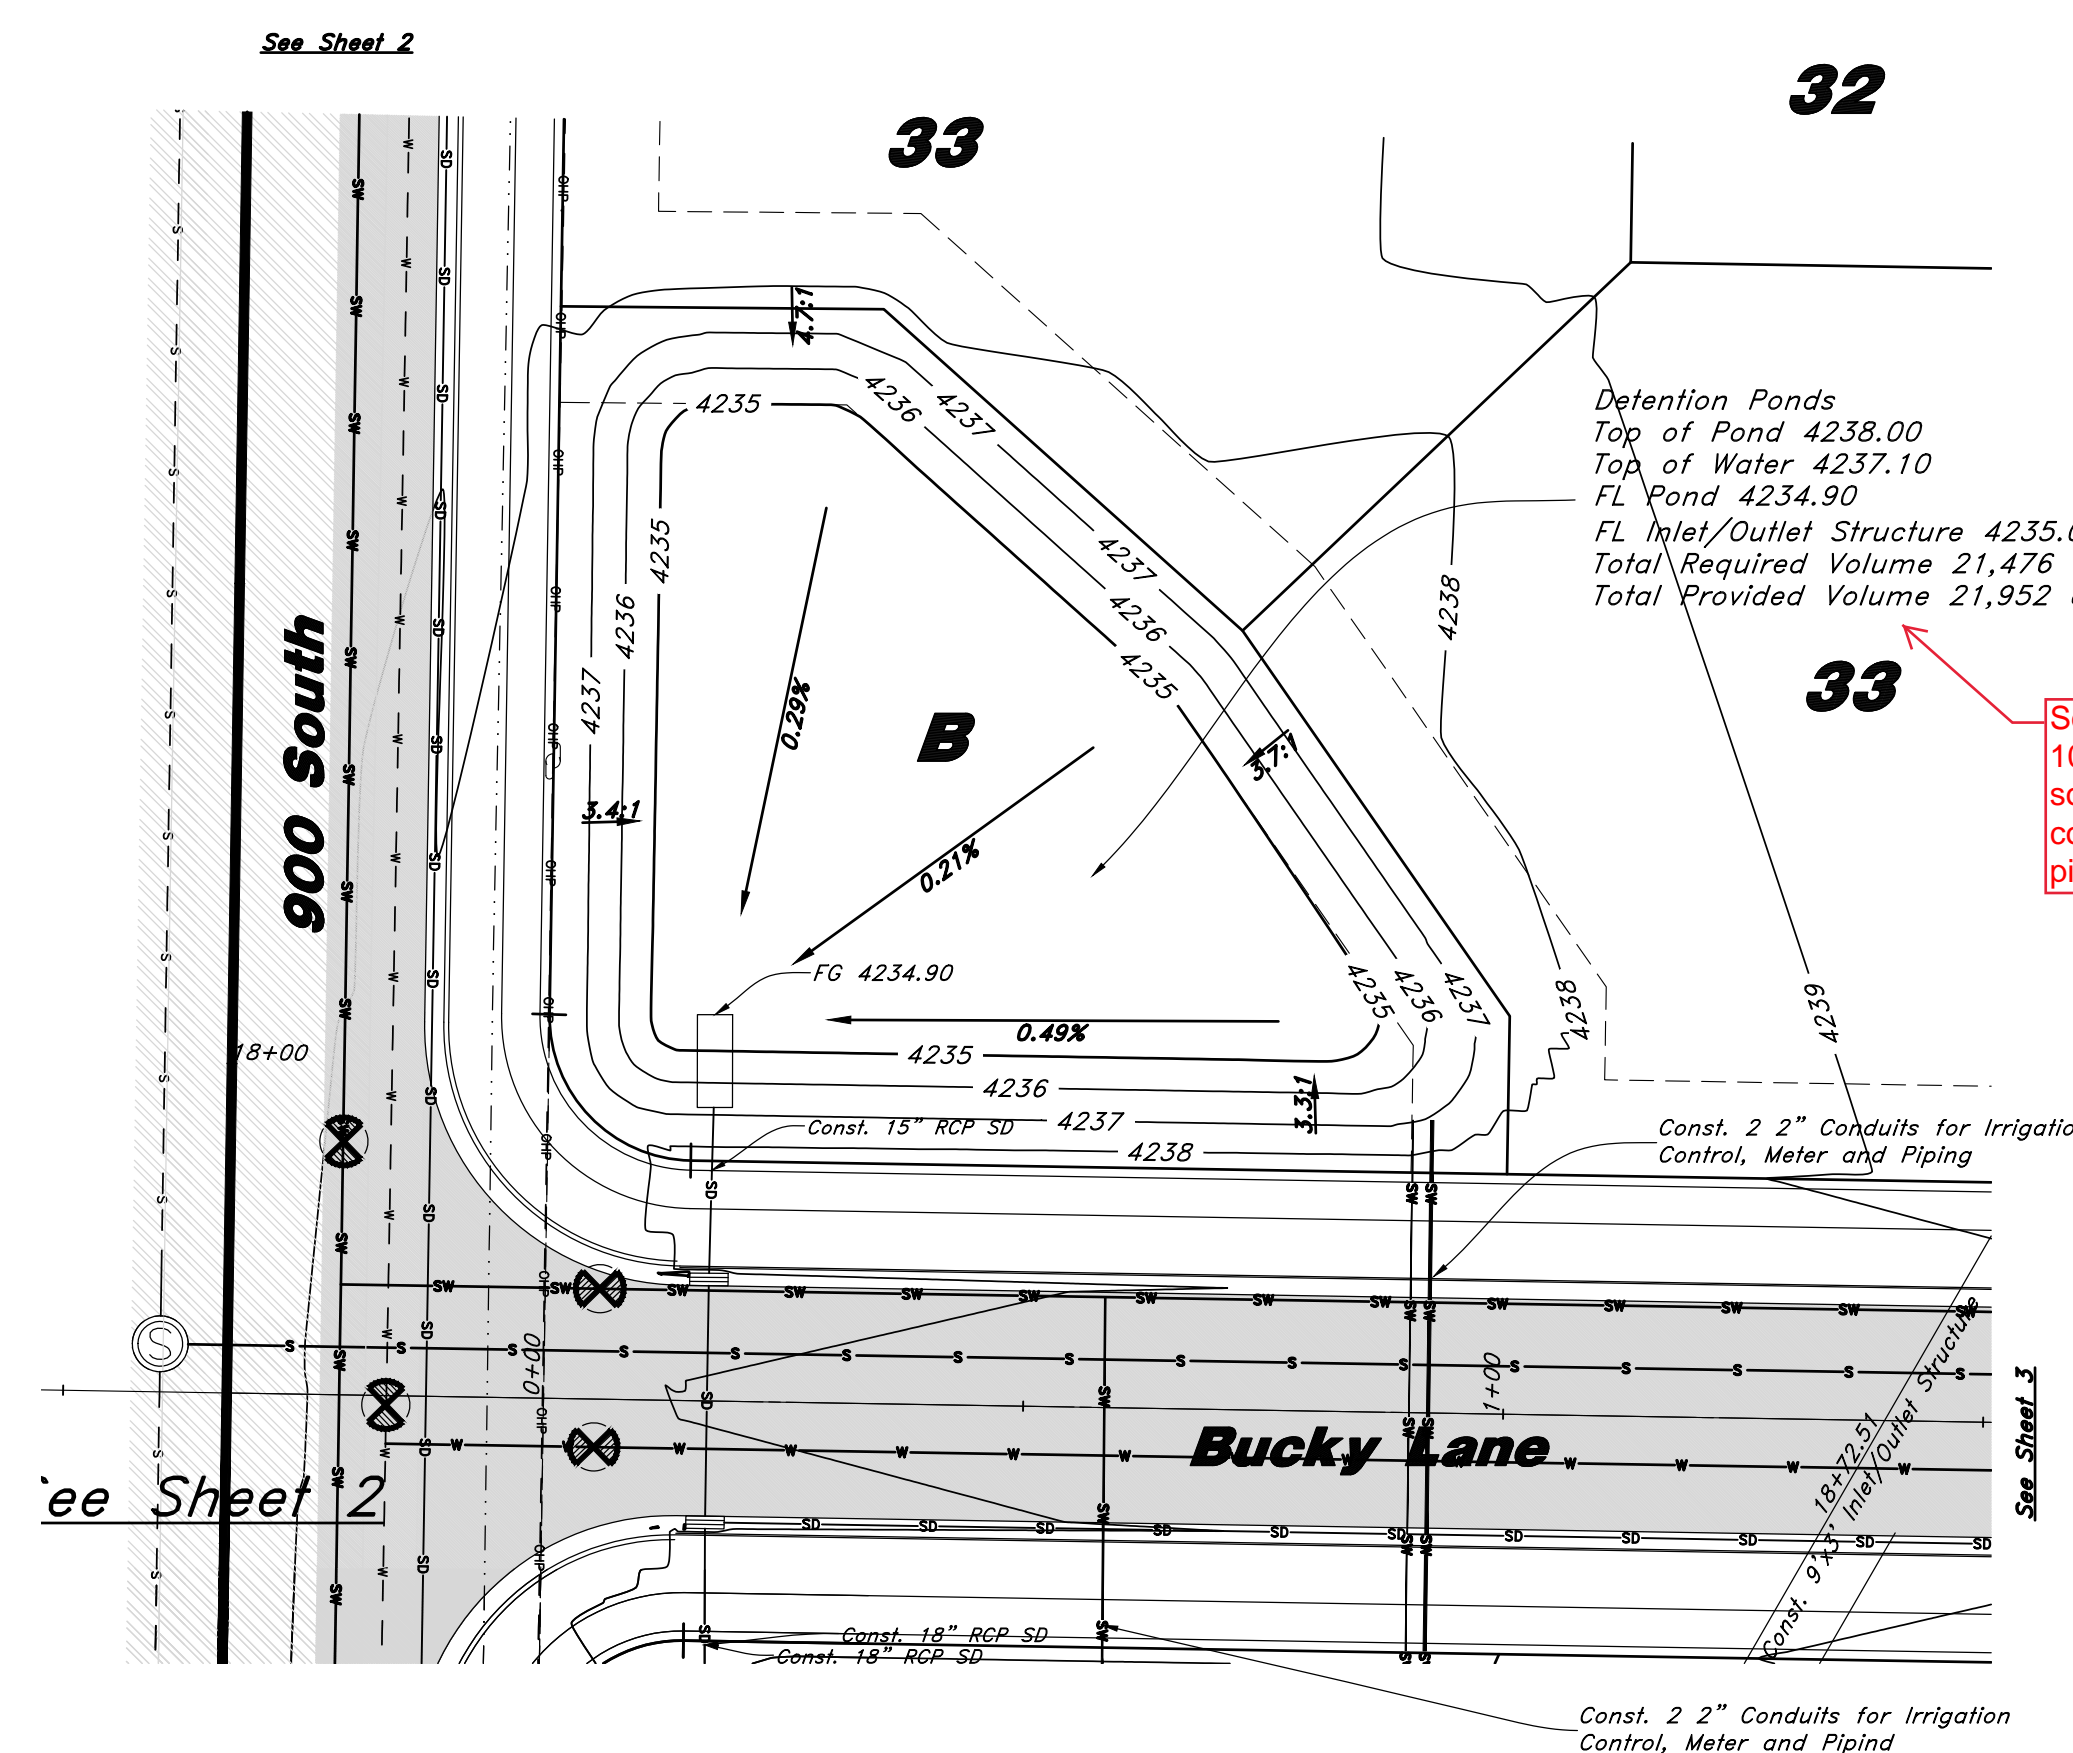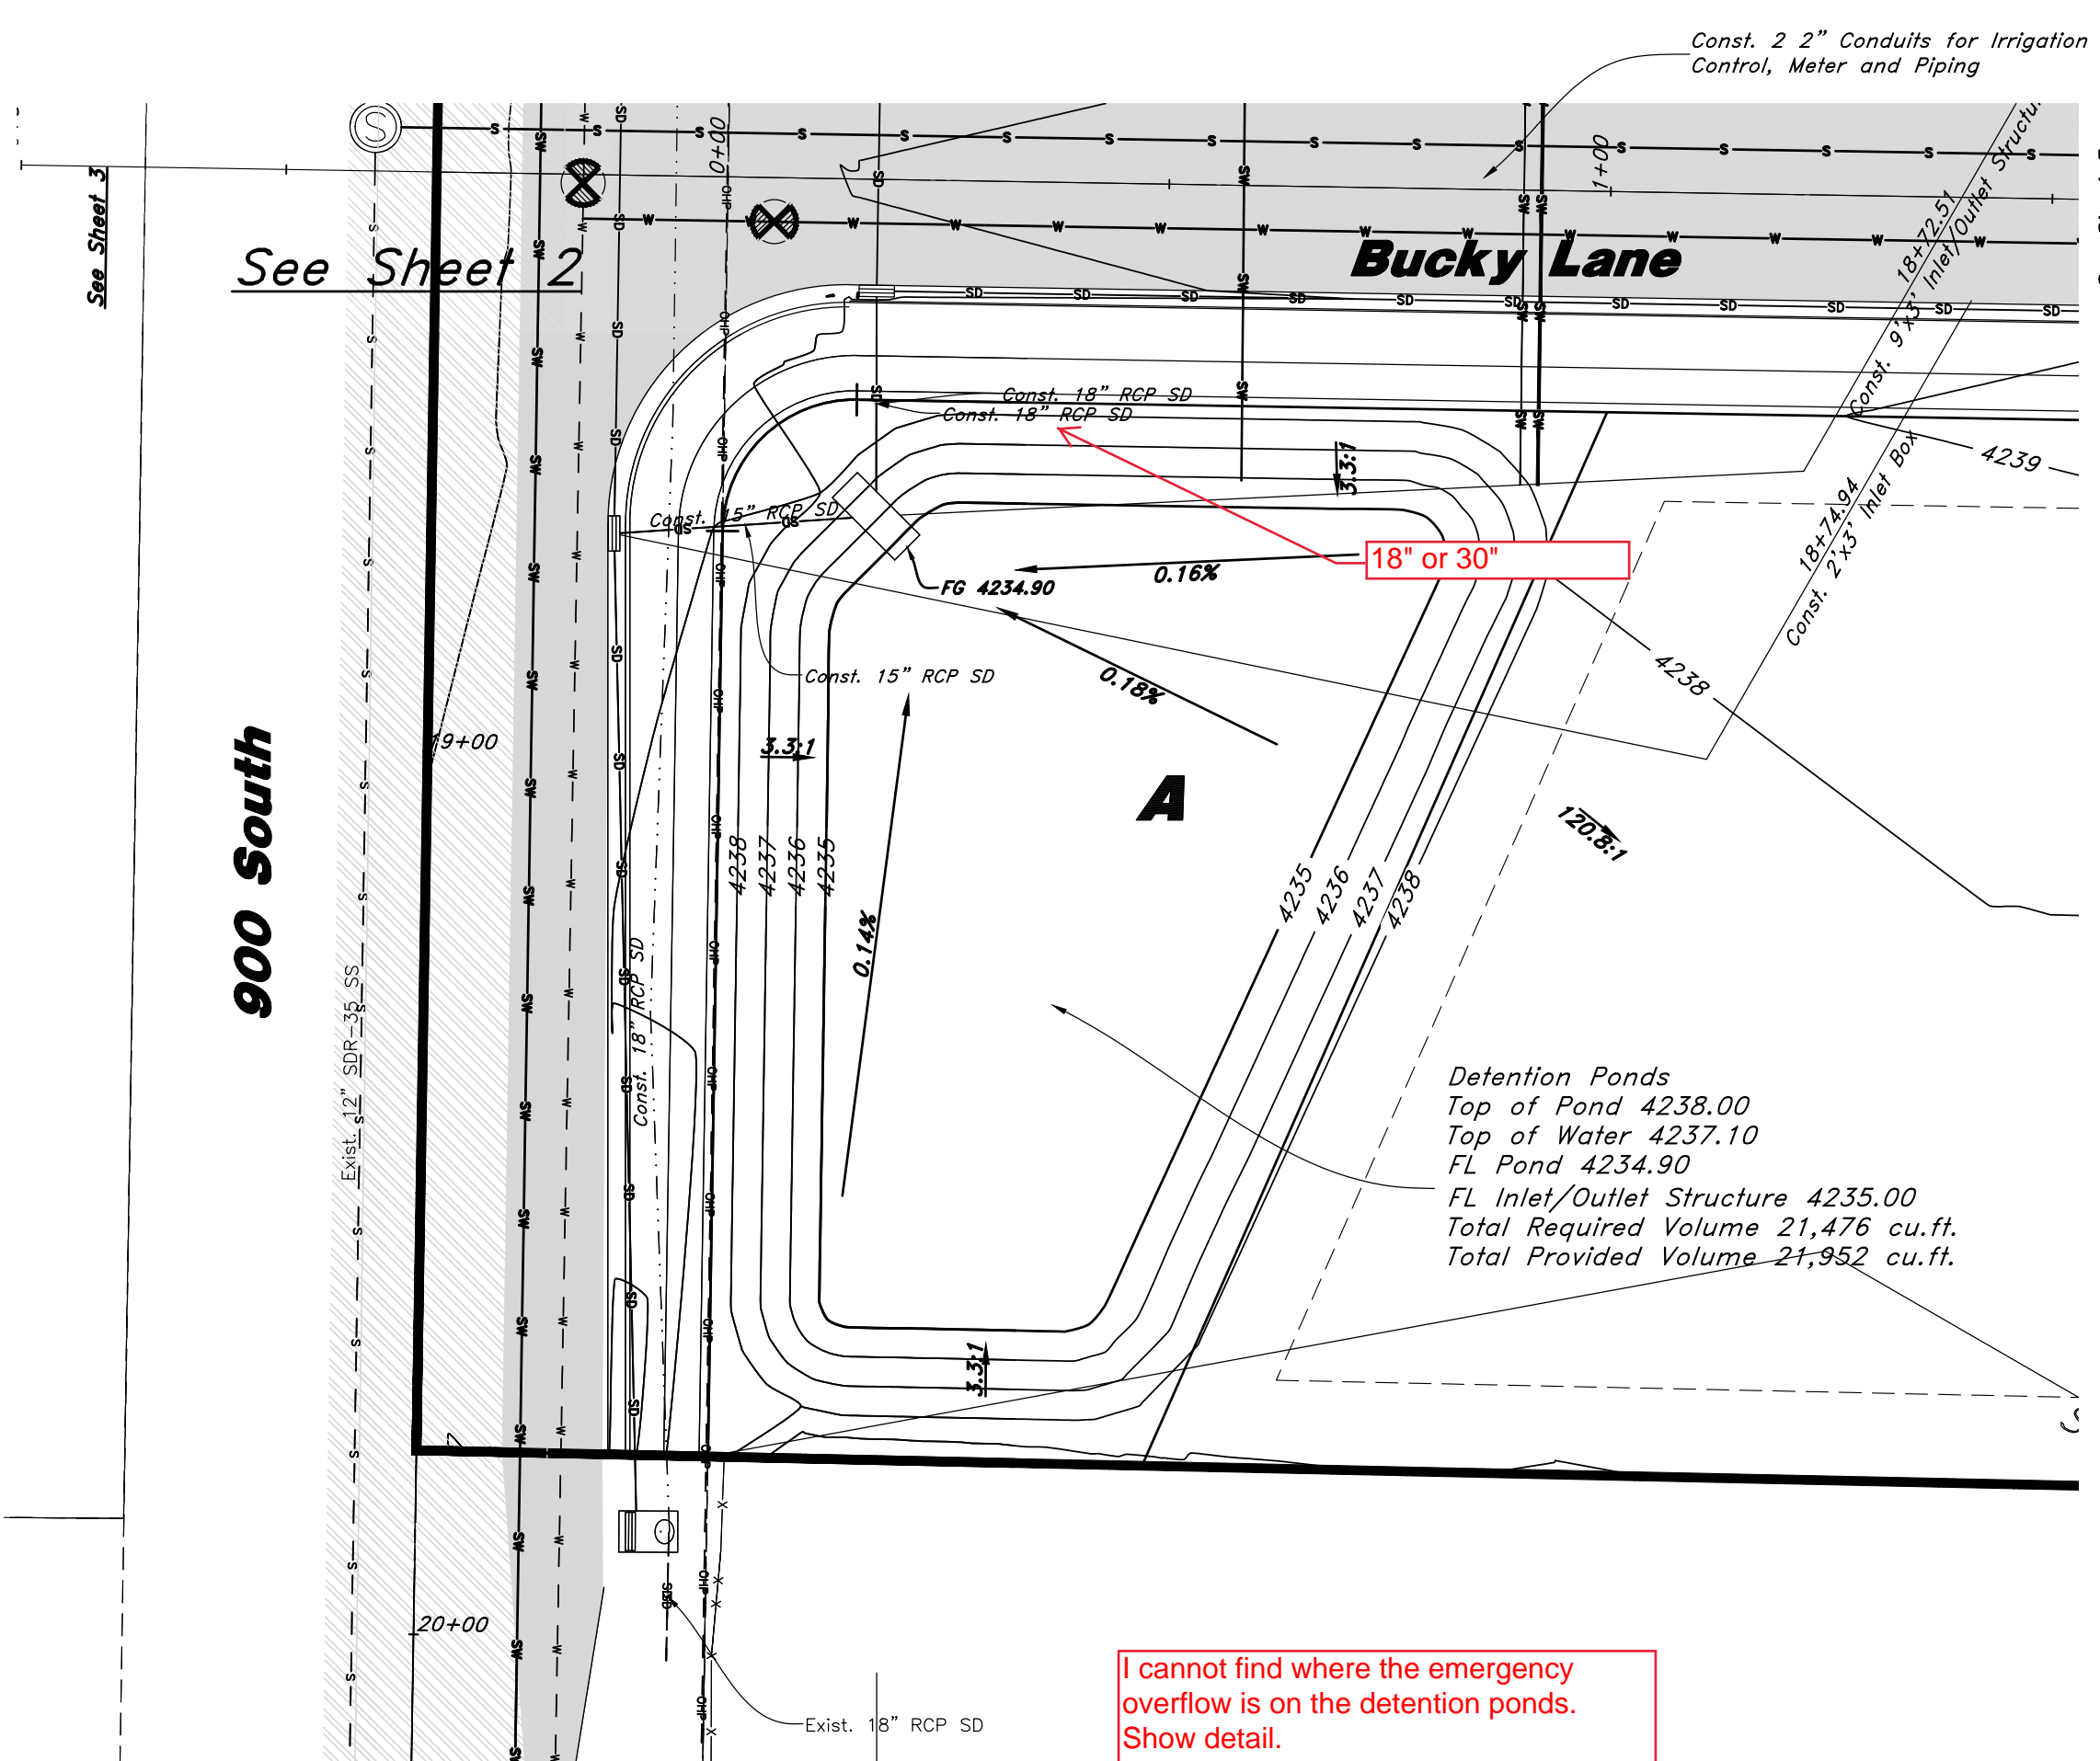


I cannot find where the emergency overflow is on the detention ponds. Show detail.

So is each pond 10,976 or is there some storage considered in the pipe crossing?


## Detention Pond

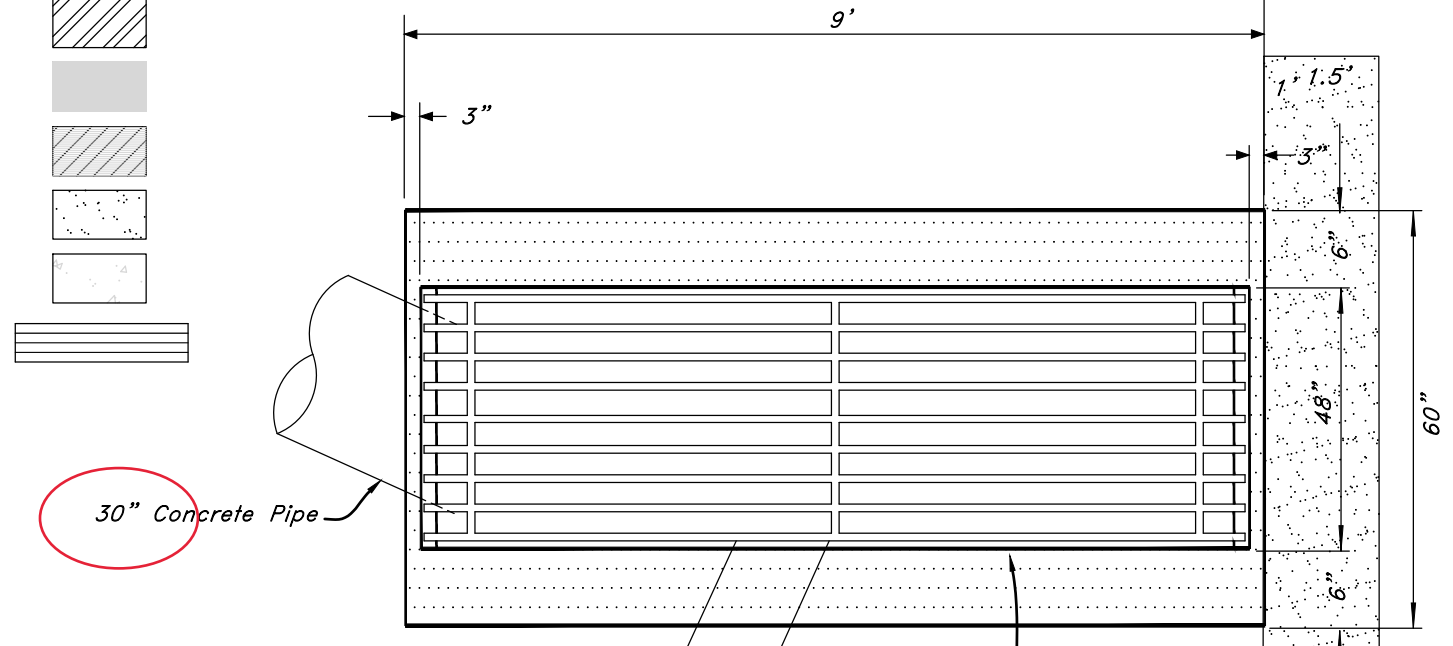


### Plan View Detail of Inlet / Outlet Structure

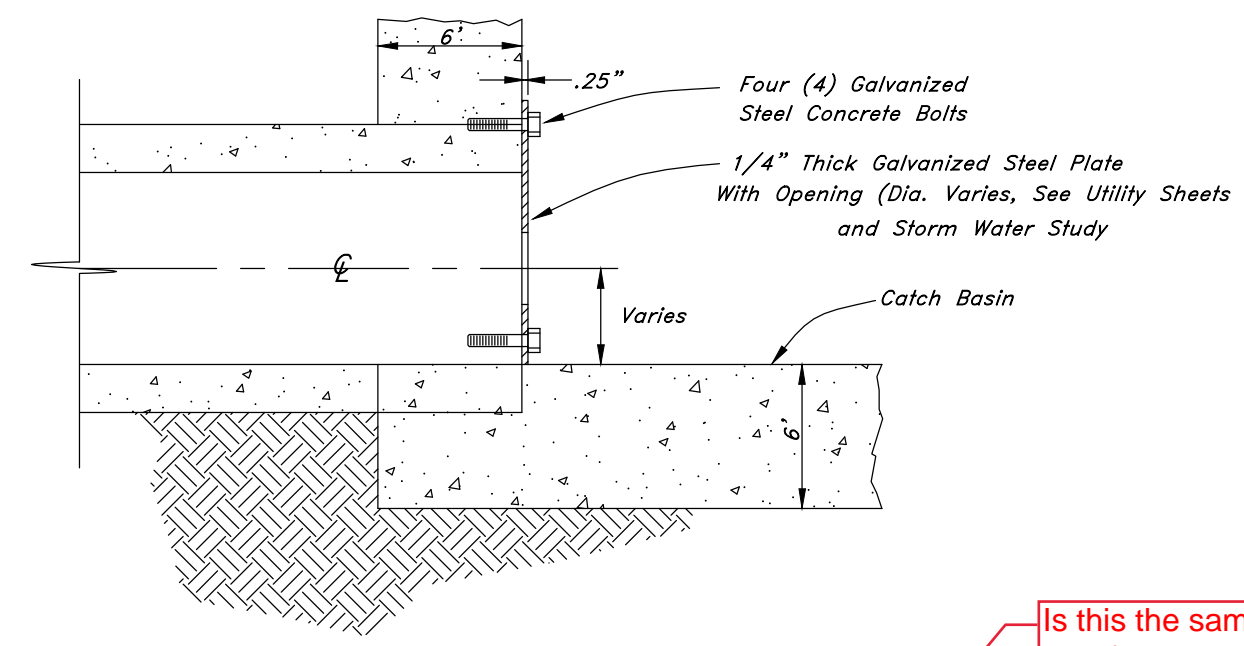


### Orifice Plate Detail

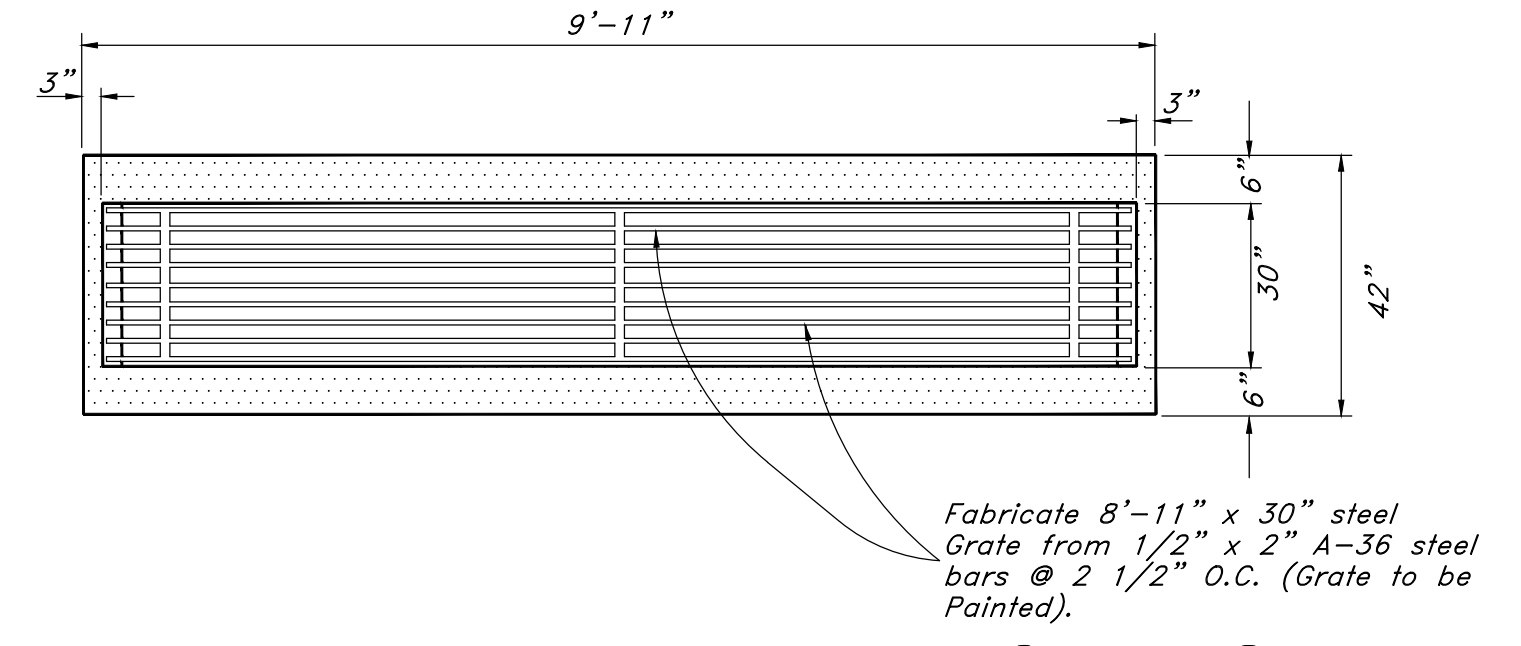


### Plan View Detail of Inlet / Outlet Structure

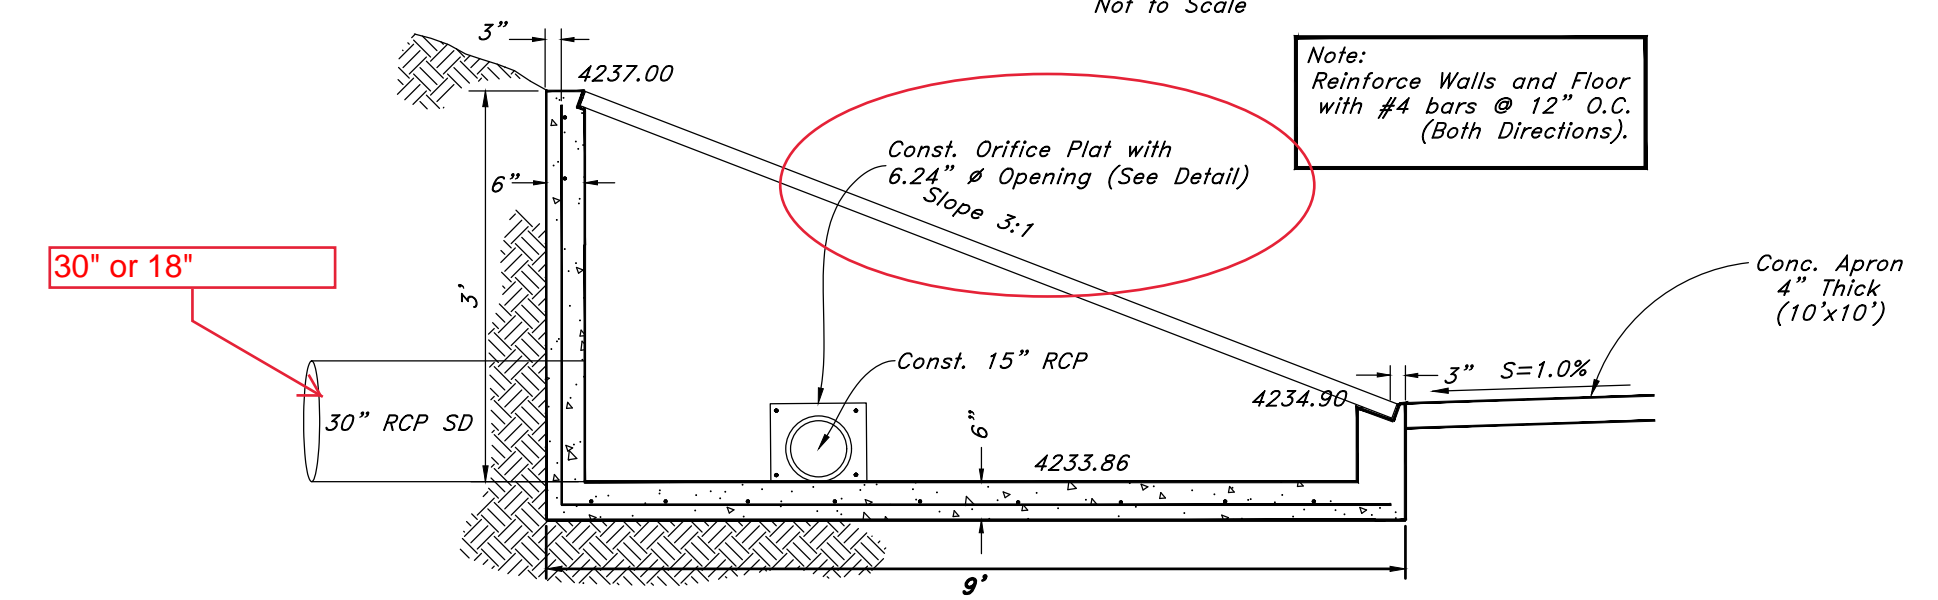

### Profile View Detail of East Inlet / Outlet Structure

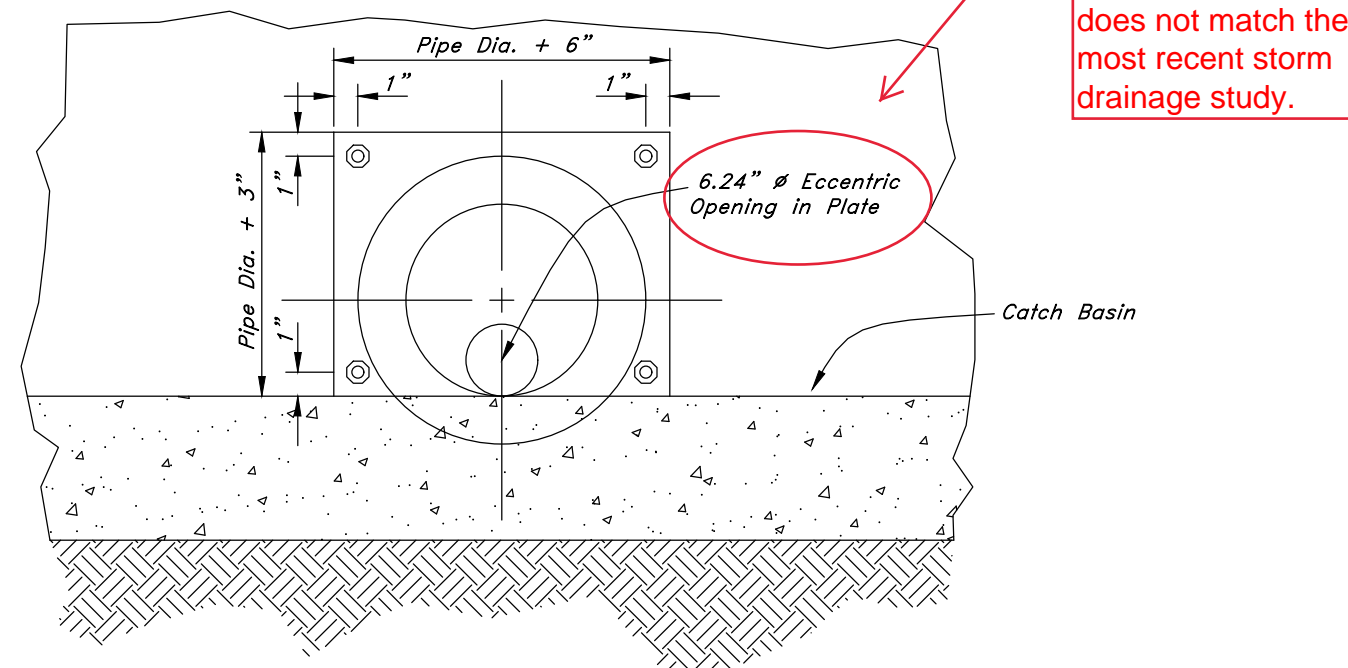

Is this the same size for both ponds? This size does not match the most recent storm drainage study.

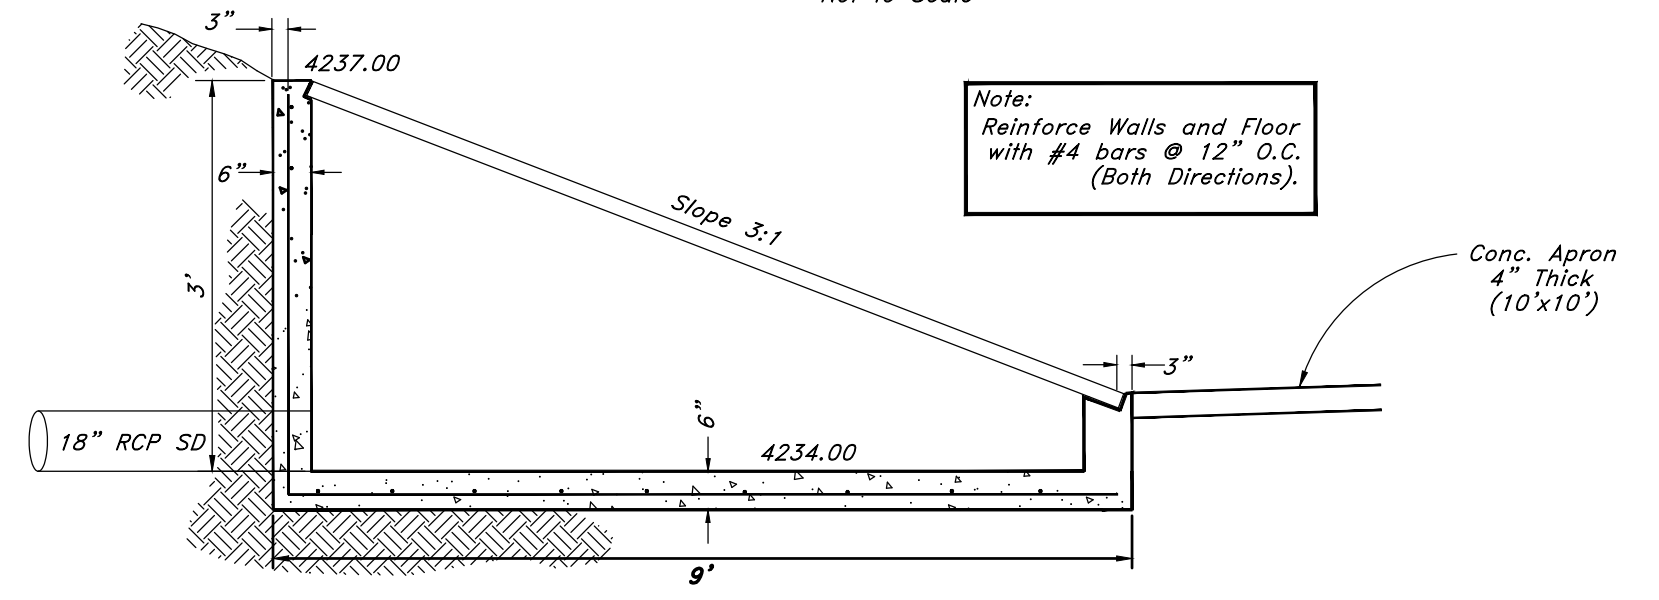

### Profile View Detail of West Inlet / Outlet Structure

# FOR CONSTRUCTION



**Plan & Profile**

**The Barn at Terakee Farms No. 1**

Approx. 900 South 4500 West  
Weber County, Utah


A part of Section 17, T6N, R2W, SLE&M, U.S. Survey

20 July, 2020

SHEET NO. **10** of 11

16N719 - AM

REV	DATE	DESCRIPTION

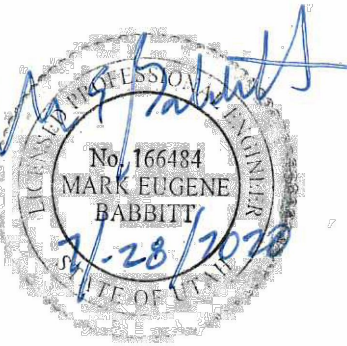

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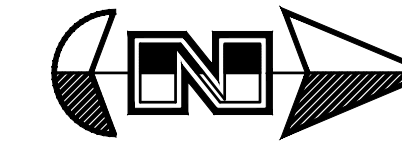
# The Barn at Terakee Farms® No. 1

A PRUD Subdivision


A part of Section 17, T6N, R2W, SLB&M, U.S. Survey

Weber County, Utah

July 2020






Scale: 1" = 60'

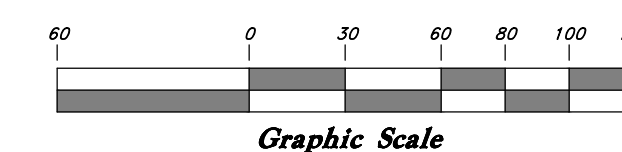

- GENERAL GRADING NOTES:**
- All work shall be in accordance with the County Public Works Standard.
  - Cut slopes shall be no steeper than 2 horizontal to 1 vertical.
  - Fill slopes shall be no steeper than 2 horizontal to 1 vertical.
  - Fills shall be compacted per the recommendations of the geotechnical report prepared for the project and shall be certified by the geotechnical engineer.
  - Areas to receive fill shall be properly prepared and approved by the County inspector and geotechnical Engineer prior to placing fill.
  - Fills shall be benched into competent material as per specifications and geotechnical report.
  - All trench backfills shall be tested and certified by the site geotechnical engineer per the grading code.
  - A geotechnical engineer shall perform periodic inspections and submit a complete report and map upon completion of the rough grading.
  - The final compaction report and certification from the geotechnical engineer shall contain the type of field testing performed. Each test shall be identified with the method of obtaining the in-place density, whether sand cone or drive ring and shall be so noted for each test. Sufficient maximum density determinations shall be performed to verify the accuracy of the maximum density curves used by the field technician.
  - Dust shall be controlled by watering.
  - The location and protection of all utilities is the responsibility of the permittee.
  - Approved protective measures and temporary drainage provisions must be used to protect adjoining properties during the grading project.
  - All public roadways must be cleared daily of all dirt, mud and debris deposited on them as a result of the grading operation. Cleaning is to be done to the satisfaction of the County engineer.
  - The site shall be cleared and grubbed of all vegetation and deleterious matter prior to grading.
  - The contractor shall provide shoring in accordance with OSHA requirements for trench walls.
  - Aggregate base shall be compacted per the geotechnical report prepared for the project.
  - Elevations shown on this plan are finish grades. Rough grades are the subgrades of the improvements shown herein.
  - The recommendations in the following Geotechnical Engineering Report by CMT Engineering Laboratories are included in the requirements of grading and site preparation.
  - The report is titled "GEOTECHNICAL ENGINEERING STUDY"
  - CMT Project No.: 10241 Address: About 4700 West 900 South, West Weber, Weber County, Utah
  - Dated: October 2, 2018
  - As part of the construction documents, owner has provided contractor with a topographic survey performed by manual or aerial means. Such survey was prepared for project design purposes and is provided to the contractor as a courtesy. It is expressly understood that such survey may not accurately reflect existing topographic conditions.
  - Erosion Control: Protect all inlet boxes, catch basins, etc. with straw bales or other approved method to strain the storm water during construction. Protect surrounding properties and streets from site runoff with sandbags and earth berms.

## TURNING SPACE AT SIDEWALK LEVEL

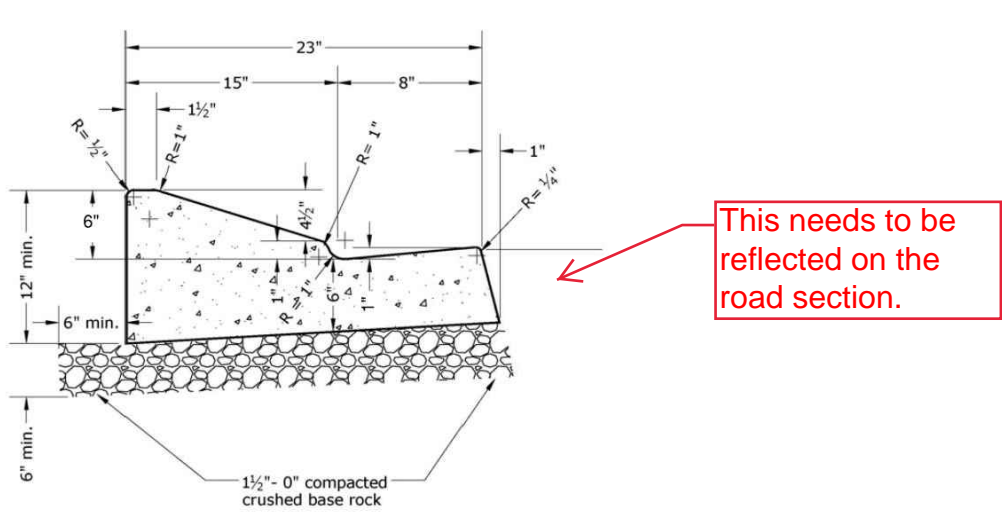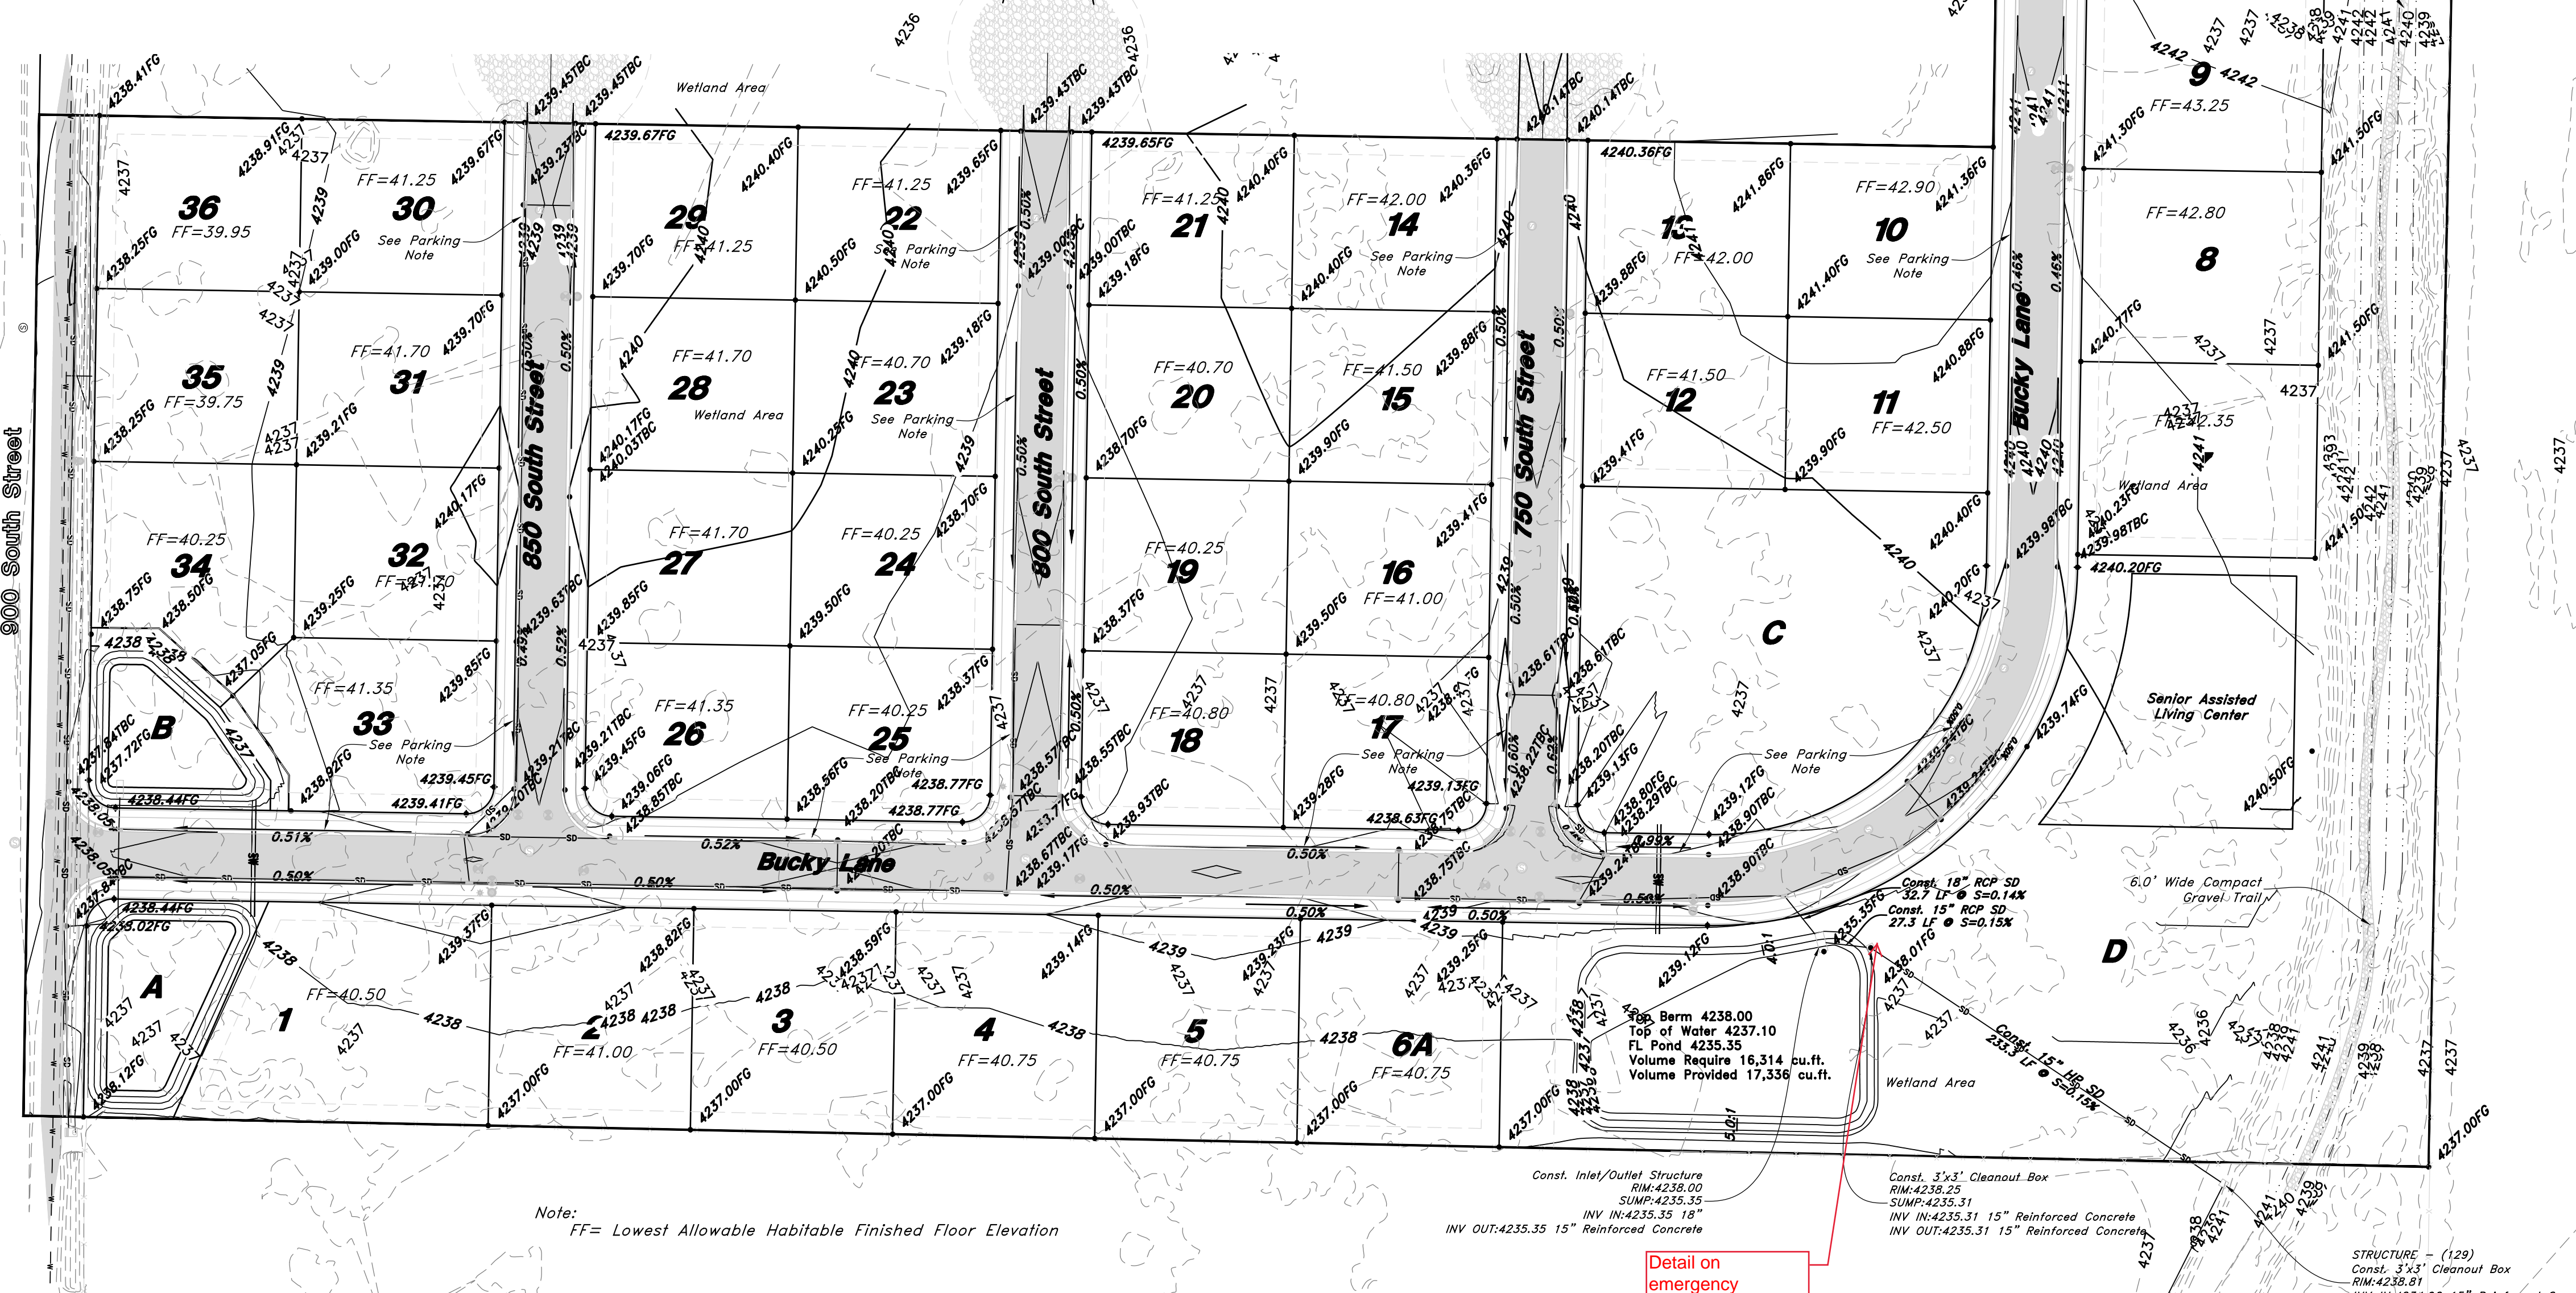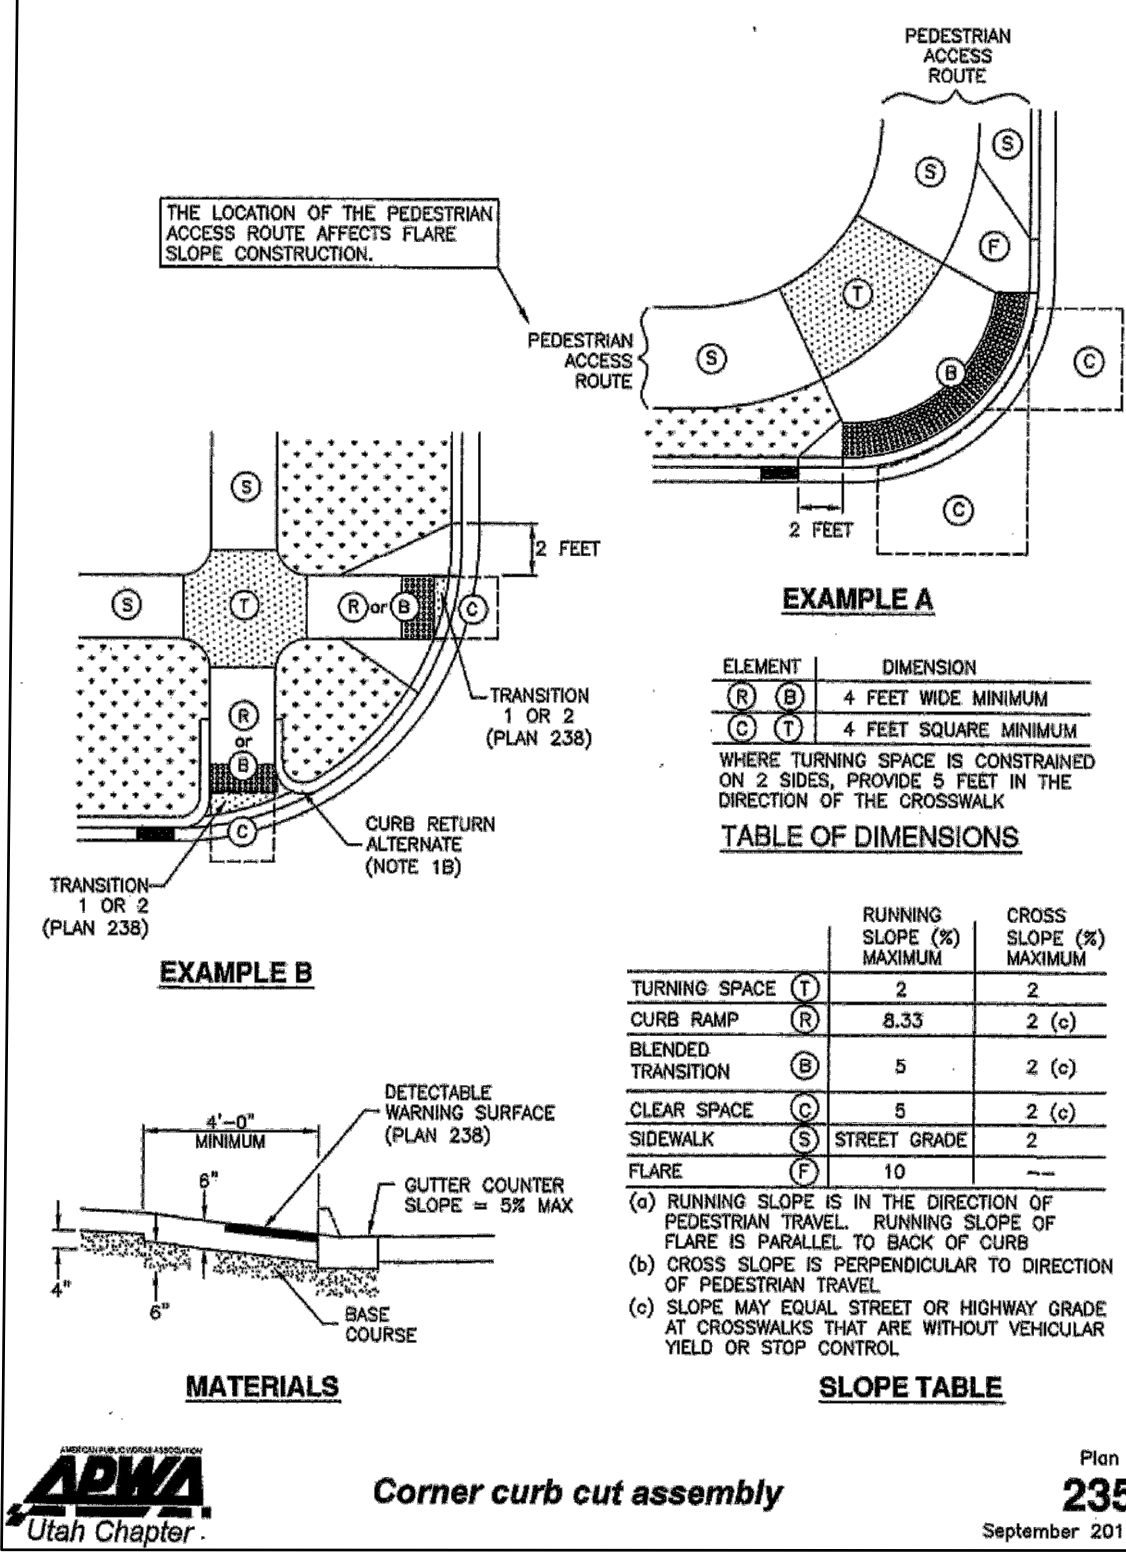

- Notes:**
- Concrete shall attain 4,000 psi compression strength in 28 days.
  - Contractor joints shall be constructed at all points of curvature, and at a maximum interval of 20 feet.
  - This curb design is limited to use within private alley and roadways.

- CURB AND GUTTER CONSTRUCTION NOTES:**
- Open face gutters shall be constructed where drainage is directed away from curb.
  - Open face gutter locations are indicated by shading and notes on site and grading plan.
  - It is the responsibility of the surveyor/contractor to adjust top of curb grades at all points of the time construction staking to ensure proper slope from existing asphalt into curb (1.0% Min 4.0% Max cross slope).
  - Refer to the typical details for a standard and open face curb and gutter for dimensions.
  - Transitions between open face and standard curb and gutter are to be smooth. Hand form these areas if necessary.
- ADA NOTES:**
- Contractor must maintain a running slope on Accessible routes no steeper than 5.0% (1:20). The cross slope for Accessible routes must be no steeper than 2.0% (1:50). All Accessible routes must have a minimum clear width of 36". If grades on plans do not meet this requirement notify Consultants immediately.
- The Client, Contractor, and Subcontractor should immediately notify the Consultant of any conditions of the project that they believe do not comply with the current state of the ADA and/or FHAA.

## Legend

- (Note: All items may not appear on drawing)
- San. Sewer Manhole
  - Water Manhole
  - Storm Drain Manhole
  - Cleanout
  - Electrical Manhole
  - Catch Basins
  - Exist. Fire Hydrant
  - Exist. Water Valve
  - Sanitary Sewer Culinary Water
  - Gas Line
  - Irrigation Line
  - Storm Drain
  - Telephone Line
  - Secondary Waterline
  - Power Line
  - Fire Line
  - Land Drain
  - Power pole
  - Power pole w/guy
  - Light Pole
  - Fence
  - Flowline of ditch
  - Overhead Power line
  - Corrugated Metal Pipe
  - Concrete Pipe
  - Reinforced Concrete Pipe
  - Ductile Iron
  - Polyvinyl Chloride
  - Top of Asphalt
  - Edge of Asphalt
  - Centerline
  - Flowline
  - Finish Floor
  - Top of Curb
  - Top of Wall
  - Top of Walk
  - Top of Concrete
  - Natural Ground
  - Finish Grade
  - Match Existing
  - Fire Department Connection
  - Finish Contour
  - Exist. Contour
  - Exist. Grade
  - Ridge Line
  - Direction of Flow
  - Existing Asphalt
  - New Asphalt
  - Existing Concrete
  - New Concrete
  - CP
  - RCP
  - DI
  - PKC
  - TA
  - EA
  - CL
  - FL
  - TC
  - TWL
  - TW
  - TCN
  - FG
  - NG
  - ME
  - 90-
  - 95.337A
  - 95.721A
  - R
  -

**PARKING NOTE**

Private Roads that are less than 32 feet in width shall be posted with "NO PARKING FIRE LANE" on the West and South sides. (Roadways and signage shall comply with appendix D of the 2015 International Fire Code as adopted by Weber Fire District).

**BENCHMARK**

Brass Cap Section Monument located in the South Quarter Corner of Section 17, T6N, R2W, SLB&M, U.S. Survey 4" below surface grade with an elevation of 4238.10.

**CAUTION NOTICE TO CONTRACTOR**

The contractor is specifically cautioned that the location and/or elevation of existing utilities as shown on these plans are based on records of the various utility companies and, where possible, measurements taken in the field. The information is not to be relied on as being exact or complete. The contractor must call the appropriate utility company at least 48 hours before any excavation to request exact field location of utilities. It shall be the responsibility of the contractor to relocate all existing utilities which conflict with the proposed improvements shown on the plans.

**PRIVATE ENGINEER'S NOTICE TO CONTRACTORS**

The Contractor agrees that he shall assume sole and complete responsibility for job site conditions during the course of construction of this project, including safety of all persons and property; that this requirement shall apply continuously and not be limited to normal working hours; and that the contractor shall defend, indemnify, and hold the owner and the engineer harmless from any and all liability, real or alleged, in connection with the performance of work on this project, excepting for liability arising from the sole negligence of the owner or the engineer.






# FOR CONSTRUCTION

16N719 TERAKEE VILLAGE\DWG16N719 - AP.dwg, 2/16/2021 9:53:51 AM, drew, 1:1  
 DESCRIPTION  
 REV  
 DATE  
 No. 166184  
 MARK EUGENE  
 BABBITT  
 7-28-2020  
**GREAT BASIN ENGINEERING**  
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 801-392-4155 FAX 801-392-7544  
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**GREAT BASIN ENGINEERING**  
 20 July, 2020  
 SHEET NO. **11** of 11  
 16N719 - AM

# The Barn at Terakee Farms® No. 1


A PRUD Subdivision  
 A part of Section 17, T6N, R2W, SLB&M, U.S. Survey  
 Weber County, Utah  
 July 2020

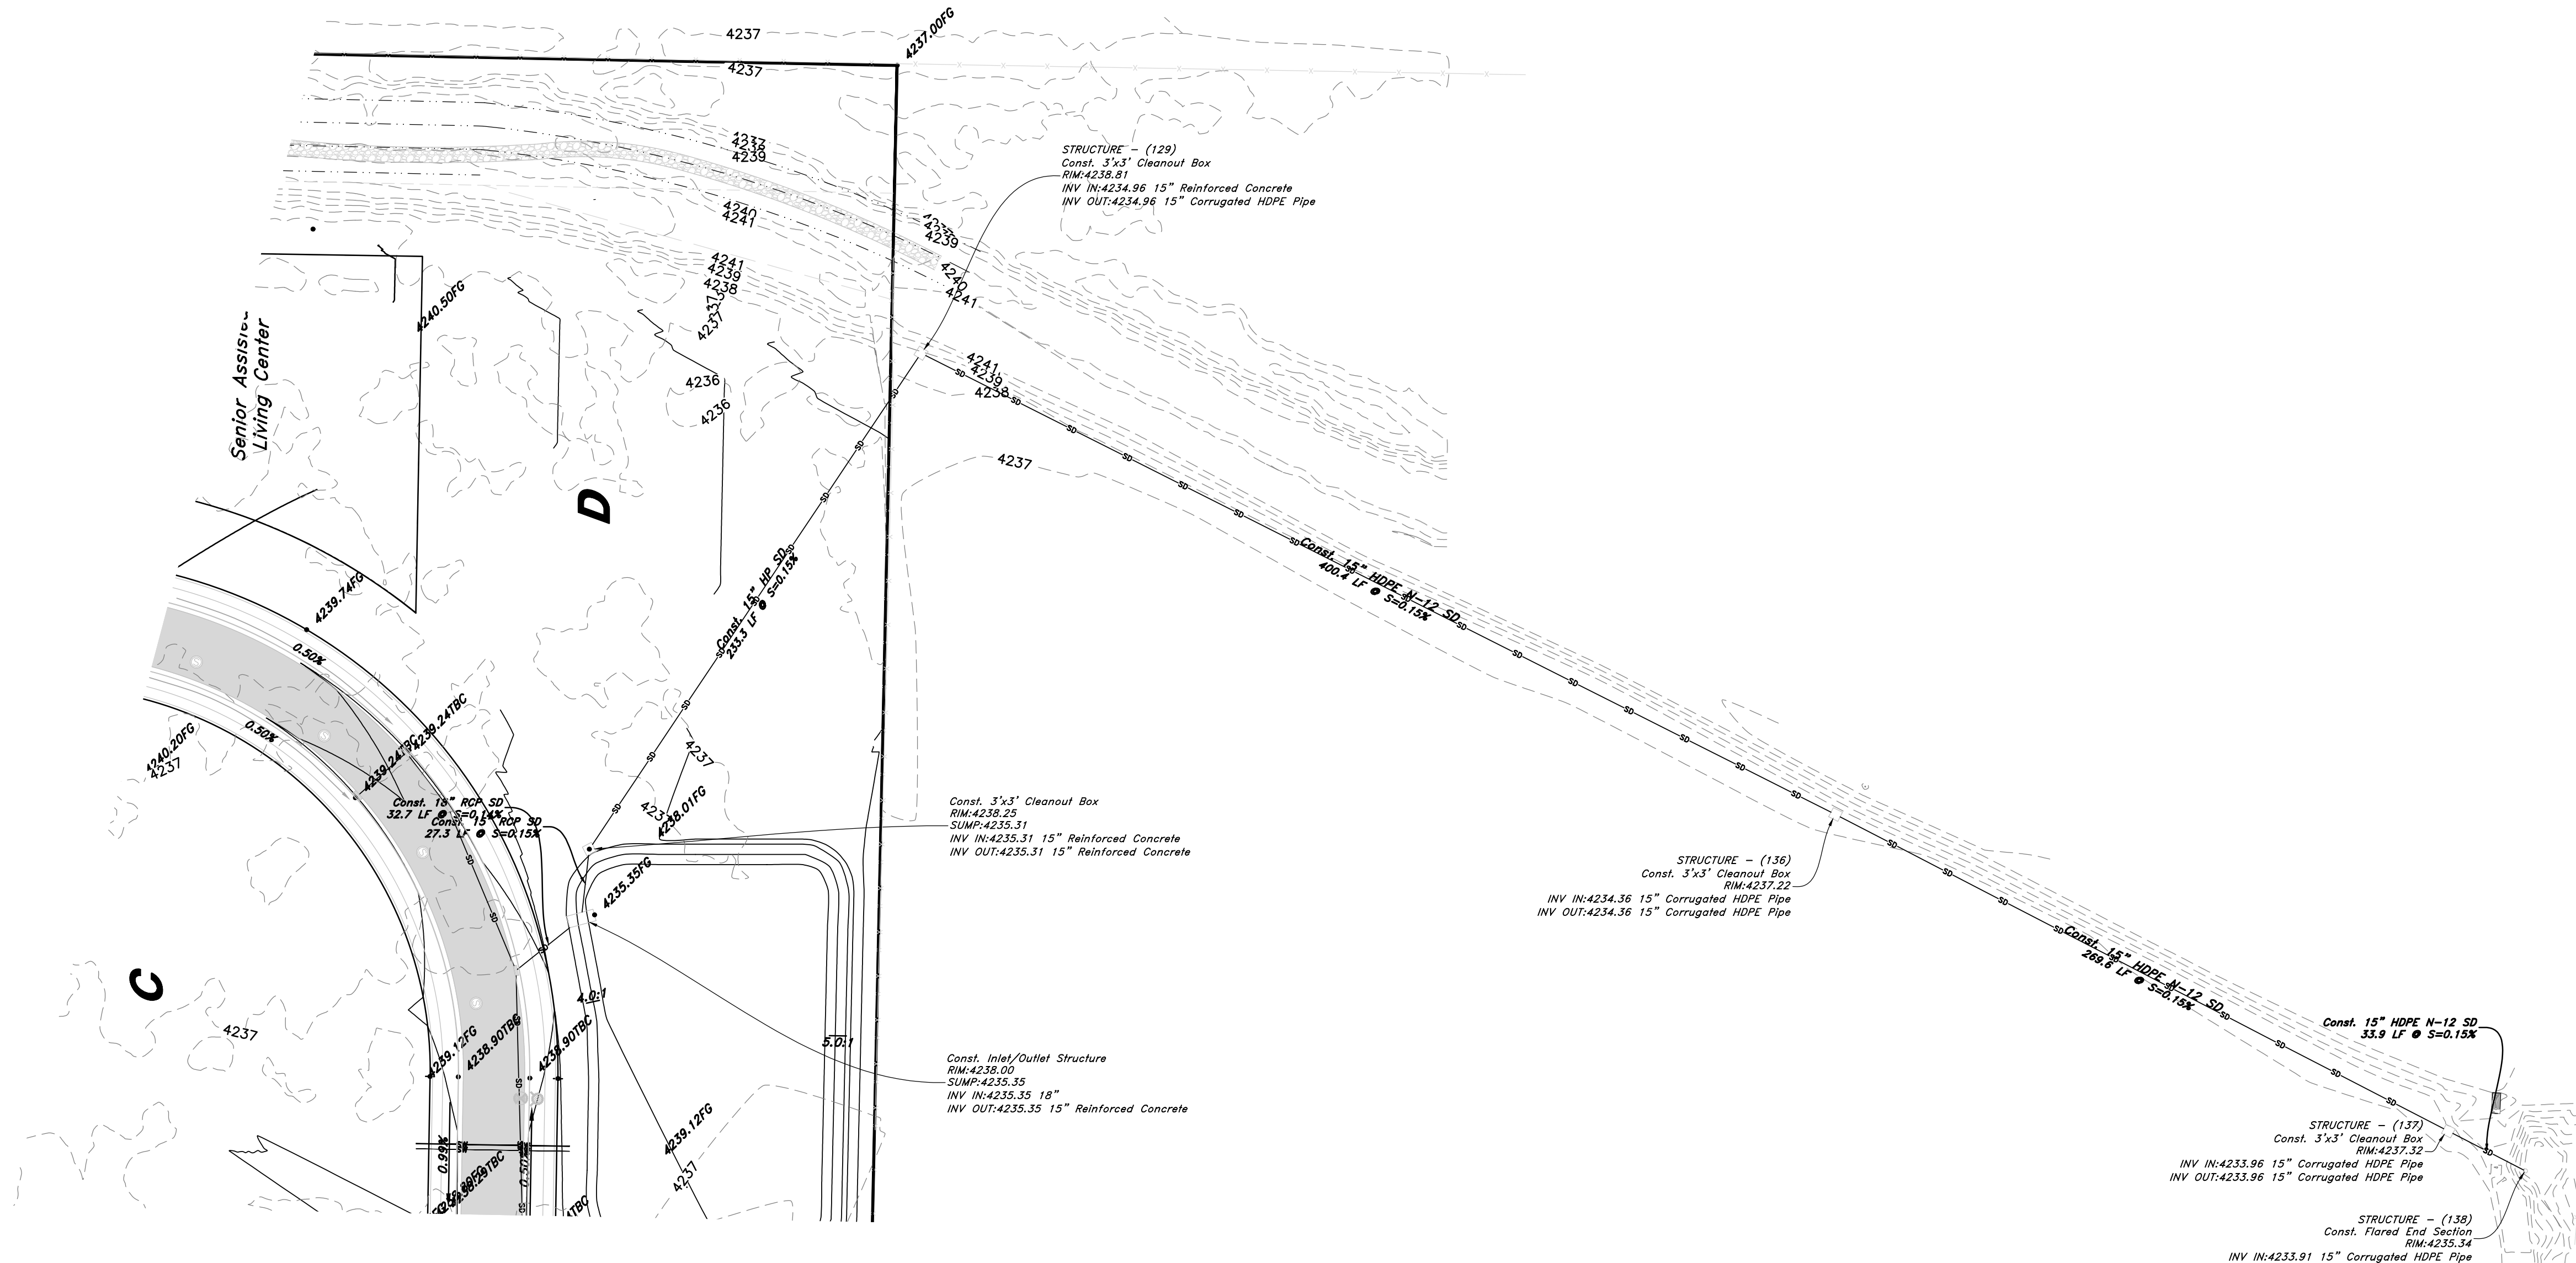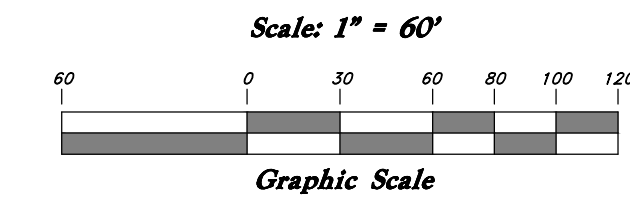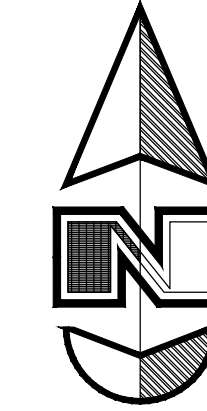

## Legend

(Note: All items may not appear on drawing)

San. Sewer Manhole	Concrete Pipe	CP
Water Manhole	Reinforced Concrete Pipe	RCP
Storm Drain Manhole	Ductile Iron	DI
Cleanout	Polyvinyl Chloride	PVC
Electrical Manhole	Top of Asphalt	TA
Catch Basins	Edge of Asphalt	EA
Exist. Fire Hydrant	Centerline	CL
Exist. Water Valve	Flowline	FL
Water Valve	Finish Floor	FF
Sanitary Sewer	Top of Curb	TC
Culinary Water	Top of Wall	TW
Gas Line	Top of Walk	TW
Irrigation Line	Top of Concrete	TCW
Storm Drain	Natural Ground	NG
Telephone Line	Finish Grade	FG
Secondary Waterline	Match Existing	ME
Power Line	Fire Department Connection	FDC
Fire Line	Finish Contour	-90-
Land Drain	Exist. Contour	-90-
Power pole	Finish Grade	95.33TA
Power pole w/guy	Exist. Grade	95.72TA
Light Pole	Ridge Line	R
Fence	Direction of Flow	->
Flowline of ditch	Existing Asphalt	[Hatched Box]
Overhead Power line	New Asphalt	[Diagonal Hatched Box]
Corrugated Metal Pipe	Existing Concrete	[Dotted Box]
	New Concrete	[Cross-hatched Box]

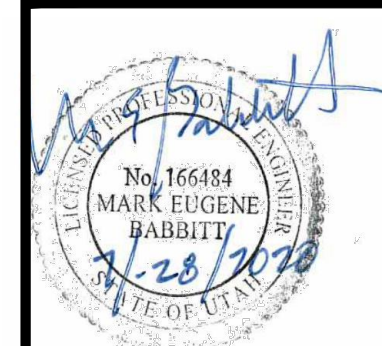

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 MAIN (801) 399-4515 S.L.C. (801) 521-0222 FAX (801) 399-2754  
 WWW.GREATBASINENGINEERING.COM

**Grading & Drainage Plan**  
**The Barn at Terakee Farms No. 1**  
 Approx. 900 South, 4500 West  
 Weber County, Utah  
 A part of Section 17, T6N, R2W, SLB&M, U.S. Survey



20 July, 2020  
 SHEET NO. **11A** of 11  
 16N719 - AM

**FOR CONSTRUCTION**