## TAYLOR LANDING PHASE 1

A CLUSTER SUBDIVISION

PART OF THE NORTH HALF OF SECTION 28, TOWNSHIP 6 NORTH,
RANGE 2 WEST,
SALT LAKE BASELINE AND MERIDIAN
WEBER COUNTY, TAYLOR, UTAH

INDEX SHEET

Sunset EQ

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Wite and the Concrete, Inc.

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Google Earth

- PROJECT

VICINITY MAP

OWNER/DEVELOPER SIERRA HOMES

CIVIL ENGINEER
ALLIANCE CONSULTING
ENGINEERS, INC.
150 EAST 200 NORTH SUITE P
LOGAN, UTAH 84321
435-755-5121

	SHEET INDEX
SHEET NO.	SHEET DESCRIPTION
1	INDEX SHEET
2	3940 WEST ROAD PLAN
3	1470 WEST/2130 SOUTH CONSTRUCTION
4	IRRIGATION RE-ROUTE PLAN
5	GRADING/DRAINAGE PLAN

1. ALL CONSTRUCTION AND MATERIALS SHALL BE IN ACCORDANCE WITH THE PROJECT SPECIFICATIONS, WEBER COUNTY STANDARDS, STATE OF UTAH AND ANY OTHER APPLICABLE STANDARDS ISSUED BY THE CONTROLLING AGENCY.

2. CONTRACTOR SHALL FIELD VERIFY ALL DIMENSIONS BEFORE CONSTRUCTION. ANY DISCREPANCIES BETWEEN CONSTRUCTION DOCUMENTS AND FIELD CONDITIONS SHALL IMMEDIATELY BE BROUGHT TO THE ATTENTION OF THE OWNER. ANY WORK COMPLETED WITHOUT DOING SUCH IS DONE SO AT THE CONTRACTORS EXPENSE.

3. CONTRACTOR SHALL REPAIR AND/OR REPLACE ANY AREAS AND/OR MATERIALS DAMAGED DURING CONSTRUCTION.

4. CONTRACTOR SHALL MAINTAIN ALL ADJACENT PROPERTY (PUBLIC & PRIVATE) FROM ALL CONSTRUCTION DEBRIS.

5. CONTRACTOR SHALL PROVIDE SMOOTH TRANSITION FROM ALL NEW CONSTRUCTION TO EXISTING CONDITIONS.

6. CONTRACTOR SHALL PROVIDE ALL NECESSARY AUTOMOBILE AND PEDESTRIAN TRAFFIC CONTROL DEVICES REQUIRED BY LOCAL, STATE, AND FEDERAL CODES AND ORDINANCES.

7. CONTRACTOR SHALL REPLACE SURVEY MONUMENTS DAMAGED DURING CONSTRUCTION.
SURVEY MONUMENTS TO BE REPLACED BY A REGISTERED, LICENSED LAND SURVEYOR.

8. CONTRACTOR TO LOCATE ALL EXISTING UTILITIES, INCLUDING FIBER OPTIC. ANY DAMAGES TO EXISTING UTILITIES WILL BE REPAIRED AT CONTRACTORS EXPENSE.

9. DIMENSIONS SHOWN ARE TO THE CENTER OF THE PIPELINE UNLESS OTHERWISE NOTED

10. DISTANCES SHOWN ALONG PIPELINES ARE HORIZONTAL DISTANCES AND NOT ACTUAL PIPE LENGTHS. MORE PIPE MAY BE REQUIRED TO COMPLETE CONSTRUCTION THAN IS DIMENSIONED IN THE PLANS.

11. CONTRACTOR IS REQUIRED TO HAVE A SET OF PLANS ON THE SITE AT ALL TIMES. ANY WORK COMPLETED WITHOUT A SET PRESENT IS DONE SO AT THE CONTRACTORS RISK AND EXPENSE IF ERRORS OCCUR.

12. CONTRACTOR IS RESPONSIBLE FOR PROVIDING WATER NECESSARY FOR DUST ABATEMENT, COMPACTION, ETC.

13. THE CONTRACTOR SHALL BE RESPONSIBLE FOR SECURING SOURCES FOR GRANULAR MATERIALS, WATER, WASTE SITES, AND ANY OTHER MATERIALS SOURCES AS REQUIRED FOR PROJECT COMPLETION.

14. ANY WORK DONE WITHIN A PUBLIC RIGHT-OF-WAY SHALL BE COORDINATED WITH THE APPROPRIATE TRANSPORTATION AGENCY AND SHALL MEET THE REQUIREMENTS OF THAT AGENCY AND THE REQUIREMENTS OF ANY RIGHT-OF-WAY OR SPECIAL USE

15. THE CONTRACTOR SHALL COORDINATE ALL LIVE TAPS AND ANY OTHER WORK OR MANIPULATION OF THE EXISTING WATER SYSTEM WITH THE COUNTY.

16. ON SLOPING AREAS THE CONTRACTOR SHALL TAKE PRECAUTIONS TO MITIGATE ANY POSSIBLE EROSION PROBLEMS IN THE TRENCHES DUE TO STORM WATER THAT MIGHT OCCUR DURING OR AFTER CONSTRUCTION AS DIRECTED OR APPROVED BY ENGINEER.

17. THE CONTRACTOR SHALL INSTALL AND MAINTAIN ALL EROSION CONTROL MEASURES AS DETAILED IN THE PROJECT PLANS UNTIL FINAL ACCEPTANCE OF THIS PROJECT.

18. THE CONTRACTOR IS REQUIRED TO TAKE ALL PRECAUTIONS NECESSARY TO INSURE THAT NO STORM WATER/SEDIMENT AND/OR CONSTRUCTION DEBRIS ARE RELEASED FROM THE SITE. ANY RELEASES SHALL BE CLEANED AND MITIGATED AT THE CONTRACTOR'S

19. CONTRACTOR SHALL COORDINATE ALL CONSTRUCTION ACCESS AND RELATED TRAFFIC CONTROL WITH THE COUNTY, CITY, AND STATE ROADWAY DEPARTMENTS. THE ENGINEER SHALL REVIEW ALL TRAFFIC CONTROL PLANS.

20. CONTRACTOR SHALL PROVIDE ALL NECESSARY FITTINGS, HARDWARE, LABOR, ETC. TO CONSTRUCT VERTICAL AND HORIZONTAL BENDS IN PIPE AS NEEDED TO MEET THE REQUIRED GRADES, ALIGNMENTS AND COVER REQUIREMENTS.

21. ALL AIR RELEASE VALVES SHALL BE INSTALLED AT THE CREST OF THE VERTICAL CURVATURE OF THE WATER LINE. CONTRACTOR SHALL RECORD ACTUAL LOCATION OF VALVES ON FIELD RECORD DRAWINGS.

22. THE CONTRACTOR SHALL COORDINATE WITH WEBER COUNTY FOR ALL UTILITY INSPECTIONS PRIOR TO BACKFILLING.

23. ALL WATER SYSTEM COMPONENTS SHALL BE INSTALLED, PRESSURE TESTED, AND CHLORINATED PRIOR TO COMPLETING ANY ROADWAY CONSTRUCTION.


CITY ENGINEER'S CERTIFICATE OF APPROVAL

I hereby approve the above plat having reviewed it for conformity with standard engineering practice and Logan City's Subdivision Ordinance


Weber County Engineer

*FOR REVIEW* 8-3-2020

ANCE CONSULTING ENGINEERS 150 EAST 200 NORTH SUITE P LOGAN, UTAH 84321 (435)755-5121

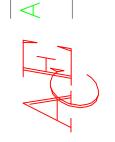


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IRUCTION DOCUMENTS THAT ARE DISTRIBUTED FOR IG PURPOSES SHALL NOT BE RETURNED AND SHALL ESTROYED WITHIN 30 DAYS AFTER THE BID OPENING IE PLAN HOLDER.

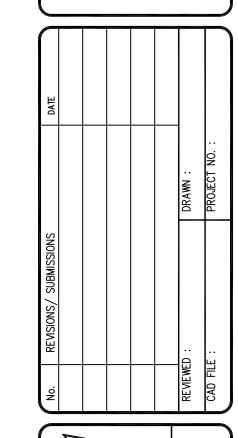



OR LANDING PHASE
A CLUSTER SUBDIVISION


DATE: JULY,2020
DRAWING No.

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## TAYLOR LANDING PHASE
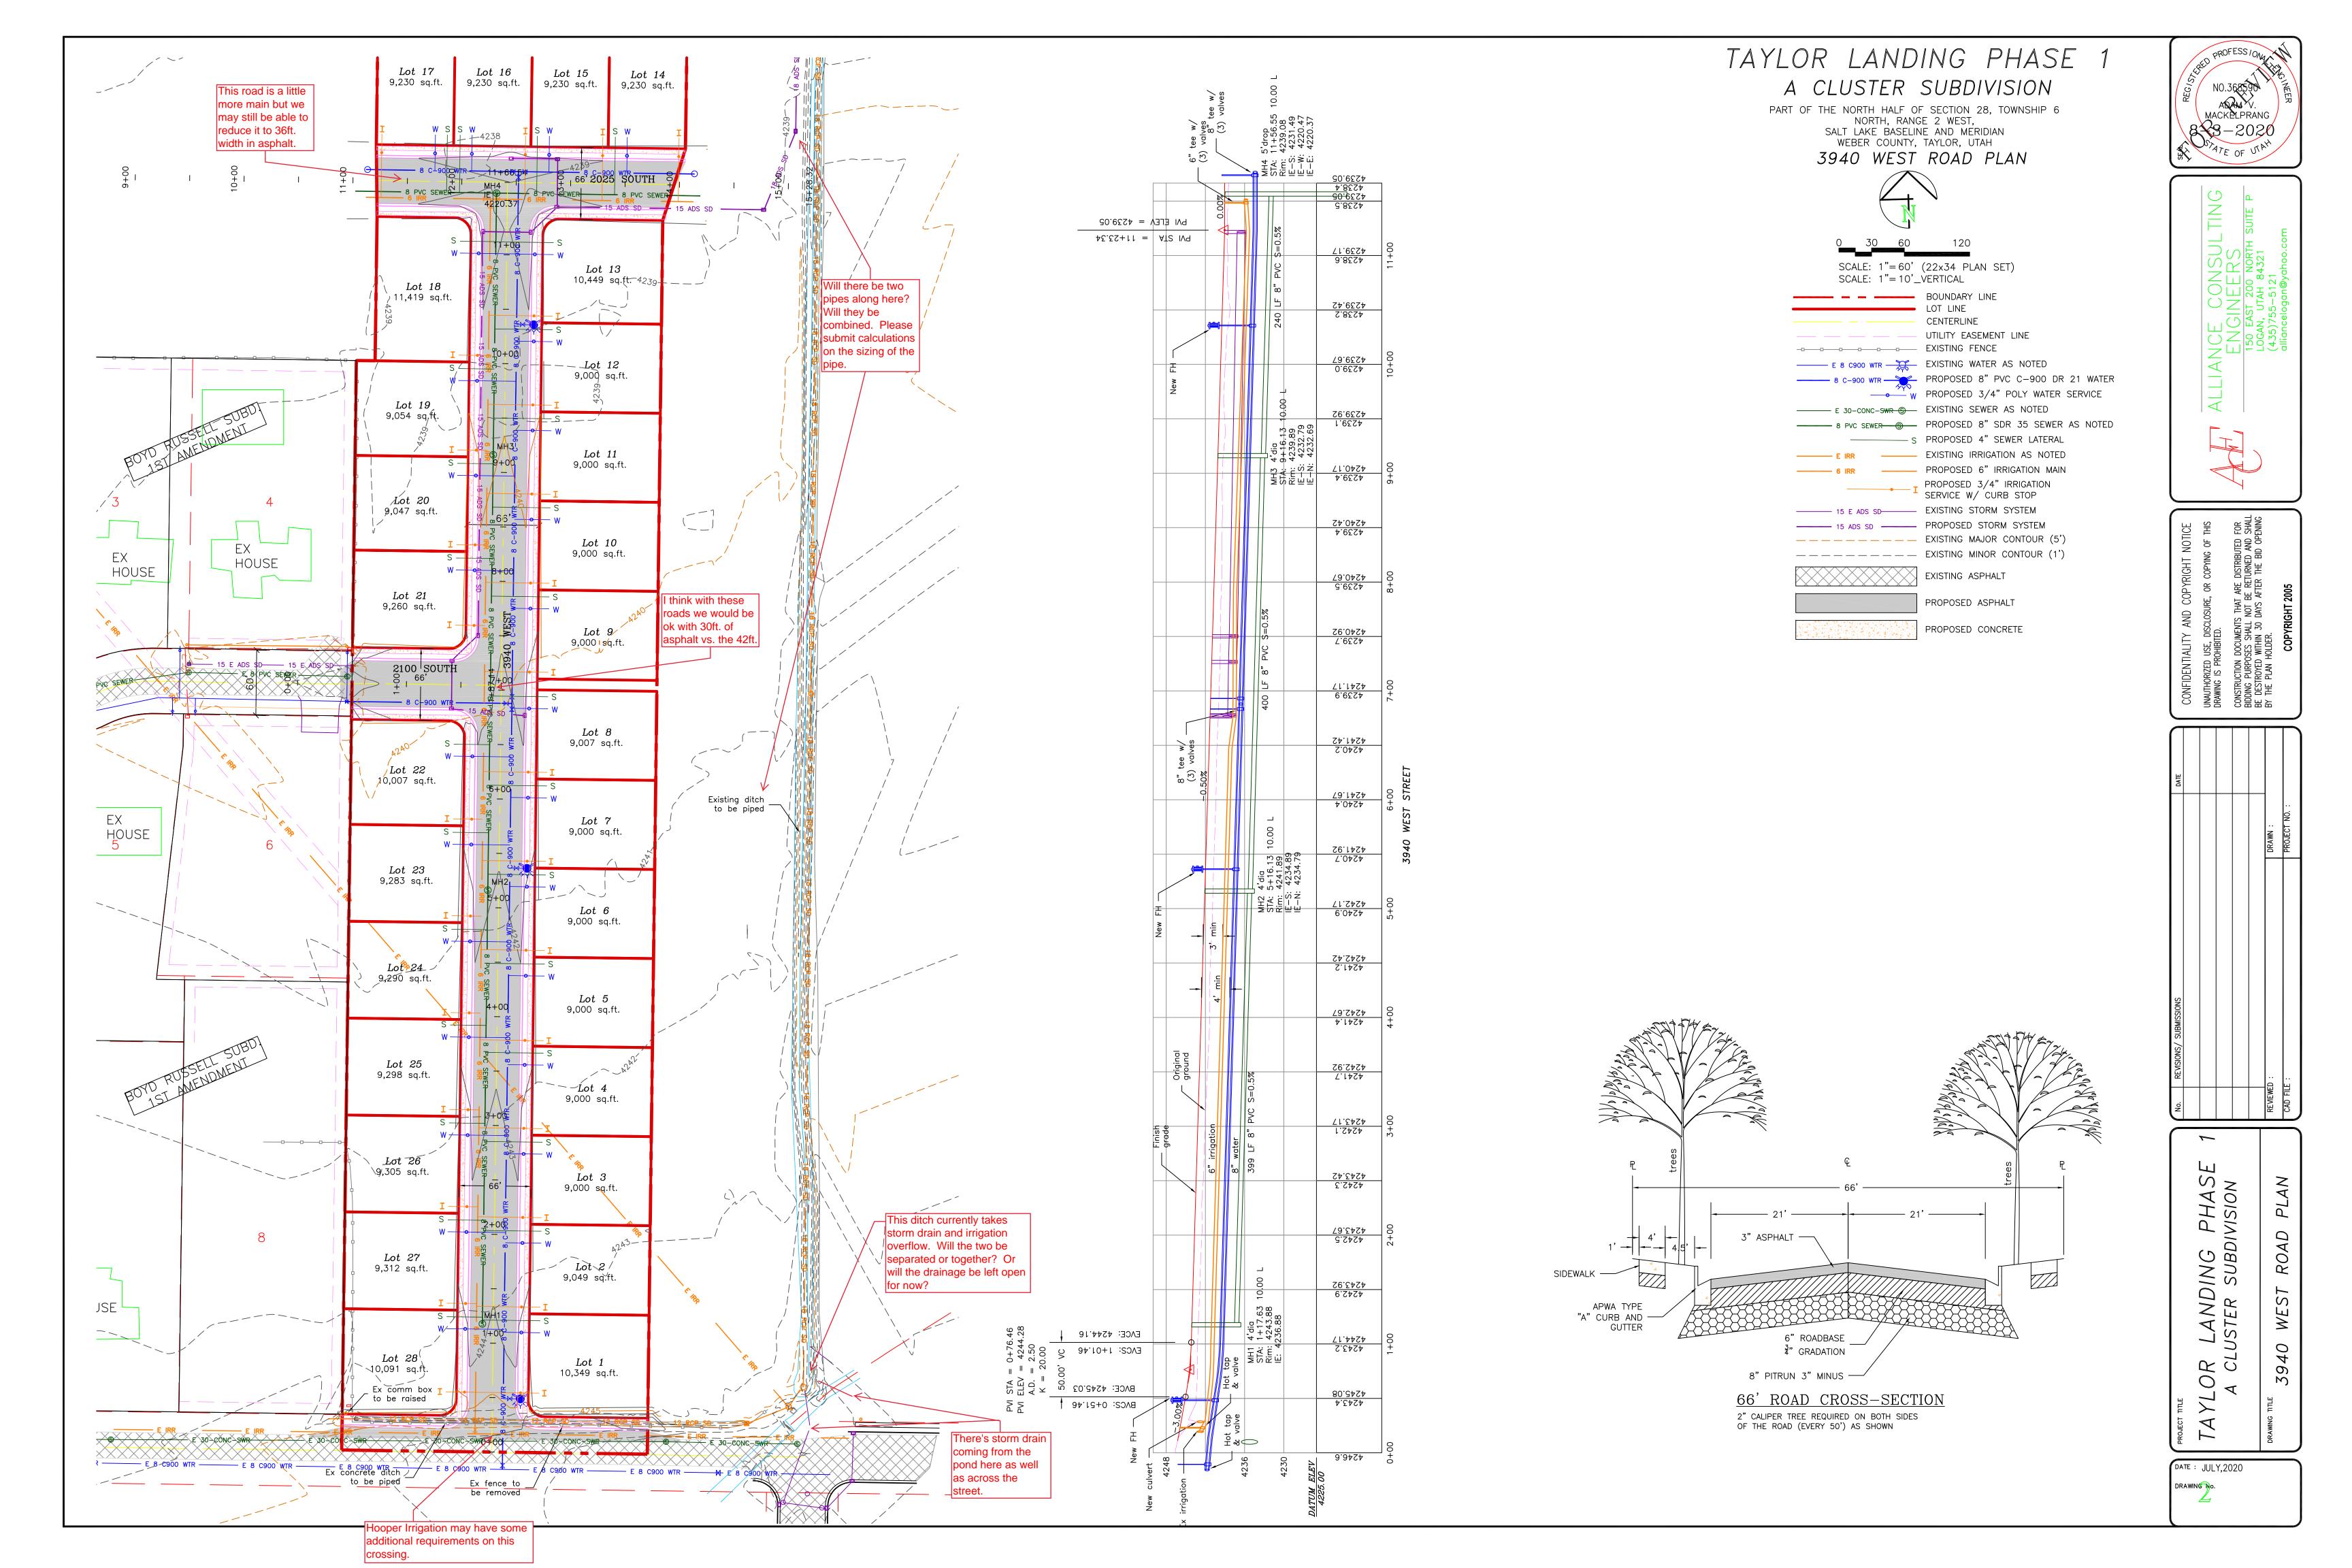
## A CLUSTER SUBDIVISION

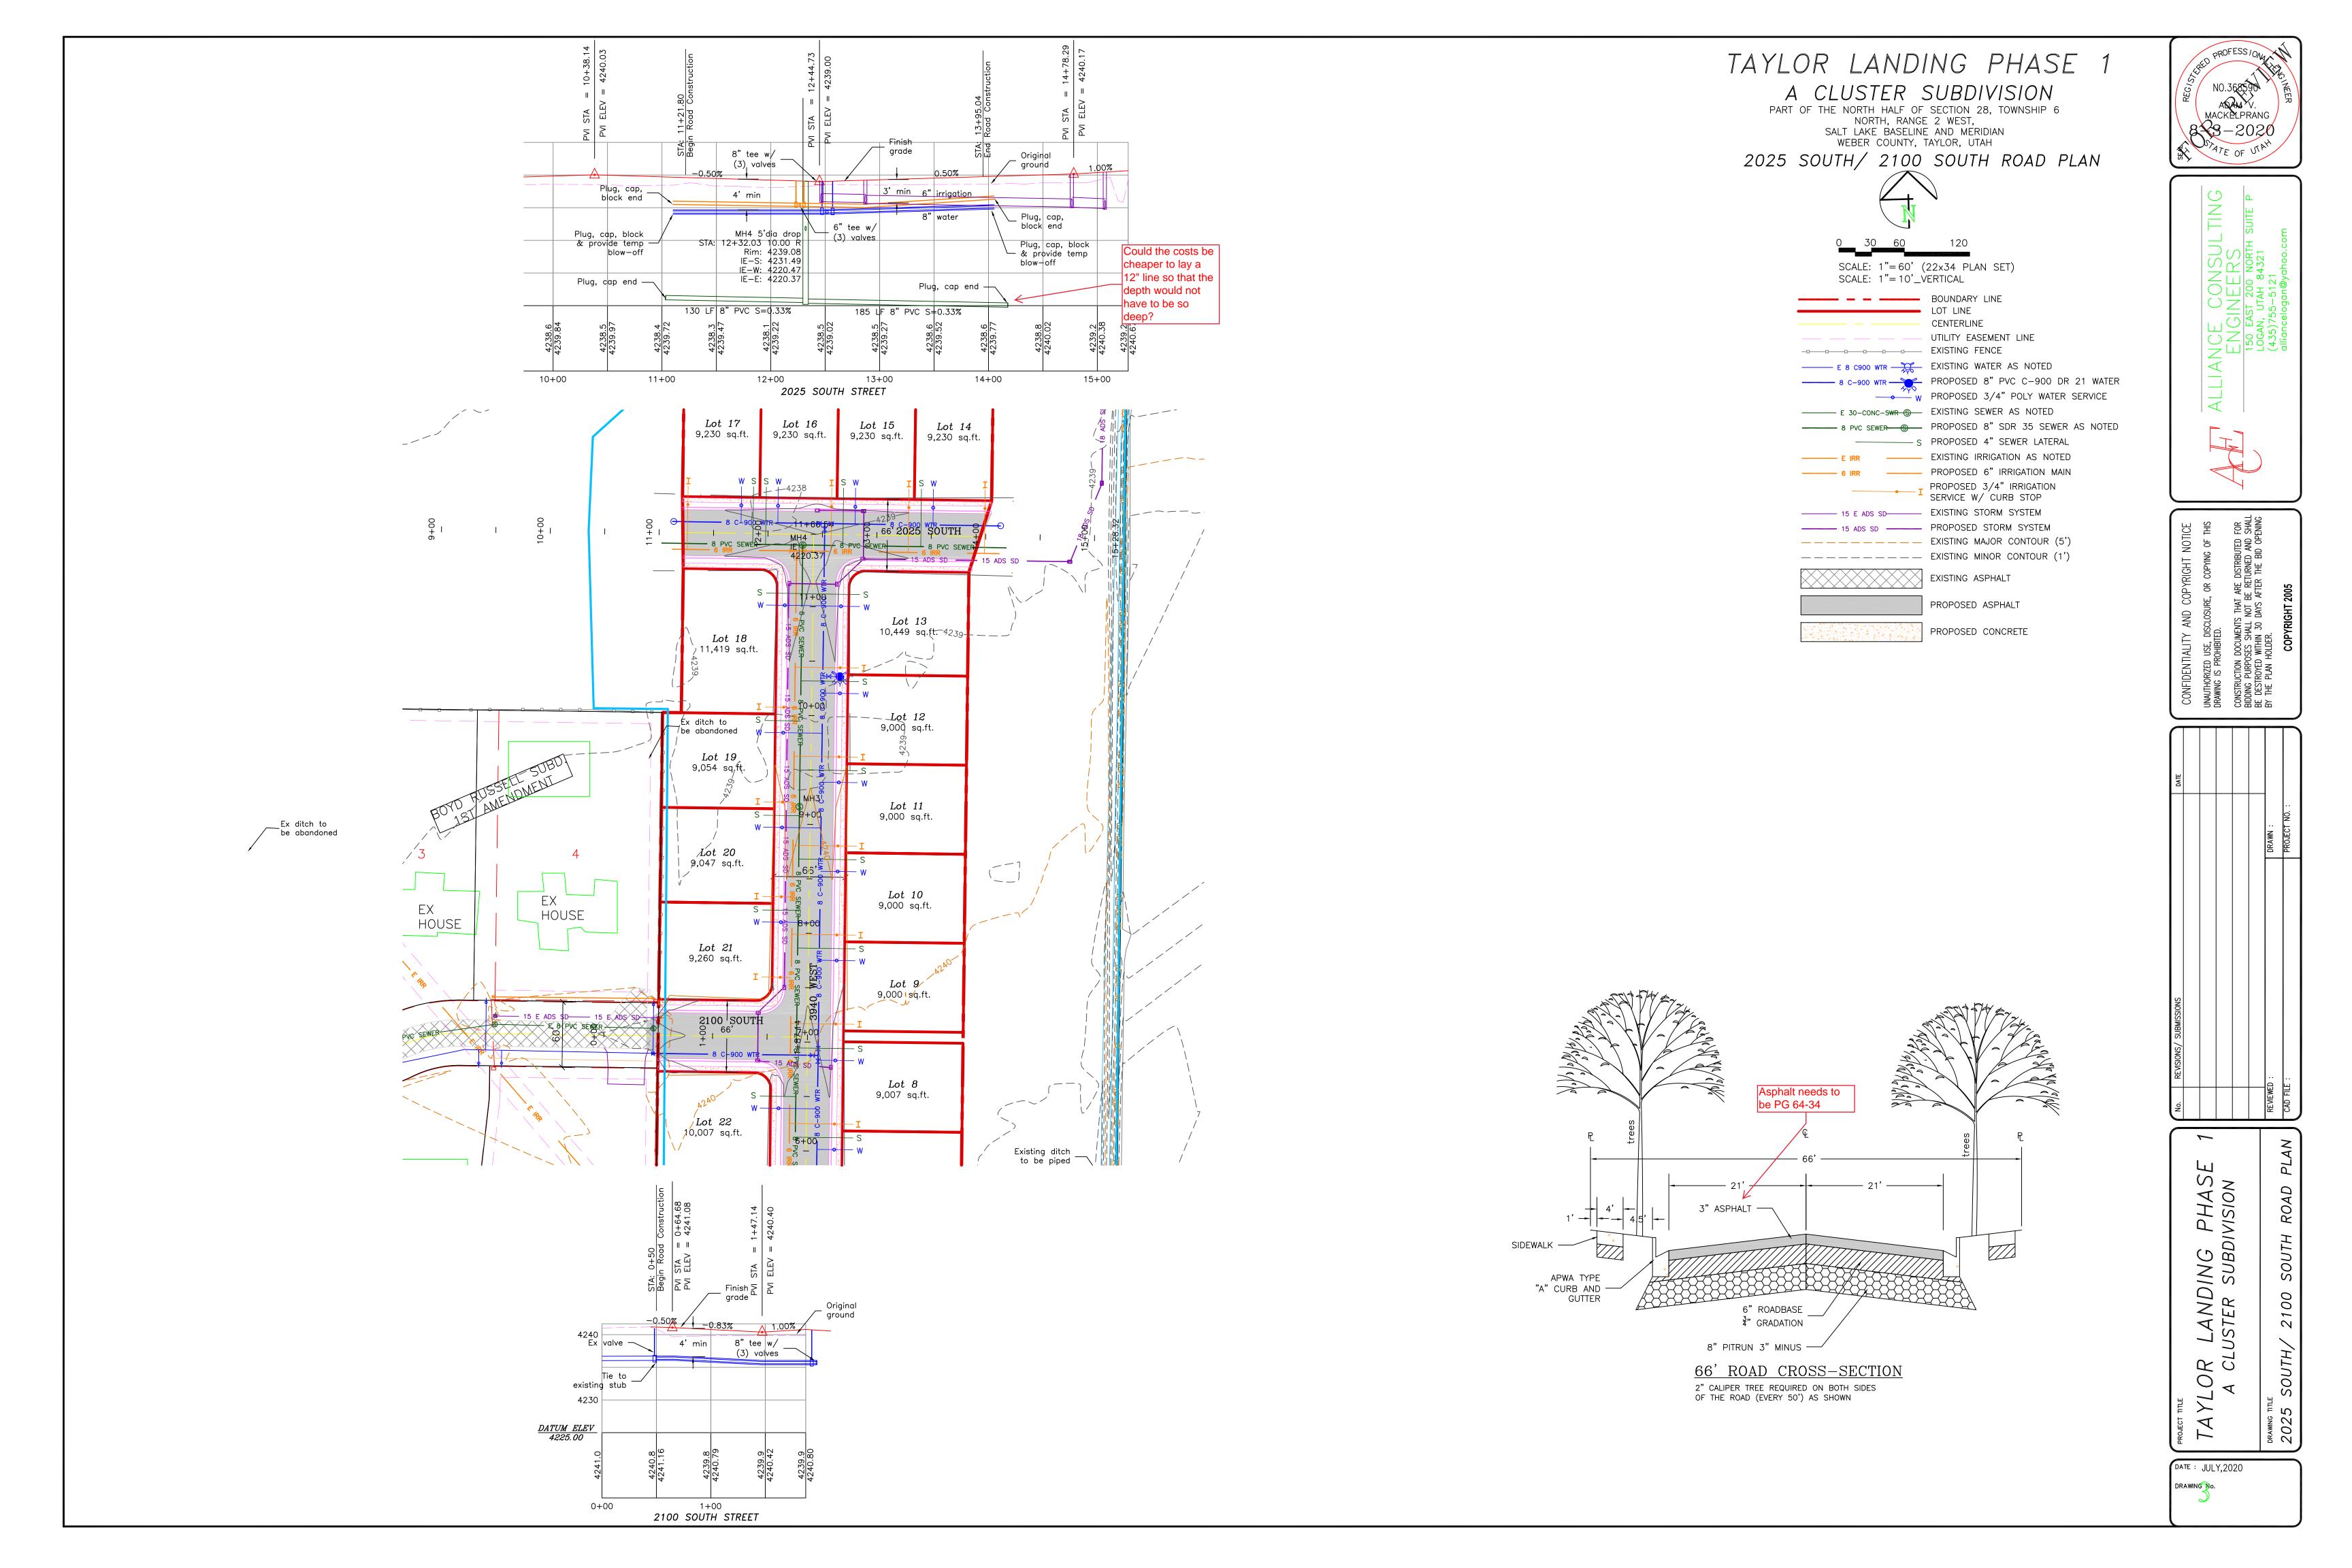PART OF THE NORTH HALF OF SECTION 28, TOWNSHIP 6 NORTH, RANGE 2 WEST, SALT LAKE BASELINE AND MERIDIAN WEBER COUNTY, TAYLOR, UTAH

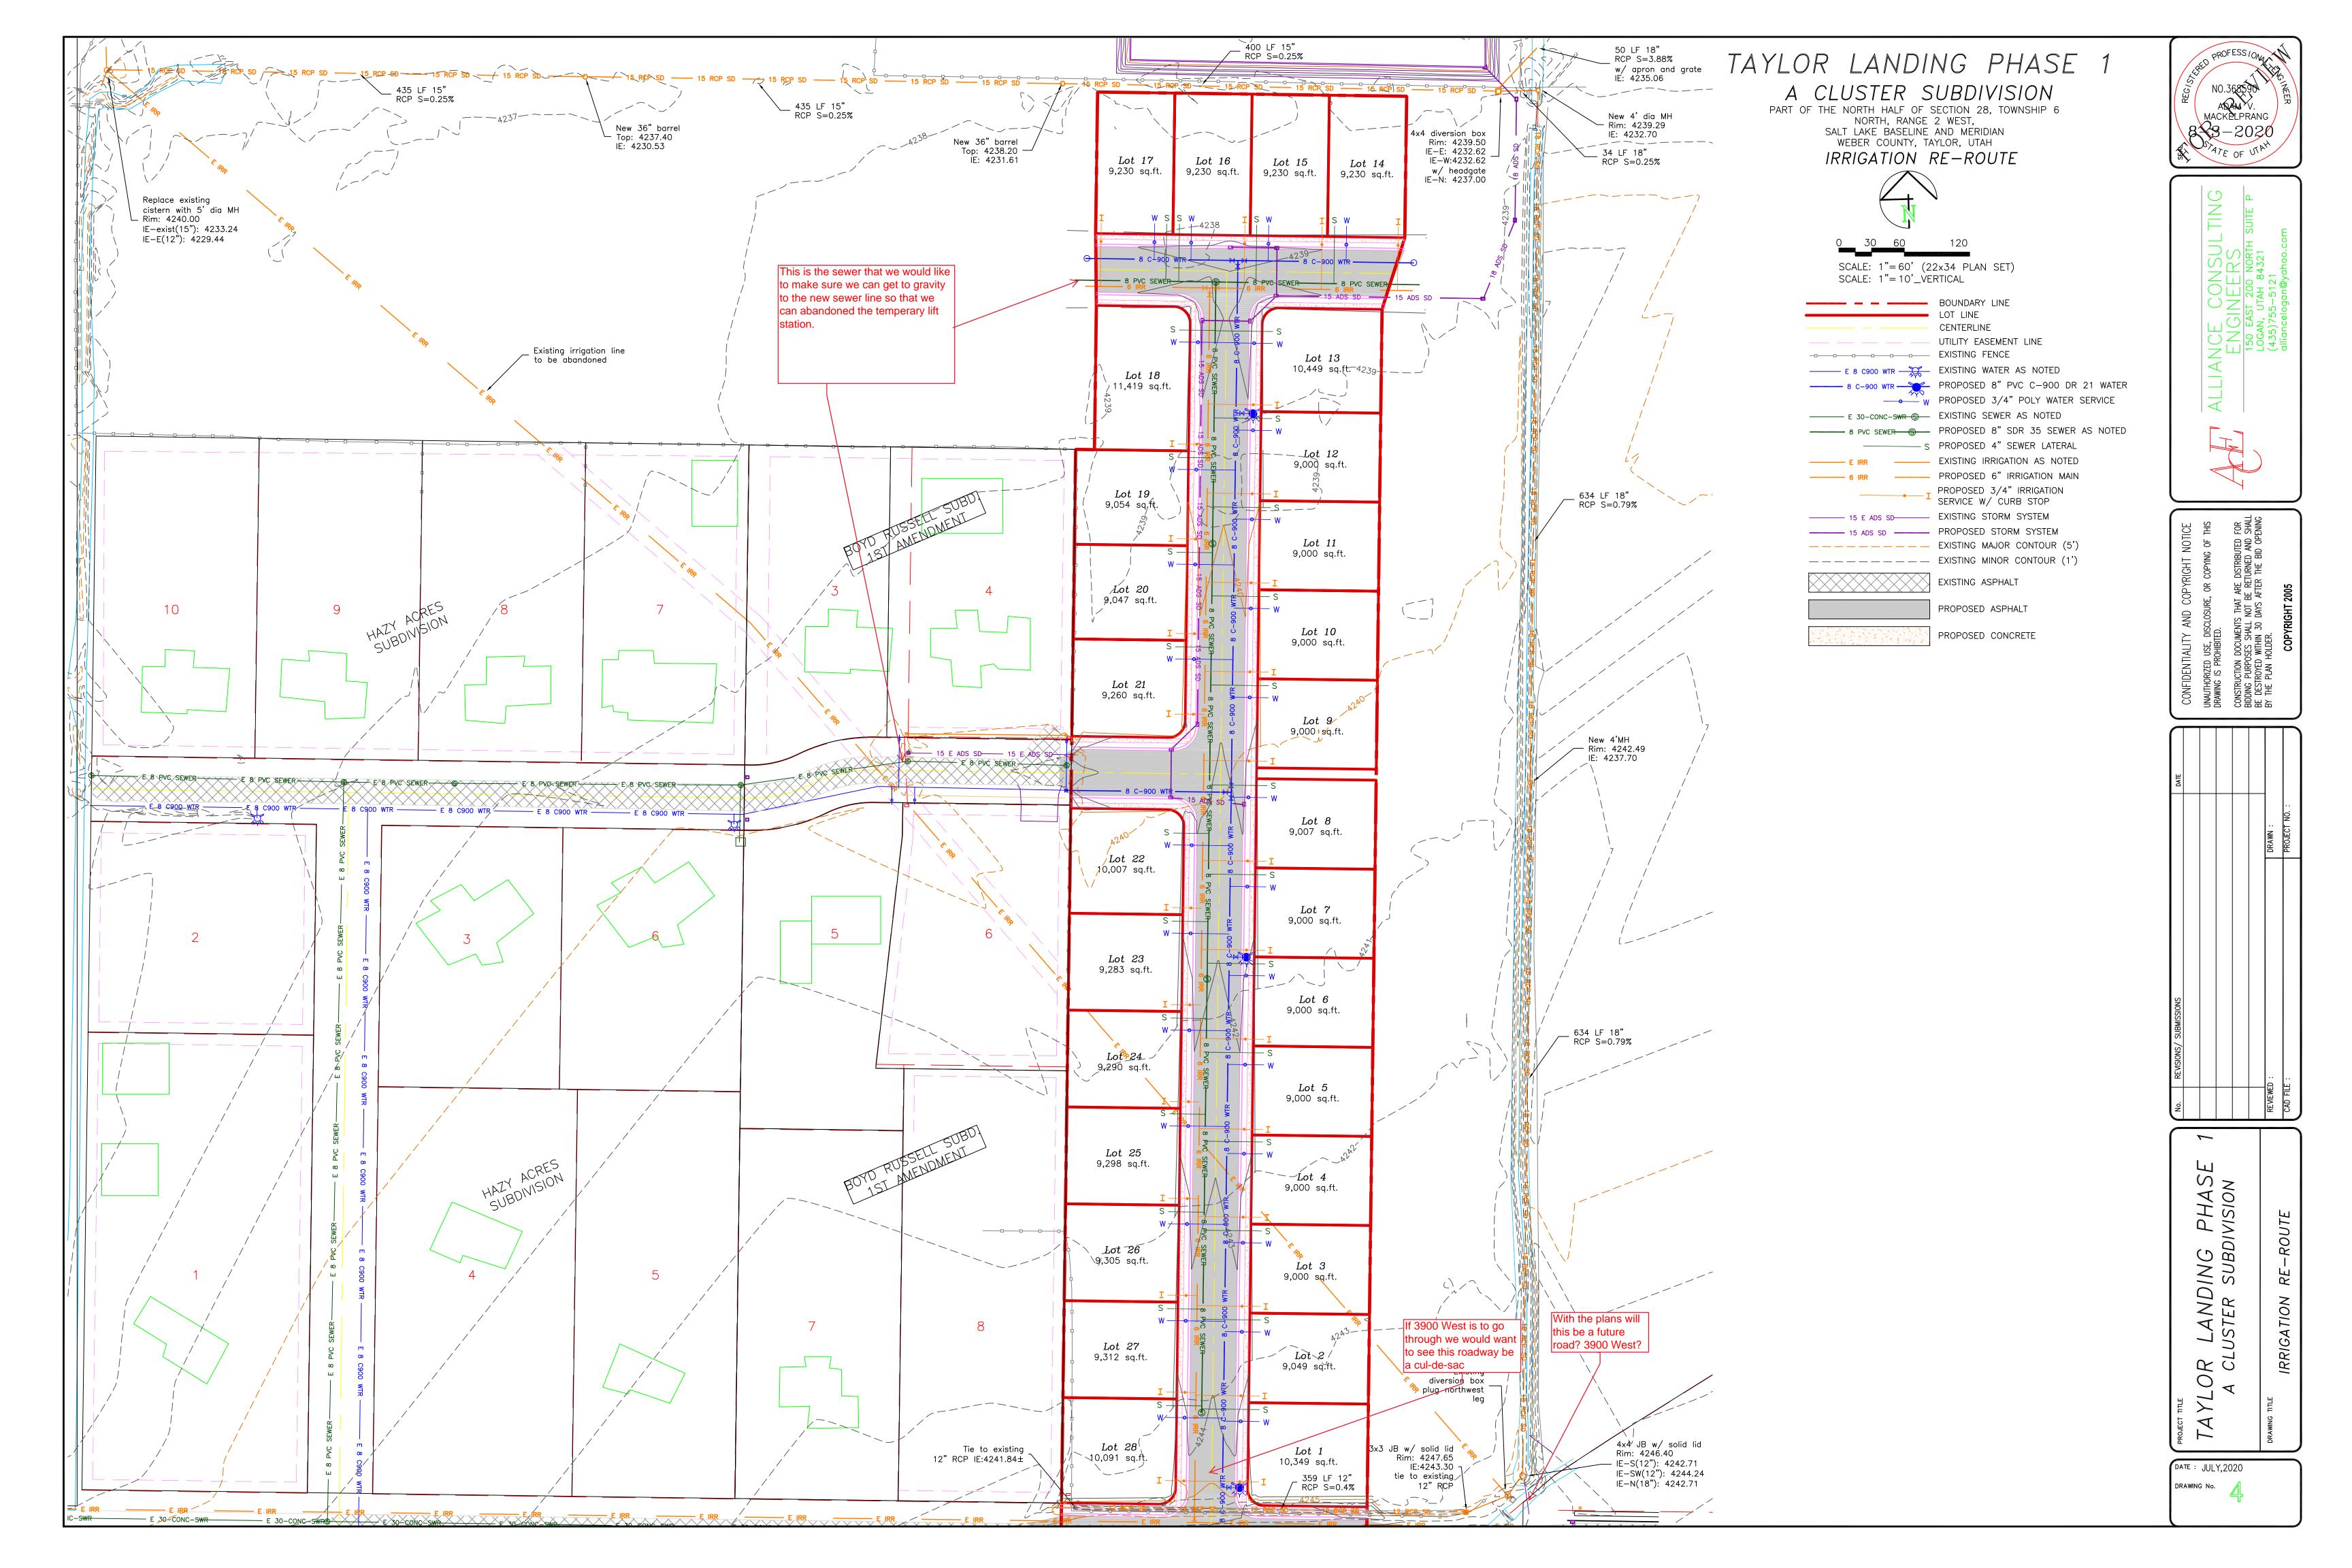WEBER COUNTY, TAYLOR, UTAH

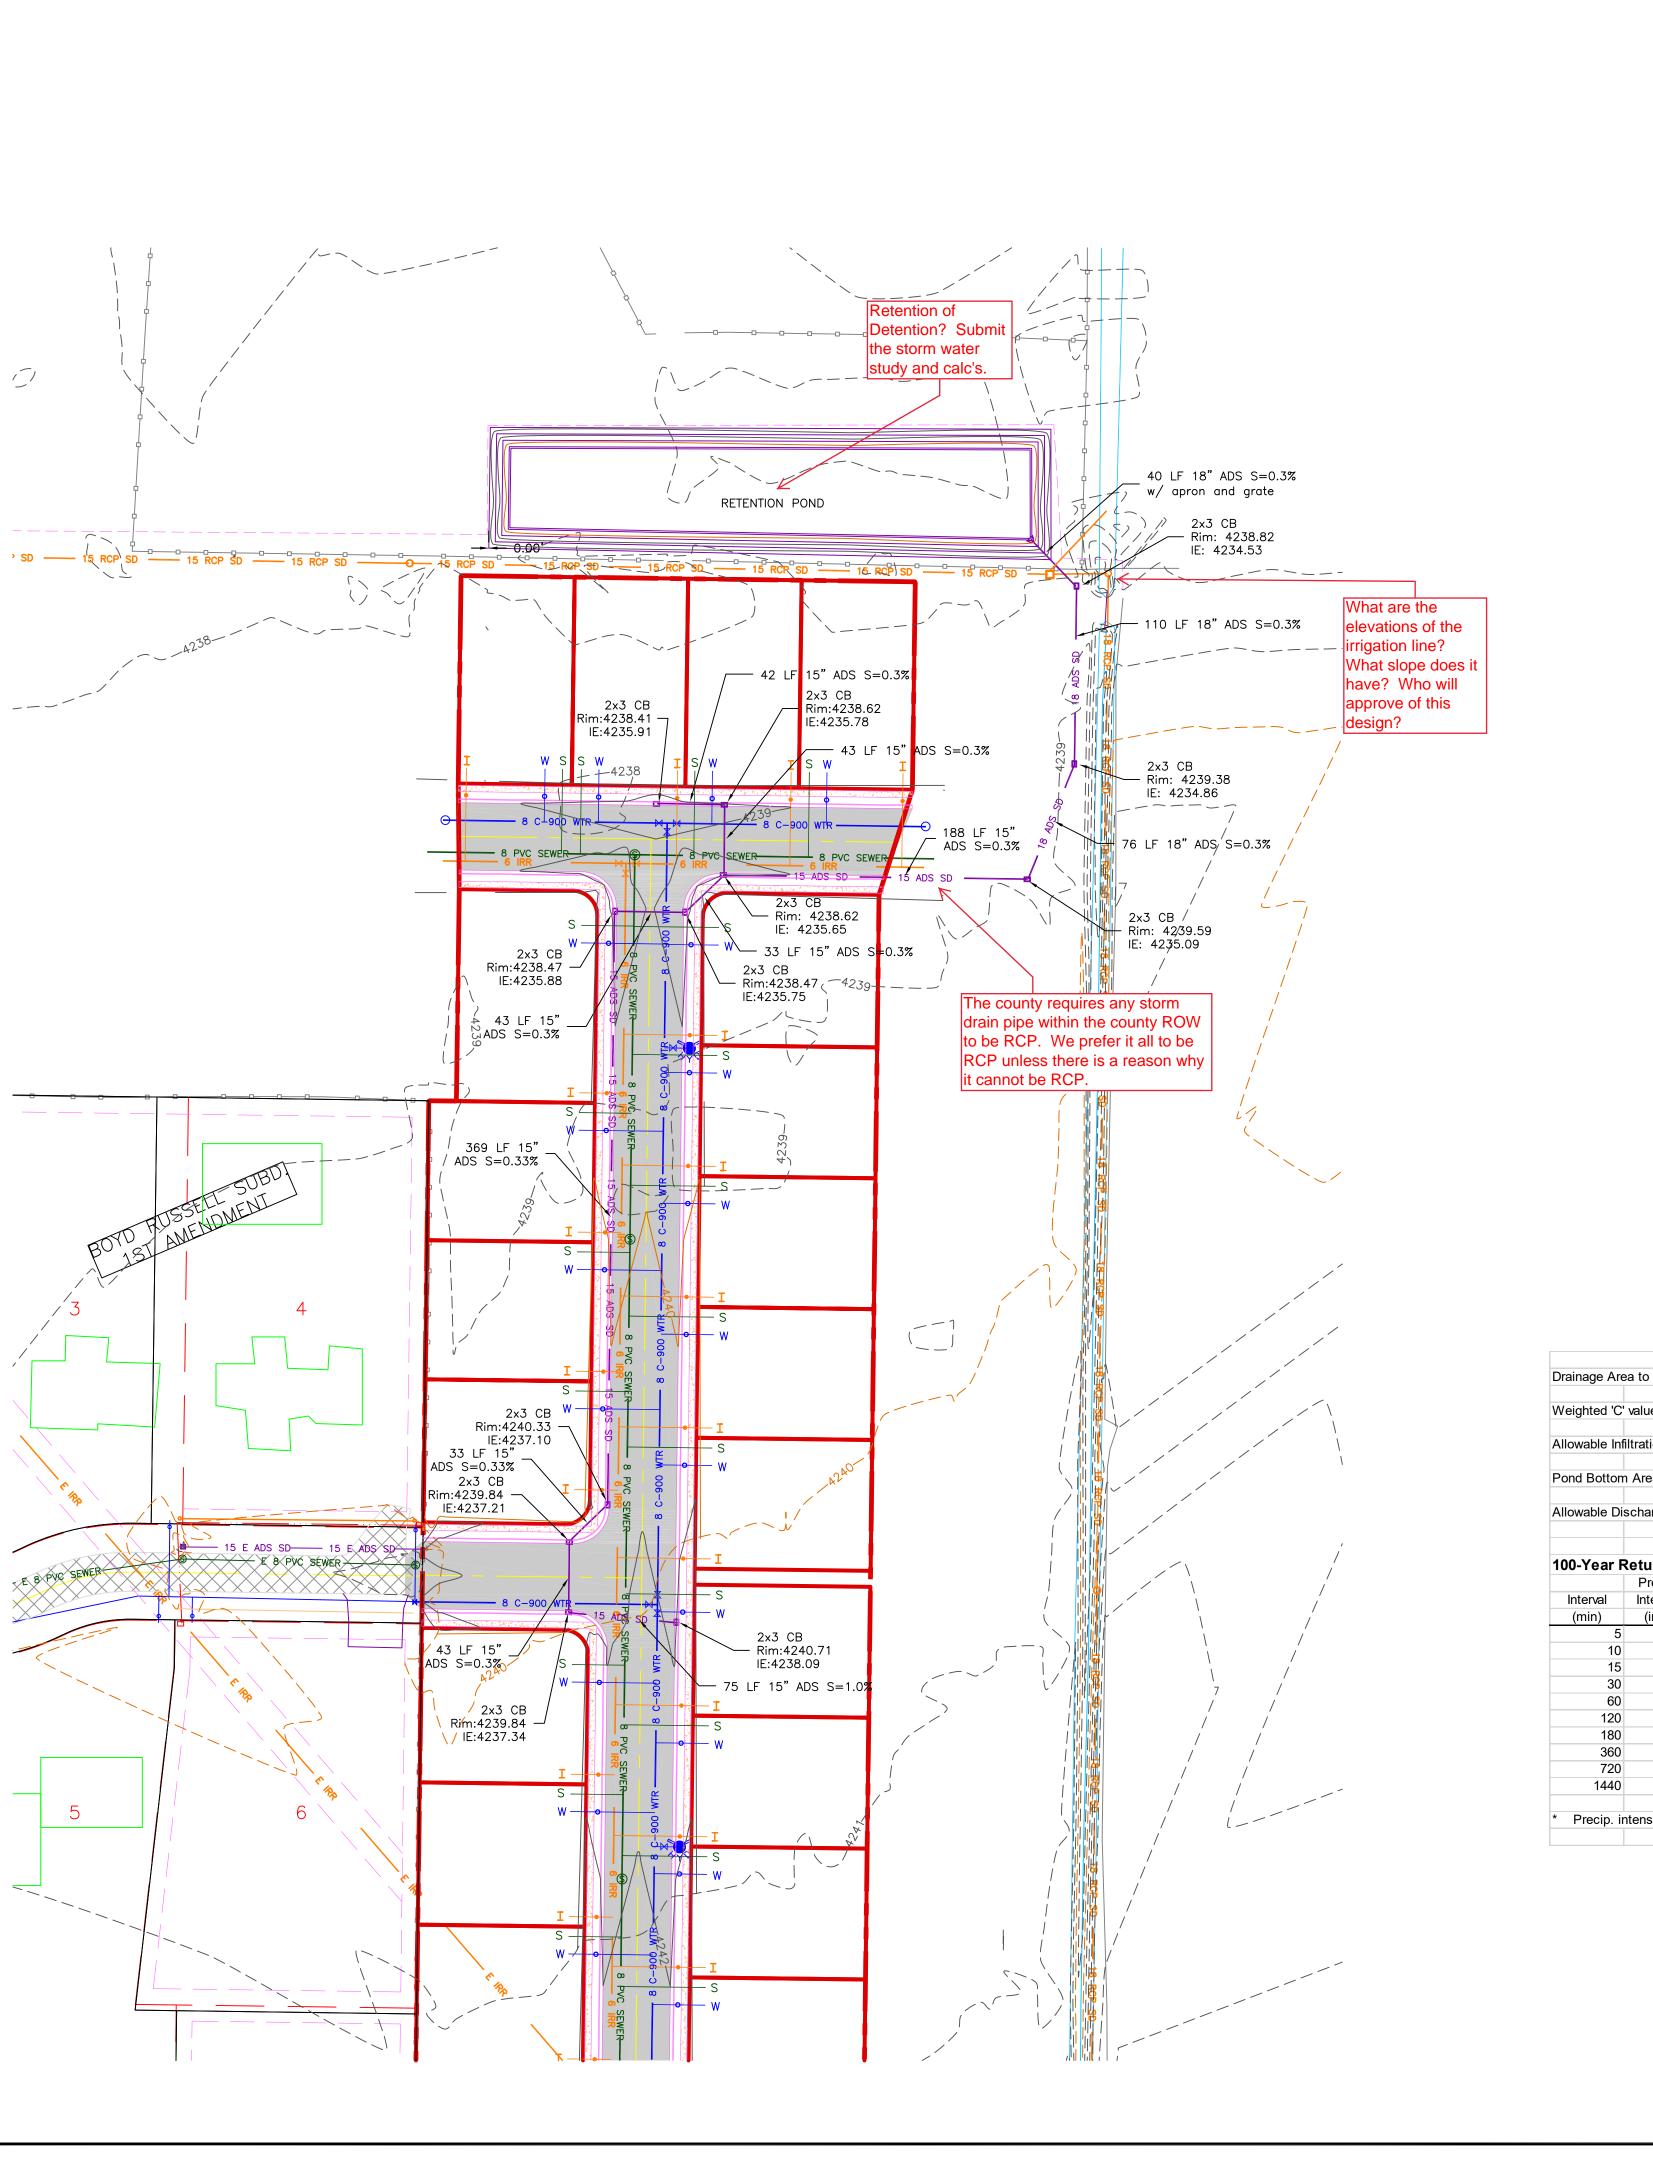GRADING / DRAINAGE PLAN



SCALE: 1"=60' (22x34 PLAN SET)


	BOUNDARY LINE LOT LINE CENTERLINE UTILITY EASEMENT LINE EXISTING FENCE
——— E 8 С900 WTR — 💢	EXISTING WATER AS NOTED
	PROPOSED 8" PVC C-900 DR 21 WATER
<u> </u>	PROPOSED 3/4" POLY WATER SERVICE
E 30-CONC-SWR S	EXISTING SEWER AS NOTED
8 PVC SEWER	PROPOSED 8" SDR 35 SEWER AS NOTED
s	PROPOSED 4" SEWER LATERAL
E IRR	EXISTING IRRIGATION AS NOTED
NEW IRR	PROPOSED 6" IRRIGATION MAIN
I	PROPOSED 3/4" IRRIGATION SERVICE
——————————————————————————————————————	EXISTING STORM SYSTEM
——————————————————————————————————————	PROPOSED STORM SYSTEM
	EXISTING MAJOR CONTOUR (5')
	EXISTING MINOR CONTOUR (1')
	EXISTING ASPHALT

PROPOSED ASPHALT

PROPOSED CONCRETE




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150 EAST 200 NORTH SUITE P
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allianceloggn@vghoo.com

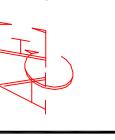

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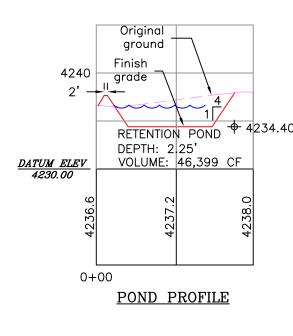
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YLOR LANDING PHASE 1
A CLUSTER SUBDIVISION
GRADING/ DRAINAGE PLAN

DATE: JULY,2020
DRAWING No.

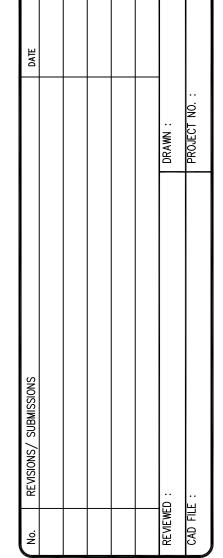

	. 5			10.70				1		
Drainage Are	ea to Pond:			13.70	acres					
Weighted 'C'	value for Por	nd Drainage	Area:	0.46						
Allowable Infiltration Rate:		Hyd D	0.6	inches/hr =	0.0008	ft/min	100	min/inch		
thowable in	intration rate		riya D	0.0	111011007111	0.0000	10111111	100	THE WILLIAM	
Pond Bottom	n Area:		76	ft x	350	ft =	26600	sq. ft.		
Allowable Di	scharge Rate	<b>5</b> .		0.0	cfs/acre					
				0.0	510, 510.0					
100 Voor 5	Return Peri	iad								
iuu-rear r						A 0 01 100	Allowable	A 0.011m2	Dogu	uirad
luada un val	Precip.*	Precip.	A	0	Cv.A.v.20220	Accum.		Accum.	Required Storage	
Interval	Intensity	Depth	Area	C	CxAx3630	Inflow	Discharge	Discharge		
(min)	(in/hr)	(in)	(ac)	Value	(ft^3/in)	(ft3/min)	(ft^3/min)	(ft^3)	(ft^3)	(ac-ft)
5	6.52	0.54	13.7					111		0.28
10	4.96	0.83	13.7					222		0.43
15	4.08	1.02	13.7					332.5		0.53
30	2.76	1.38	13.7					665		0.71
60	1.71	1.71	13.7	0.46				1330	37788	0.87
120	0.93	1.86	13.7	0.46	22876.26	42549.844	22	2660	39890	0.92
180	0.63	1.90	13.7	0.46	22876.26	43462.606	22	3990	39473	0.91
360	0.35	2.12	13.7	0.46	22876.26	48497.214		7980		0.93
720	0.22	2.60	13.7	0.46	22876.26	59476.446	22	15960	43516	1.00
1440	0.12	2.88	13.7	0.46	22876.26	65883.629	22	31920	33964	0.78
* Precip in	ntensity value	es derived fro	m NOAA							
1 100ip. II	itorionty value	4011104 110	11110701							