

PROJECT NUMBER

ISSUE DATE: APR. 13, 2018 **REVISIONS:**

No. Date Description

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ADVENTURE'S FIRST STOP

~

VE


0

ENGINEER:

J. NATE REEVE

CONCRETE MOW STRIP

SCALE: NOT TO SCALE

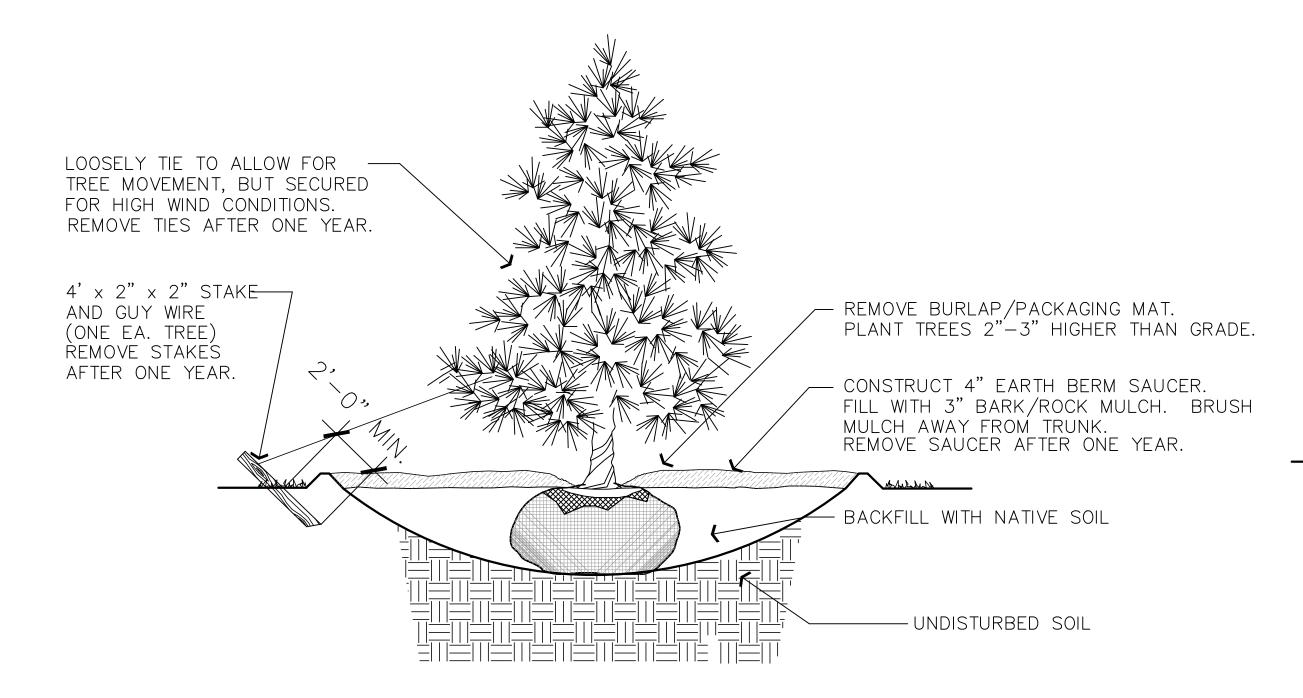


CONIFEROUS TREE PLANTING

NOTE: DIG HOLE THREE TIMES THE WIDTH AND AS DEEP

AS ROOTBALL, EXCEPT WHERE NOTED.


SCALE: NOT TO SCALE

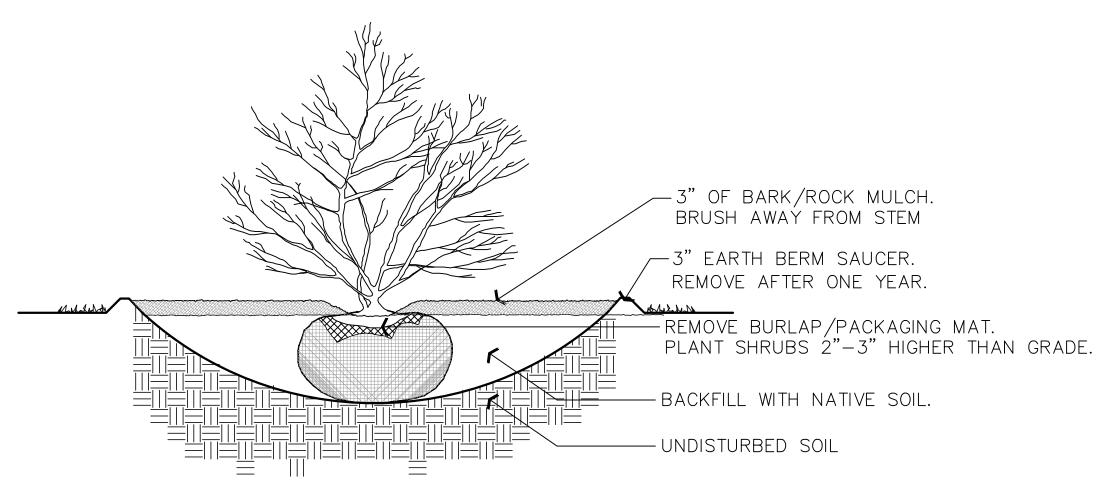

NOTE: DIG HOLE THREE TIMES THE WIDTH AND AS DEEP AS ROOTBALL, EXCEPT WHERE NOTED.

SHRUB PLANTING

SCALE: NOT TO SCALE

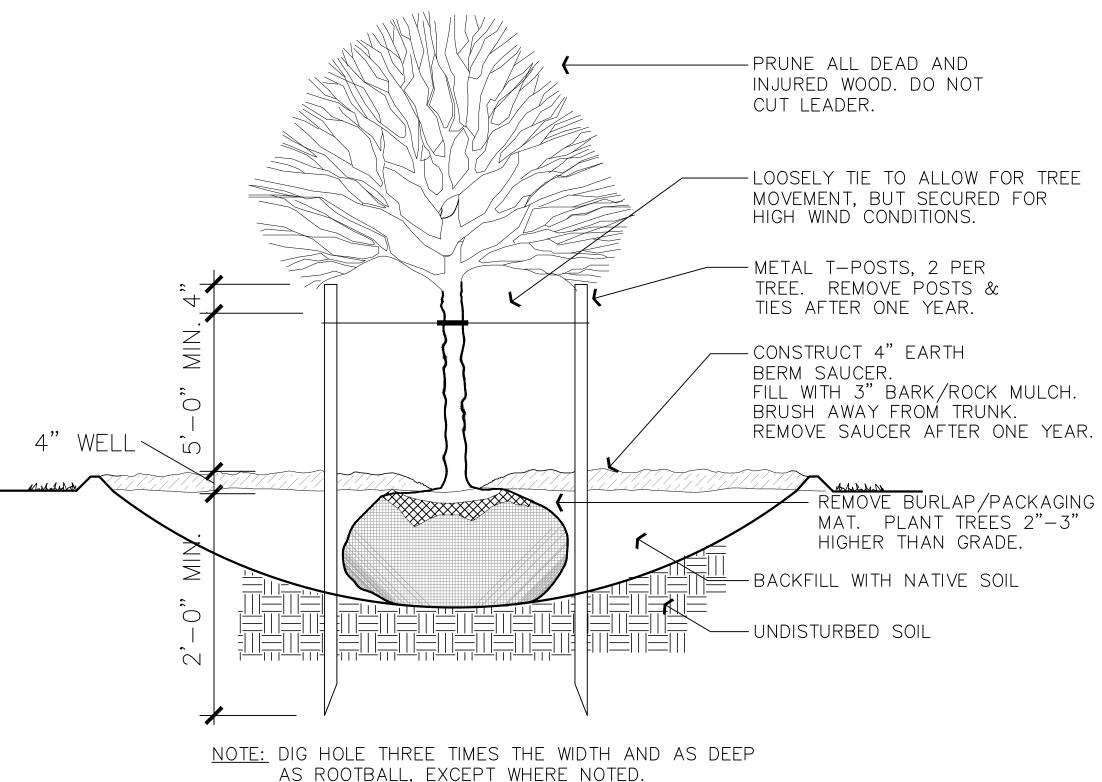

DECIDUOUS TREE PLANTING

SCALE: NOT TO SCALE

<u>General Notes</u>

A) The contractor shall verify the exact location of all existing and proposed utilities, and all site conditions prior to beginning construction. The contractor shall coordinate his work with the project manager and all other contractors working on this site.

B) The finish grade of all planting area shall be smooth, even and consistent, free of any humps, depressions or other grading irregularities. The finish grade of all landscape areas shall be graded consistently 3/4" below the top of all surrounding walks, curbs, etc.

C) The contractor shall stake the location of all plants for approval prior to planting. Trees shall be located equidistant from all surrounding plant material. Shrubs and ground covers shall be triangular and equally spaced.

D) The plant materials list is provided as an indication of the specific requirements of the plants specified, wherever in conflict with the planting plan, the planting plan shall govern.

E) The contractor shall provide all materials, labor and equipment required for the proper completion of all landscape work as specified and shown on the drawings.

F) All plant materials shall be approved prior to planting. The Owner/Landscape Architect has the right to reject any and all plant material not conforming to the specifications. The Owner/Landscape Architect decision will be final.

G) The contractor shall keep the premises, storage areas and paving areas neat and orderly at all times. Remove trash, sweep, clean, hose, etc. daily.

H) The contractor shall plant all plants per the planting details, stake/guy as shown. Top of root balls shall be planted flush with grade.

I) The contractor shall not impede drainage in any way. The contractor shall always maintain positive drainage away from the building, walls, etc.

J) The contractor shall maintain all work until ALL work is complete and accepted by the Owner. In addition, the contractor shall maintain and guarantee all work for a period of THIRTY DAYS from the date of final acceptance by the Owner. Maintenance shall include mowing, weeding, fertilizing, cleaning, insecticides, herbicides, etc.

K) Maverik Corporation shall be responsible for landscape maintenance beyond construction period.



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DRAWN BY:

ENGINEER:

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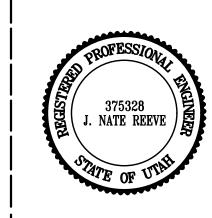
ADVENTURE'S FIRST STOP

AVER 09


MAVERIK, INC. STORE #2 5100 EAST & 2500 NORTH EDEN, UTAH

> ANDSCAPE DETAILS

L2



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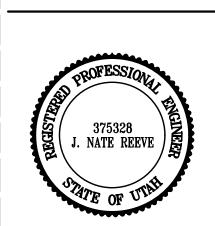
ADVENTURE'S FIRST STOP

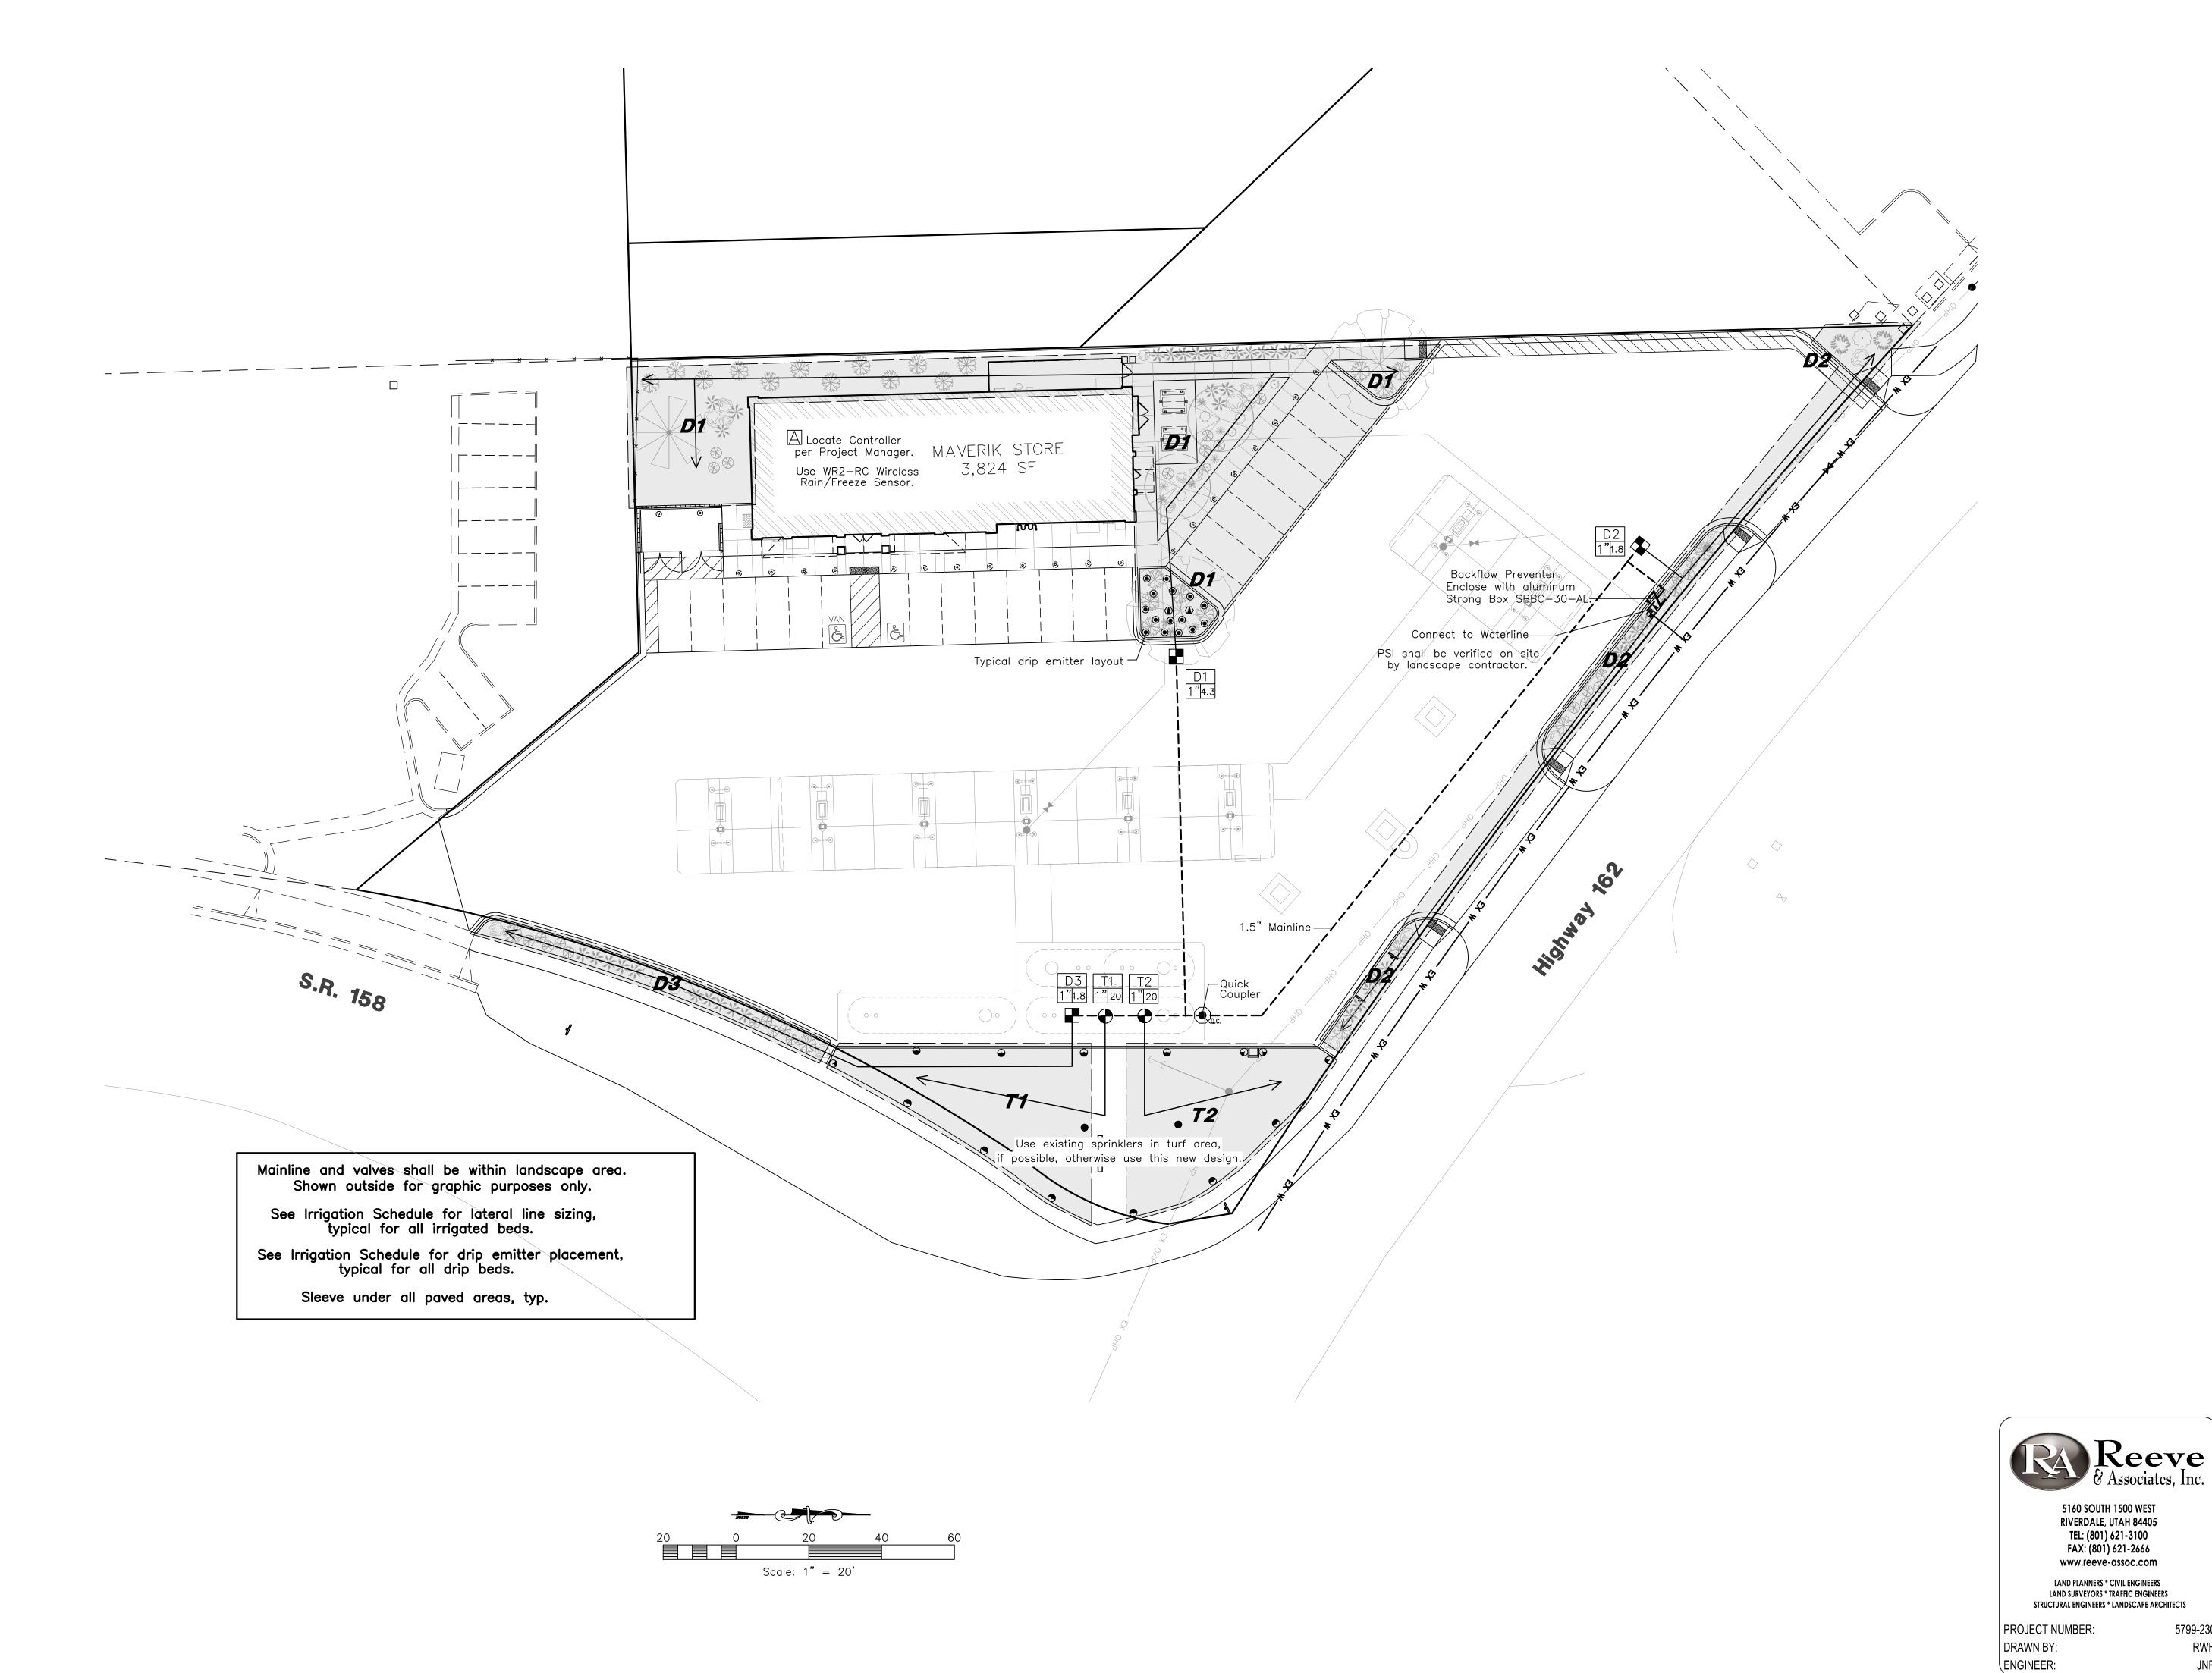VE

MAM

2500 NO UTAH


10



SYMBOL	MANUFAC ⁻	TURER CATALOG NUMBER	DESCRIPTION
	RAINBIRD	5004-PL-SAM-MPR-25 USE EXISTING SPRINKLERS IN	BODY AND RAIN CURTAIN ROTOR NOZZLE UNIT, 25'R TURF AREA, IF POSSIBLE.
(1)	RAINBIRD	RWS-B-C-1401	ROOT WATERING SERIES, 0.25 GPM, 2 EMITTERS/TREE
•	RAINBIRD	XB-T-20-PC	XERIBUG THREADED DRIP EMITTERS, 2 GAL/HOUR 1 EMITTER/1 GAL. PLANT, 2 EMITTERS/5 GAL. PLANT.
	RAINBIRD	XCZ-100-PRB-COM	COMMERCIAL CONTROL ZONE KIT DRIP VALVE
	RAINBIRD	PEB SERIES	PRESSURE REGULATING PLASTIC VALVE
VA	ALVE NO & C	CONTROLLER	
SIZE	PM		VALVE ID BOX
	ī ==		1-1/2" MAINLINE - SCHEDULE 40 PVC
	>		DRIP LATERAL LINE $-$ POLY PIPE MAY BE USED TURF LATERAL LINE $-$ CLASS 200 PVC, SIZED AS FOLLOWS $3/4"$ (0-10 gpm), 1" (10-16 gpm), 1 $1/4"$ (16-26 gpm), 1 $1/2"$ (26-35 gpm), 2" (35-55 gpm)
A	RAINBIRD	ESP 12 LXME:120 VAC	INDOOR/OUTDOOR MOUNT BASE CONTROLLER.
			SLEEVING — SCHEDULE 40 PVC, 2 SIZES GREATER THAN INTERIOR PIPE SLEEVING USED WHENEVER IRRIGATION IS PLACED UNDER PAVED AREAS.
ightharpoonup			GATE VALVE - SIZE PER PIPE - PLACE SLEEVE OVER VALVE
7	WILKENS	MODEL 375 OR EQUAL	BACKFLOW PREVENTION, SIZE AS PER CITY/COUNTY REGULATIONS.
Q.C.	RAINBIRD	MODEL 44LRC	1" QUICK COUPLING VALVE
			IRRIGATION ZONES

NOTE: USE EXISTING SPRINKLERS IN TURF AREA, IF POSSIBLE, OTHERWISE USE NEW DESIGN. NOTE: USE STRONG BOX SBBC 30 AL ALUMINUM BOX TO ENCLOSE BACKFLOW PREVENTER.

NOTE: USE WR2-RC WIRELESS RAIN/FREEZE SENSOR.

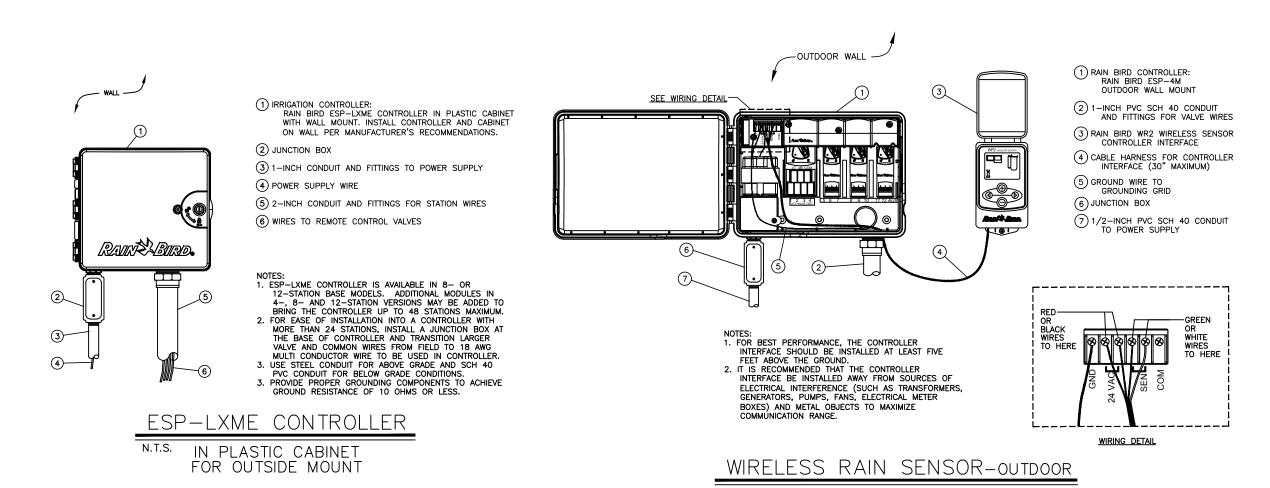


SPRINKLER NOTE


All Plant Material shown on the drawing shall be serviced by an Automatic Underground Irrigation System. The Contractor is to have a qualified Irrigation System specialist prepare a design for an Automatic Underground Irrigation System and submit drawings to the Engineer for approval at least 30 days prior to the system installation. Underground Irrigation System Drawings shall be prepared on 24"x36" sheet, neatly drawn and very legible. Drawings are to include head spacing, types of heads, piping with sizes, valves, fittings and all other items required for proper installation of the system.


The Landscape Contractor shall be responsible for the installation of all irrigation sleeves prior to placement of hard improvements. Coordinate with the General Contractor.

The Landscape Contractor is to provide an Irrigation System connection (meter and backflow preventer assembly) to the waterline, as applicable, within State and Local jurisdictional codes. The Irrigation Contractor is responsible to coordinate this item with the Utility Contractor.

The Irrigation Control Box shall be located at the direction of the Project Manager.

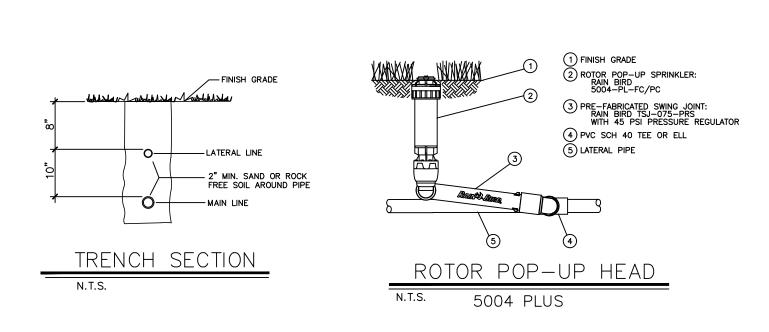

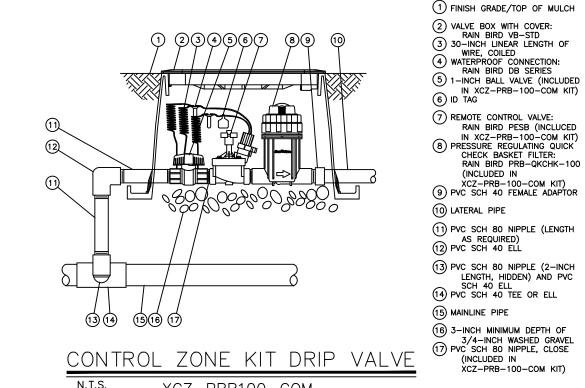

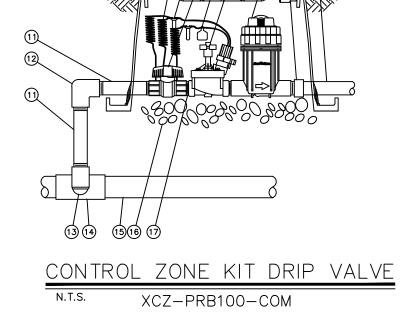

1) FINISH GRADE/TOP OF MULCH

3) SWING ASSEMBLY (INCLUDED)

PVC SCH 40 TEE OR EL

(1 OF 2 SHOWN, MORE POSSIBLE)

4) 1/2-INCH MALE NPT INLET (INCLUDED)

6 PVC OR POLYETHYLENE LATERAL PIPE

7 OPTIONAL RWS SAND SOCK (RWS-SOCK)

2 ROOT WATERING SERIES: RAIN BIRD RWS SERIES


(7) REMOTE CONTROL VALVE: RAIN BIRD PESB (INCLUCED
IN XCZ-PRB-100-COM KIT)

PRESSURE REGULATING QUICK
CHECK BASKET FILTER:
RAIN BIRD PRB-QKCHK-100 (INCLUDED IN XCZ-PRB-100-COM KIT)

9 PVC SCH 40 FEMALE ADAPTOR (10) LATERAL PIPE (11) PVC SCH 80 NIPPLE (LENGTH AS REQUIRED)

(12) PVC SCH 40 ELL (13) PVC SCH 80 NIPPLE (2-INCH LENGTH, HIDDEN) AND PVC
SCH 40 ELL

14 PVC SCH 40 TEE OR ELL (15) MAINLINE PIPE (16) 3-INCH MINIMUM DEPTH OF 3/4-INCH WASHED GRAVE (17) PVC SCH 80 NIPPLE, CLOSE (INCLUDED IN XCZ-PRB-100-COM KIT)

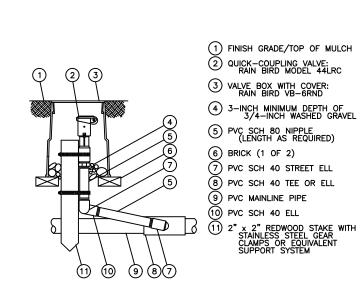

ELECTRIC REMOTE CONTROL VALVE

PEB OR PEB SERIES

INSTALL EMITTERS JUST ABOVE FINAL GRADE FOR EASY VISUAL INSPECTION.

MULCH LAYER

LINEAR LOW DENSITY — POLYETHYLENE PIPE 14" LONG MINIMUM 24" LONG MAXIMUM

N.T.S.

DRIP EMITTER

— 1/2" SCH. 40 PVC ADAPTER (gray)

L PVC OR POLY LATERAL LINE

1 30-INCH LINEAR LENGTH OF

2 WATERPROOF CONNECTION RAIN BIRD SPLICE-1 (1 OF 2) (3) ID TAG: RAIN BIRD VID SERIES

REMOTE CONTROL VALVE:
RAIN BIRD PESB-PRS-D
WITH NP-HAN

6) FINISH GRADE/TOP OF MULCH 7) PVC SCH 80 NIPPLE (CLOSE)

5 VALVE BOX WITH COVER: RAIN BIRD VB-STD

8) PVC SCH 40 ELL

10) BRICK (1 OF 4)

11) PVC MAINLINE PIPE (12) SCH 80 NIPPLE (2-INCH LENGTH, HIDDEN) AND SCH 40 ELL


(13) PVC SCH 40 TEE OR ELL

(14) PVC SCH 40 MALE ADAPTER 15) PVC LATERAL PIPE 16 3.0-INCH MINIMUM DEPTH OF 3/4-INCH WASHED GRAVEL

PVC SCH 80 NIPPLE
 (LENGTH AS REQUIRED)

FURNISH FITTINGS AND PIPING NOMINALLY SIZED IDENTICAL TO NOMINAL QUICK COUPLING VALVE INLET SIZE.

QUICK COUPLING VALVE N.T.S. MODEL 44RC SERIES

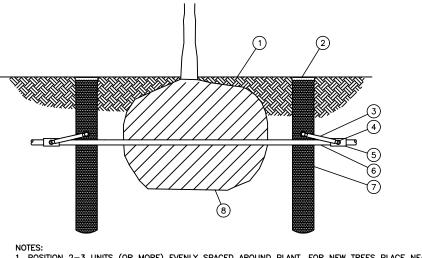

) FINISH GRADE/TOP OF MULCH

) SWING ASSEMBLY: RAIN BIRD MODEL SA 6050

PVC LATERAL PIPE

POP-UP SPRAY HEAD

RD-04 WITH SWING PIPE

(5) PVC SCH 40 TEE OR ELL


FOR SANDY SOILS (1 OF 2 SHOWN, MORE POSSIBLE) 8 PLANT ROOT BALL NOTES:
1. POSITION 2-3 UNITS (OR MORE) EVENLY SPACED AROUND PLANT. FOR NEW TREES PLACE NEAR ROOT BALL. FOR EXISTING TREES PLACE HALF THE DISTANCE BETWEEN CANOPY EDGE AND TREE TRUNK.

2. INSTALL PRODUCT WITH TOP EVEN WITH GROUND SURFACE.

3. RWS SERIES AVAILABLE IN THE FOLLOWING MODELS: RWS-B-C-1401 (0.25 GPM, CHECK VALVE) RWS (NO BUBBLER/EMITTER INCLUDED) RWS-B-X-1401 (0.25 GPM, 18" SWING ASSEMBLY) RWS-B-C-1402 (0.5 GPM, CHECK VALVE) RWS-B-1402 (0.5 GPM) RWS-B-C-1408 (2.0 GPM, CHECK VALVE)

4. WHEN INSTALLING IN EXTREMELY HARD OR CLAY SOILS, ADD 3/4" GRAVEL UNDER AND AROUND THE UNIT TO ALLOW FASTER WATER

INFILTRATION AND ROOT PENETRATION.
5. ONCE RWS HAS BEEN INSTALLED FILL THE BASKET WITH PEA GRAVEL BEFORE LOCKING LID. RWS ROOT WATERING SYSTEM N.T.S. INSTALLATION FOR TREES

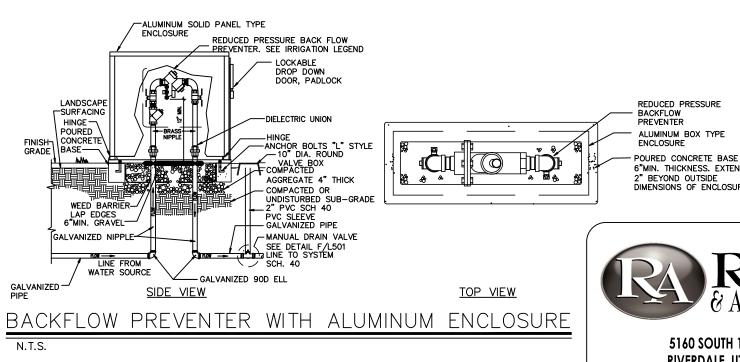

6"MIN. THICKNESS. EXTEND 2" BEYOND OUTSIDE DIMENSIONS OF ENCLOSURE Reeve & Associates, Inc.

> 5160 SOUTH 1500 WEST RIVERDALE, UTAH 84405 TEL: (801) 621-3100 FAX: (801) 621-2666 www.reeve-assoc.com

LAND PLANNERS * CIVIL ENGINEERS LAND SURVEYORS * TRAFFIC ENGINEERS STRUCTURAL ENGINEERS * LANDSCAPE ARCHITECTS

PROJECT NUMBER: DRAWN BY: **ENGINEER:**

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ISSUE DATE: APR. 13, 2018 **REVISIONS:**

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ADVENTURE'S FIRST STOP

50


#2 ORE 0 9 4 250 UT/ S

S X X 0 0





WR2 SERIES CONTROLLER INTERFACE

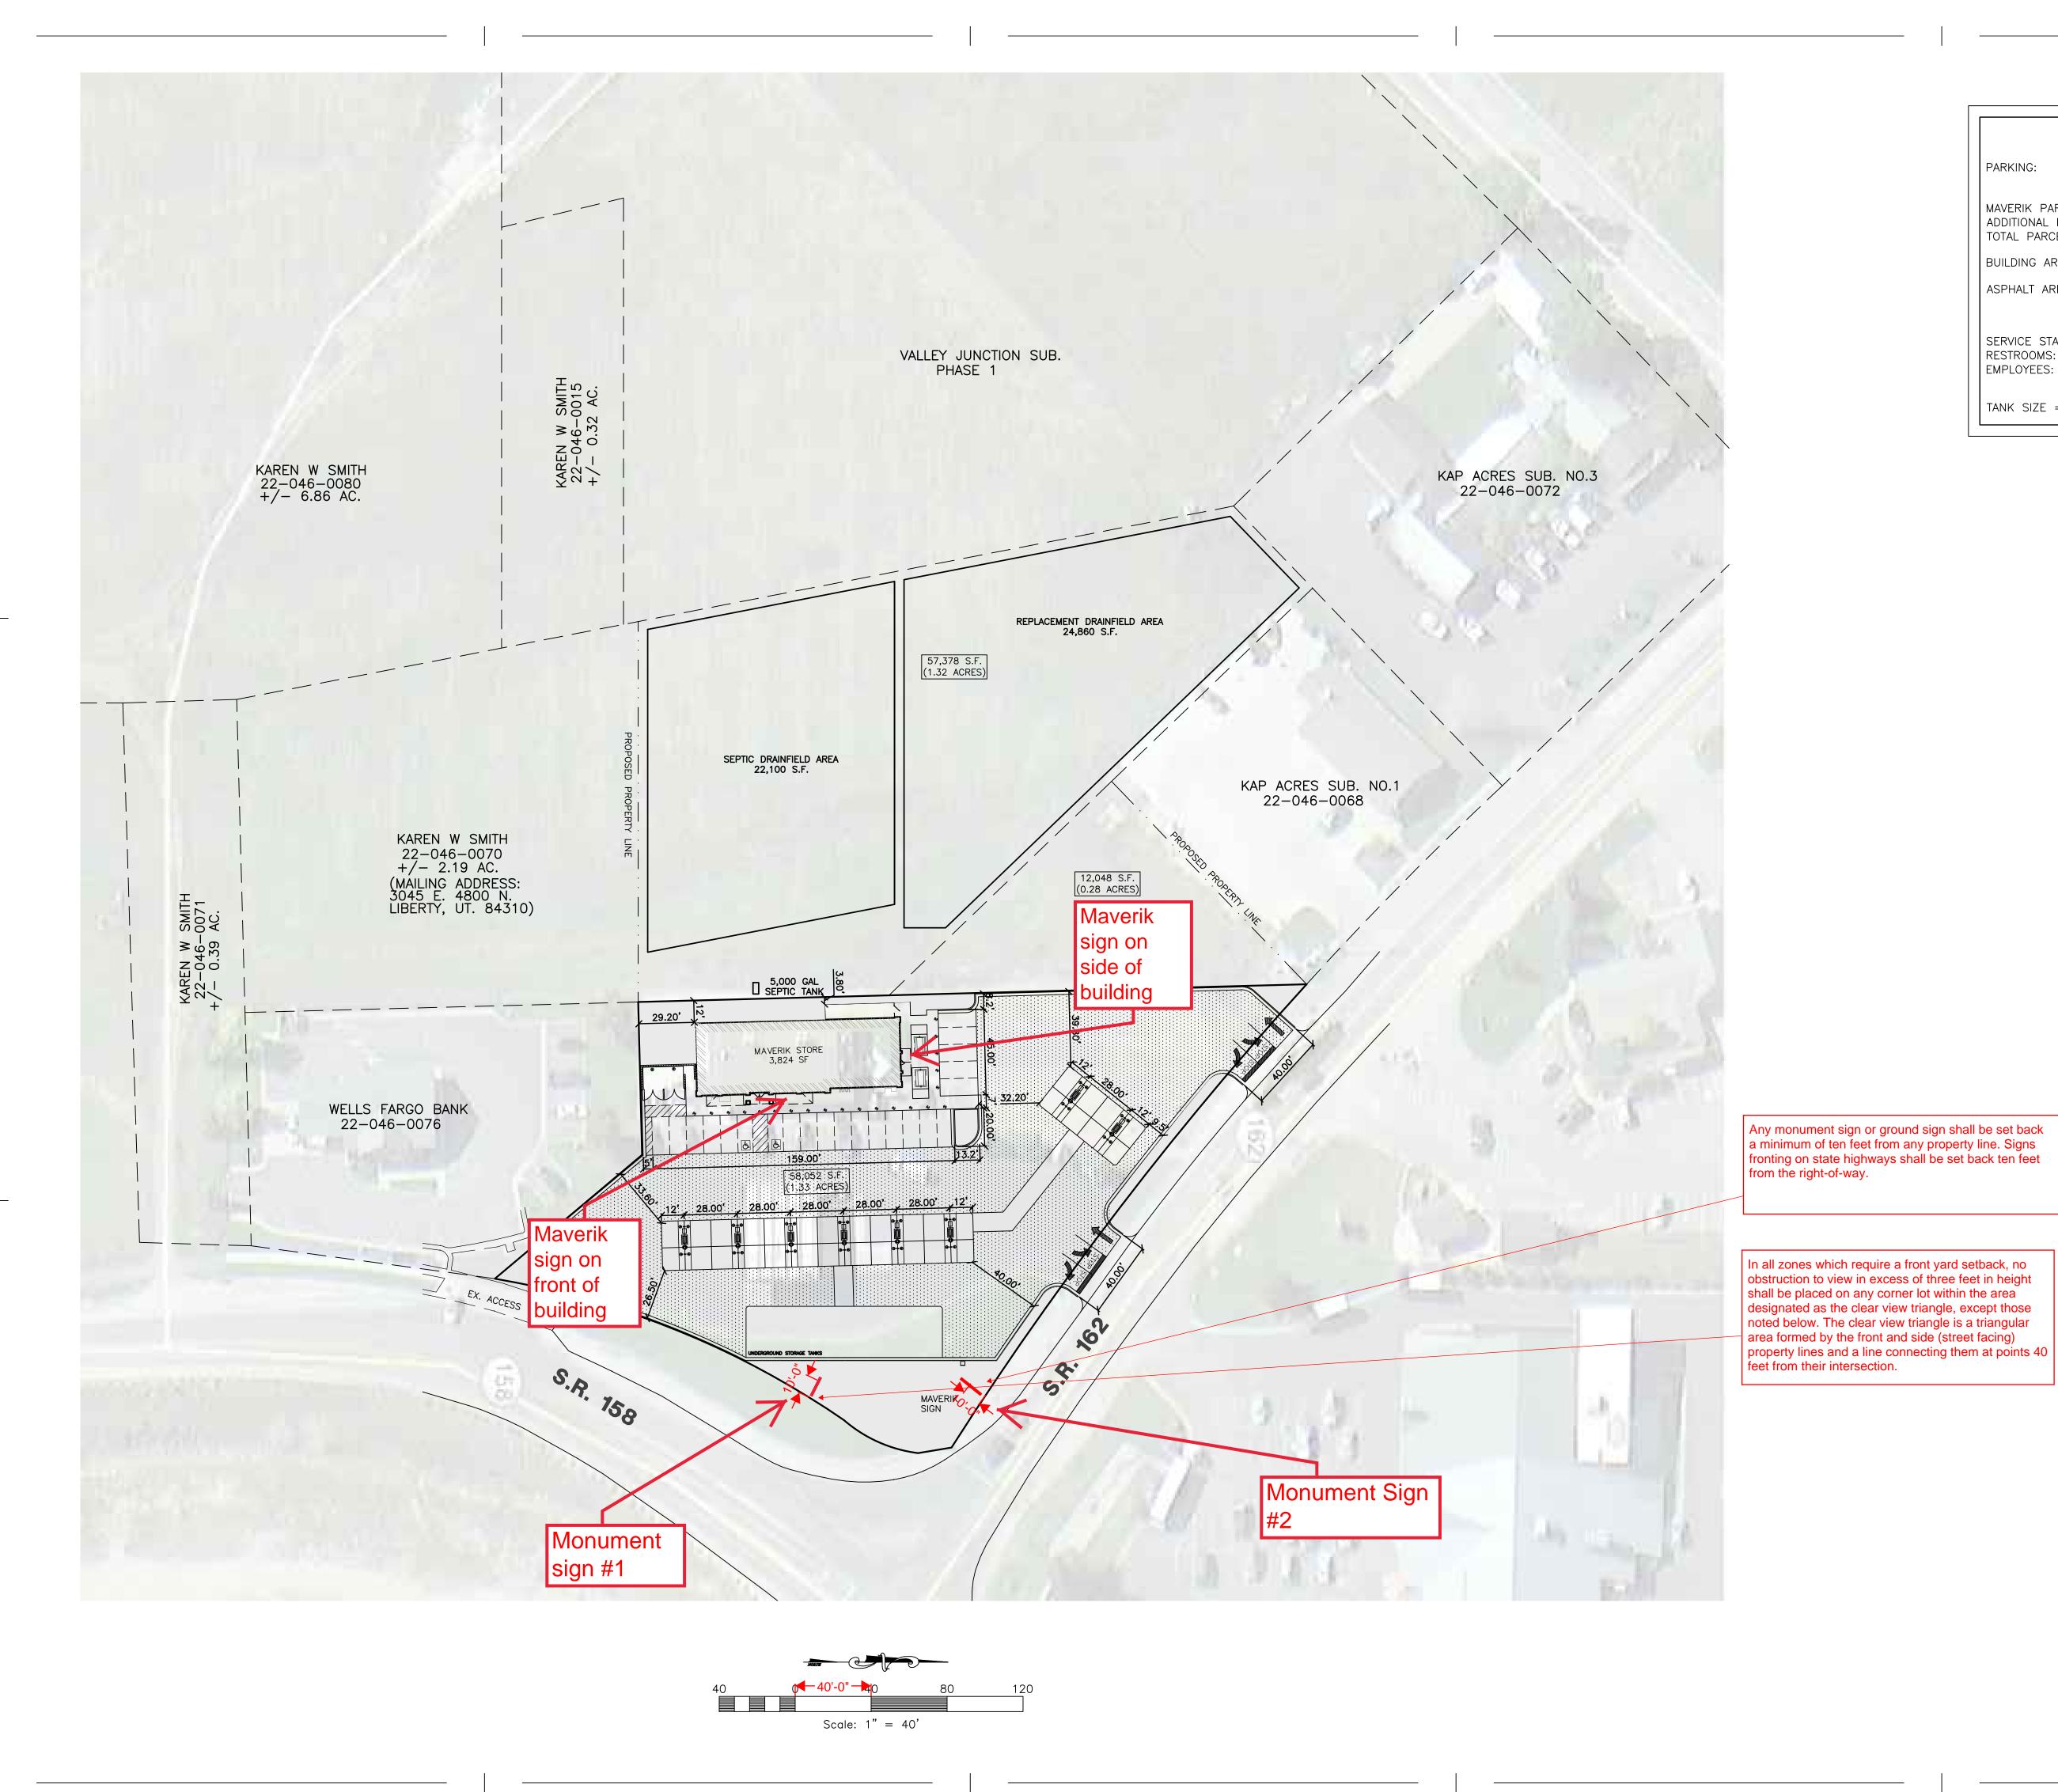

SITE DATA

PARKING:

32 STALLS PROVIDED (2 A.D.A.) (Not incl. gas canopy locations)

MAVERIK PARCEL: ADDITIONAL PARCEL: TOTAL PARCEL:

58,052 S.F. (1.33 ACRES) 69,426 S.F. (1.59 ACRES) 127,478 S.F. (2.93 ACRES)

BUILDING AREA: 3,824 S.F.

31,968 S.F (0.73 ACRES) ASPHALT AREA:

SEPTIC TANK CALCS

SERVICE STATION: 250 GAL/DAY/PUMP(12) = 3,000 GPD500 GAL/DAY/RR(2) =RESTROOMS: 11 GAL/DAY/EMP(5) =EMPLOYEES:

1,000 GPD 55 GPD TOTAL 4,055 GPD

TANK SIZE = 1.5*4,055 = 6082.5 GAL SEPTIC TANK REQ.



CONSULTANTS



OGDEN, UTAH 84403 TEL: (801) 621-3100 FAX: (801) 621-2666 www.reeve-assoc.com

LAND PLANNERS * CIVIL ENGINEERS LAND SURVEYORS * TRAFFIC ENGINEERS STRUCTURAL ENGINEERS * LANDSCAPE ARCHITECTS

PROJECT NUMBER: 5799-230 NOTE:

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ADVENTURE'S FIRST STOP

STORE #250 MAVERIK, Inc. 5100 East & **2500 North** Eden, Utah

#	DATE	D	ESC.			
1	11/29/16	COMPLETED	PRELIM			
ISSUE:			1/15/2015			
PROJE	CT NO:		0			
DRAWN BY: RWI						
CHECKED BY: JNR						

Preliminary Site Plan Alt B

CO

M-8-60-16in

Cabinet sizes & widths & retainer sizes have been verified from SKYLINE. All remainder of sign to match.

1'-2"

Unless otherwise specified, all exterior lighting of a sign shall be downward directed from the top of the sign, and oriented so as to illuminate only the sign area, as defined in section 101-1-7, excluding the supports. If proposing exterior illuminated, please demonstrate compliance.

No direct artificial light, as defined in section 101-1-7, shall be projected from the sign area or beyond the sign area, including by means of diffusion or refraction through a translucent or transparent surface.

street side aluminum cabinet w/ painted finish [see color key]. 1 5/8" retainer. 1 1/2" metal divider bar. TOP FACE: Clear plycarbonate formed face w/ 2nd surface decoration. BOTTOM FACE: White face w/ digitally printed graphics [color corrected] SKYLINE changer FRESH FOOD to be white faces w/ 1st surface vinyl [see Sign Area: 60ft² Steel structure with cement board, 3" cement mow pad, and painted aluminum caps [match building]. Contractor to do brickwork.

MANUFACTURE & INSTALL TWO D/F **EXTERIOR ILLUMINATED** MONUMENT SIGNS. PERMITTING Sign Area: 60ft2 FINAL ELECTRICAL ONNECTION BY

	COLOR KE	Y - MAVERIK STANDARDS - NEW LOGO
4	PAINT	SHERWIN WILLIAMS# 7069 "IRON ORE"
7		
2	PAINT	PMS #186
4	VINYL	3M 3630-33 "RED"
2	PAINT	MATCH PMS 348c/SW#LV5-5074896-389504-A
3	VINYL	3M 3630-26 "GREEN"
	PAINT	DUPONT #K 9441
4	VINYL	3M 3630-26 "LT EUROPEAN BLUE"
5	VINYL	AVERY UC 900-811-T "PANTONE 427c"
~	NOTE: UNLESS	OTHERWISE NOTED, THE COLORS DEPICTED ON THIS RENDERING MAY

NOT MATCH ACTUAL COLORS ON FINISHED DISPLAY, PLEASE REFER TO COLOR-CALLOUTS
AND THEIR APPROPRIATE VENDOR SPECIFIED SAMPLES FOR APPROVED COLOR

FIELD SURVEY REQUIRED PRIOR TO FABRICATION. CABINET SIZES & WIDTHS & RETAINER SIZES TO BE VERIFIED FROM SUNSHINE. ALL REMAINDER OF SIGN TO MATCH SUNSHINE. CINNABON PRINT IS NOT PRINT READY, STANDARD FILES TO BE USED BY LAYOUT.

2.1 SIDE VIEW

D/F ILLUMINATED MONUMENT SIGN

If a downward directed light will be proposed instead, we will need to see illumination details.

lluminated


SCROLLING

cabinets with products

color key]. Exterior

price

Exterior lighting of a sign shall not exceed a ratio of 75 lumens per square foot of sign area. This ratio shall be calculated by combining the total lumen output of each artificial light source divided by the square footage of the sign area.

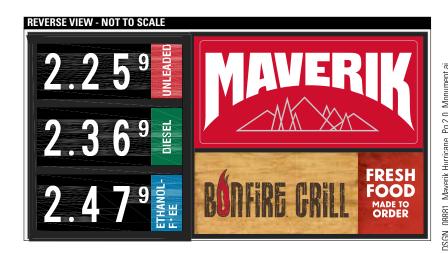

YESCO.

DESIGN

1605 South Gramercy Rd. Salt Lake City, UT 84104 801.487.8481

www.yesco.com

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This drawing was created to assist you in visualizing our proposal. The original ideas herein are the property of YESCO LLC. Permission to copy or revise this drawing can only be obtained through a written agreement with YESCO.

The colors shown are only approximated on any computer monitor, inkjet or laser print. The final product may vary slightly in color from your computer monitor or print.

This sign will be installed in accordance with the requirements of Article 600 of the National Electrical Code and / or other applicable local codes. This includes proper grounding and bonding of the sign.

Revisions

No.	Date / Description
Initial (R0)	10.18.2017
R1	12.01.2017
R2	02.14.2018
R3	
R4	
R5	
R6	
R7	
R8	
R9	
R10	
R11	
R12	
R13	
R14	
R15	

Approvals

YESCO A/E Signat	ture / Dat

Client Signature / Date

Landlord Signature / Date

Maverik

Acct. Exec: Matt Wren

Designer: Justin Raymond

Date: 02.14.2018

Monument

JO#

scale: as noted

Unless otherwise specified, all exterior lighting of a sign shall be downward directed from the top of the sign, and oriented so as to illuminate only the sign area, as defined in section 101-1-7. excluding the supports. If proposing exterior illuminated, please demonstrate compliance.

Exterior lighting of a sign shall not exceed a ratio of 75 lumens per square foot of sign area. This ratio shall be calculated by combining the total lumen output of each artificial light source divided by the square footage of the sign area.

This lighting is not permitted. If a downward directed

light will be proposed instead, we will need to see

-5" x 6" extuded aluminum raceway painted to match black returns.

illumination details.

·5" deep aluminum channel letter w/ 3RK32 or 2282 Red Arcylic faces. 1" Black trim cap. White L.E.D illumination. Mounted to raceway


1'-8"

2.1 SIDE VIEW

PAN CHANNEL LETTERS SCALE: 3/8" = 1'-0"

48" LETTER SET

No direct artificial light, as defined in section 101-1-7, shall be projected from the sign area or beyond the sign area, including by means of diffusion or refraction through a translucent or transparent surface. However, direct artificial light, excluding diffused or refracted light, for a sign area that does not have a frame or separate background, as in the case of a logo or individual lettering mounted to a wall without a defined sign perimeter, may illuminate or reflect onto a background surface, such as a wall, beyond the exterior perimeter of the sign area, provided that: 1. It shall not exceed six inches beyond the sign area; 2. It shall be shielded so as not to project light onto any other surface.

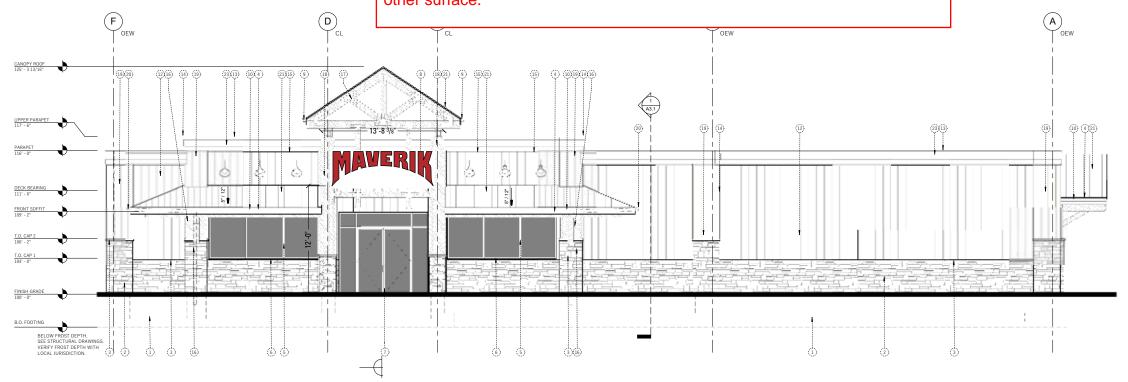

MANUFACTURE & INSTALL ONE [1] SET L.E.D. LLUMINATED PAN CHANNEL LETTERS. MOUNT TO BUILDING STRUCTURE

PERMITTING SIGN AREA: 53.0ft² | ELECTRICAL: | 2 Amps 120 V

CONNECTION BY:

COLOR KEY - MAVERIK STANDARDS PAINT | MATCH PMS 348c/SW#LV5-5074896-389504-A VINYL 3M 3630-26 "GREEN"

PAINT DUPONT #GS 379 VINYL 3M 3630-126 "DK EMERALD GREEN" PAINT | SW #LV5-5080915-342127-A

VINYL 3M 3630-149 "LT BEIGE" PAINT DUPONT #K 9441

VINYL 3M 3630-26 "LT EUROPEAN BLUE" PAINT PMS #186

VINYL 3M 3630-33 "RED" PAINT PMS STANDARD BLACK VINYL 3M 3630-22 "BLACK"

PAINT PMS #2945 VINYL 3M 3630-167 "BRIGHT

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FIELD SURVEY REQUIRED PRIOR TO FABRICATION.

YESCO. **DESIGN**

1605 South Gramercy Rd. Salt Lake City, UT 84104 801.487.8481

www.yesco.com

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Revisions

No.	Date / Description
Initial (R0)	08.17.2017
R1	09.07.2017
R2	09.08.2017
R3	
R4	
R5	
R6	
R7	
R8	
R9	
R10	
R11	
R12	
R13	
R14	
R15	

YESCO A/E Signature / Date

Client Signature / Date

Landlord Signature / Date

Maverik

Date: 09.08.2017

Large Front Letters

JO#

DETAIL ELEVATION SCALE: 3/32" = 1'-0"

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> x 5" extuded aluminum raceway painted to match black returns. 5" deep aluminum channel letter w/ 3RK32 or 2282 Red

PAN CHANNEL LETTERS

3.1 SIDE VIEW

24" LETTER SET

Mounted to racewa

Arcylic faces. 1" Black trim

cap. White L.E.D illumination.

SCALE: 3/8" = 1'-0"

4 (9) (12)(4) (18)(13)(3)(5) BELOW FROST DEPTH. SEE STRUCTURAL DRAWINGS VERIFY FROST DEPTH WITH LOCAL JURISDICTION

This lighting is not permitted. If a downward directed light will be proposed instead, we will need to see illumination details.

Exterior lighting of a sign shall not exceed a ratio of 75 lumens per square foot of sign area. This ratio shall be calculated by combining the total lumen output of each artificial light source divided by the square footage of the sign area.

COLOR KEY - MAVERIK STANDARDS PAINT | MATCH PMS 348c/SW#LV5-5074896-389504-A VINYL 3M 3630-26 "GREEN" PAINT DUPONT #GS 379 VINYL 3M 3630-126 "DK EMERALD GREEN" PAINT | SW #LV5-5080915-342127-A VINYL 3M 3630-149 "LT BEIGE" PAINT | DUPONT #K 9441 VINYL 3M 3630-26 "LT EUROPEAN BLUE" PAINT PMS #186 VINYL 3M 3630-33 "RED" PAINT | PMS STANDARD BLACK VINYL 3M 3630-22 "BLACK" PAINT PMS #2945 VINYL 3M 3630-167 "BRIGHT NOTE: LINESS OTHERWISE NOTED. THE COLORS DEPICTED ON THIS RENDERING MA NOT MATCH ACTUAL COLORS ON FINISHED DISPLAY. PLEASE REFER TO COLOR-CALLOUT AND THEIR APPROPRIATE VENDOR SPECIFIED SAMPLES FOR APPROVED COLO

MANUFACTURE & INSTALL ONE [1] SET L.E.D. ILLUMINATED

PAN CHANNEL LETTERS. MOUNT TO BUILDING ON RACEWAY

PERMITTING SIGN AREA: 11.5ft2 | ELECTRICAL: | 2 Amps 120 V

CONNECTION BY:

FIELD SURVEY REQUIRED PRIOR TO FABRICATION.

No direct artificial light, as defined in section 101-1-7, shall be projected from the sign area or beyond the sign area, including by means of diffusion or refraction through a translucent or transparent surface. However, direct artificial light, excluding diffused or refracted light, for a sign area that does not have a frame or separate background, as in the case of a logo or individual lettering mounted to a wall without a defined sign perimeter, may illuminate or reflect onto a background surface, such as a wall, beyond the exterior perimeter of the sign area, provided that: 1. It shall not exceed six inches beyond the sign area; 2. It shall be shielded so as not to project light onto any other surface.

YESCO.

DESIGN

1605 South Gramercy Rd. Salt Lake City, UT 84104 801.487.8481

www.yesco.com

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This drawing was created to assist you in visualizing our proposal. The original ideas herein are the property of YESCO LLC. Permission to copy or revise this drawing can only be obtained through a written agreement with YESCO.

The colors shown are only approximated on any computer monitor, inkjet or laser print. The final product may vary slightly in color from your computer monitor or print.

This sign will be installed in accordance with the requirements of Article 600 of the National Electrical Code and / or other applicable local codes. This includes proper grounding and bonding of the sign.

Revisions

No.	Date / Description
Initial (R0)	08.17.2017
R1	09.07.2017
R2	09.08.2017
R3	
R4	
R5	
R6	
R7	
R8	
R9	
R10	
R11	
R12	
R13	
R14	
R15	

YESCO A/E Signature / Date

Client Signature / Date

Landlord Signature / Date


Maverik

Date: 09.08.2017

Small Side Letters

JO#

SCALE: 1/8" = 1'-0"

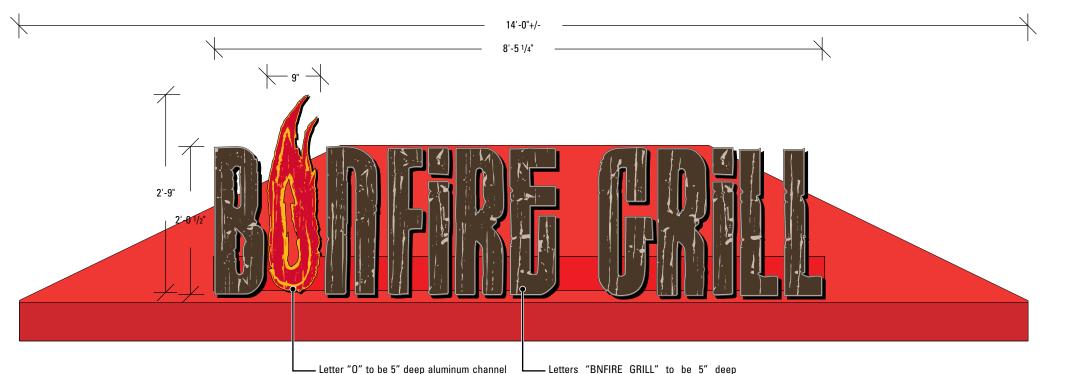

MANUFACTURE & INSTALL ONE [1] SET L.E.D. ILLUMINATED PAN CHANNEL LETTERS. MOUNT TO AWNING ON RACEWAY.

• TRIGGER SCHEDULE TO BE DETERMINED BY LAYOUT DEPT.

PERMITTING SIGN AREA: 0.00ft² | ELECTRICAL: | 2 Amps 120 V

CONNECTION BY:

COLOR KEY - BONFIRE GRI

PAINT PMS #186C VINYL 3M DIGITAL PRINT

PAINT PMS #1235 MANGO VINYL 3M DIGITAL PRINT

PAINT | PMS #1505C ORANGE VINYL 3M DIGITAL PRINT

> PAINT PMS #7528C MATCH LIGHT BEIGE 149 VINYL VINYL 3M DIGITAL PRINT

PAINT | PMS #7533 DARK BROWN VINYL 3M DIGITAL PRINT

NOTE: UNLESS OTHERWISE NOTED, THE COLORS DEPICTED ON THIS RENDERING MAY NOT MATCH ACTUAL COLORS ON FINISHED DISPLAY PLEASE REFER TO COLOR-CALLOUTS AND THEIR APPROPRIATE VENDOR SPECIFIED SAMPLES FOR APPROVED COLOR SPECIFICATIONS

FIELD SURVEY REQUIRED PRIOR TO FABRICATION. **CUSTOMER TO PROVIDE LOCATION RENDERING.**

TYPICAL INSTALLATION SHOWN. THIS SITE MAY VARY. **CENTER IN SPACE**

Letter "0" to be 5" deep aluminum channel letters w/ pre-painted black returns. Clear acrylic faces w/ 1st surface [non colorcorrected] digitally printed vinyl applied to white acrylic face. 1" Black trim cap. LED's to "flicker" with internal illumination plus (8) internal flashers. Flush mount to raceway [see side view].

PAN CHANNEL LETTERS SCALE: 3/4" = 1'-0"

BONFIRE LETTERS Std. SIZE "A"

aluminum channel letters w/ pre-painted

black returns. White acrylic faces w/ 1st

surface [color-corrected] digitally printed

vinyl applied to white acrylic face. 1" Black

trim cap. White L.E.D illumination. Flush

mount to raceway [see side view].



Please specify if this is indoor/outdoor lighting.

YESCO.

DESIGN

1605 South Gramercy Rd. Salt Lake City, UT 84104 801.487.8481

www.yesco.com

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This sign will be installed in accordance with the requirements of Article 600 of the National Electrical Code and / or other applicable local codes. This includes proper grounding and bonding of the sign.

Revisions

Initial (R0)	08.17.2017	
R1	09.07.2017	
R2	09.08.2017	
R3		
R4		
R5		
R6		
R7		
R8		
R9		
R10		
R11		
R12		
R13		
R14		
R15		
Δn	provals	

YESCO A/E Signature / Date


Client Signature / Date Landlord Signature / Date


Maverik

Date: 09.08.2017

Bonfire Letters

JO#

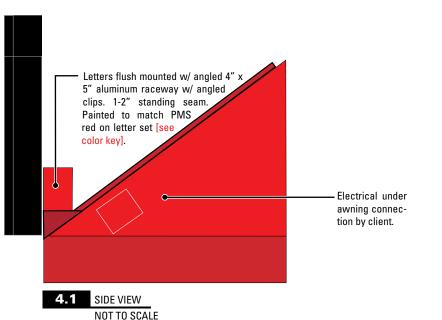

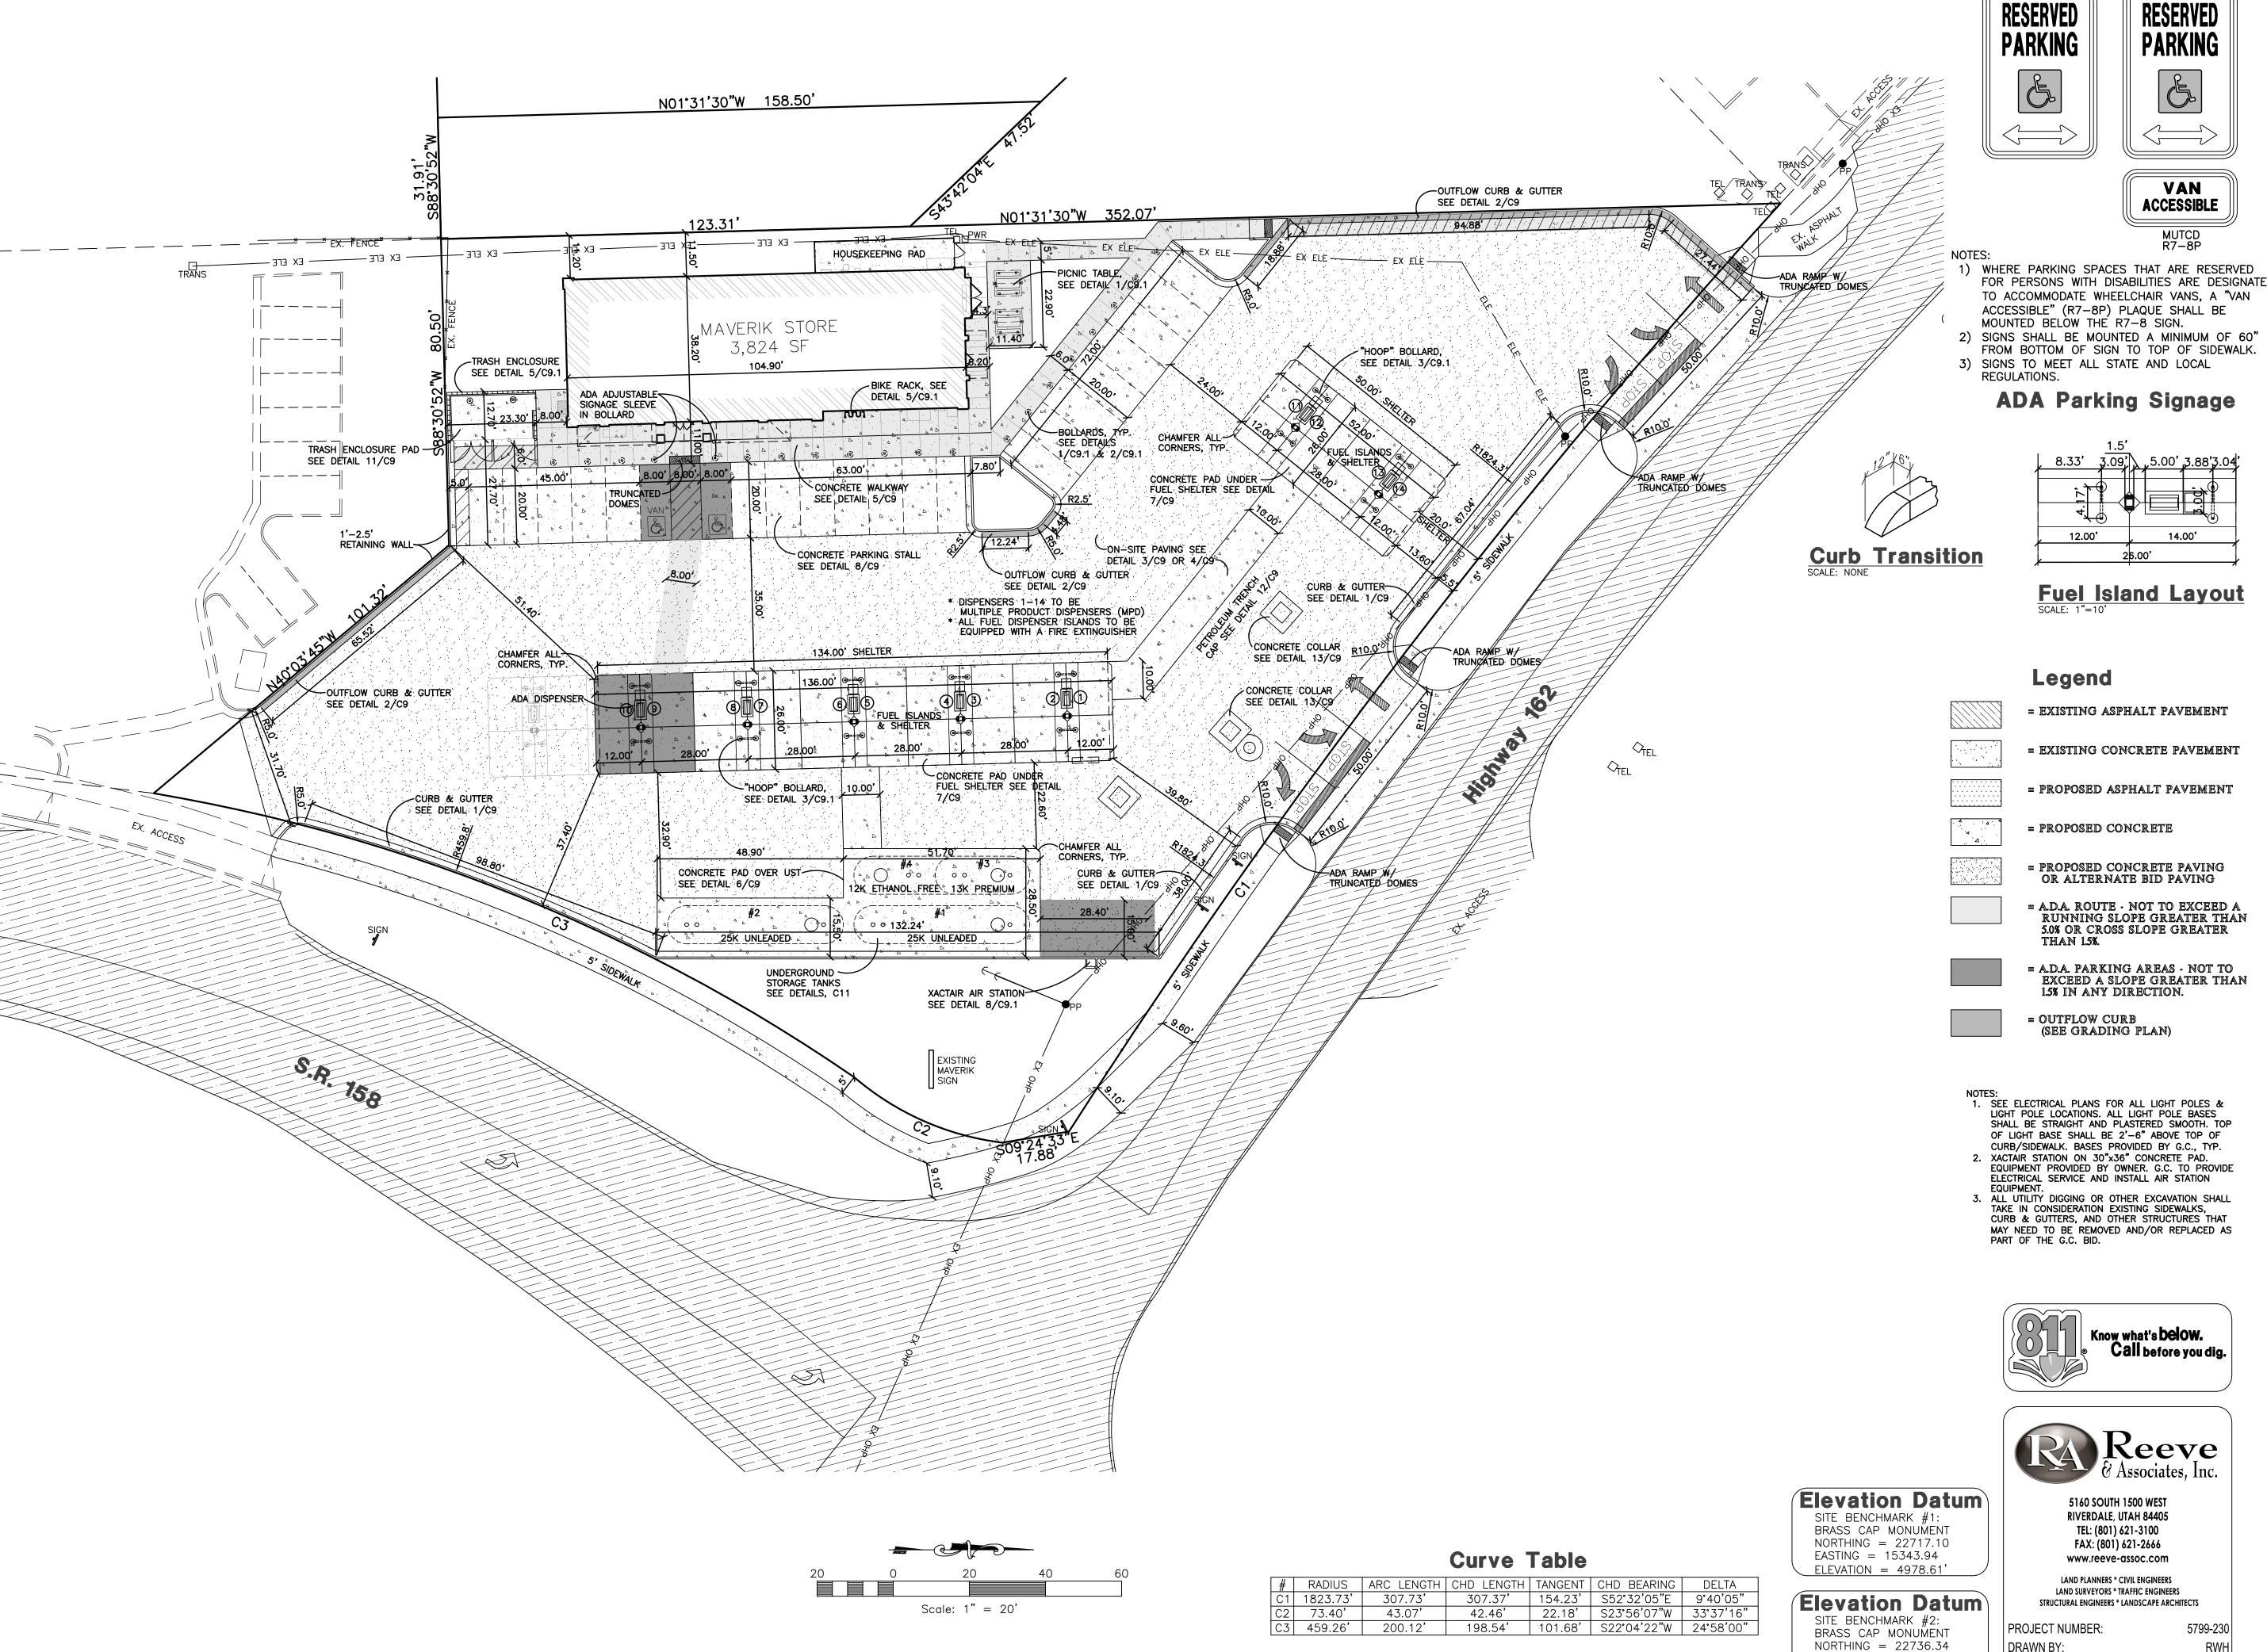

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PROJECT NUMBER

ISSUE DATE:

REVISIONS:

APR. 13, 2018

No. Date Description

Bid documents should not be separated or issued as partial sets to subcontractors. Bidders are responsible for all portions of the documents that pertain to work covered by sub-bids. Bidder assumes full responsibility for error or misinterpretations resulting fro partial sets of Bidding Documents by itself or any sub-bidder.

Conflicting information or errors found in the construction documents should be

brought to the attention of the architect immediatly. In the event of a conflict in the drawings, bidder should not assume the least expensive option will meet the project requirements.

ADVENTURE'S FIRST STOP

2500 UTAI

0

0

PROP SITE I

C6

375328 J. NATE REEVE

50

X X

Fuel Island Layout

14.00'

Legend

MUTCD R7-8

MUTCD R7-8

VAN

ACCESSIBLE

= EXISTING ASPHALT PAVEMENT

= EXISTING CONCRETE PAVEMENT

= PROPOSED ASPHALT PAVEMENT

= PROPOSED CONCRETE

= PROPOSED CONCRETE PAVING OR ALTERNATE BID PAVING

= A.D.A. ROUTE - NOT TO EXCEED A RUNNING SLOPE GREATER THAN 5.0% OR CROSS SLOPE GREATER THAN 1.5%.

= A.D.A. PARKING AREAS - NOT TO EXCEED A SLOPE GREATER THAN 1.5% IN ANY DIRECTION.

= OUTFLOW CURB (SEE GRADING PLAN)

1. SEE ELECTRICAL PLANS FOR ALL LIGHT POLES & LIGHT POLE LOCATIONS. ALL LIGHT POLE BASES SHALL BE STRAIGHT AND PLASTERED SMOOTH. TOP OF LIGHT BASE SHALL BE 2'-6" ABOVE TOP OF CURB/SIDEWALK. BASES PROVIDED BY G.C., TYP.

XACTAIR STATION ON 30"x36" CONCRETE PAD.
 EQUIPMENT PROVIDED BY OWNER. G.C. TO PROVIDE ELECTRICAL SERVICE AND INSTALL AIR STATION

3. ALL UTILITY DIGGING OR OTHER EXCAVATION SHALL TAKE IN CONSIDERATION EXISTING SIDEWALKS, CURB & GUTTERS, AND OTHER STRUCTURES THAT MAY NEED TO BE REMOVED AND/OR REPLACED AS PART OF THE G.C. BID.





5160 SOUTH 1500 WEST **RIVERDALE, UTAH 84405** TEL: (801) 621-3100 FAX: (801) 621-2666 www.reeve-assoc.com

LAND PLANNERS * CIVIL ENGINEERS LAND SURVEYORS * TRAFFIC ENGINEERS STRUCTURAL ENGINEERS * LANDSCAPE ARCHITECTS

PROJECT NUMBER: DRAWN BY: ENGINEER:

EASTING = 12676.29

ELEVATION = 4963.72

135 EAST CENTER STREET, NORTH SALT LAKE, UTAH 84054 PHONE: (801) 936-1343

	CALCULATION SUMMARY			MASTER LUMINAIRE SCHEDULE			
	AREA NAME PARKING	GRID / TYPE 0'-0" / H-H	SPAC GROUP 10.00 <+>	AVE MAX MIN 5.6 51.0 0.0	MAX/MIN AVE/MIN N/A N/A	DESCRIPT. LOW PROFILE, FULL CUTOFF WALL PACK, LED, BLACK, 4K, 7700 LUMENS	MOUNTING LAMPS BALLAST WATTS IMAGE
							WALL INCLUDED 82 CIGHT SPECIFIED BY ARCHITECT
The lighting plan for this project, including the photometric schematic is not in compliance with the Ogden Valley Outdoor Lighting chapter on many levels. The Ordinance is attached to this review. Please read it and propose a new lighting plan that						DESCRIPT. CANOPY MOUNTED, CUTOFF LUMINAIRE, 149W LED, FLAT LENS, FOR SINGLE DECK C	CANOPIES (17,001 LUMENS) CANOPY INCLUDED 149
is in compliance.						DESCRIPT. POLE MOUNTED, CUTOFF LUMINAIRE SINGLE HEAD, LED, 16,000 LUMENS, 25FT SQI	
						T-14 LITHONIA DSX1 LED 60C 700 40K T3M MVOLT SPA DDBXD/SSS 208 2 25 4C DM19 DDB LSI XLCM 3 LED SS 40 UE BLK 4SQB3 S11G 24S	25'-0" POLE INCLUDED 131
						CREE ARE-EDG-3M-DA-10-E-UL-SCBA-525MA-40K/RPSQ-25-4-11-1 T-14A SAME AS T-14 EXCEPT WITH TYPE IV DISTRIBUTION (FORWARD THROW)	S-CREEFINISH 131 262
						DESCRIPT. 4FT LED STRIP LUMINAIRE, COLD WEATHER (O'F), 3000 LUMENS, DAMP LISTED, LEN LSI MLS4 LED HO NW UE UNV EX	97
	+ +	+ + +				T-15	
		1 +0.1 +0.1 +0.2		†o.4		DESCRIPT. LOW PROFILE, FULL CUTOFF WALL PACK, LED, BLACK, 4K, 11,129 LUMENS LITHONIA DSXW2 LED 30C 1000 40K TFTM MVOLT DBLXD 120	WALL INCLUDED 109
	0.2 [†] 0.3 [†] 0.2 [†] 0.2 0.2 [†] 0.2 [†] 0.2 [†] 0.2					T-20	WALL MOLOULD 100
$^{\dagger}0.1$ $^{\dagger}0.2$ $^{\dagger}0.2$ $^{\dagger}0.3$ $^{\dagger}0$						*LUMINAIRES ARE PROVIDED BY OWNER, INSTALLED BY E.C. (REFERENCE SCHEDULE ON	E-4.0)
†0.2 †0.3 †0.4 †0.5 †0.4 †0.4 †0.4 †0.4 †0.4 †0.4 †0.4 †0.4	·						
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$^{+}0.3$ $^{+}0.4$ $^{+}0.9$ $/$ $^{+}2.2$ $^{+}1.9$ $^{+}1.6$ $^{+}1.4$ $^{+}$						′აგ	
†0.3 †0.4 †0.7 †2.1 †2.9 †2.8 †2.5 †2.4 †	2.2 + 1.8 - + 1.6 + 1.5	5+1.4 +1.3+1.3-	⁺ 1.3 ⁺ 1.2 ⁺ 1.1	1.9 +0.9 +0.8 +0.7	⁺ 0.6 ⁺ 0.5 ⁺ 0.3	+0.4 +0.3 +0.2 +0.2 +0.2 +0.2	
$^{+}0.3$ $^{+}0.6$ $^{/+}0.9$ $^{+}3.6$ $^{/+}3.8$ $^{/+}3.7$ $^{+}3.6$ $^{+}4.0$ $^{+}3.8$ $^{/+}3.7$	3.4 +3.0 +2.7 +2.6	6 ⁺ 2.5	⁺ 2.3 ⁺ 2.2 ⁺ 2.0	†1.8 †1.6 1.4 †1.1	†0.9 [†] 0.8 [†] 0.5	+0.4 +0.3 +0.3 +0.3 +0.2 +0.1	
+0.7 +3.6 +9.4 /7.0 +5.1 +5.3 +5.4 +5.6							
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$ \begin{array}{cccccccccccccccccccccccccccccccccccc$	4.8 +4.6 +5.8 +5.8	8 +6.7 +3.1 +1.7	+0.6 +0.1 +0.1	†0.1 †0.1 †1.0 †1.4	1.3 0.3 0.1	○+ <u>0.1</u> ○———	156 North Twelfth Avenue Pocatello, Idaho 83201
\bigg\tau_0.1 \bigg\tau_0.2 \bigg\tau_0.2 \bigg\tau_0.2 \bigg\tau_0.3 \bigg\tau_0.4 \bigg\tau_0.7 \bigg\tau_0.9 \bigg\tau_1.1 \bigg\tau_1.1 \bigg\tau_1.1 \bigg\tau_1.0 \bigg\tau_0.8 \bigg\tau_0.7 \bigg\tau_0.6 \bigg\tau_0.6 \bigg\tau_0.6 \bigg\tau_0.5 \bigg\tau_0.4 \bigg\tau_0.4 \bigg\tau_0.4 \bigg\tau_0.6 \bigg\tau_2.0 \bigg\tau_2.							Ph (208) 232-2577 FAX (208) 234-0918
0.1 [†] 0.1 [†] 0.1 [†] 0.1 [†] 0.2 [†] 0.3 [†] 0.5 [†] 0.6 [†] 0.7 [†] 0.6 [†] 0.5 [†] 0.5 [†] 0.4 [†] 0.4 [†] 0.3 [†] 0.4 [†] 0.7 [†] 0.7							
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							professional service, is the property of NIELSON ENGINEERING, INC. and shall not be used, in whole or in
							part, for any other project without the written permission of an authorized representative of NIELSON ENGINEERING, IN
1 SITE PHOTOMETRIC	C PLAN		-				Unauthorized use will be prosecuted to the fullest extent of the law.
E-1.2 SCALE: 1"=20'-0"							Copyright © 2018

135 EAST CENTER STREET, NORTH SALTLAKE, UTAH 84054

E1.2

PROJECT NUMBER

18313

ISSUE DATE:

April 25, 2018

REVISIONS:

No. Date Description

ADVENTURE'S FIRST STOP

AST & 2500 NORT EDEN, UT

MAVERIK, INC. STORE #250

MAVERIK MODULAR














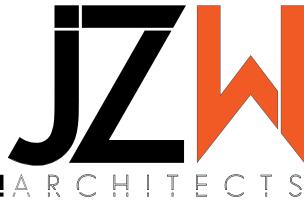



MAVERIK MODULAR

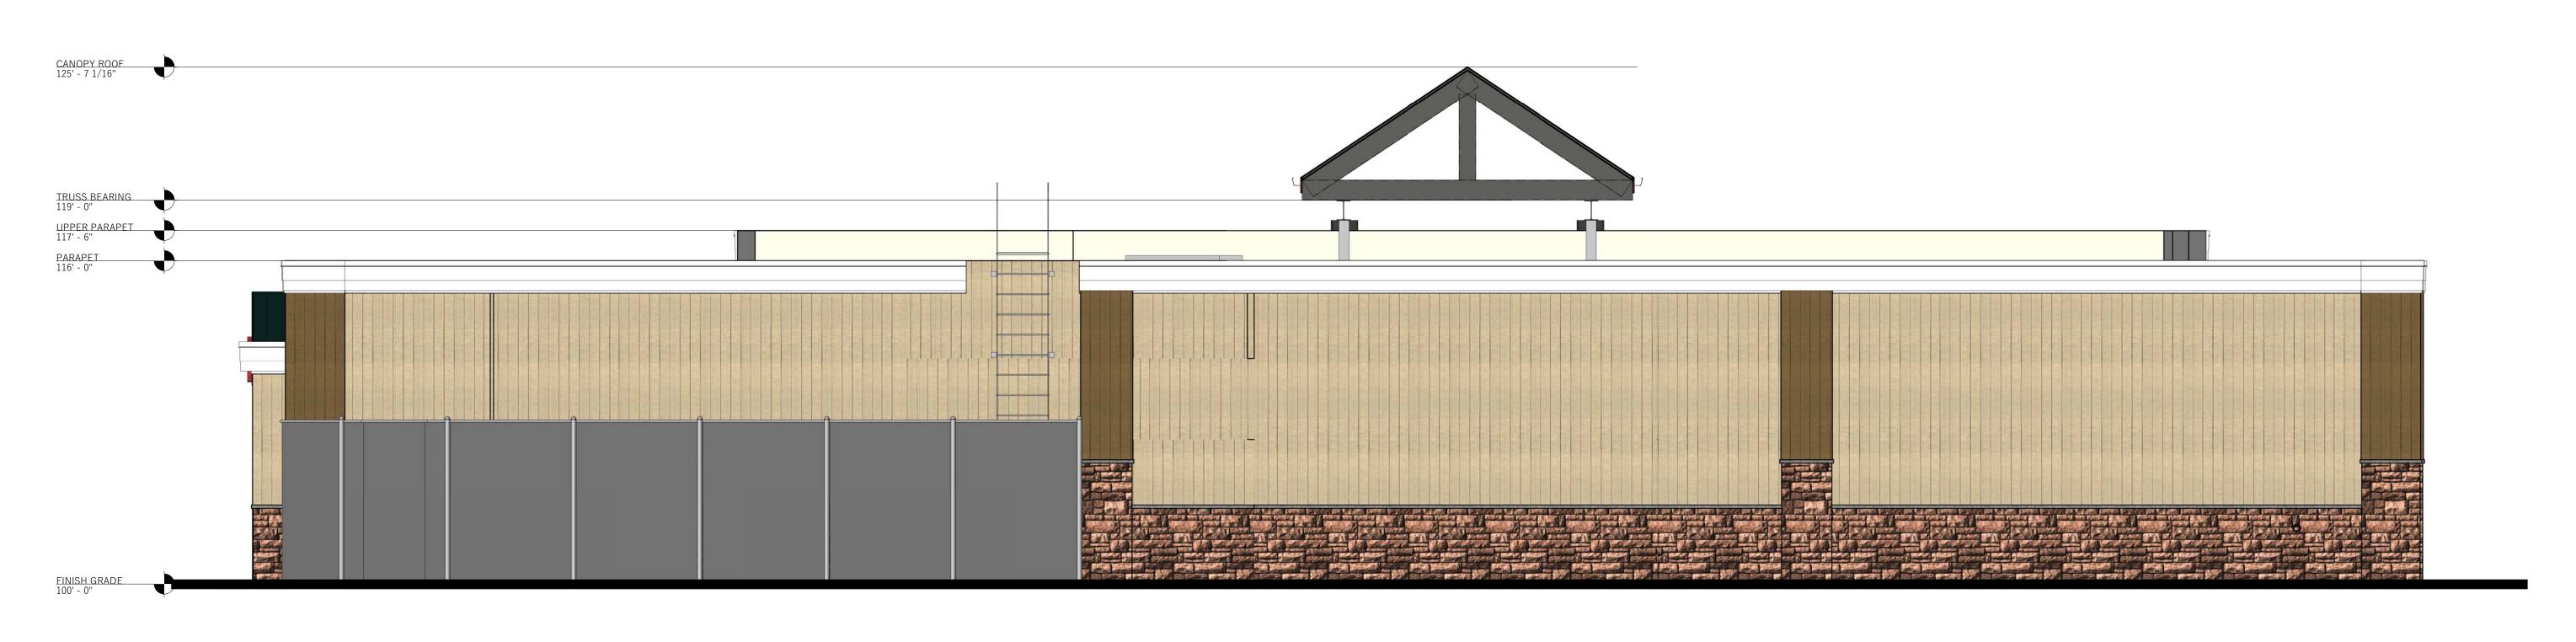



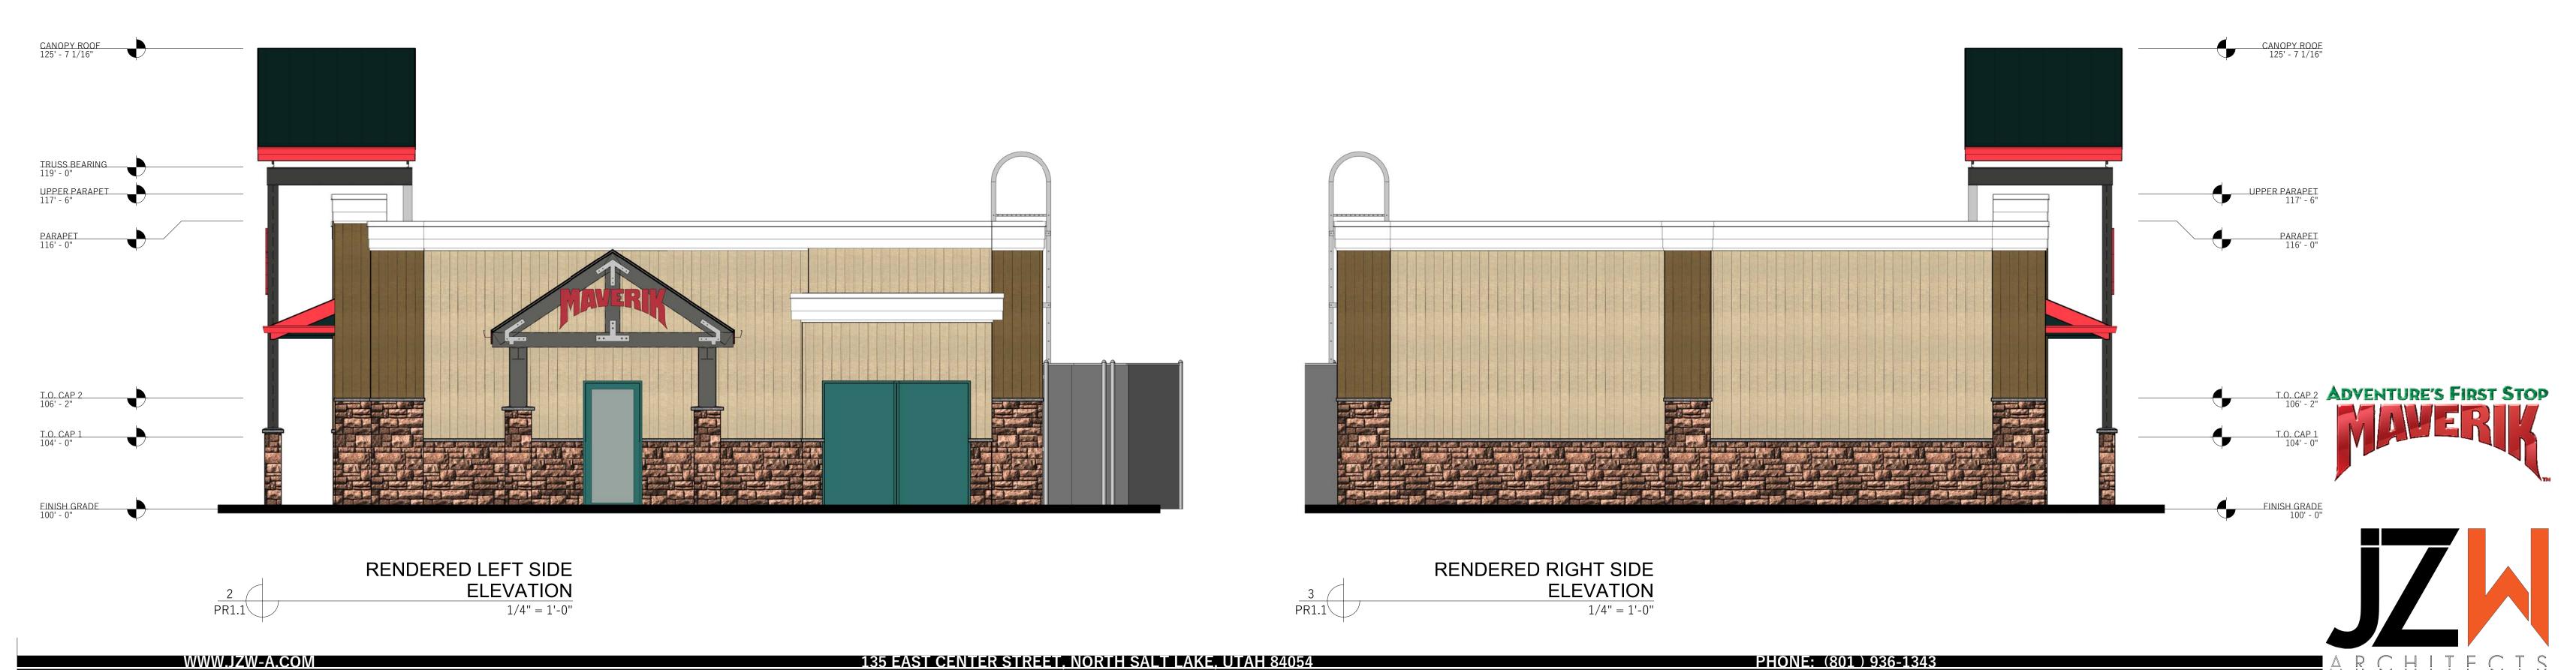

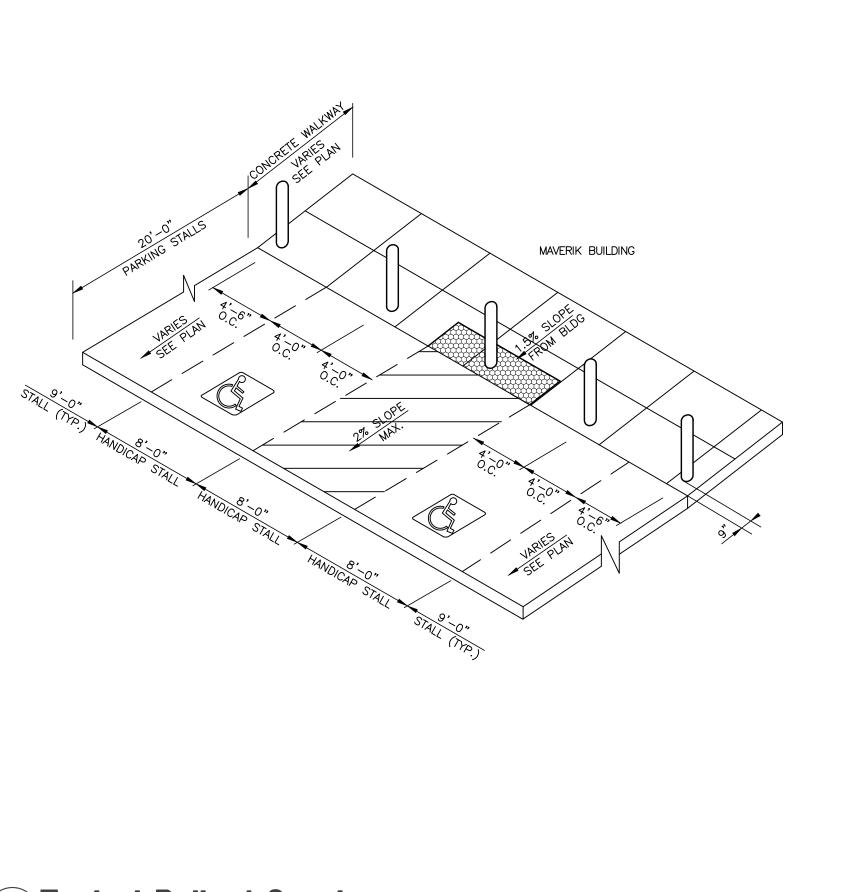

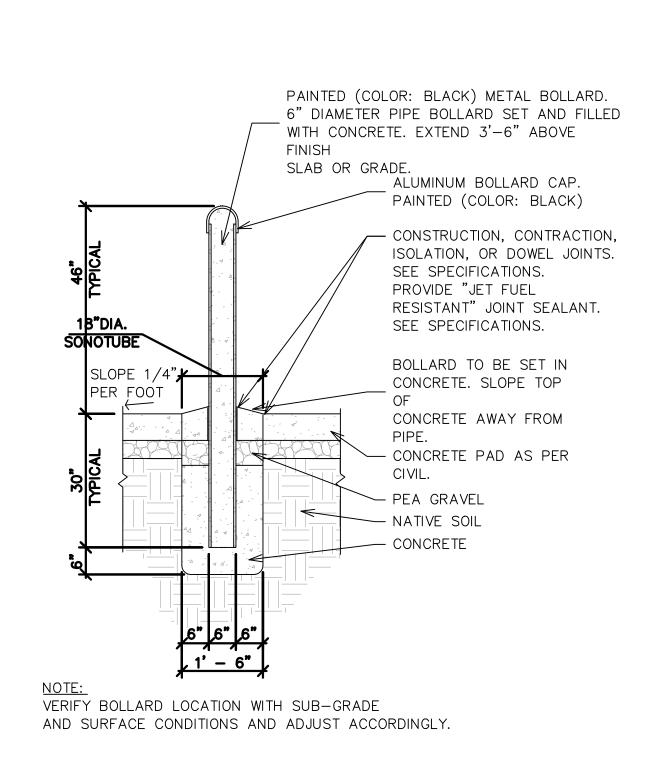



Trash dumpsters. (1) Trash dumpsters shall be located in an area shown on the approved site plan. Specific

approval of this item is required. (2) All trash dumpsters shall be screened from street or public view by a six

foot screening device on three sides. The fourth side shall be a gate constructed of opaque materials. (3) The screening device for a metal dumpster shall be placed adjacent to or on a concrete pad six inches in

thickness. The concrete pad shall match the adjacent grade and paving and provide for positive drainage.

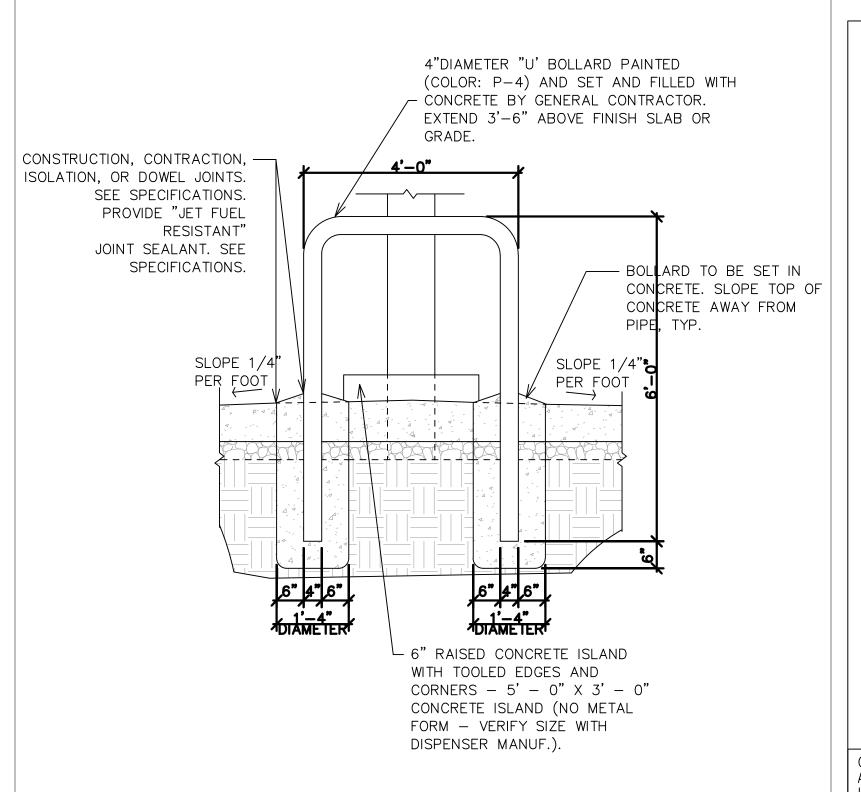

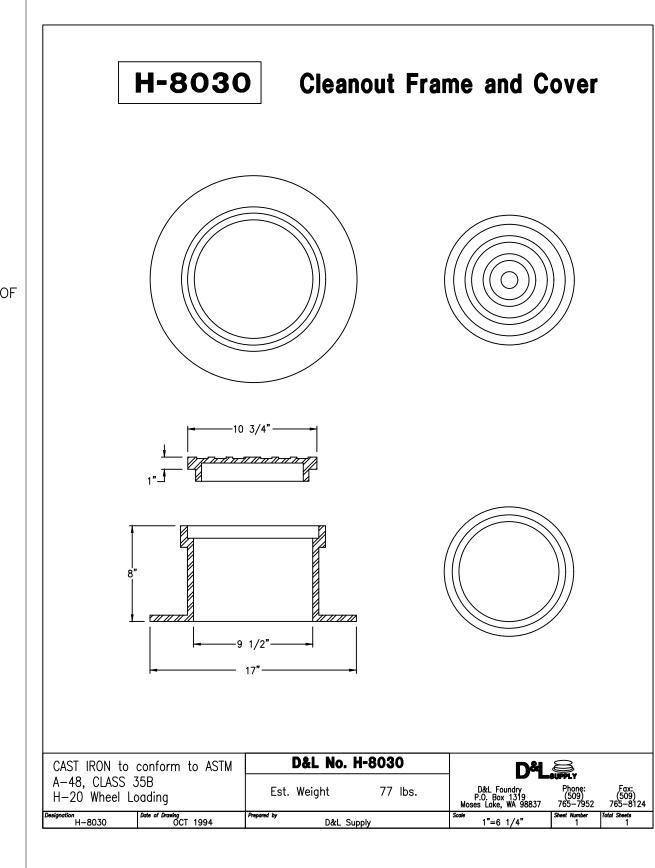









3 "Hoop" Bollard Detail
SCALE: NONE

Clean-Out Frame & Cover
SCALE: NONE

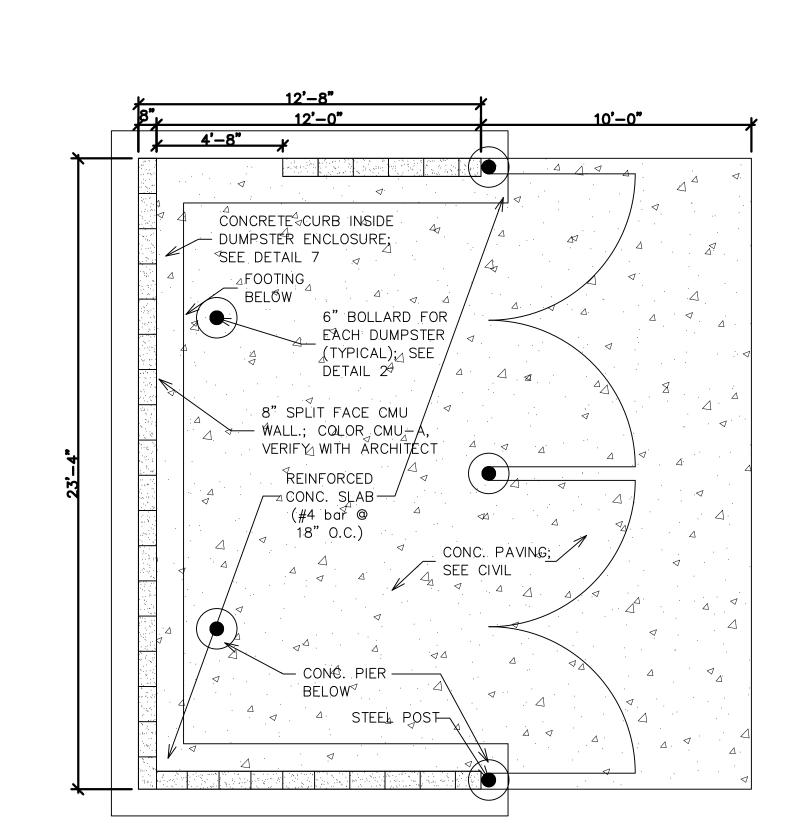

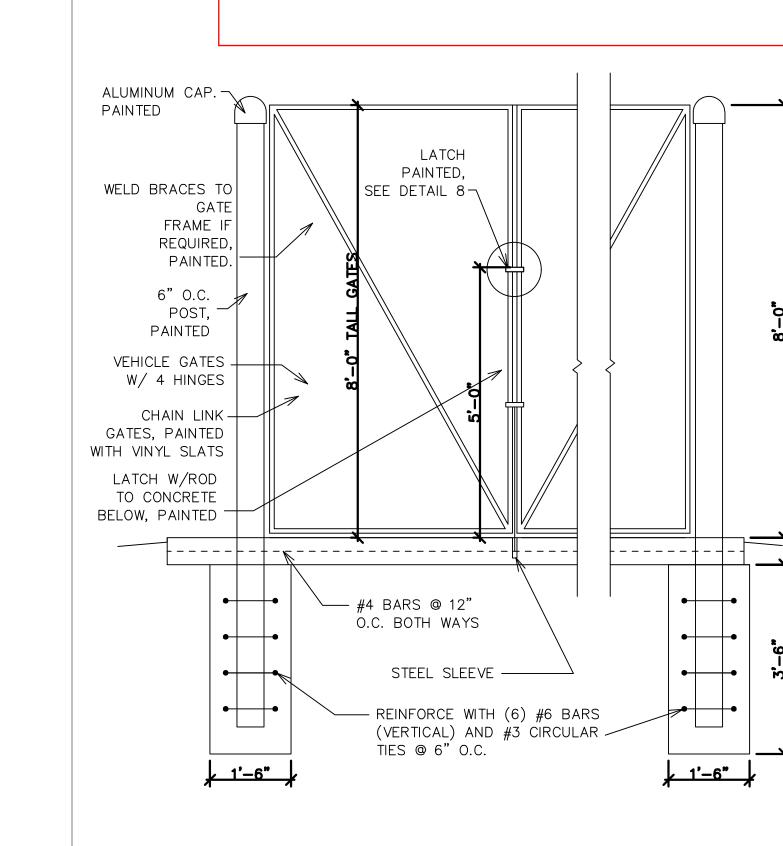

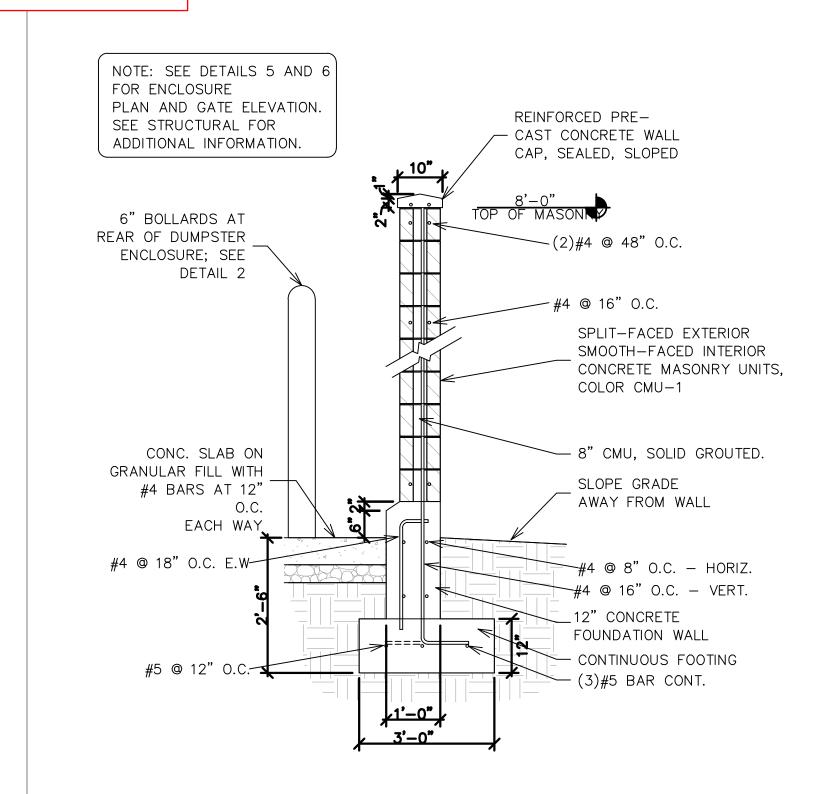

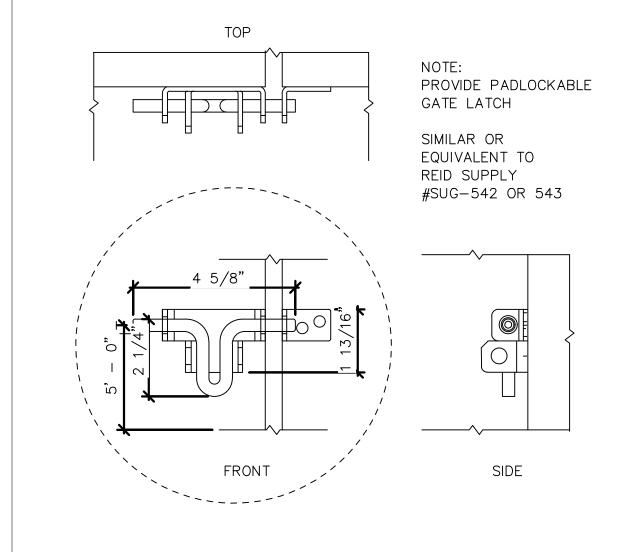



C9.1

PROJECT NUMBER

ISSUE DATE:

APR. 13, 2018

REVISIONS:

No. Date Description

Bid documents should not be separated

subcontractors. Bidders are responsible

for all portions of the documents that

pertain to work covered by sub-bids.

Bidder assumes full responsibility for

error or misinterpretations resulting from partial sets of Bidding Documents by

Conflicting information or errors found in the construction documents should be

brought to the attention of the architect

immediatly. In the event of a conflict in the drawings, bidder should not assume

the least expensive option will meet the

ADVENTURE'S FIRST STOP

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or issued as partial sets to

itself or any sub-bidder.

project requirements.

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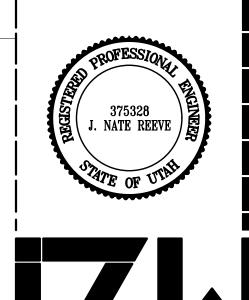
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5 Trash Enclosure Plan SCALE: NONE

6 Trash Enclosure Gate Detail
SCALE: NONE SCALE: NONE

135 EAST CENTER STREET, NORTH SALT LAKE, UTAH 84054

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PHONE: (801) 936-1343

7 Trash Enclosure Wall Section SCALE: NONE

SCALE: NONE