# MEEHAN CABIN

7914 E. HEARTWOOD DRIVE EDEN, UTAH

LloydArchitects

**573 EAST 600 SOUTH** SALT LAKE CITY, UT 84102 PHONE 801.328.3245 WEB LLOYD-ARCH.COM

SEAL

PRINT DATE

MECHANICAL PLUMBING XELECTRICAL XENERGY ACCESSIBILITY FIRE

LAN REVIEW ACCEPTANCE OF DOCUMEN DOES NOT AUTHORIZE CONSTRUCTION T PROCEED IN VIOLATION OF ANY FEDERA STATE, OR LOCAL REGULATIONS.

EST COAST CODE CONSULTANTS, IN

MEM

1296 SF

28'-0"

1588 SF

1296 SF

1586 SF

856 SF

856 SF

730 SF

28'-0" T.O. WALL

4/11/18

PROJECT PHASE RC FINAL REVIEW 01/19/20 PERMIT SUBMITTAL 02/13/20

PERMIT RESPONSE 01 04/11/20

DRAWING REVISIONS

SHEET TITLE

COVER SHEET

SHEET NUMBER

G100

## SHEET INDEX

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CIVIL GENERAL NOTES AND LEGEND SITE AND UTILITY PLAN GRADING PLAN **EROSION CONTROL PLAN** 

C501 **DETAILS** 

### C502 **DETAILS**

PARCEL SURVEY

SITE PLAN **CONSTRUCTION MITIGATION** LANDSCAPE PLAN

LOWER FLOOR

**UPPER FLOOR RCP** NORTH ELEVATION

WEST ELEVATION **BUILDING SECTIONS BUILDING SECTIONS** 

WALL SECTIONS WALL SECTIONS A304

> STAIRS & ENLARGED PLANS **ASSEMBLIES**

> > DOOR & WINDOW SCHEDULE

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**UPPER LEVEL & ROOF FRAMING** 

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SEE PACKAGE BY HELIOCENTRIC

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SELECTIONS

## ARCHITECTURAL DRAWINGS

UPPER FLOOR **ROOF PLAN** 

**DIMENSION PLANS LOWER DIMENSION PLANS UPPER** A105 LOWER FLOOR RCP

EAST ELEVATION SOUTH ELEVATION

**BUILDING SECTIONS** 

STAIRS & ENLARGED PLANS

STRUCTURAL NOTES

FTG. & FOUNDATION & LOWER LEVEL FRAMING

STRUCTURAL DETAILS STRUCTURAL DETAILS

SELECTIONS

## PROJECT TEAM

PROJECT RENDERING

### OWNER **BRYAN & TARA MEEHAN** 450 BELVEDERE AVE BELVEDERE, CA 94920 415-889-5470

TARA@MEEHAN5.COM **DESIGN ARCHITECT** SCHEMATA ARCHITECTS

3-12-7 3F KITA-AOYAMA MINATO-KU

BRYAN@MEEHAN5.COM


TOKYO 107-0061 JAPAN +81 3 6712 5514 INFO@SCHEMATA.JP CONTACT: JO NAGASAKA

EXECUTIVE ARCHITECT LLOYD ARCHITECTS 573 EAST 600 SOUTH SALT LAKE CITY, UTAH 84102 801-328-3245

STRUCTURAL ENGINEER MATT JACKSON STRUCTURAL ENGINEERS 5673 S. REDWOOD RD #22 SALT LAKE CITY, UTAH 84123 801-905-1097 CONTACT: MATT JACKSON

## SCOPE

NEW CONSTRUCTION OF FAMILY CABIN 2 STORES ABOVE GRADE

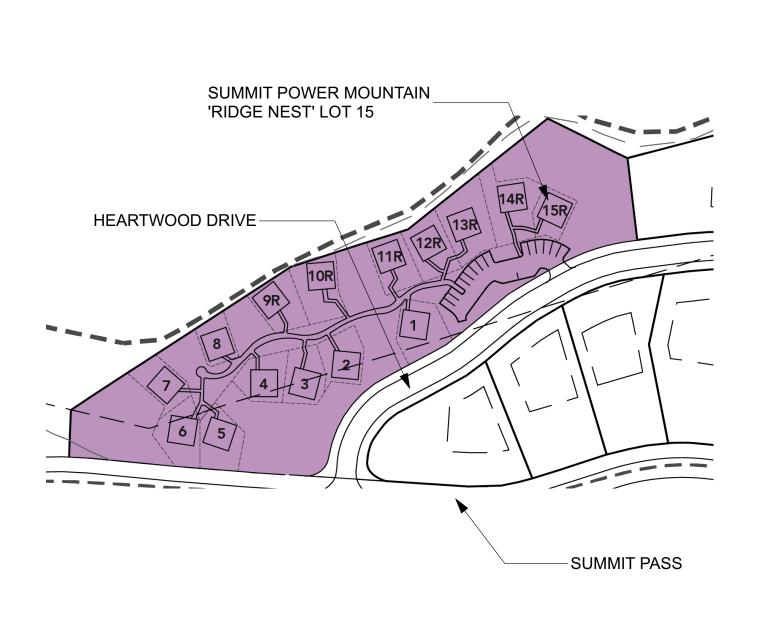

## CODE ANALYSIS

**REVISION INDEX** 

PARCEL ID: ZONE:

**BUILDING USE:** SINGLE FAMILY DWELLING R-3 **OCCUPANCY TYPE:** CONSTRUCTION TYPE:

STORIES ABOVE GRADE: LOT AREA / BUILDABLE AREA:

SETBACKS:

ALLOWABLE HEIGHT/AREA **HEIGHT**: MAX BUILDING AREA: **BUILDABLE FOOTPRINT AREA:** 

ACTUAL HEIGHT/AREA:

**BUILDING AREA:** BUILDING FOOTPRINT AREA:

> LOWER FLOOR CONDITIONED: UPPER FLOOR CONDITIONED:

HEIGHT:

**APPLICABLE CODES:** 

2015 INTERNATIONAL RESIDENTIAL CODE (IRC) 2014 NATIONAL ELECTRICAL CODE (NEC) 2015 INTERNATIONAL PLUMBING CODE (IPC) 2015 INTERNATIONAL MECHANICAL CODE (IMC) 2015 INTERNATIONAL ENERGY CONSERVATION CODE (IECC) 2015 INTERNATIONAL EXISTING BUILDING CODE (IEBC)

CACHE COUNTY 16-111-0015 / SUMMIT RIDGE NEST 15

RR w/ SUMMIT POWDER MOUNTAIN PRUD OVERLAY

(PERMIT REVIEW PERFORMED BY WEBER COUNTY)

NONE: BUILDABLE AREA COINCIDENT TO LOT AREA

2015 INTERNATIONAL FIRE CODE (IFC) 2009 ACCESSIBILITY CODE (ANSI A117.1)

802-453-9434 CONTACT: JOHN EASTERLING

GENERAL CONTRACTOR SAUSAGESPACE CONSTRUCTION SALT LAKE CITY, UTAH 801-301-9648 MARK@SAUSAGESPACE.COM CONTACT: MARK HASLAM

MECHANICAL ENGINEER

HELIOCENTRIC

BRIGHTON, UT 84121

**CIVIL ENGINEER** NV5 / TALISMAN 5217 SOUTH STATE STREET, SUITE 200 MURRAY, UTAH 84107

801-743-1300 CONTACT: WARREN LLOYD CONTACT: RYAN CATHEY

12341 E. WINDFLOWER LANE

- 1. These plan shall be designed and reviewed under 2015 IBC.
- 2. The contractor shall be responsible for obtaining all permits required for construction by the permitting authorities having jurisdiction.
- 3. The contractor shall carefully read, study, and understand all plans and specifications for trades. Coordination between trades will be necessary and the responsibility of the contractor, any questions that arise shall be clarified by the architect prior to construction.
- 4. Drawings are not to be scaled. Dimensional discrepancies are to be clarified with the architect before proceeding with construction.
- 5. The contractor shall verify existing power, water, data cable and other utilities prior to excavation. Contact blue-stakes or authorities having jurisdiction prior to any excavation. 208-2100
- 6. The contractor shall notify the designer of discrepancies in the documents, and of any field conditions that deviate from the documents.
- 7. The architects approval must be obtained for any deviations from the construction documents, including but not limited to changes in dimensions, design, materials, products, and finishes. In no case may the contractor make these changes without the approval of the architect.
- 8. Shop drawings and other submittals are to be submitted for approval by the architect with sufficient time for review prior to execution of work. Submittals must conform to the requirements indicated on construction documents, structural notes, and specifications.
- 9. See door and window schedule for sizes, types, and finishes.
- 10. All construction shall conform to and strictly comply with all applicable codes, covenants, restrictions, and Weber County building standards.
- 11. In no event shall the contractor substitute a standard construction detail for a detail specified in these documents. The contractor shall bring all work into conformity with the construction documents, as the designer orders, before approval of that construction will be granted.
- 12. The contractor is to verify all dimensions, datum & levels prior to construction. Exterior walls are dimensioned from face of exterior wall sheathing or face of concrete unless otherwise noted. Exterior wall studs at heated spaces shall be 2x6 except as noted. All other wall studs shall be 2x4 except where noted otherwise on construction documents.
- 13. Glazing in locations subject to human impact such as panes in doors, glazing within 12" of door opening, glazing within 18" of floor, and shower doors shall be tempered or laminated safety glass as per 2012 IBC.
- 14. Provide and install smoke detectors as per 2015 IBC.
- 15. Provide attic access, minimum 22" x 30" with minimum 30" headroom at unobstructed readily accessible opening as per 2015 IBC.
- 16. Building shall comply with Utah State Energy Code. The contractor is to seal and caulk all cracks to prevent air infiltration. The contractor shall insulate the walls to R-19, ceilings to R-38, and floors over unheated spaces to R-38 unless otherwise noted.
- 17. These drawings are the exclusive property of Lloyd Architects and may be reproduced only with the written permission of the architect. Authorized reproductions must bear the name of the architect.
- 18. Fireplaces shall conform to 2012 IBC. UL listing on fireplaces are as follows: Wood burning units, UL#MH5850 Enclosed gas units; ICBO #4030
- 19. SITE PLAN & GRADING: remove stumps, shrubs and clear and grub site near house as indicated on site plans including legal off-site disposal of all debris and unusable fill. Scrape topsoil layer before excavation and place onsite for finish landscape use. Excavate, trench, and backfill as required for footings, foundations, slabs, utility lines, mechanical, electrical and other work below grade required to complete the project. Maintain excavation free of water and provide an adequate system for the handling and removal of surface
- 20. Contact the Utah Division of Air Quality on all remodel projects: 536-4000

### **FOUNDATION**

- 1. GEOTECHNICAL: SOIL BEARING: Assume 1500 psf soil load pressure per R401.4. CONCRETE: 3,000 psi in slabs and footings, 3000 psi in foundation walls, 3500 psi in garage slab and exterior steps.
- 2. CONCRETE FOOTING SIZES AND DEPTH: see footing schedule on structural sheets (minimum footing size 9" by 20", minimum depth 30" below grade). MINIMUM REBAR: see structural sheets for minimum reinforcing requirements.
- 3. ANCHOR BOLTS TO FOUNDATION: minimum 7" embedment per R403.1.6(maximum spacing allowed by code is 32" O.C.)
- 4. CONCRETE FOUNDATION WALLS: see structural drawings for size and reinforcing.
- 5. HEIGHT ABOVE FINISHED GRADE: concrete foundation wall to be 6" minimum above finish grade. Use treated sill plate where required
- 6. FOUNDATION WALL DAMP-PROOFING AND FOUNDATION DRAIN: bituminous coating or equal to be applied on basement walls per R406. Foundation drain to be installed by new footings per R405.
- 7. PLATE WASHERS: All plate washers to be 3"X3"X.227" (1/4") square slotted plate per R602.11.1
- 8. WINDOW WELLS AND LADDERS: 9 sq ft min area, 36 inches out from window, if deeper than 44 inches affix a ladder.
- 9. BACKFILL: not to be placed adjacent to basement walls until bracing is in place per IRC R404.1.7

### **CONSTRUCTION**

- 1. EMERGENCY ESCAPE AND RESCUE OPENINGS: 44 inches max above floor, in every sleeping room, 5.7 sq ft or 5 sq ft if within 44 inches of grade, 20 inch min width, 24 inch min height.
- 2. EXIT DOORS AND HALLWAYS: one 3'-0" x 6'-8" door required, 36 inch min. width in hallways.
- 3. LANDINGS AT DOORS AND STAIRWAYS: 36" min. out from door and door width minimum.
- 4. RAMPS, SLOPES AND RAILS: maximum slope 1 in 8, railing required on ramps over 1 in 12 slope.
- 5. STAIRWAYS: 36" width minimum, TREADS AND RISERS: 8" rise and 9" tread minimum, HEADROOM: 6'- 8" minimum, UNDER STAIR PROTECTION: 1/2" GWB, HANDRAILS: required with (2) or more risers, 34" to 38" in height and 1 1/4 to 2 5/8" in diameter if circular.
- 6. GUARDRAILS (GUARDS): required at floors over 30" above grade, 36" min. height, a 4"sphere shall not pass through with design as to eliminate ladder
- 7. LUMBER PROTECTION AGAINST DECAY: 18" minimum to grade under floor joists, 12" minimum to grade under floor girders. Provide treated plate on concrete slab less than 8" above exposed ground and framing and siding less than 6" from the ground. All lumber in contact with concrete, earth, or within 18" of finish grade shall be pressure treated. Pressure treat above ground items with water-borne preservatives complying with AWPB LP-2. Wood members in contact with ground shall be pressure treated with water-borne preservative complying AWPB LP-22.
- 8. WOOD COLUMNS: required to be 1" above the floor or finish grade, See structural for connection to foundation or slab.
- 9. MINIMUM AREA DIMENSIONS AND HEIGHTS: see all plan sheets for room sizes. All room minimums shall be: (1) 120 sf room. 70 sf bedrooms. 50 sf kitchen, 7 feet min. heights, sloping to 5 feet min. 3 feet min. passageways in kitchens
- 10. INTERIOR MOISTURE VAPOR RETARDERS: on "warm-in-winter" side of wall.

### WALL CONSTRUCTION

- 1. INTERIOR WALL COVERINGS: 5/8" GWB. Green Gyp. board to be limited to R702.3.8.1 for no direct contact to moisture.
- 2. EXTERIOR WALL COVERINGS AND WEATHER BARRIERS: 15# felt paper or approved equal.
- 3. STRUCTURAL COLUMNS: see structural sheets for all column sizes and
- 4. MID-HEIGHT BRIDGING: in unfinished walls
- 5. BRACED WALL LINES AND PANELS: see structural notes. Minimum requirement are to provide within 12'-6" of wall corner, at 4'-0" in length for plywood w/ nailing @ 6" O.C. @ edges and 12" O.C. in field, at 8'-0" for GWB w/ screws @ 7" O.C. @ edges and field. DOORS AND WINDOWS
- 6. HABITABLE ROOMS AND BATHROOMS: 8% of area in glazing, 4% in openings, and 3 sf window in bathrooms or bathrooms to have exhaust fan per IRC 303.3
- 7. GARAGE SEPARATION FROM DWELLING: 1 hour separation. Walls shall have 1/2" GWB on walls and attic. If garage is below habitable rooms the ceiling shall have 5/8" type "X" GWB. Door shall have a 20 min. fire-resistance rating and shall be self-closing.
- 8. SHOWER COMPARTMENTS: NON-ABSORBENT FLOORS AND WALLS TO BE PROVIDED FOR SHOWER COMPARTMENTS MIN 72" ABOVE F.F.; PER IRC R307.2

### **FLOOR CONSTRUCTION**

- 1. FLOOR JOISTS: double joists under bearing partitions and blocking shall be installed at bearing walls.
- 2. DRAFT-STOPPING: shall be installed in all concealed spaces over 1,000 sq ft.
- 3. FIREBLOCKING: shall be installed in all concealed spaces at 10'-0" O.C.
- 4. SUBFLOOR SHEATHING: see structural sheets for all floor sheathing callouts (minimum requirements are as follows; 5/8 inch thick tongue & groove osb for ioists @ 16" to 20" O.C. and 3/4" thick tongue & groove osb @ 24" O.C.)
- 5. FLOOR JOISTS SUPPORTING BEARING PARTITIONS OFFSETS: offset minimum floor joist depth.
- 6. EXPOSED LAMINATED TIMBERS: ATIC Rated Architectural grade Glu-laminated Timbers: See structural sheets for sizes and locations. not applicable
- 7. EXTERIOR DECKS: exposed structural framing, support joists, and beams not sheltered by roof or eaves shall be constructed with naturally durable wood or pressurepreservative-treated wood as required by IRC R317.1.3.

### **ROOF CONSTRUCTION**

- 1. ROOF FRAMING: see structural sheets pre-engineered truss type and layout. Submit shop drawings to architect/engineer for approval. Truss packet to be reviewed and signed by Engineer of Record. R802.10.1.
- 2. ATTIC VENTILATION: Provide a 1 to 150 sq.ft. (or 1 to 300 if 50% is in soffit and 50-80% located more than 3'0" above soffits) of the attic area in ventilation. Provide insulation baffles to insure air flow through space. Cut or drill holes in truss blocking for vent air passage from soffit vents.
- 3. ROOF SLOPES and DRAINAGE: felt paper, 1/4" per foot minimum. provide "ice and water shield" at all valleys U.N.O.
- 4. ICE DAM PROTECTION: "ice and water shield" at eaves to 36" inside the wall plane of the building
- 5. CHIMNEY TERMINATION: chimney shall be 2'-0" higher than any portion of building within 10'-0", 3'-0" tall minimum.

### **MASONRY**

- 1. MASONRY VENEERS, AND TIES: see structural sheets, provide minimum brick ties at 16 inches on center in either direction, with horizontal 9 gage wire mechanically attached to ties (if applicable)
- 2. LINTELS: see structural drawings for lintel sizes and locations. SHEARWALLS & HOLDDOWN SCHEDULE: see structural sheets

### **MECHANICAL**

- 1. GAS FIREPLACE: ICBO #4030 on typical gas unit
- 2. FIREPLACE HEARTHS: Extend 20" min. from front of firebox and 12" min. extension on both sides.
- 3. RES-CHECK: 2009 IECC See attached REScheck report.
- 4. CENTRAL FURNACE, CLEARANCE, ACCESS, PLATFORM, LIGHT: provide 3" side and rear of platform, space is 12 inches wider than furnace, 6 inches in front if door or 30 inches in front, 30 x 30 inch access platform with light
- 5. BTU SIZES OF WATER HEATERS, FURNACES: see mechanical drawings for all mechanical sizing.
- 6. COMBUSTION AIR: provide duct or opening within 12 inches of ceiling and size of 1 sq inch for every 3000 btu/h.
- 7. ELEVATION OF COMBUSTION SOURCE OF APPLIANCES: appliances having an ignition source shall be elevated such that source is not less than 18" above floor. Rooms that are not part of the living space which communicate with a private garage through openings shall be considered to be a part of the garage; see plans
- 8. APPLIANCE PROTECTION FROM IMPACT: N/A (mechanical not in garage).
- 9. CONDENSATE DISPOSAL: provide an indirect drain, secondary condensate if located in attic or on wood floor (to be trap seal primer type)
- 10. GAS LINE SCHEMATIC: See mechanical sheets.
- 11. WATER HEATERS, LOCATIONS, EXPANSION TANKS, AND PRESSURE RELIEF VALVES: can not be located in closets, bedrooms, or bathrooms. If located within sealed enclosures provide combustion air vent. Direct-vent water heaters are okay. Provide and install high-efficiency radiant hydronic heat system including connection of hot water storage tank, gas hot water heaters and piping from the hot water tank to all fixtures as indicated in drawings. Installation shall conform to all local codes, ordinances and regulations pertaining to this work. Manifold and thermostat locations to be approved by the Architect. Provide trap seal primer type drain at water heaters.
- 12. WATER HEATER ANCHORAGE, FLOOR DRAIN, AND PANS FOR DRAINAGE: provide seismic strap to top third and bottom third of water heater. Provide an indirect drain for water heaters. Provide pan for water heaters on wood floors.
- 13. CLOTHES DRYER EXHAUST: maximum 25'-0" to outside with 5'-0" reduction for 90 degree bends
- 14. EXHAUST VENT TERMINATIONS: 4'-0" below or beside and 1'-0" above doors or windows, 12" above grade
- 15. SHOWER SIZE AND DOOR: 900 sq inches and 30" diameter, door swings outward
- 16. HEATING: new construction to have a gas fired forced air furnace with air conditioning condenser unit. Heating facility to maintain 68 degrees.

### **PLUMBING**

- 1. WATER PIPING: Shall be pex.
- 4. FLOOR DRAINS: Deep seal or Trap seal primer required in laundry or
- 5. WASTE INTERIOR TO BE ABS, WASTE INTERIOR UNDER SLAB AND
- 6. BACK WATER VALVE: required to protect plumbing fixtures located below the elevation level of the nearest upstream man hole cover. Fixtures that are above the elevation level of
- 7. SHOWER COMPARTMENTS: non-absorbent floors and walls (up to 72" above finished
- 8. MAXIMUM FLOW RATES AND CONSUMPTION: for plumbing fixtures and fittings per IRC

Lavatory faucet: 2.2 gpm at 60 psi 2.5 gpm at 80 psi

P2708.3 and 2713.1

11. WATER HAMMER ARRESTORS: required at quick-close valves such as dishwashers and

### **ELECTRICAL**

- 5. GFCI PROTECTION: see electrical sheets for all locations. Provide in bathrooms and jetted tub motors, garage, outdoor, crawlspace, kitchen
- 6. LIGHTING WALL SWITCHES: see electrical drawings for all switch locations. Electrical sub-contractor to walk through project with owner to verify all electrical fixture locations prior to commencing work. Follow all local
- 7. RECEPTACLES AND LIGHTING IN DAMP AND WET LOCATIONS: provide weatherproof covers for outlets, lighting to be listed for wet or damp locations.
- 8. LIGHT FIXTURES IN CLOSETS: incandescent fixtures 12" minimum to storage, fluorescent fixtures 6" minimum to storage
- 9. SUPPORT OF CEILING FANS: as per manufacturer's recommendations.
- 10. ELECTRICAL: all wiring to be in accordance with the National Electrical Code and applicable local codes. Locate main panel and meter where indicated on the Drawings. Provide underground power connection from source to main panel.80.
- 11. SMOKE DETECTORS: locate (1) inside each sleeping room, in corridors outside sleeping rooms, and on each level. All smoke detectors to be wired
- 12. CO2 DETECTORS: Locate (1) on each level
- 13. OUTLETS: tamper resistant per IRC E4002.14

- 2. VENT PIPING: shall be ABS.
- 3. HOSE CONNECTION BACKFLOW PREVENTER: provide at all exterior hose bib locations. Use frostproof type with vacuum breaker.
- mechanical rooms per IBC 3201.2
- **EXTERIOR TO BE ABS.**
- the manhole cover shall not discharge through the backwater valve.
- floor) required for shower compartments; per IRC R307.2

Shower head: Sink faucet: 2.2 gpm at 60 psi 1.6 gallons per flushing cycle Water closet:

- 9. TEMPERATURE LIMITING DEVICES: set at 120F for bathtubs and showers per IRC
- 10. SEDIMENT TRAPS: provide on downstream side of shutoff valve per G2419.4.
- clothes washers per P2903.5

- 1. WHIRLPOOL BATHTUB ACCESS PANEL: see plans for size and locations.
- 2. ELECTRICAL SERVICE PANEL LOCATION: shall not be located in bathrooms or firewalls, provide 30" clearance side to side and 36" clearance in front. Provide a minimum of 6'-6" in height.
- 3. RECEPTACLE OUTLETS: see electrical drawings for all outlet locations. Electrical sub-contractor to walk through project with owner to verify all electrical fixture locations prior to commencing work. Follow all local electrical
- 4. ARC-FAULT CIRCUIT-INTERRUPTER PROTECTION: provide in bedrooms.
- counters, kitchen islands, and wet-bar.
- electrical codes.

- 14. NON-METALLIC SHEATHED CABLES (ROMEX): when two are more are installed together in the same space without maintaining space between them and where the opening they are installed in is filled with caulking, foam insulation, or other types of insulation, conductors must be derated per IRC E3705.4.4

SHEET TITLE

LlovdArchitects

**573 EAST 600 SOUTH** 

SALT LAKE CITY, UT

84102

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PERMIT SUBMITTAL 02/13/20

PERMIT RESPONSE 01 04/11/20

DRAWING REVISIONS

NOTES & **LEGENDS** 

PLAN REVIEW ACCEPTANCE SHEET NUMBER FOR COMPLIANCE WITH THE APPLICABLE **X**BUILDING □STRUCTURAI

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MECHANICAL PLUMBING XELECTRICAL XENERGY

VEST COAST CODE CONSULTANTS, INC

DATE: 04/18/18

ACCESSIBILITY FIRE


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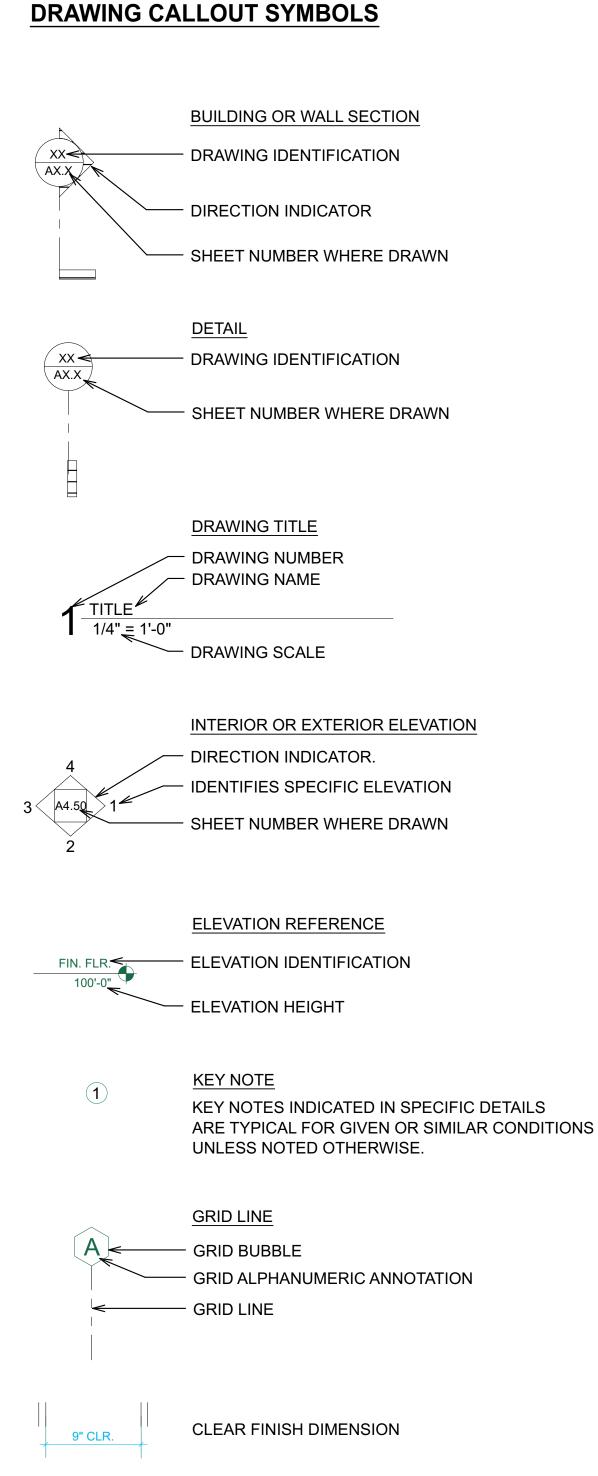
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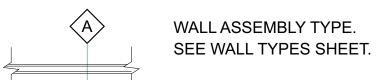
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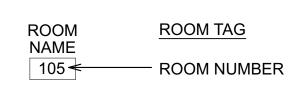
NOTE: DIMENSIONS IN THESE DRAWINGS ARE GENERALLY PLACED AS INDICATED BELOW, UNLESS NOTED OTHERWISE


- 1. MASONRY: TO UNFINISHED FACE (NOTE @ SPLIT FACE CONDITION THESE DRAWINGS ASSUME STANDARD 8" OR 12" WIDE BLOCK)
- 2. CONCRETE: TO UNFINISHED FACE 3. STRUCTURAL: TO STEEL OR TUBING FACE OR CENTER LINE
- 4. COLUMNS: CENTER LINE
- 5. NONBEARING PARTITIONS: TO FACE OF STUD. SEE NOTE 9 BELOW
- 6. THE CONTRACTOR SHALL BE RESPONSIBLE FOR COORDINATING ALL ARCHITECTURAL DIMENSIONS TO ASSURE PROPER PLACEMENT OF ALL PARTS AND MATERIALS IN CONJUNCTION WITH ALL OTHER DISCIPLINES REPRESENTED IN THESE DOCUMENTS, PRIOR TO COMMENCING WORK.
- 7. VERIFY ALL DIMENSIONS INCLUDING SITE CONDITIONS BEFORE STARTING WORK.
- 8. WRITTEN DIMENSIONS SHALL TAKE PRECEDENCE OVER SCALE.
- 9. DIMENSION GRAPHICS:







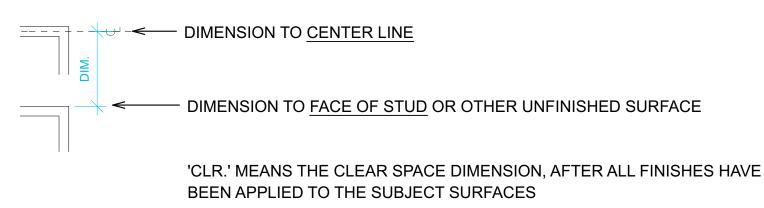


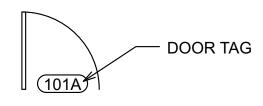


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CEILING HEIGHT


### DRAWING GRAPHIC SYMBOLS

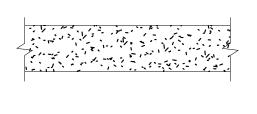

CONCRETE OR CEMENTITIOUS MATERIAL

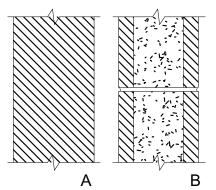


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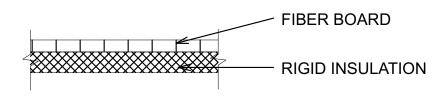


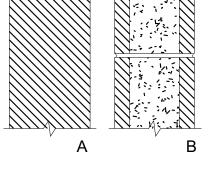
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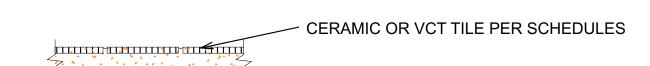
**CEMENT PLASTER** 





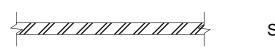


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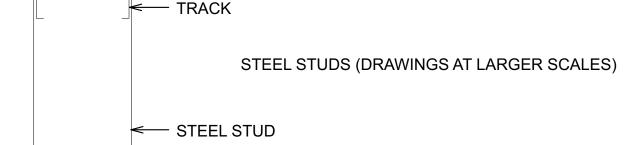


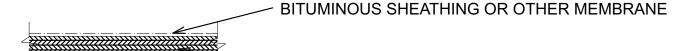







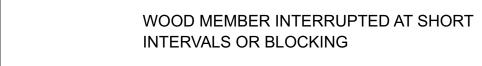

OR COMPLIANCE WITH THE APPLICABL STRUCTURAL **▼**MECHANICAL **▼**PLUMBING XELECTRICAL XENERGY ROCEED IN VIOLATION OF ANY FEDE STATE, OR LOCAL REGULATIONS. DATE: 04/18/18 VEST COAST CODE CONSULTANTS, IN

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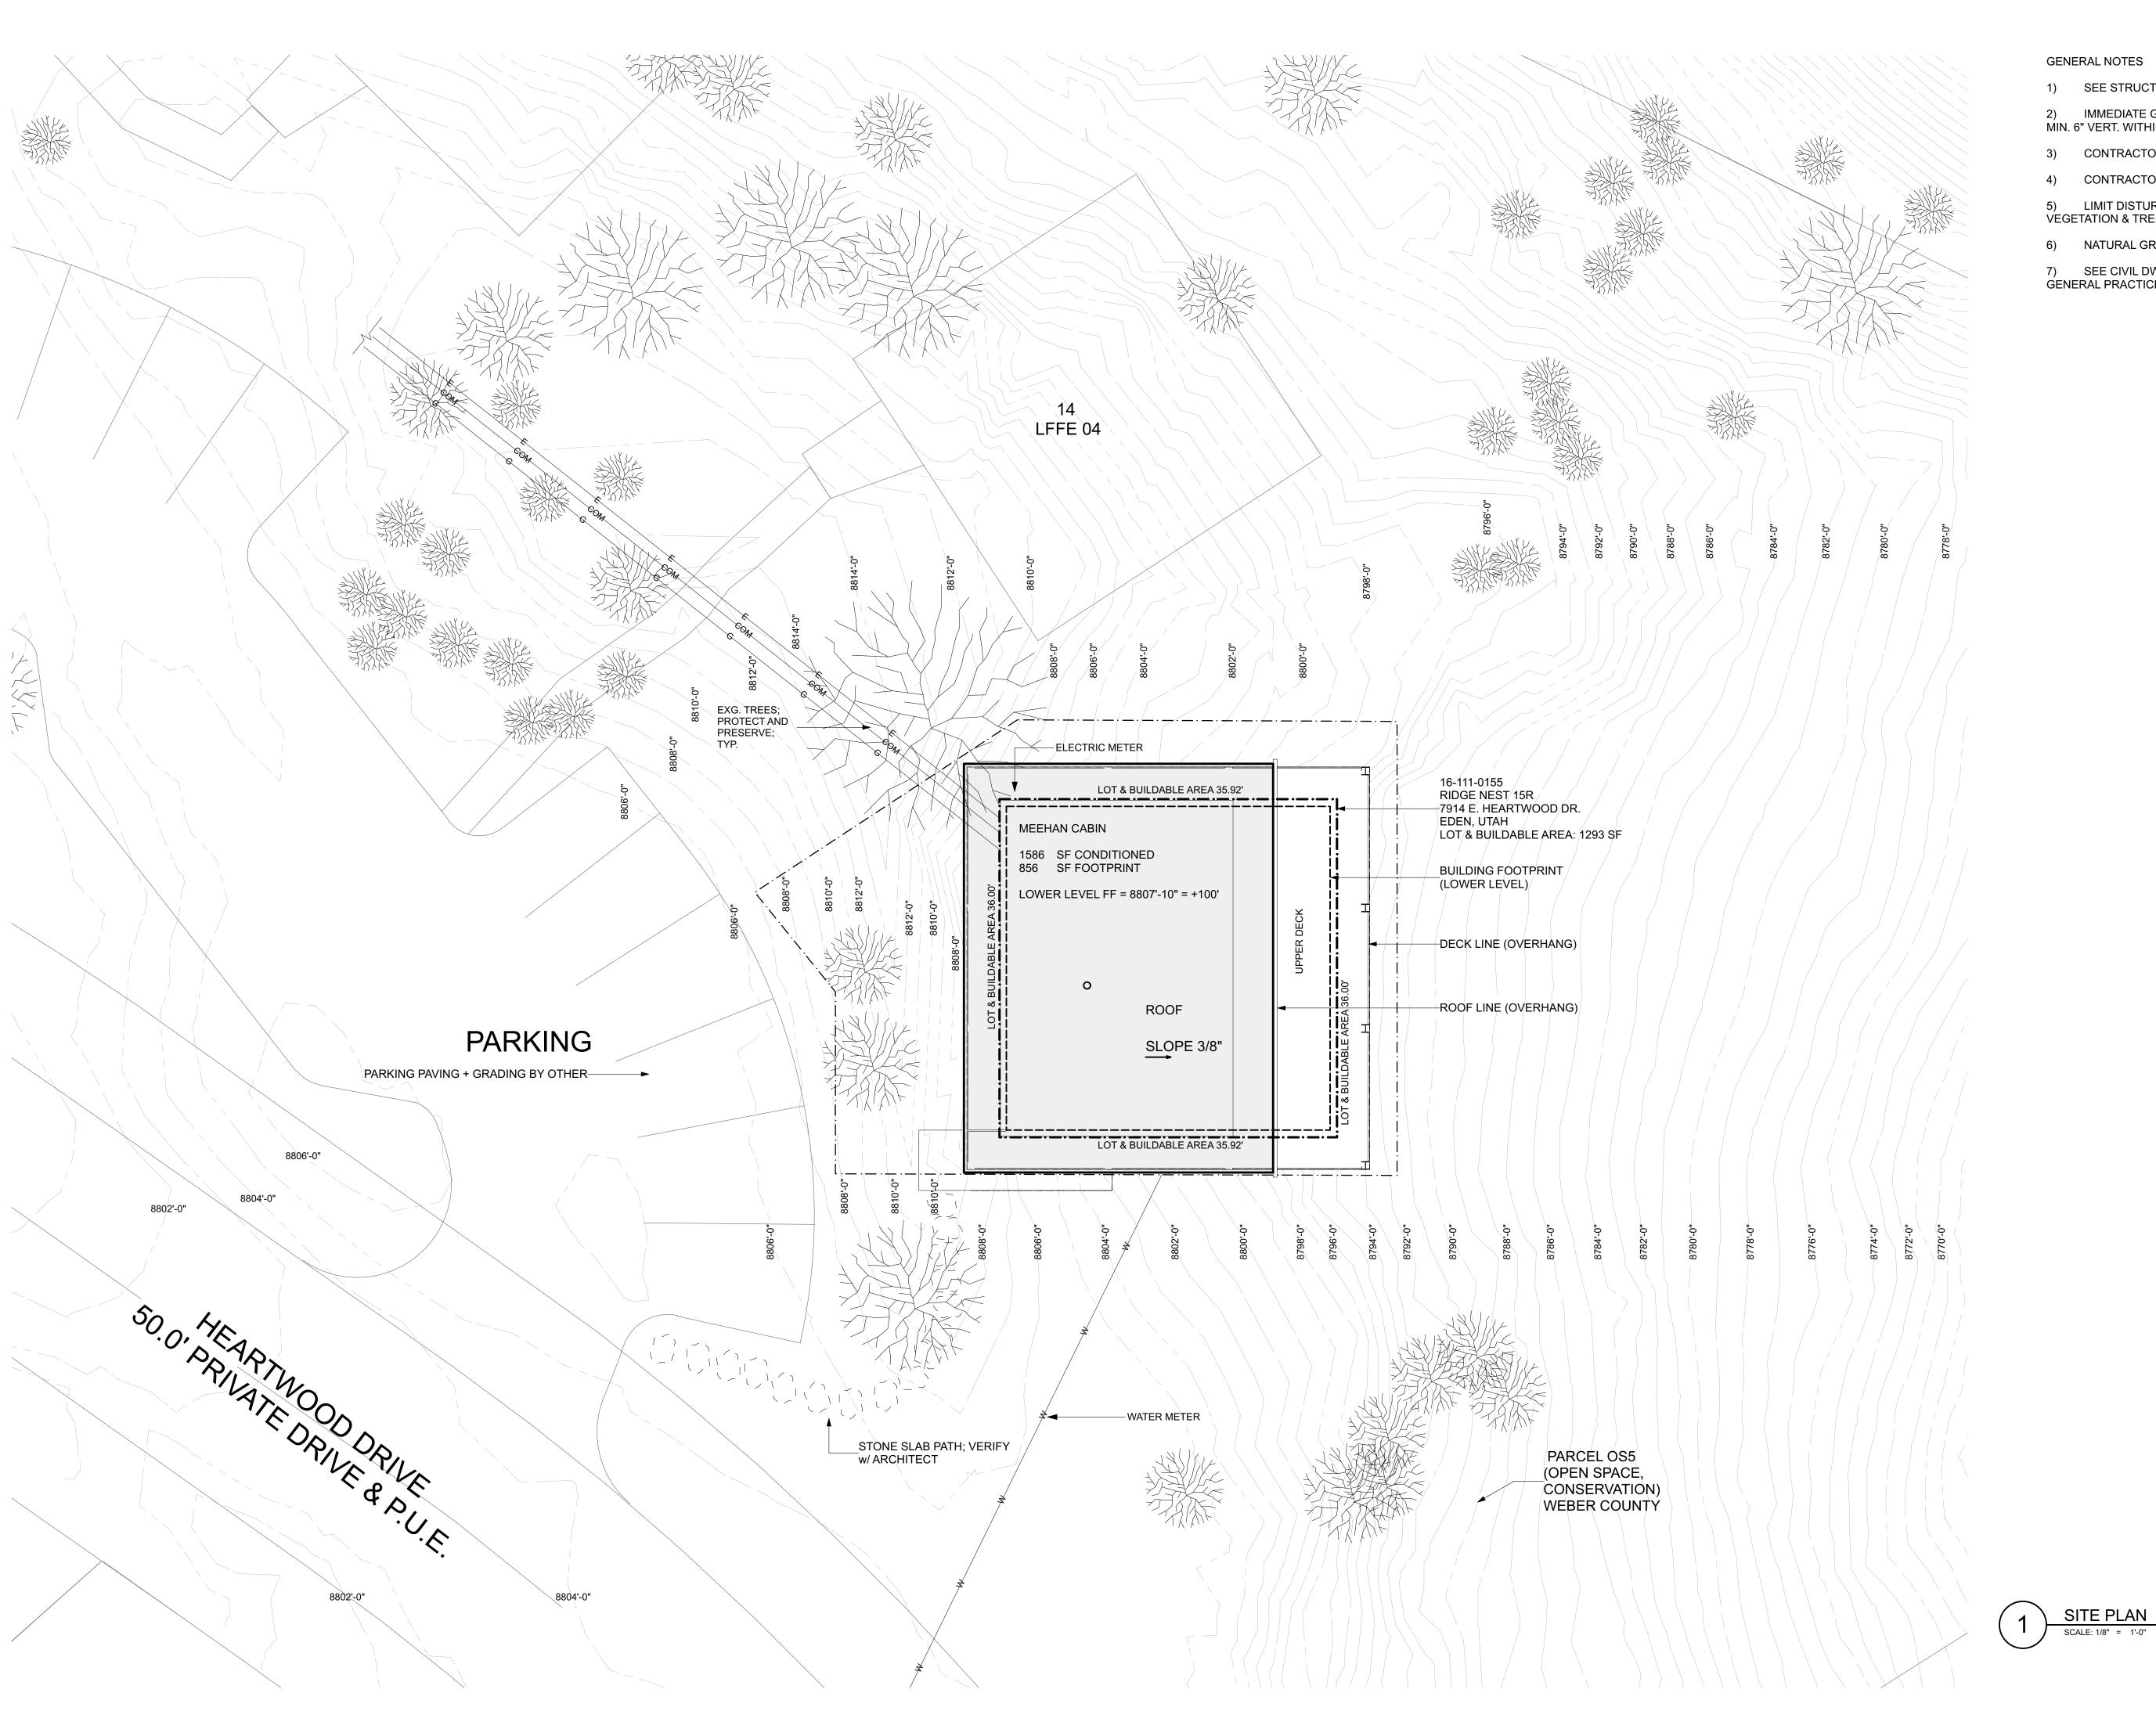
SHEET TITLE

SYMBOLS & **ABBREVIATI** ONS

SHEET NUMBER

G102





1) SEE STRUCT'L, CIVIL, & MECH'L DWGs. FOR MORE INFO

2) IMMEDIATE GRADE TO SLOPE AWAY FROM BUILDING MIN. 6" VERT. WITHIN FIRST 10' HORIZ.; PER IRC R401.3

CONTRACTOR TO VERIFY CONDITIONS ON SITE

CONTRACTOR TO VERIFY DIMENSIONS IN FIELD

5) LIMIT DISTURBANCE & PROTECT SIGNIFICANT VEGETATION & TREES

6) NATURAL GRADE TO BE PRESERVED

7) SEE CIVIL DWGs. FOR EROSION CONTROL AND GENERAL PRACTICES

7

PLAN REVIEW ACCEPTANCE
FOR COMPLIANCE WITH THE APPLICABLE

XBUILDING STRUCTURAL
XMECHANICAL XPLUMBING
XELECTRICAL XENERGY
ACCESSIBILITY FIRE

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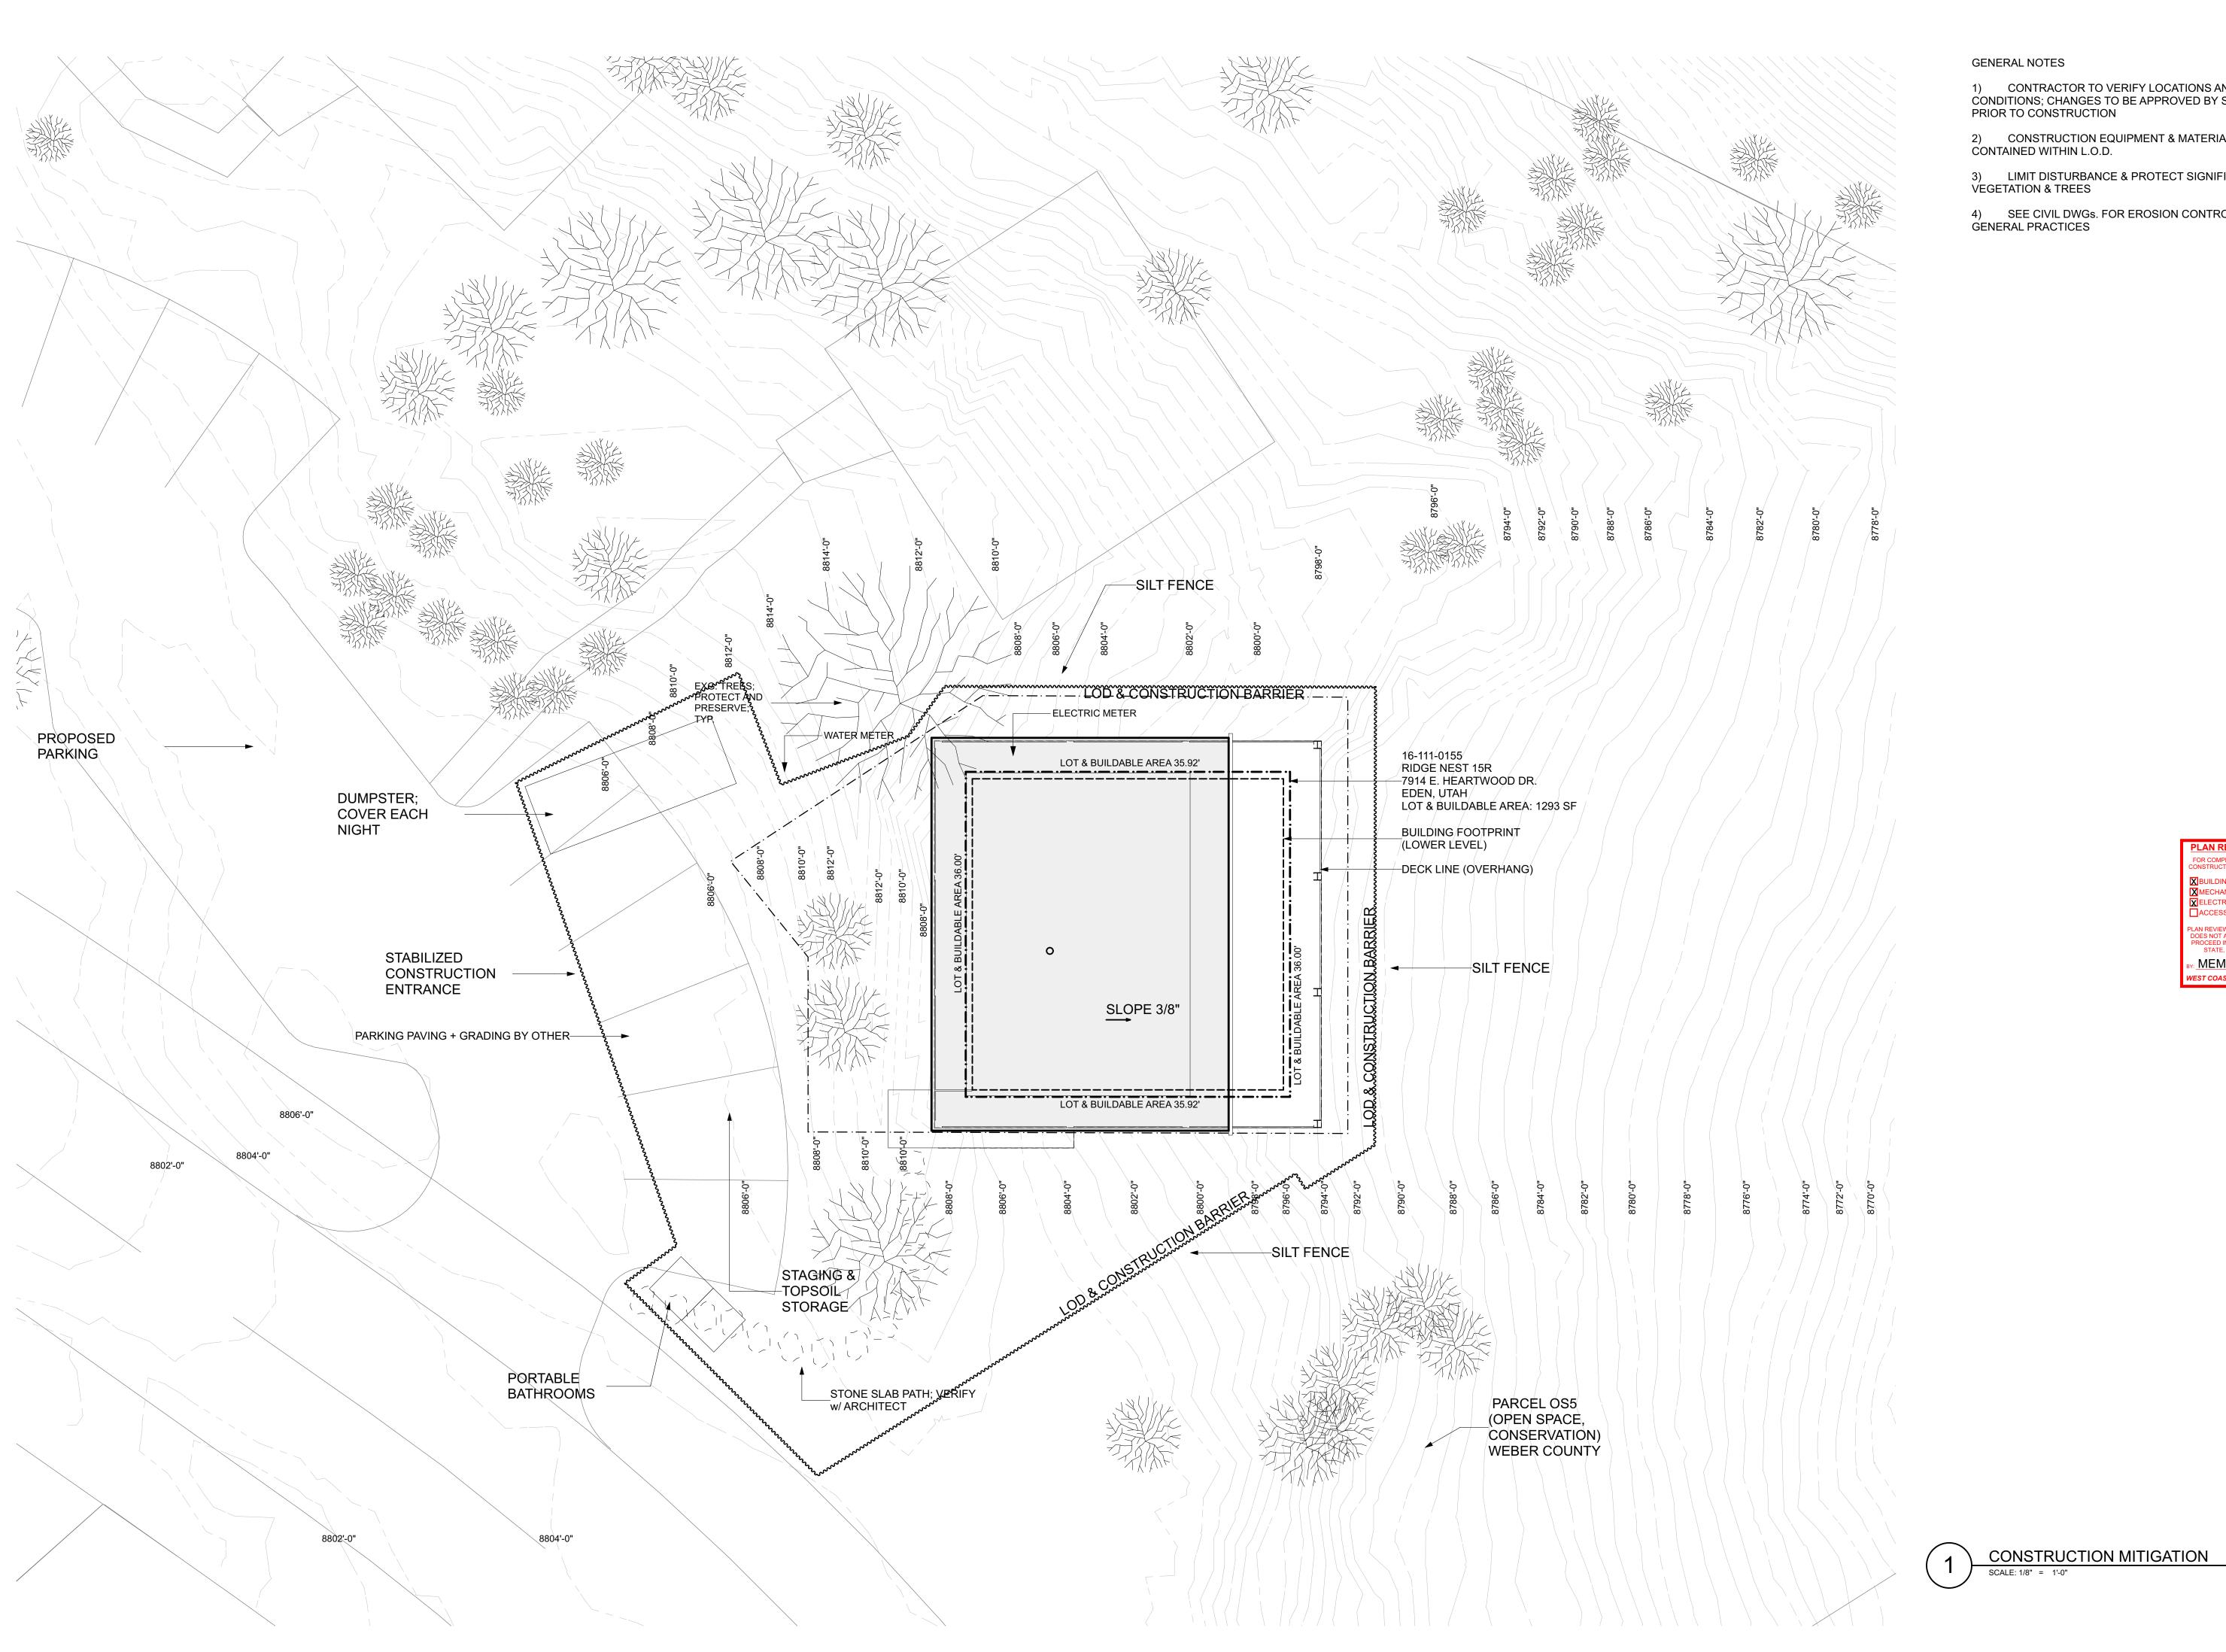
DRAWING REVISIONS

SHEET TITLE

SITE PLAN

SHEET NUMBER

SD101



1) CONTRACTOR TO VERIFY LOCATIONS AND SITE CONDITIONS; CHANGES TO BE APPROVED BY SUMMIT ARC PRIOR TO CONSTRUCTION

2) CONSTRUCTION EQUIPMENT & MATERIALS TO BE CONTAINED WITHIN L.O.D.

3) LIMIT DISTURBANCE & PROTECT SIGNIFICANT VEGETATION & TREES

4) SEE CIVIL DWGs. FOR EROSION CONTROL AND GENERAL PRACTICES

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Y: MEM

PROJECT PHASE

ARC FINAL REVIEW 01/19/2018


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SHEET TITLE

CONSTRUCT MITIGATION



### GENERAL NOTES

 NATURAL GRADE & LANDSCAPE TO BE PRESERVED;
 STRATEGY FOR REVEGETATING NATIVE PLANTS IN AREAS OF DISTURBANCE TO BE SUBMITTED TO SUMMIT ARC FOR FINAL LANDSCAPE REVIEW PRIOR TO 4-WAY INSPECTION

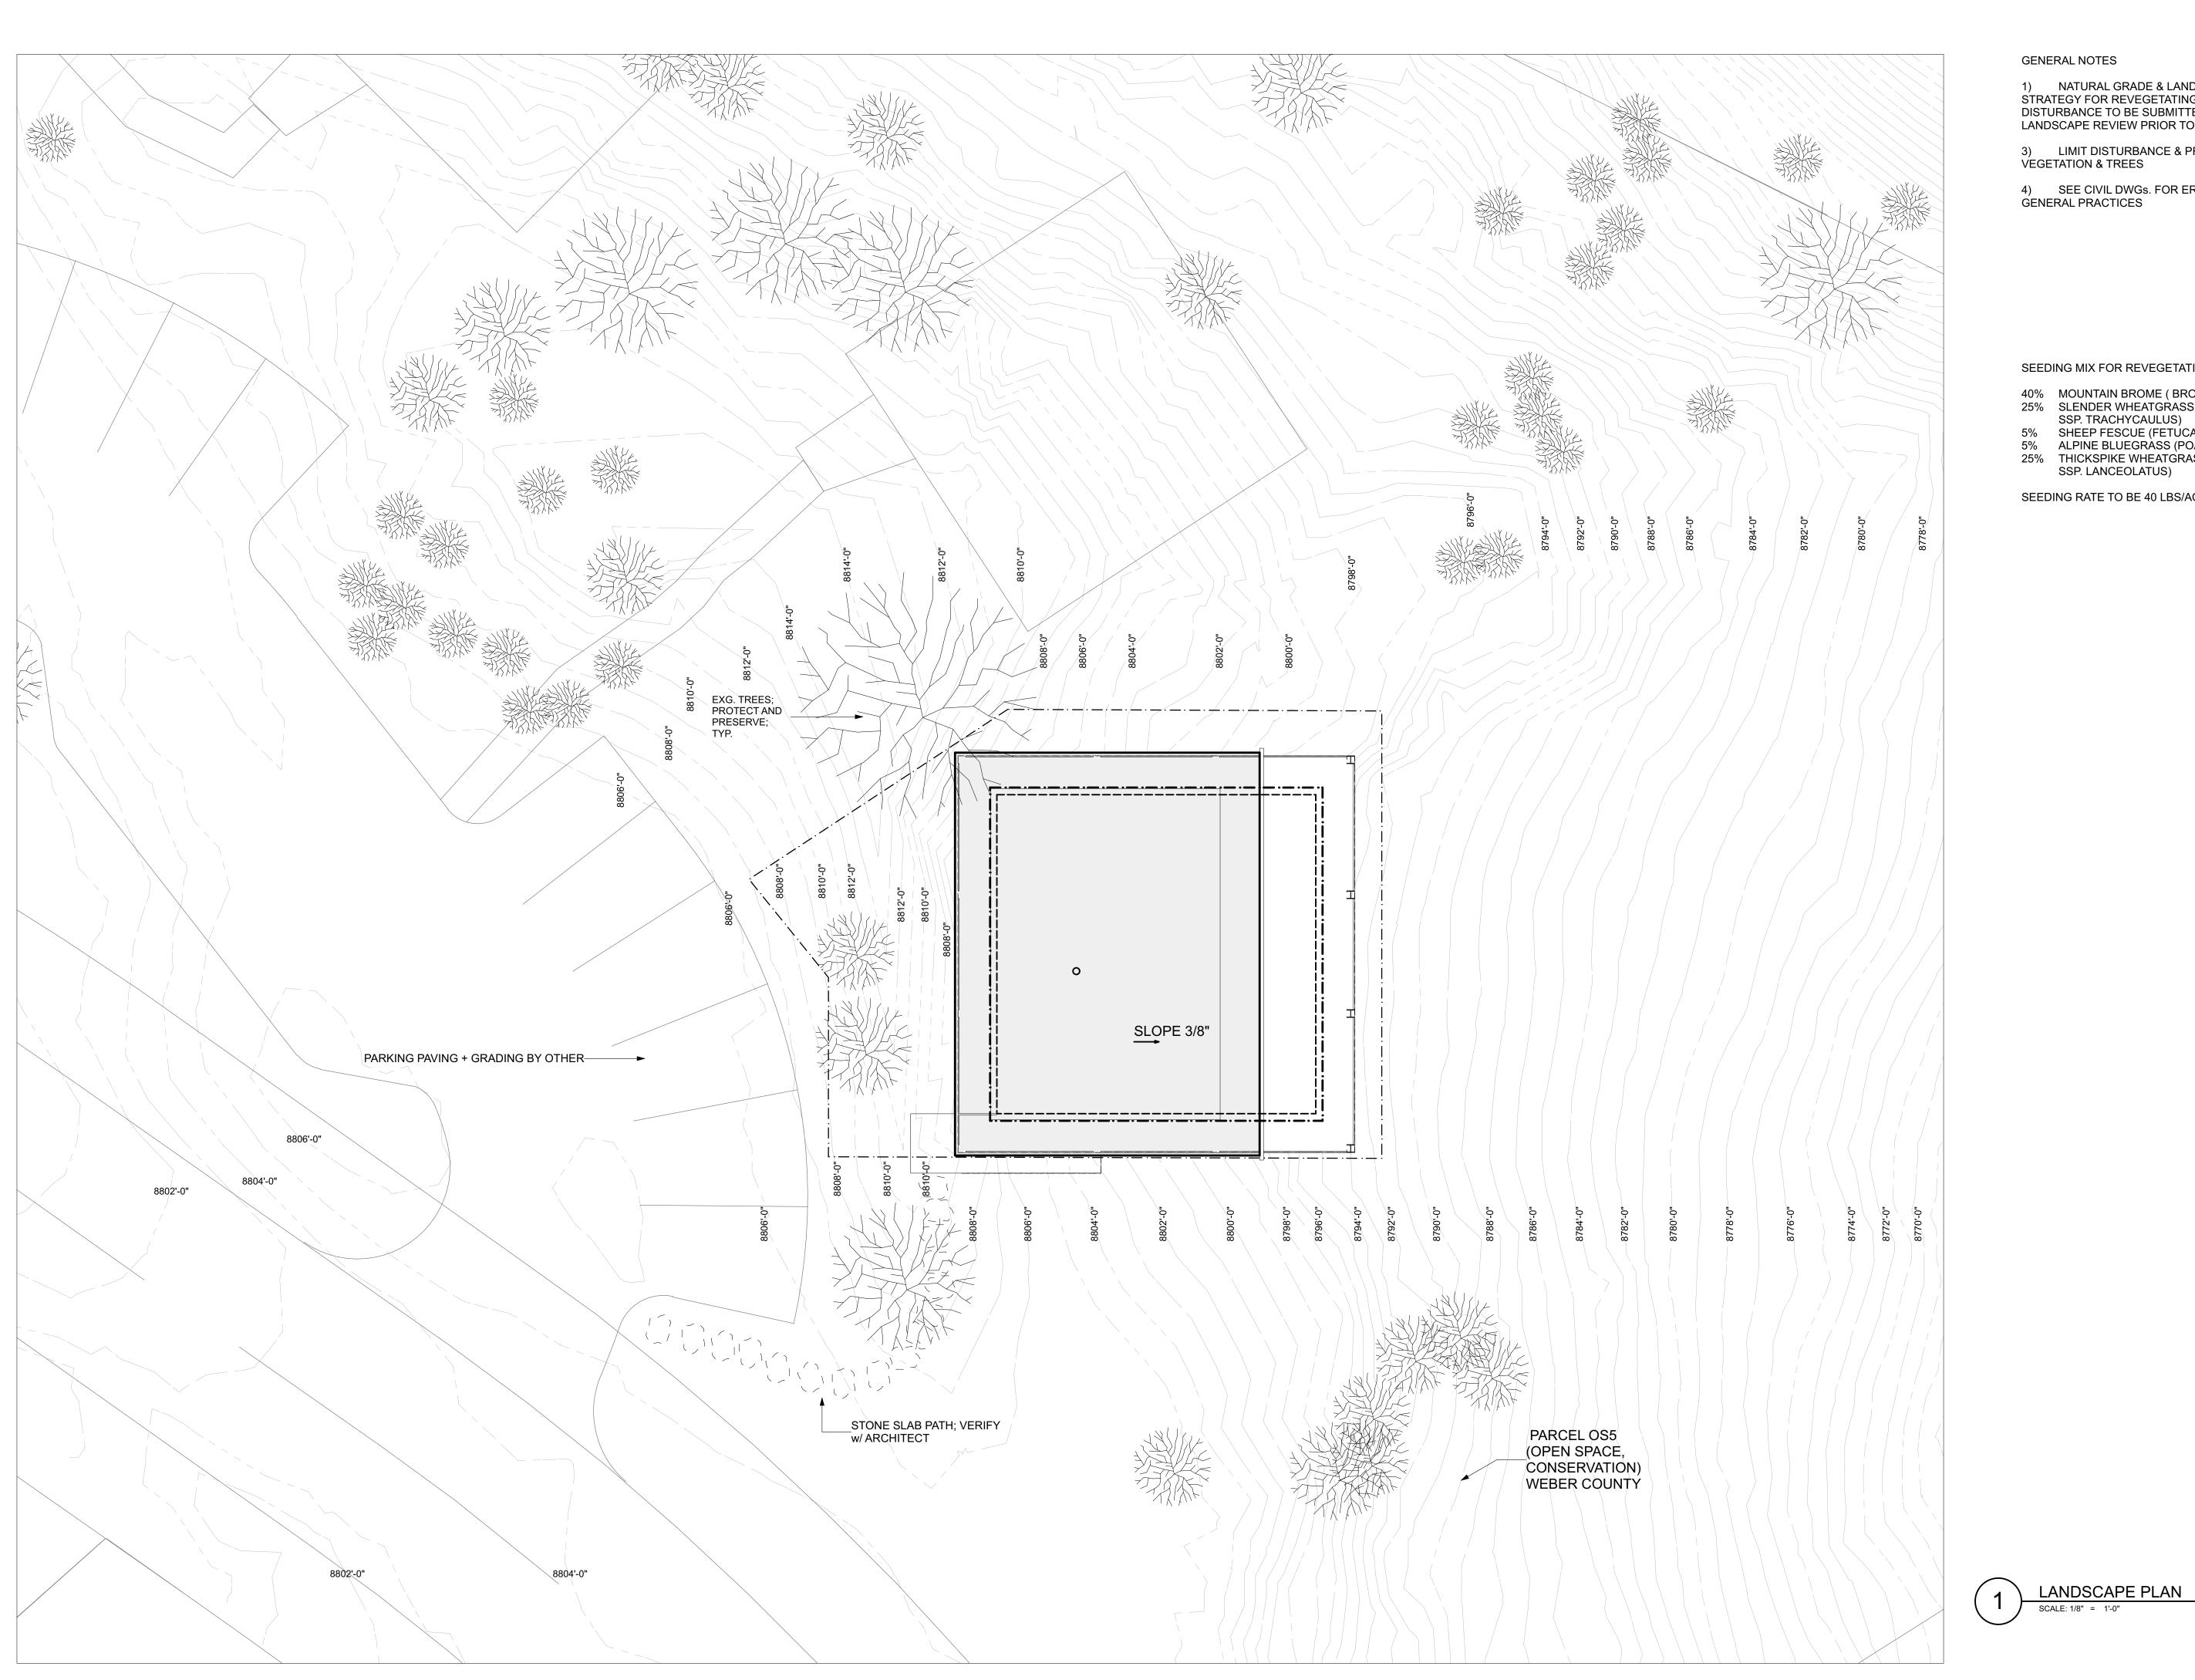3) LIMIT DISTURBANCE & PROTECT SIGNIFICANT VEGETATION & TREES

4) SEE CIVIL DWGs. FOR EROSION CONTROL AND GENERAL PRACTICES

### SEEDING MIX FOR REVEGETATION

- 40% MOUNTAIN BROME (BROMUS MARGINATUS)
  25% SLENDER WHEATGRASS (ELYMUS TRACHYCAULUS SSP. TRACHYCAULUS)
  5% SHEEP FESCUE (FETUCA OVINA SPP. DURIUSCULA)
  5% ALPINE BLUEGRASS (POA ALPINE)
  25% THICKSPIKE WHEATGRASS (ELYMUS LANCEOLATUS SSP. LANCEOLATUS)

SEEDING RATE TO BE 40 LBS/ACRE

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XMECHANICAL XPLUMBING
XELECTRICAL XENERGY
ACCESSIBILITY FIRE PLAN REVIEW ACCEPTANCE OF DOCUMEN' DOES NOT AUTHORIZE CONSTRUCTION TO PROCEED IN VIOLATION OF ANY FEDERAL STATE, OR LOCAL REGULATIONS.

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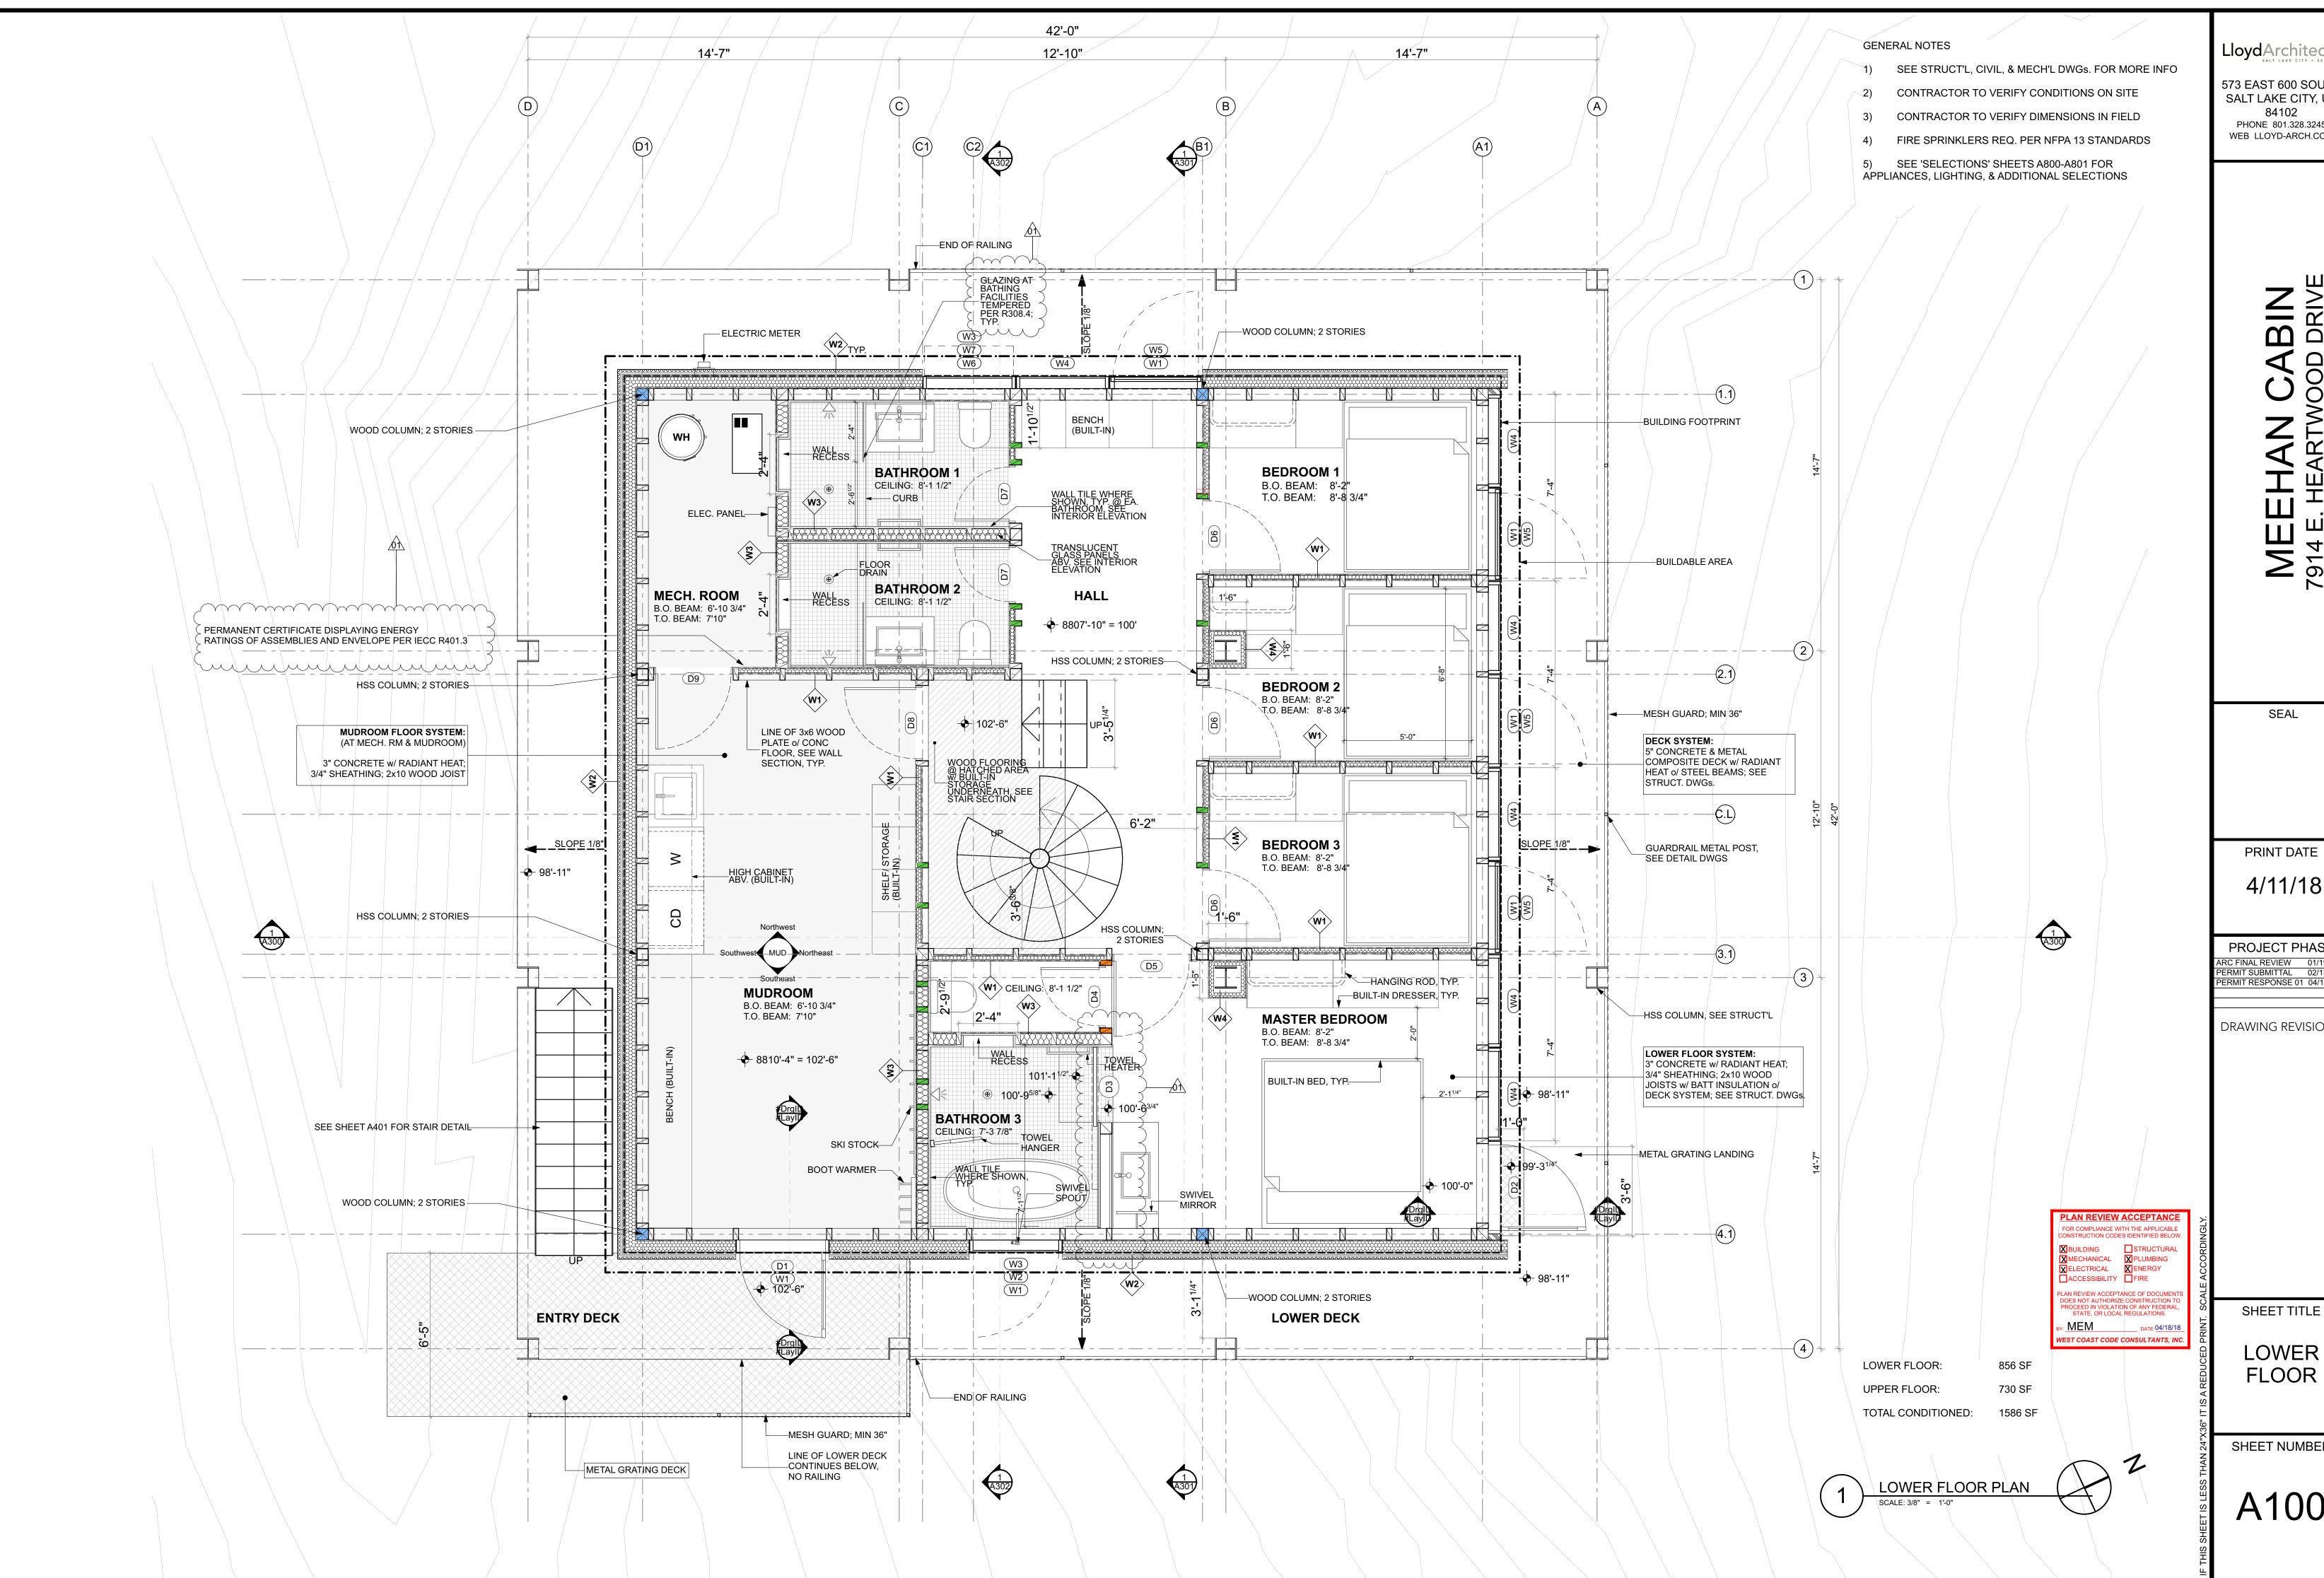
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SHEET TITLE

LANDSCAPE PLAN



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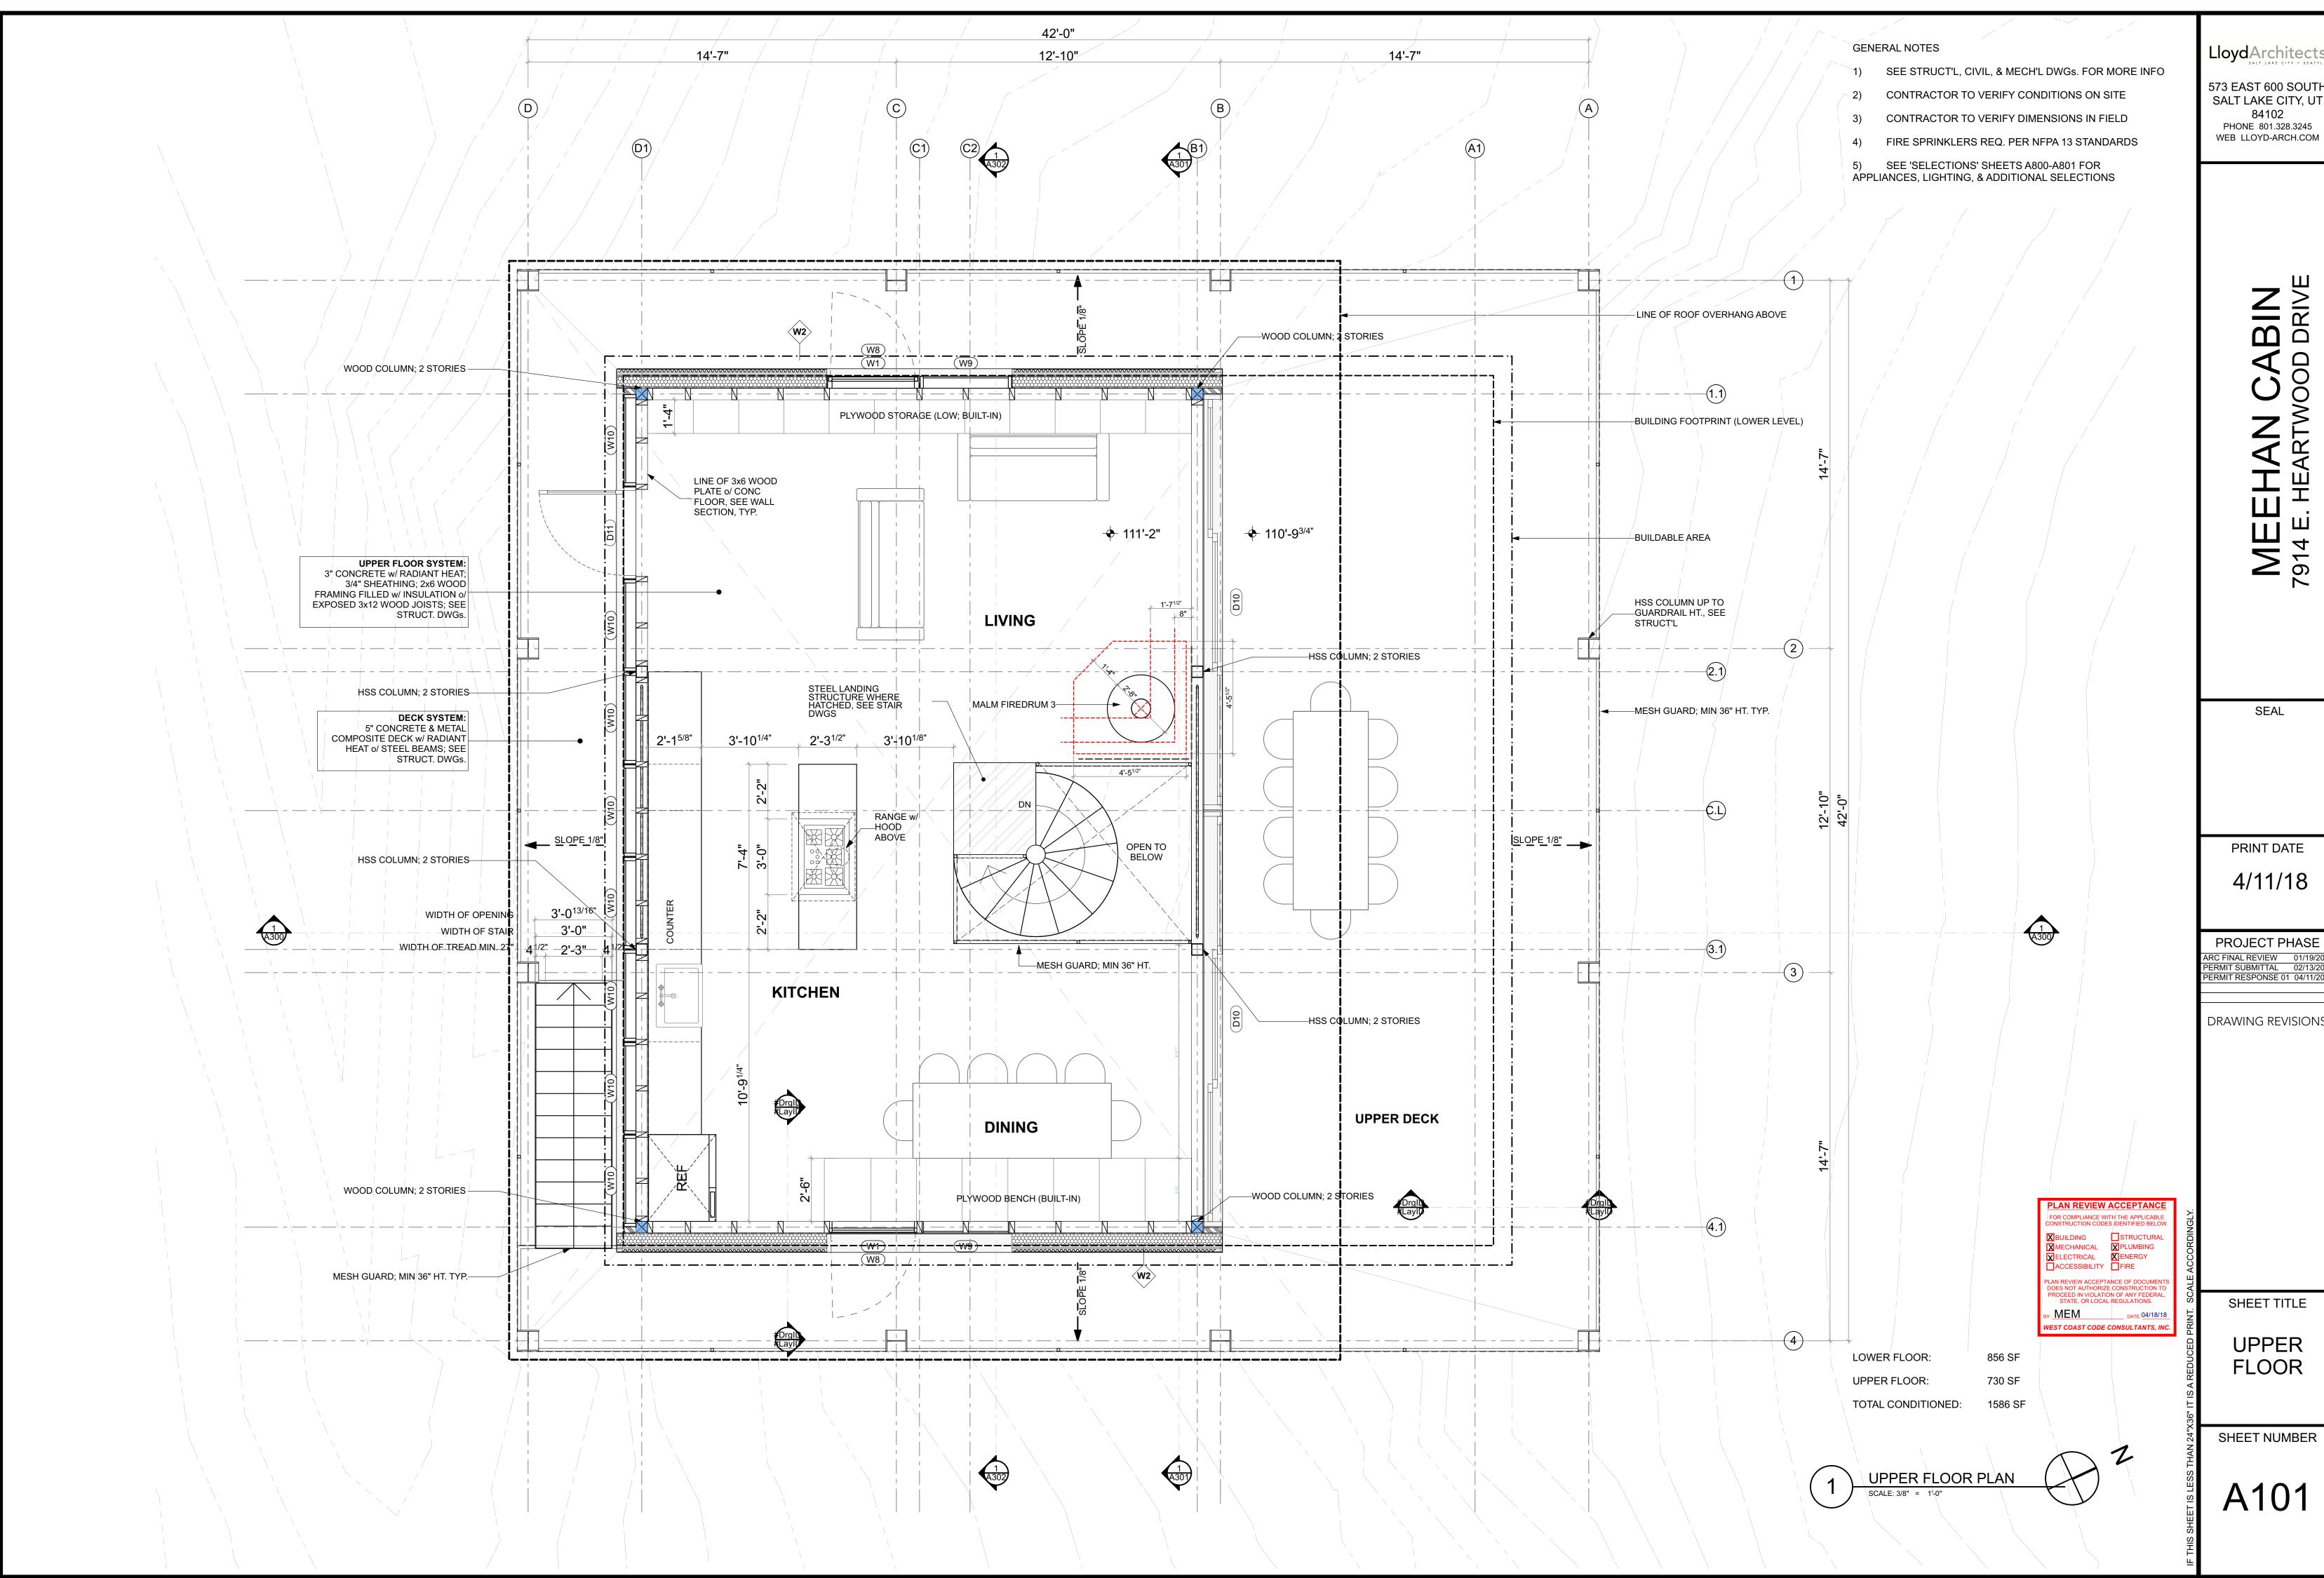
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**LOWER FLOOR** 



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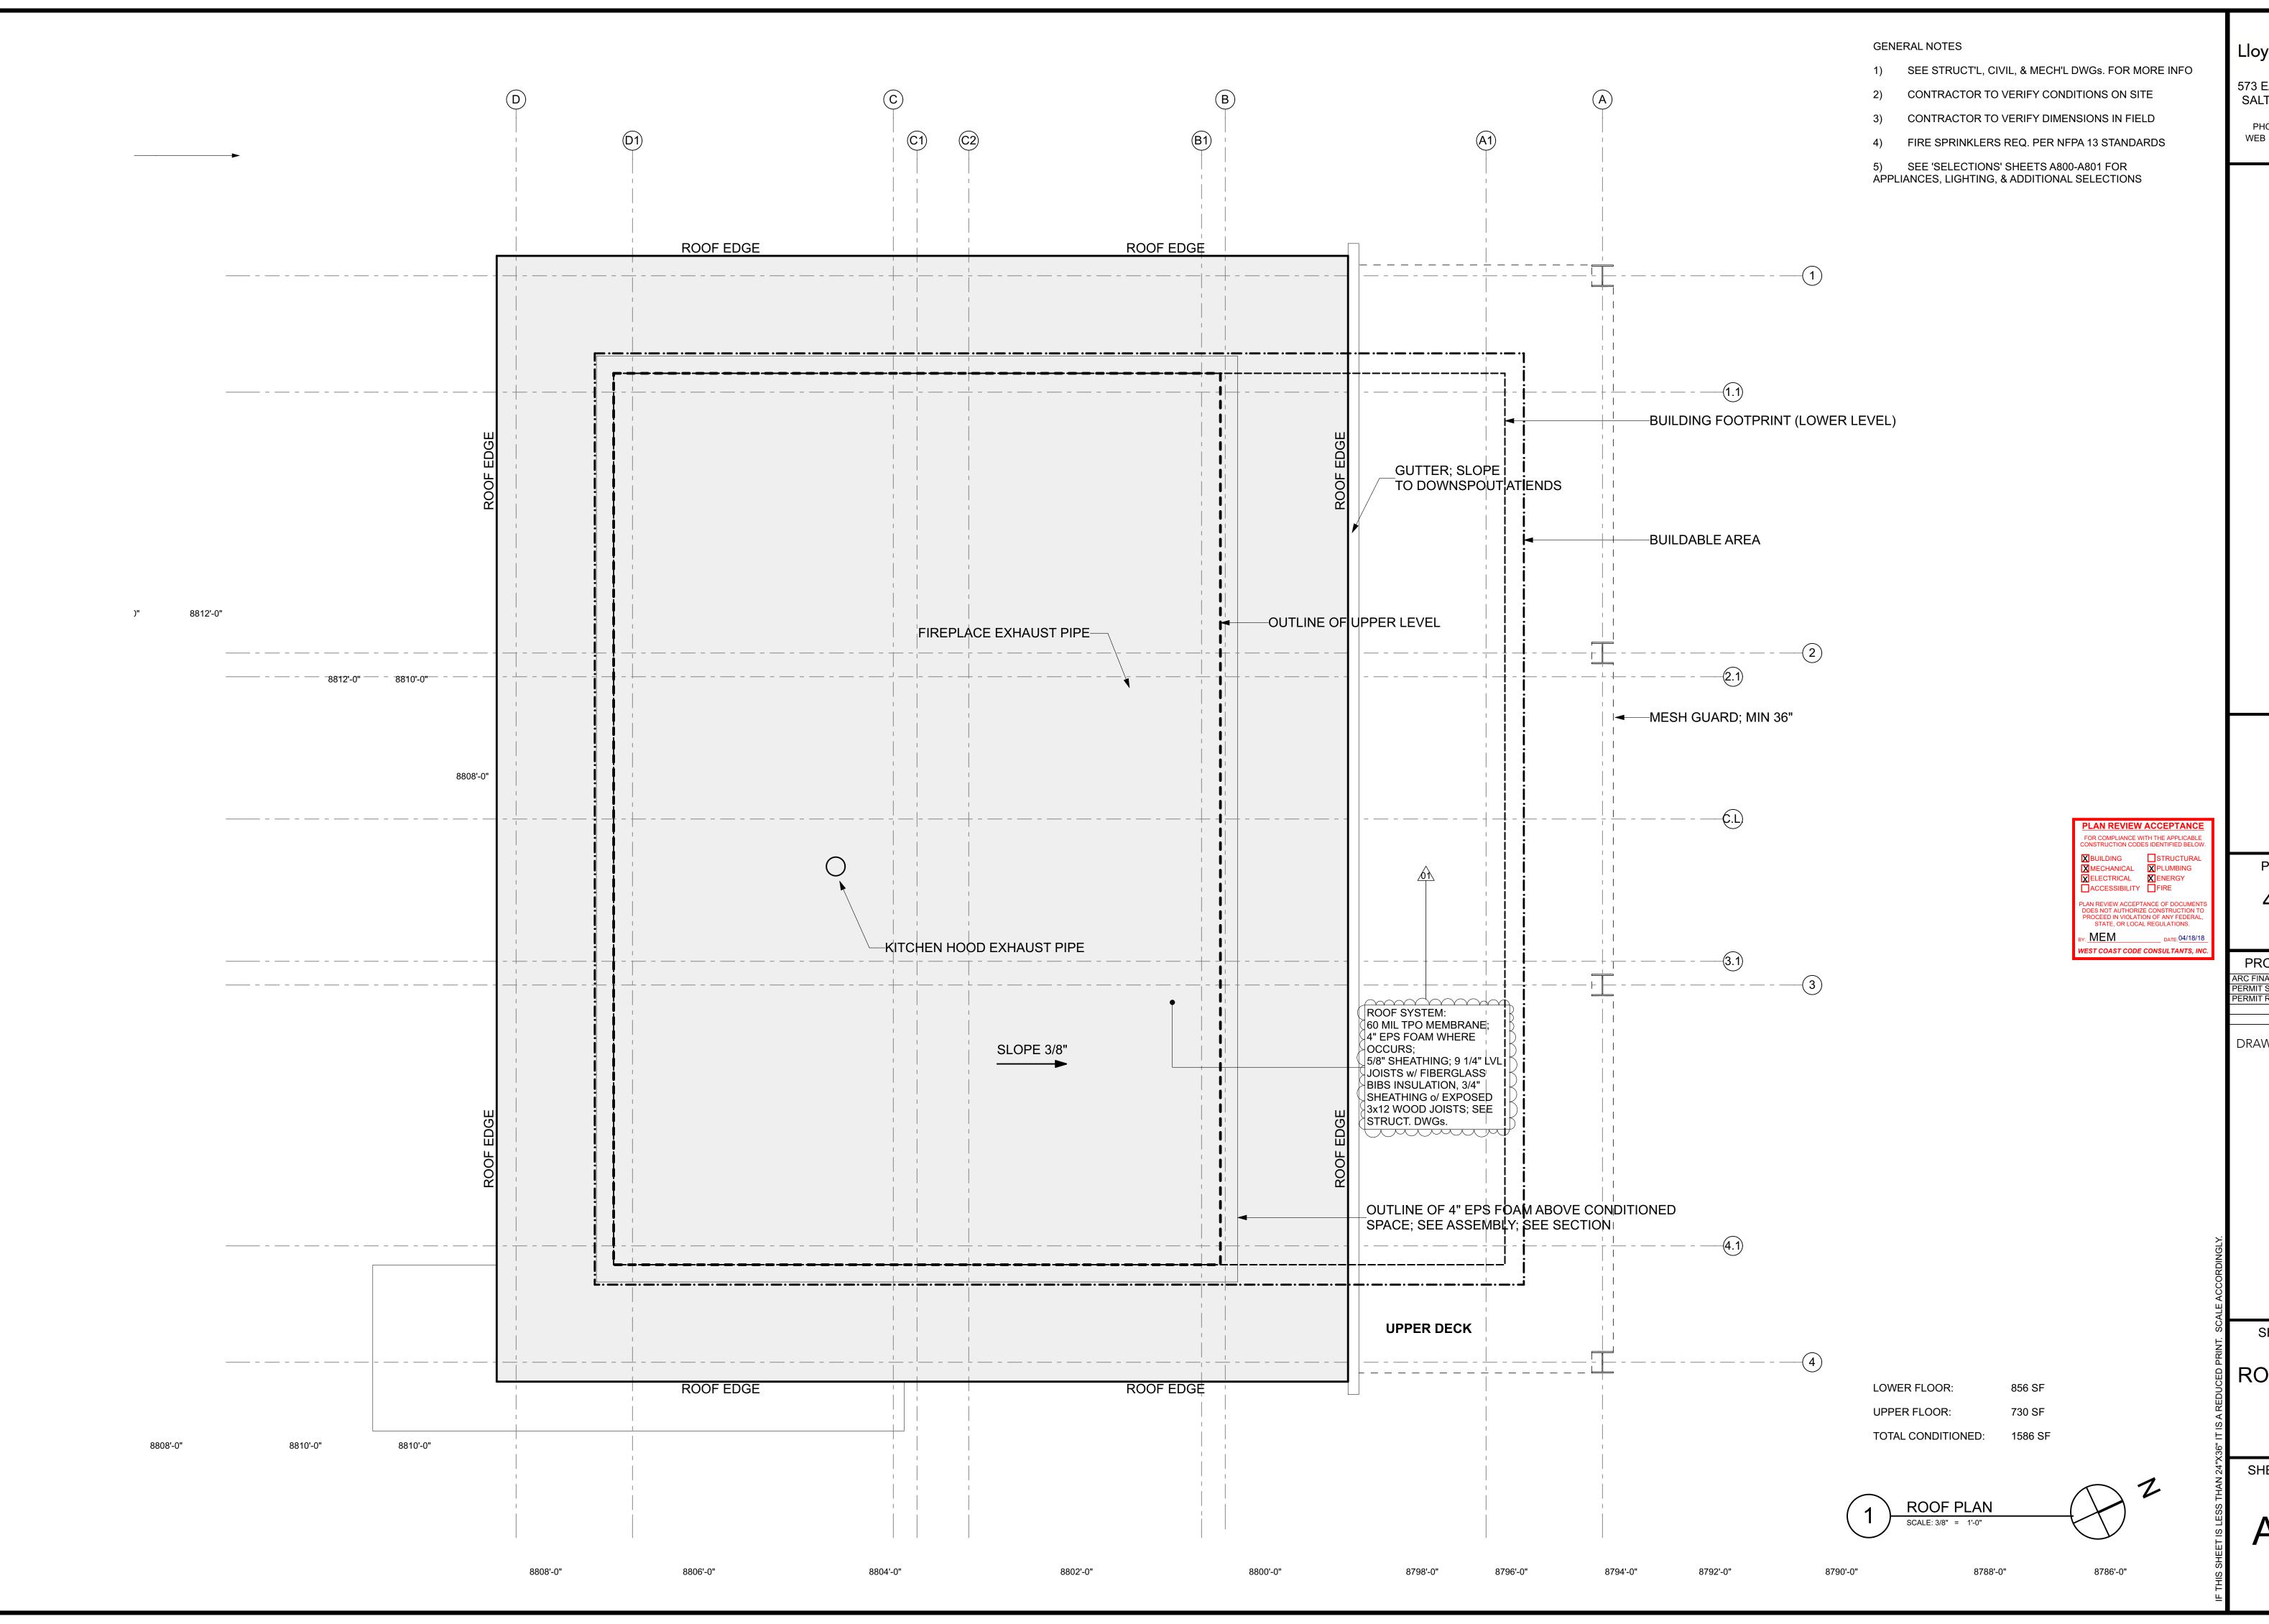
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**UPPER FLOOR** 



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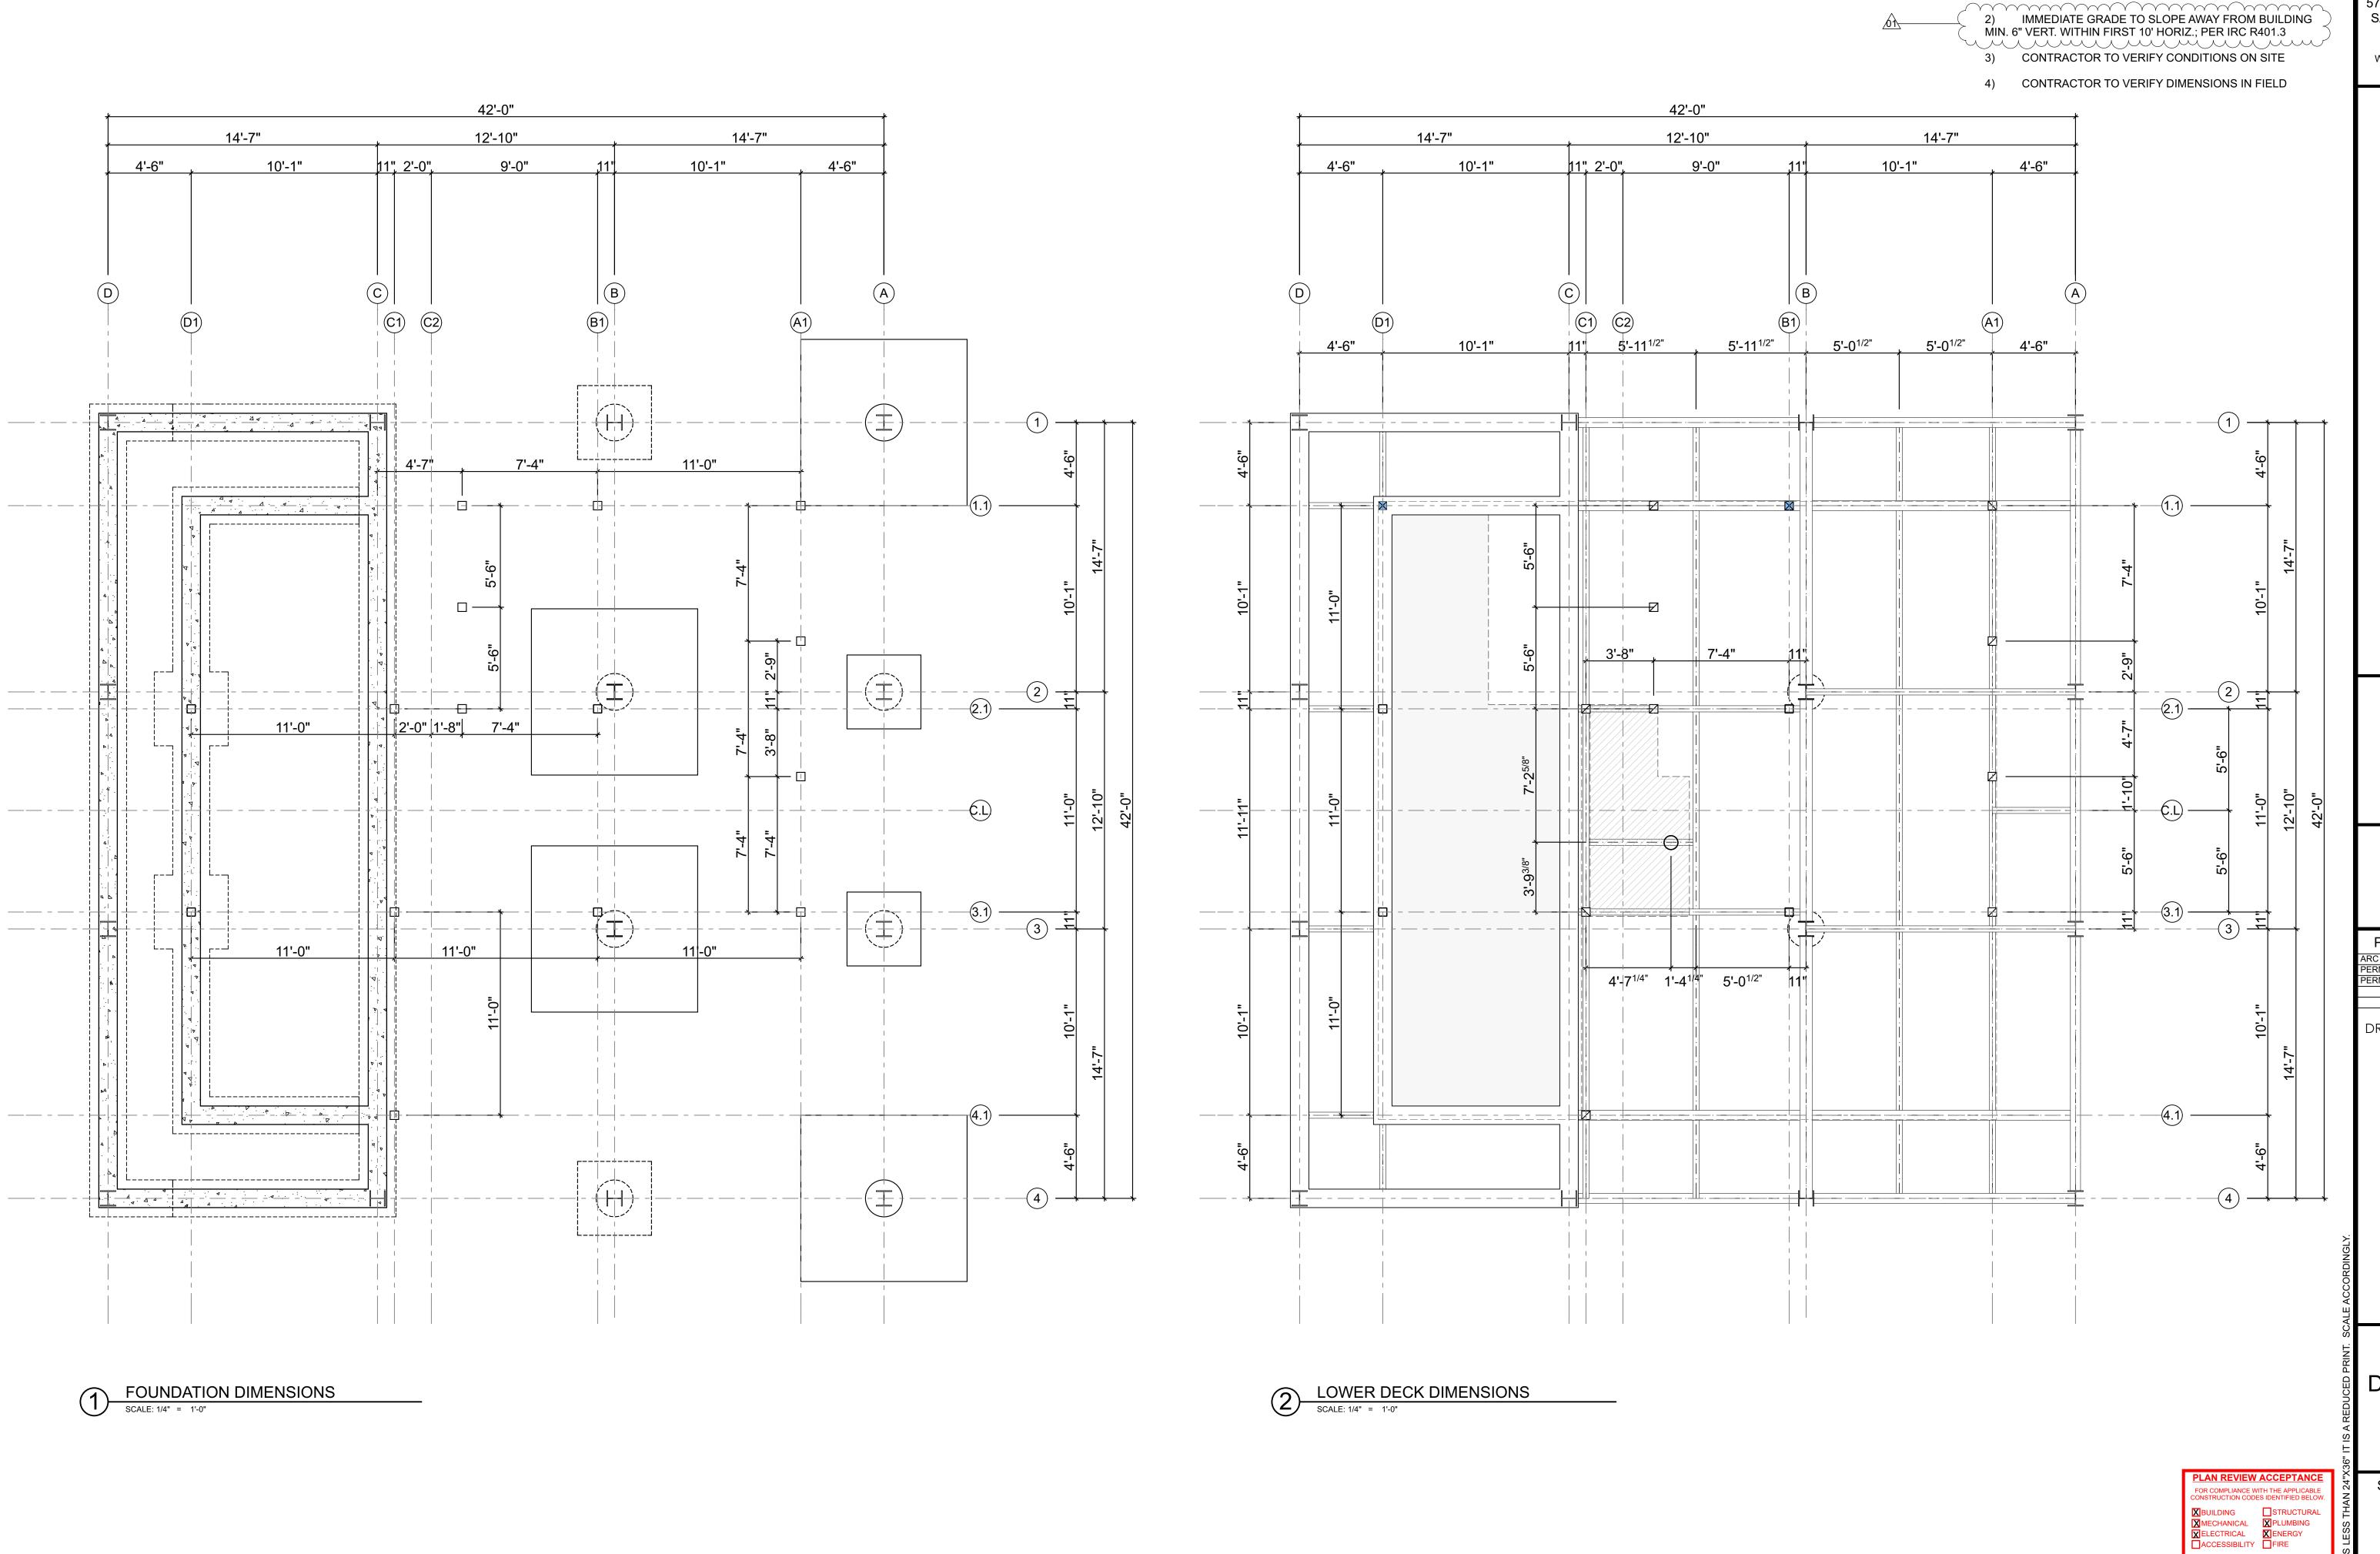
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SHEET TITLE

ROOF PLAN

SHEET NUMBER



**GENERAL NOTES** 

1) SEE STRUCT'L, CIVIL, & MECH'L DWGs. FOR MORE INFO

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DIMENSION PLANS LOWER


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**GENERAL NOTES** 

1) SEE STRUCT'L, CIVIL, & MECH'L DWGs. FOR MORE INFO

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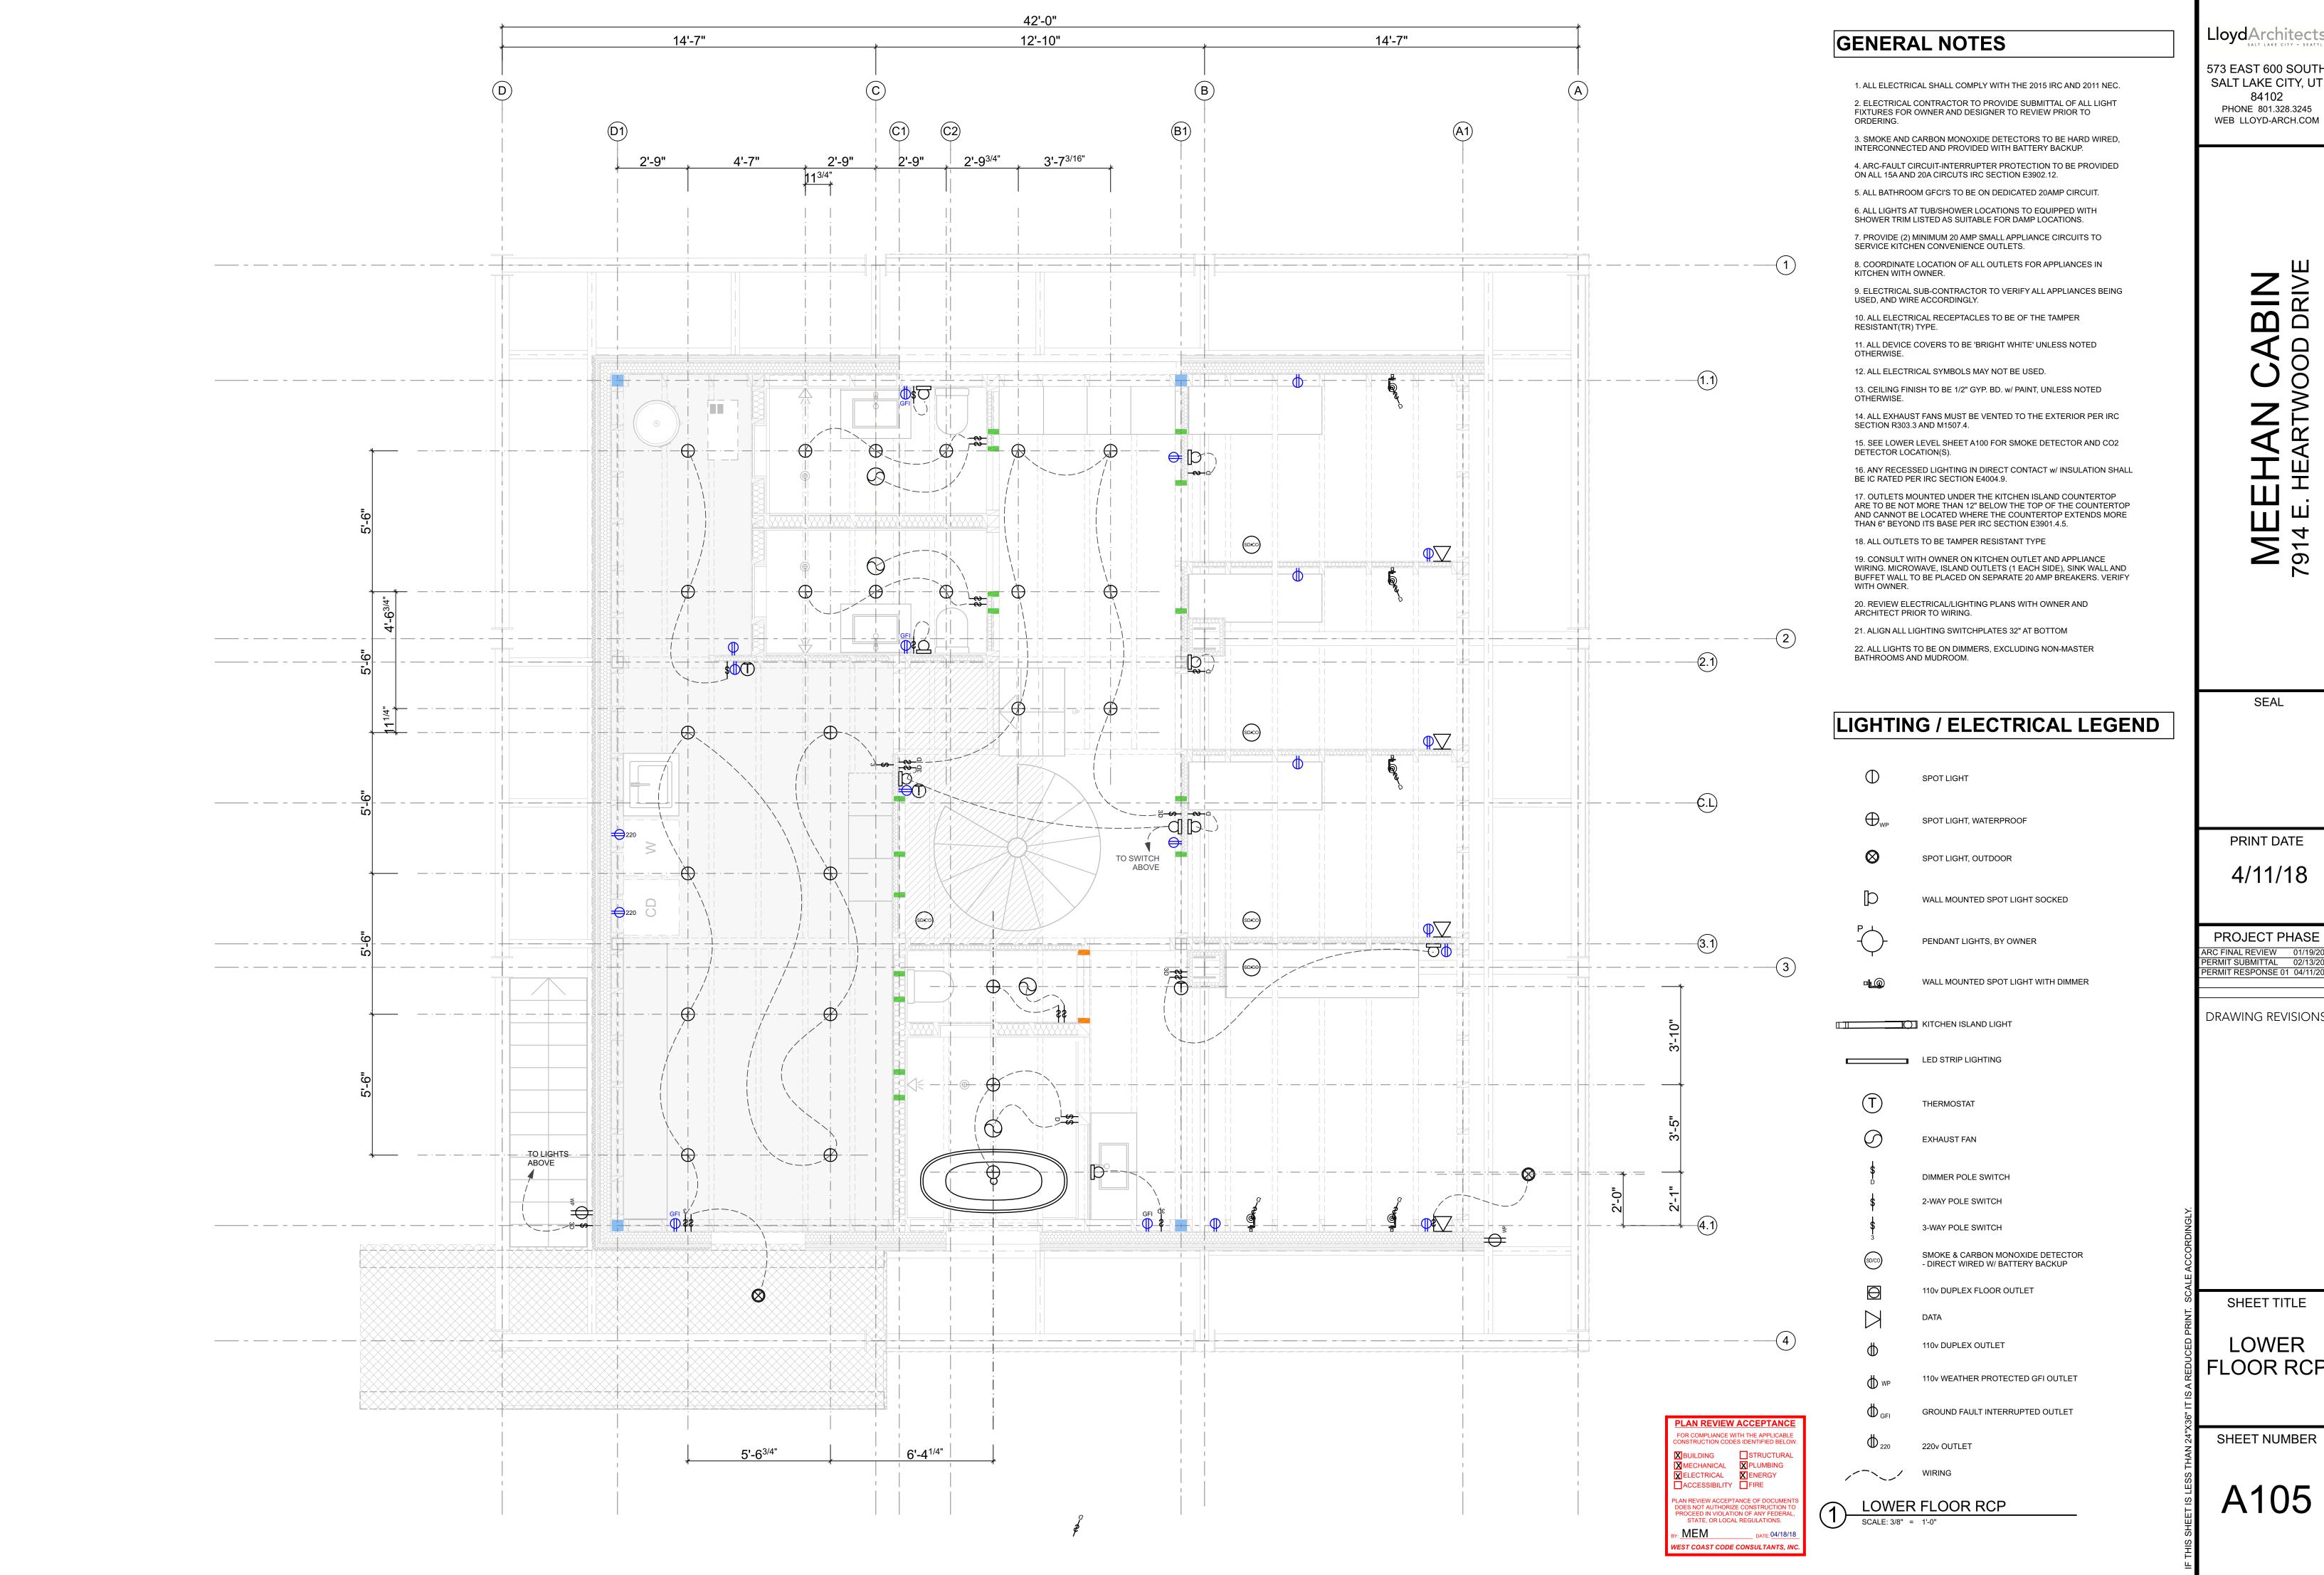
DIMENSION PLANS UPPER

SHEET NUMBER

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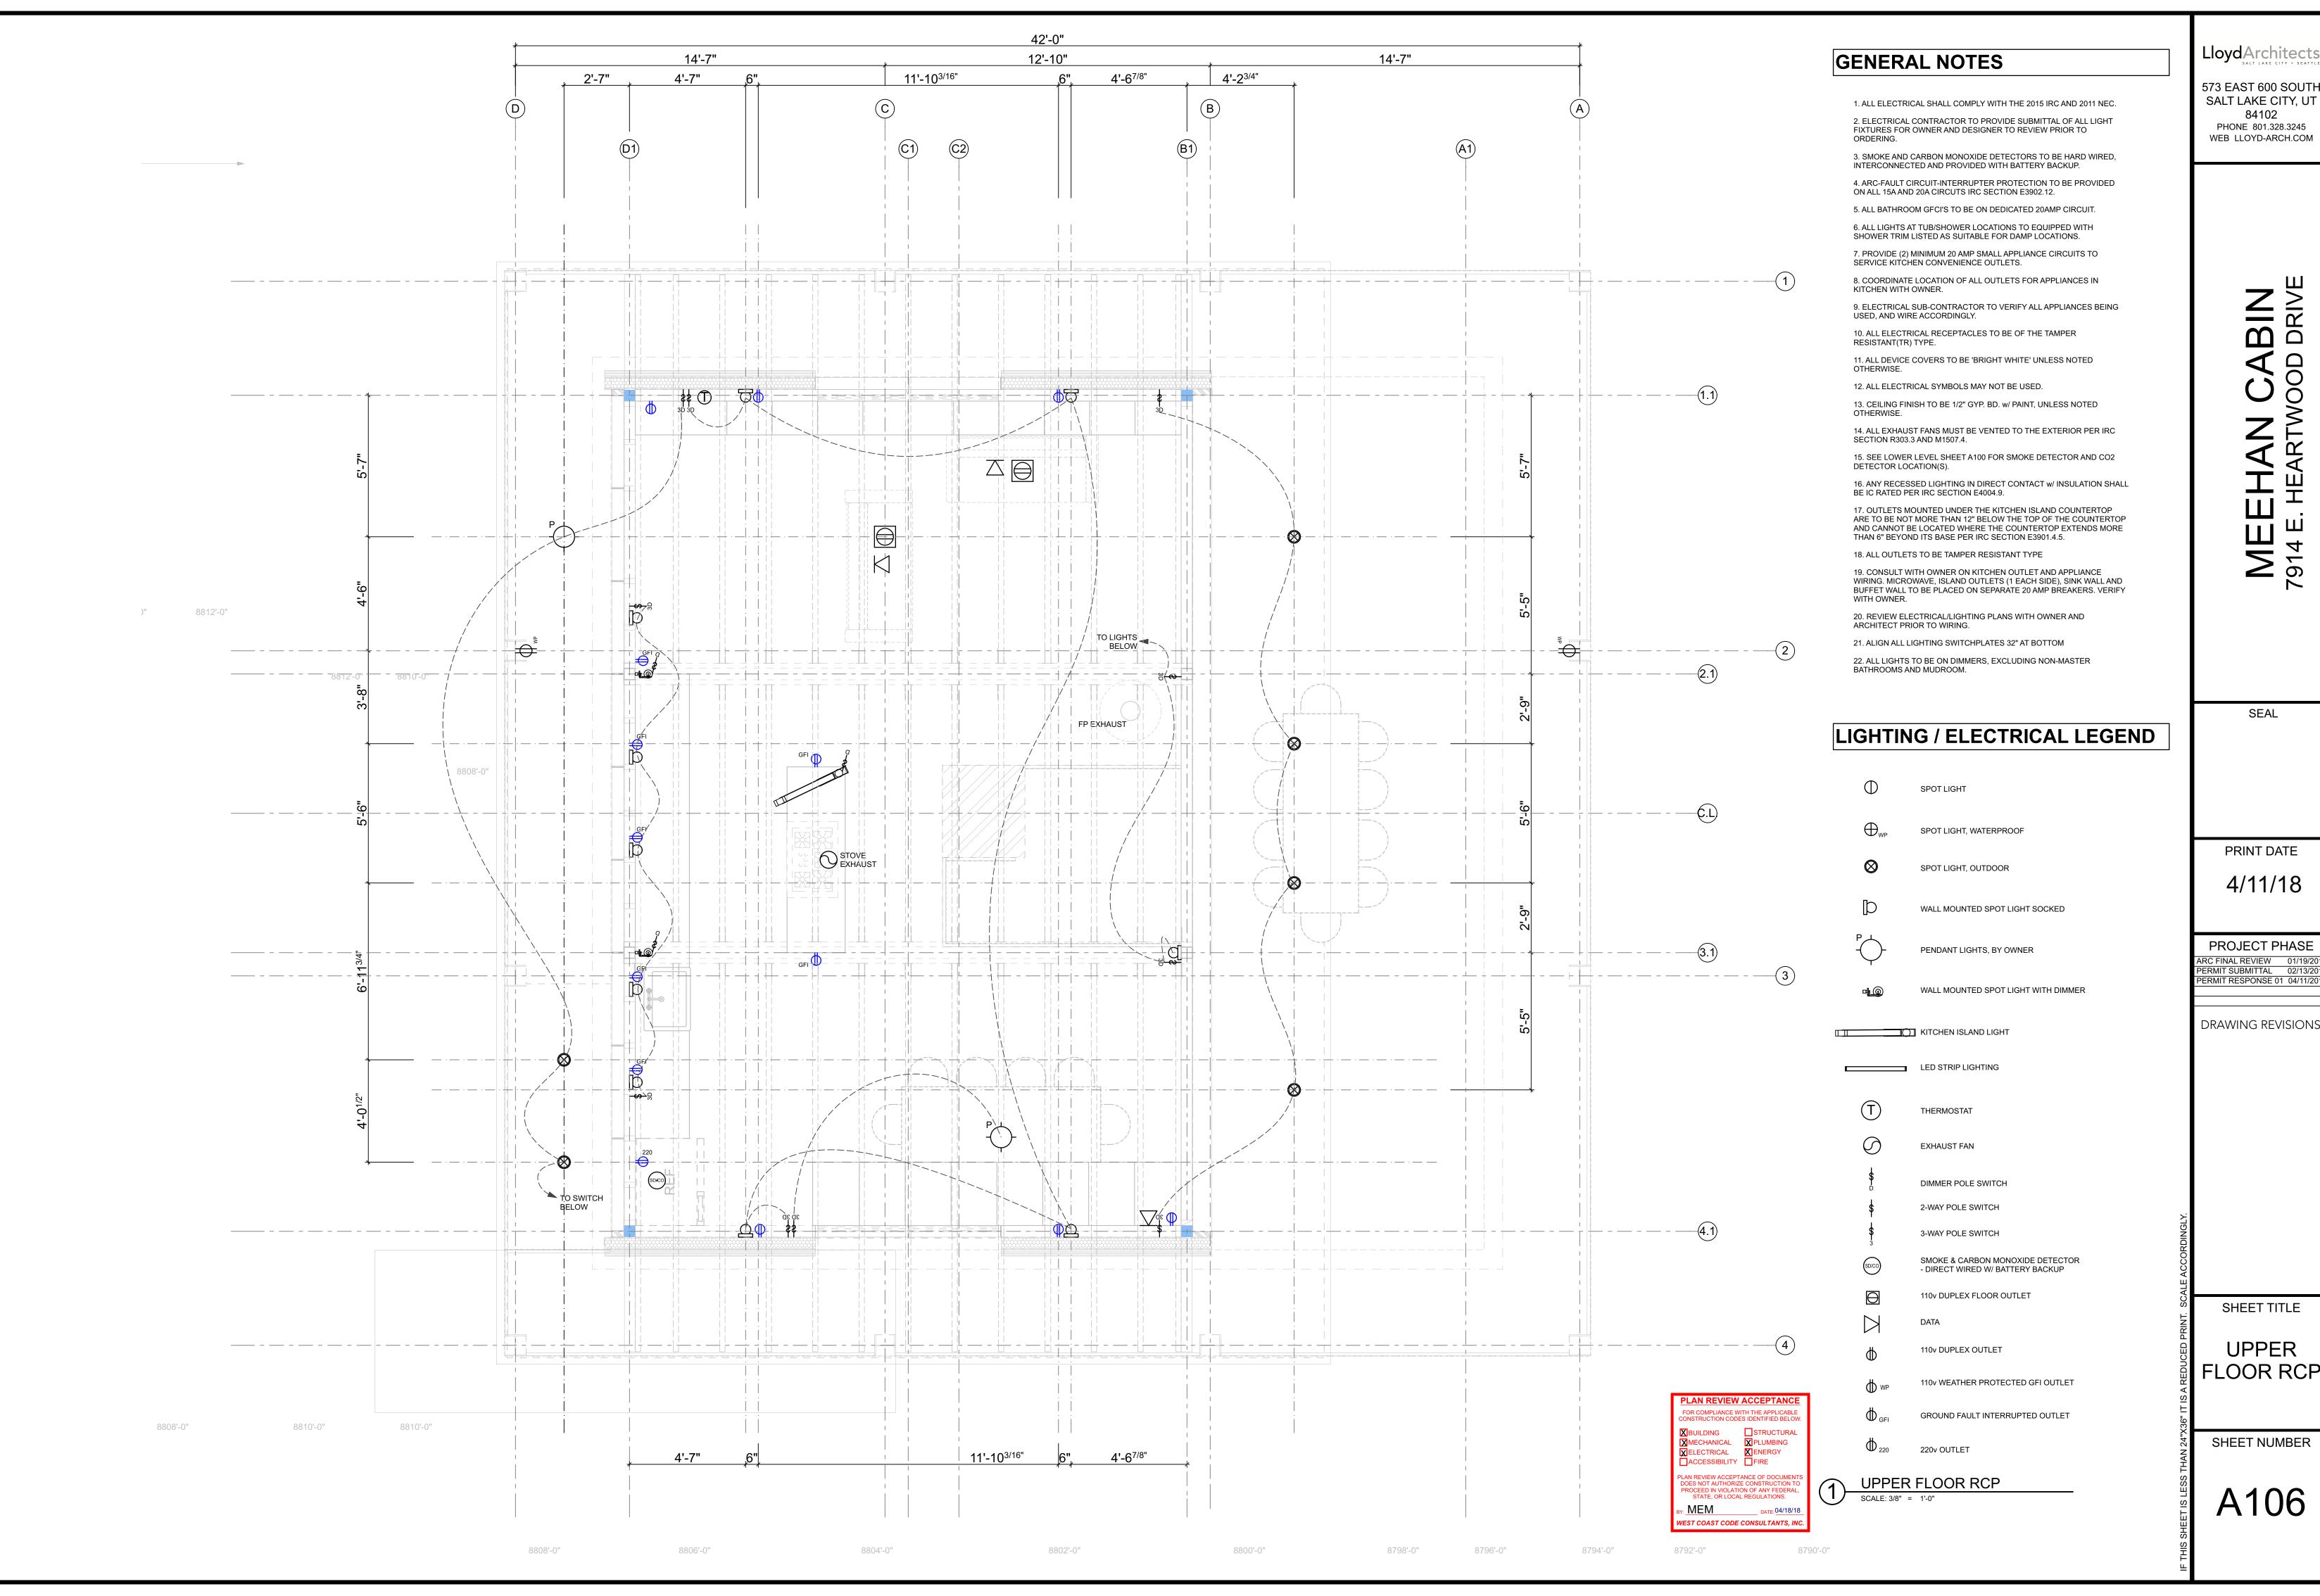
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SHEET TITLE

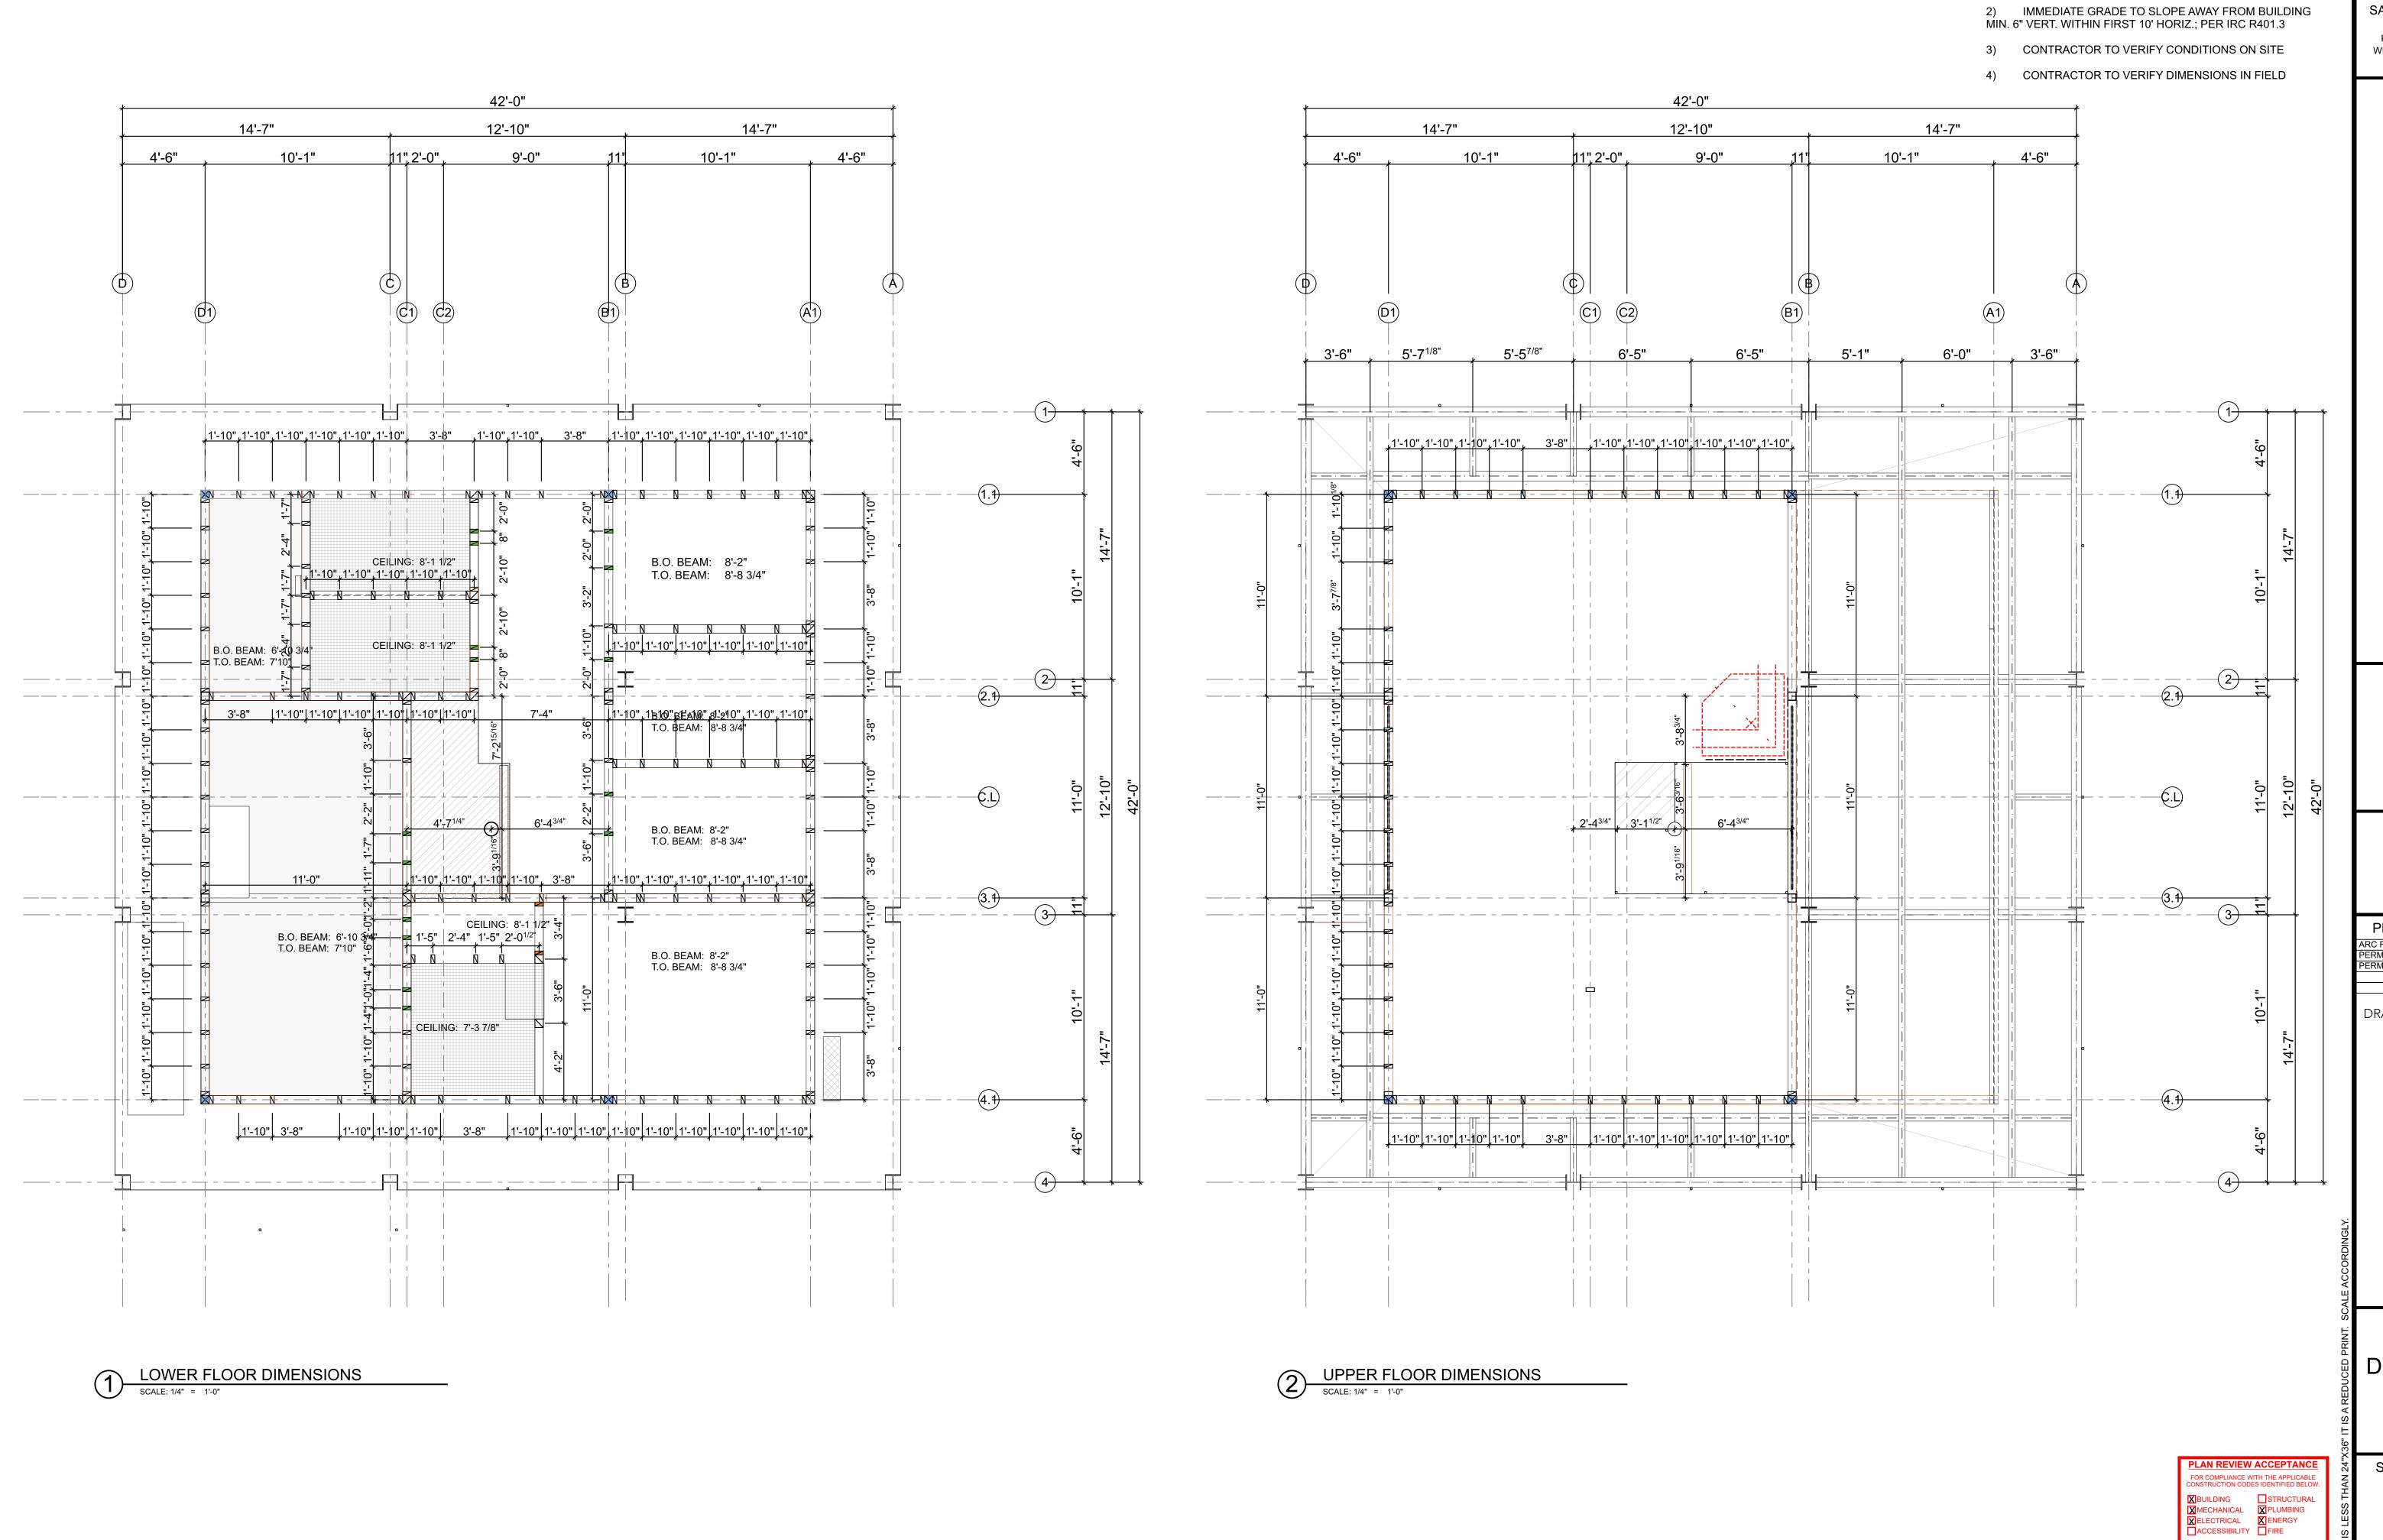LOWER FLOOR RCP

SHEET NUMBER



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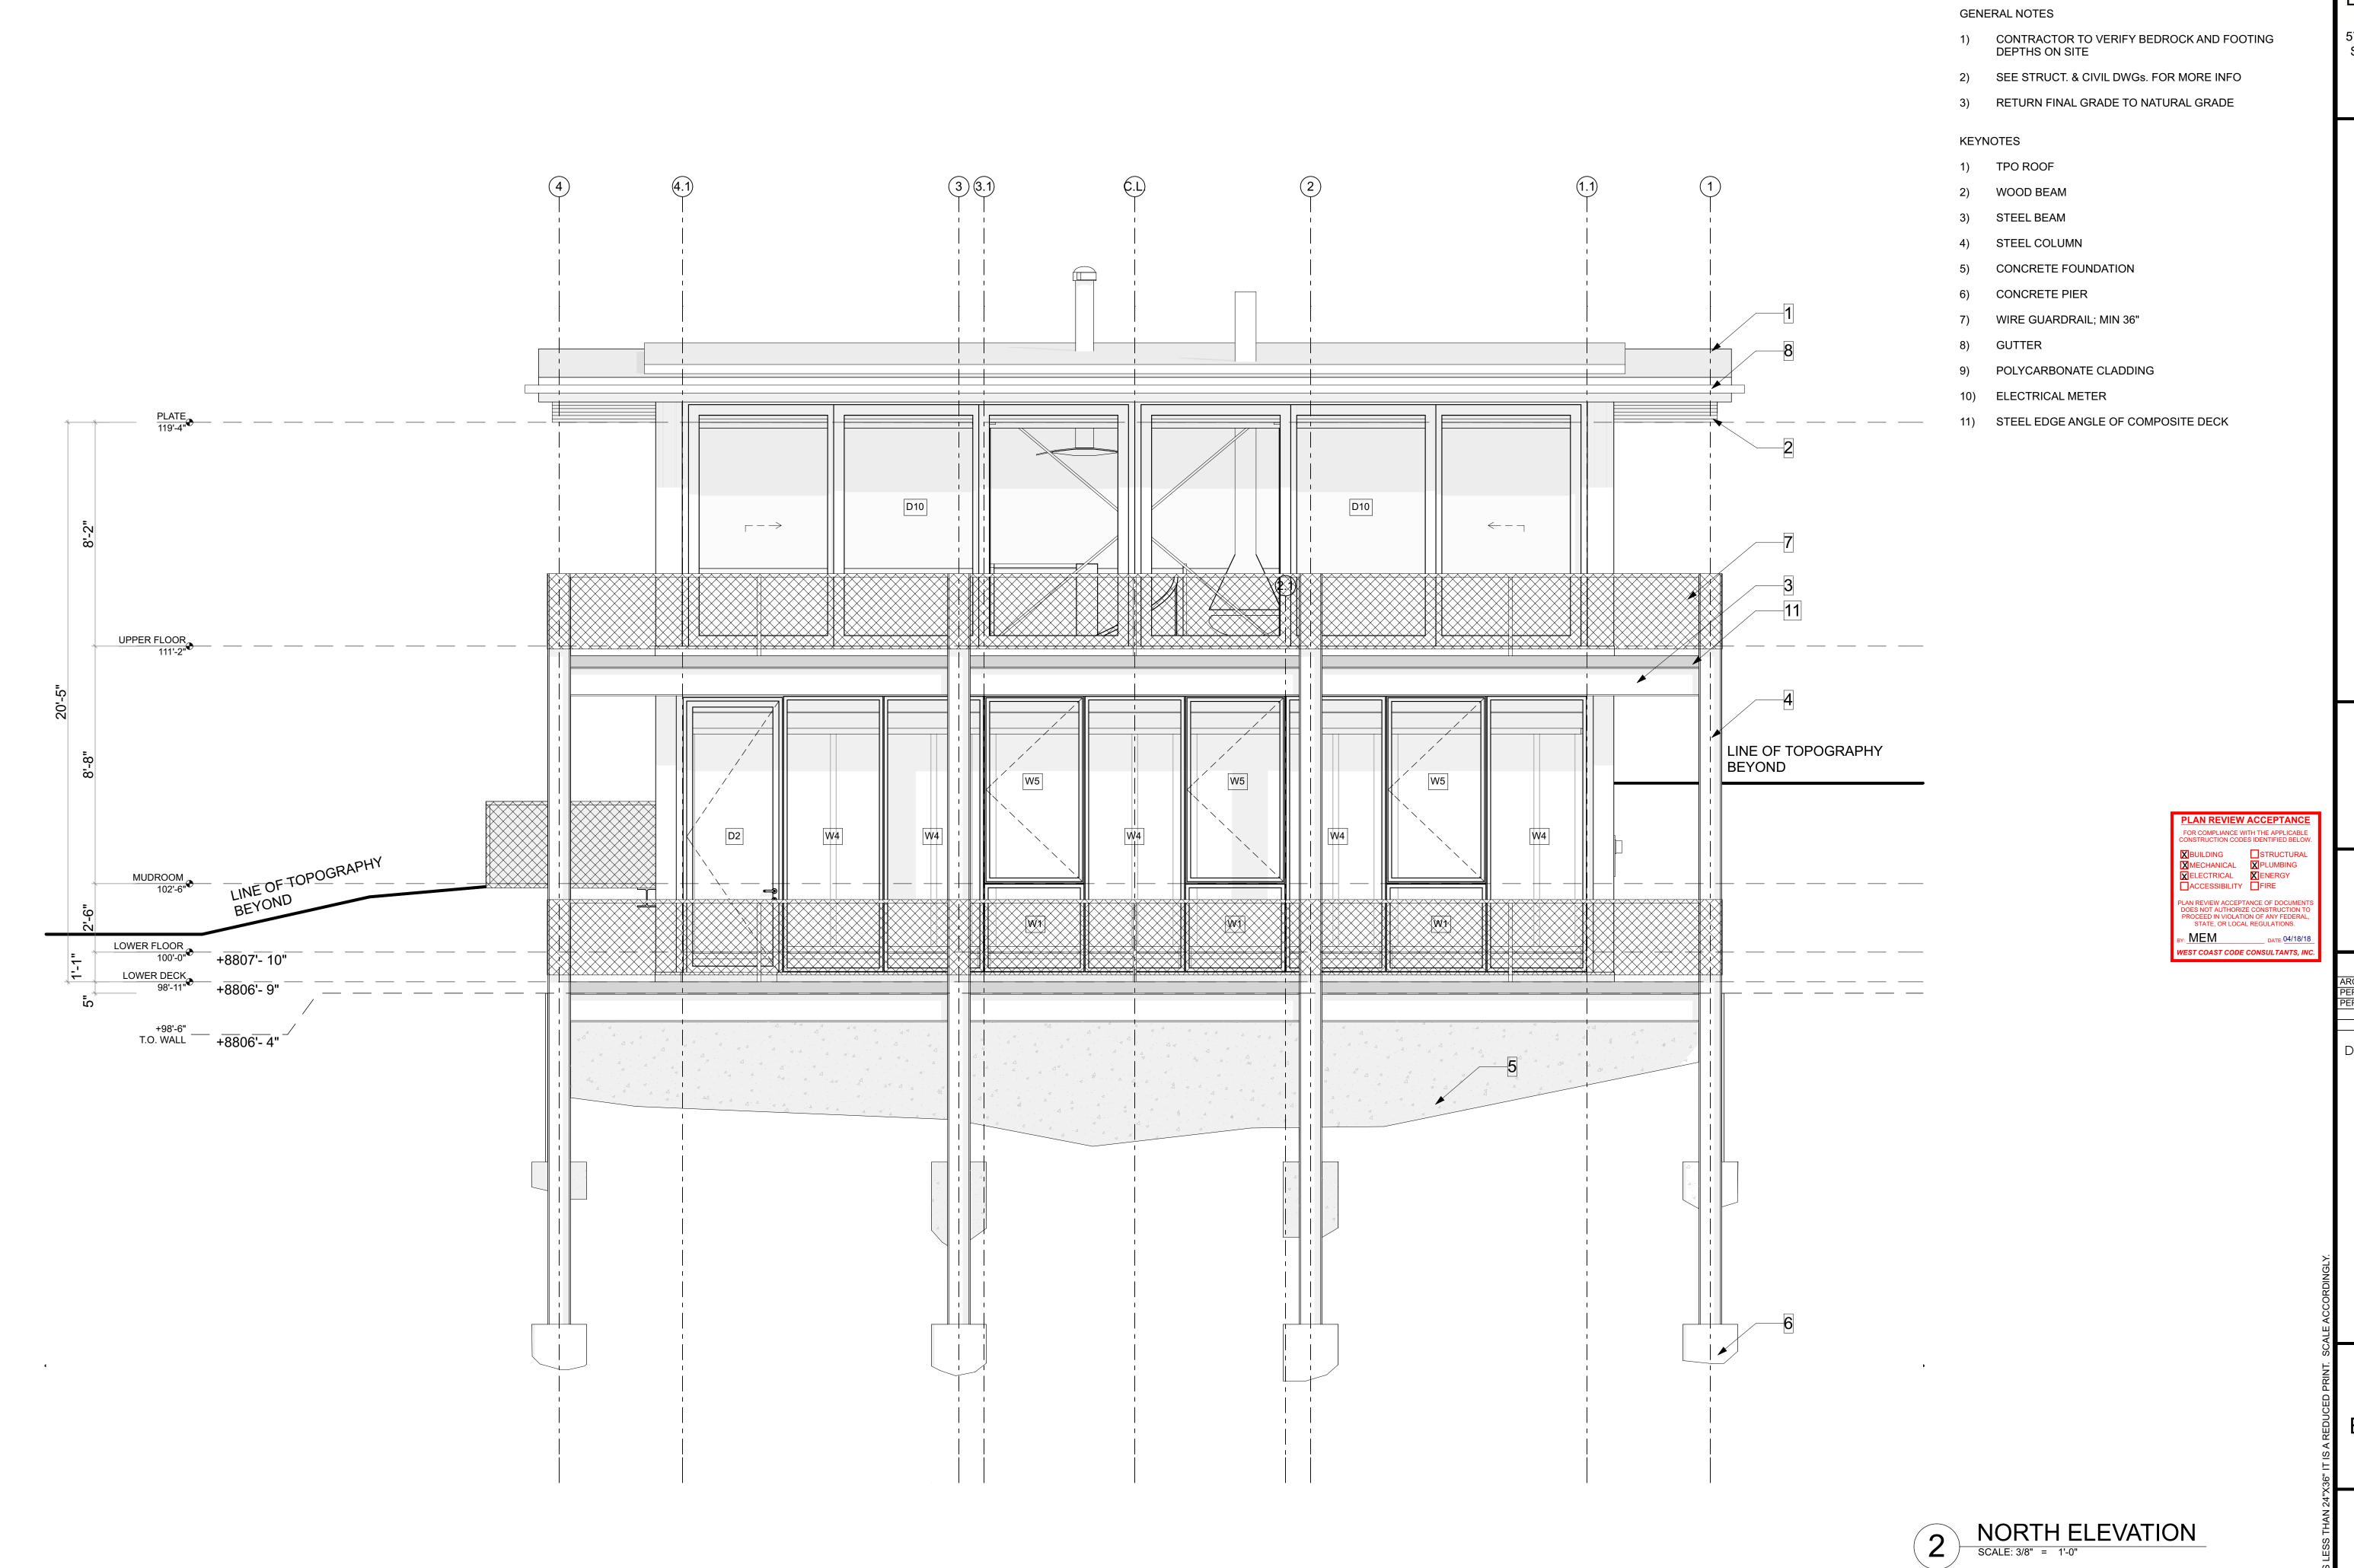
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**UPPER** FLOOR RCP

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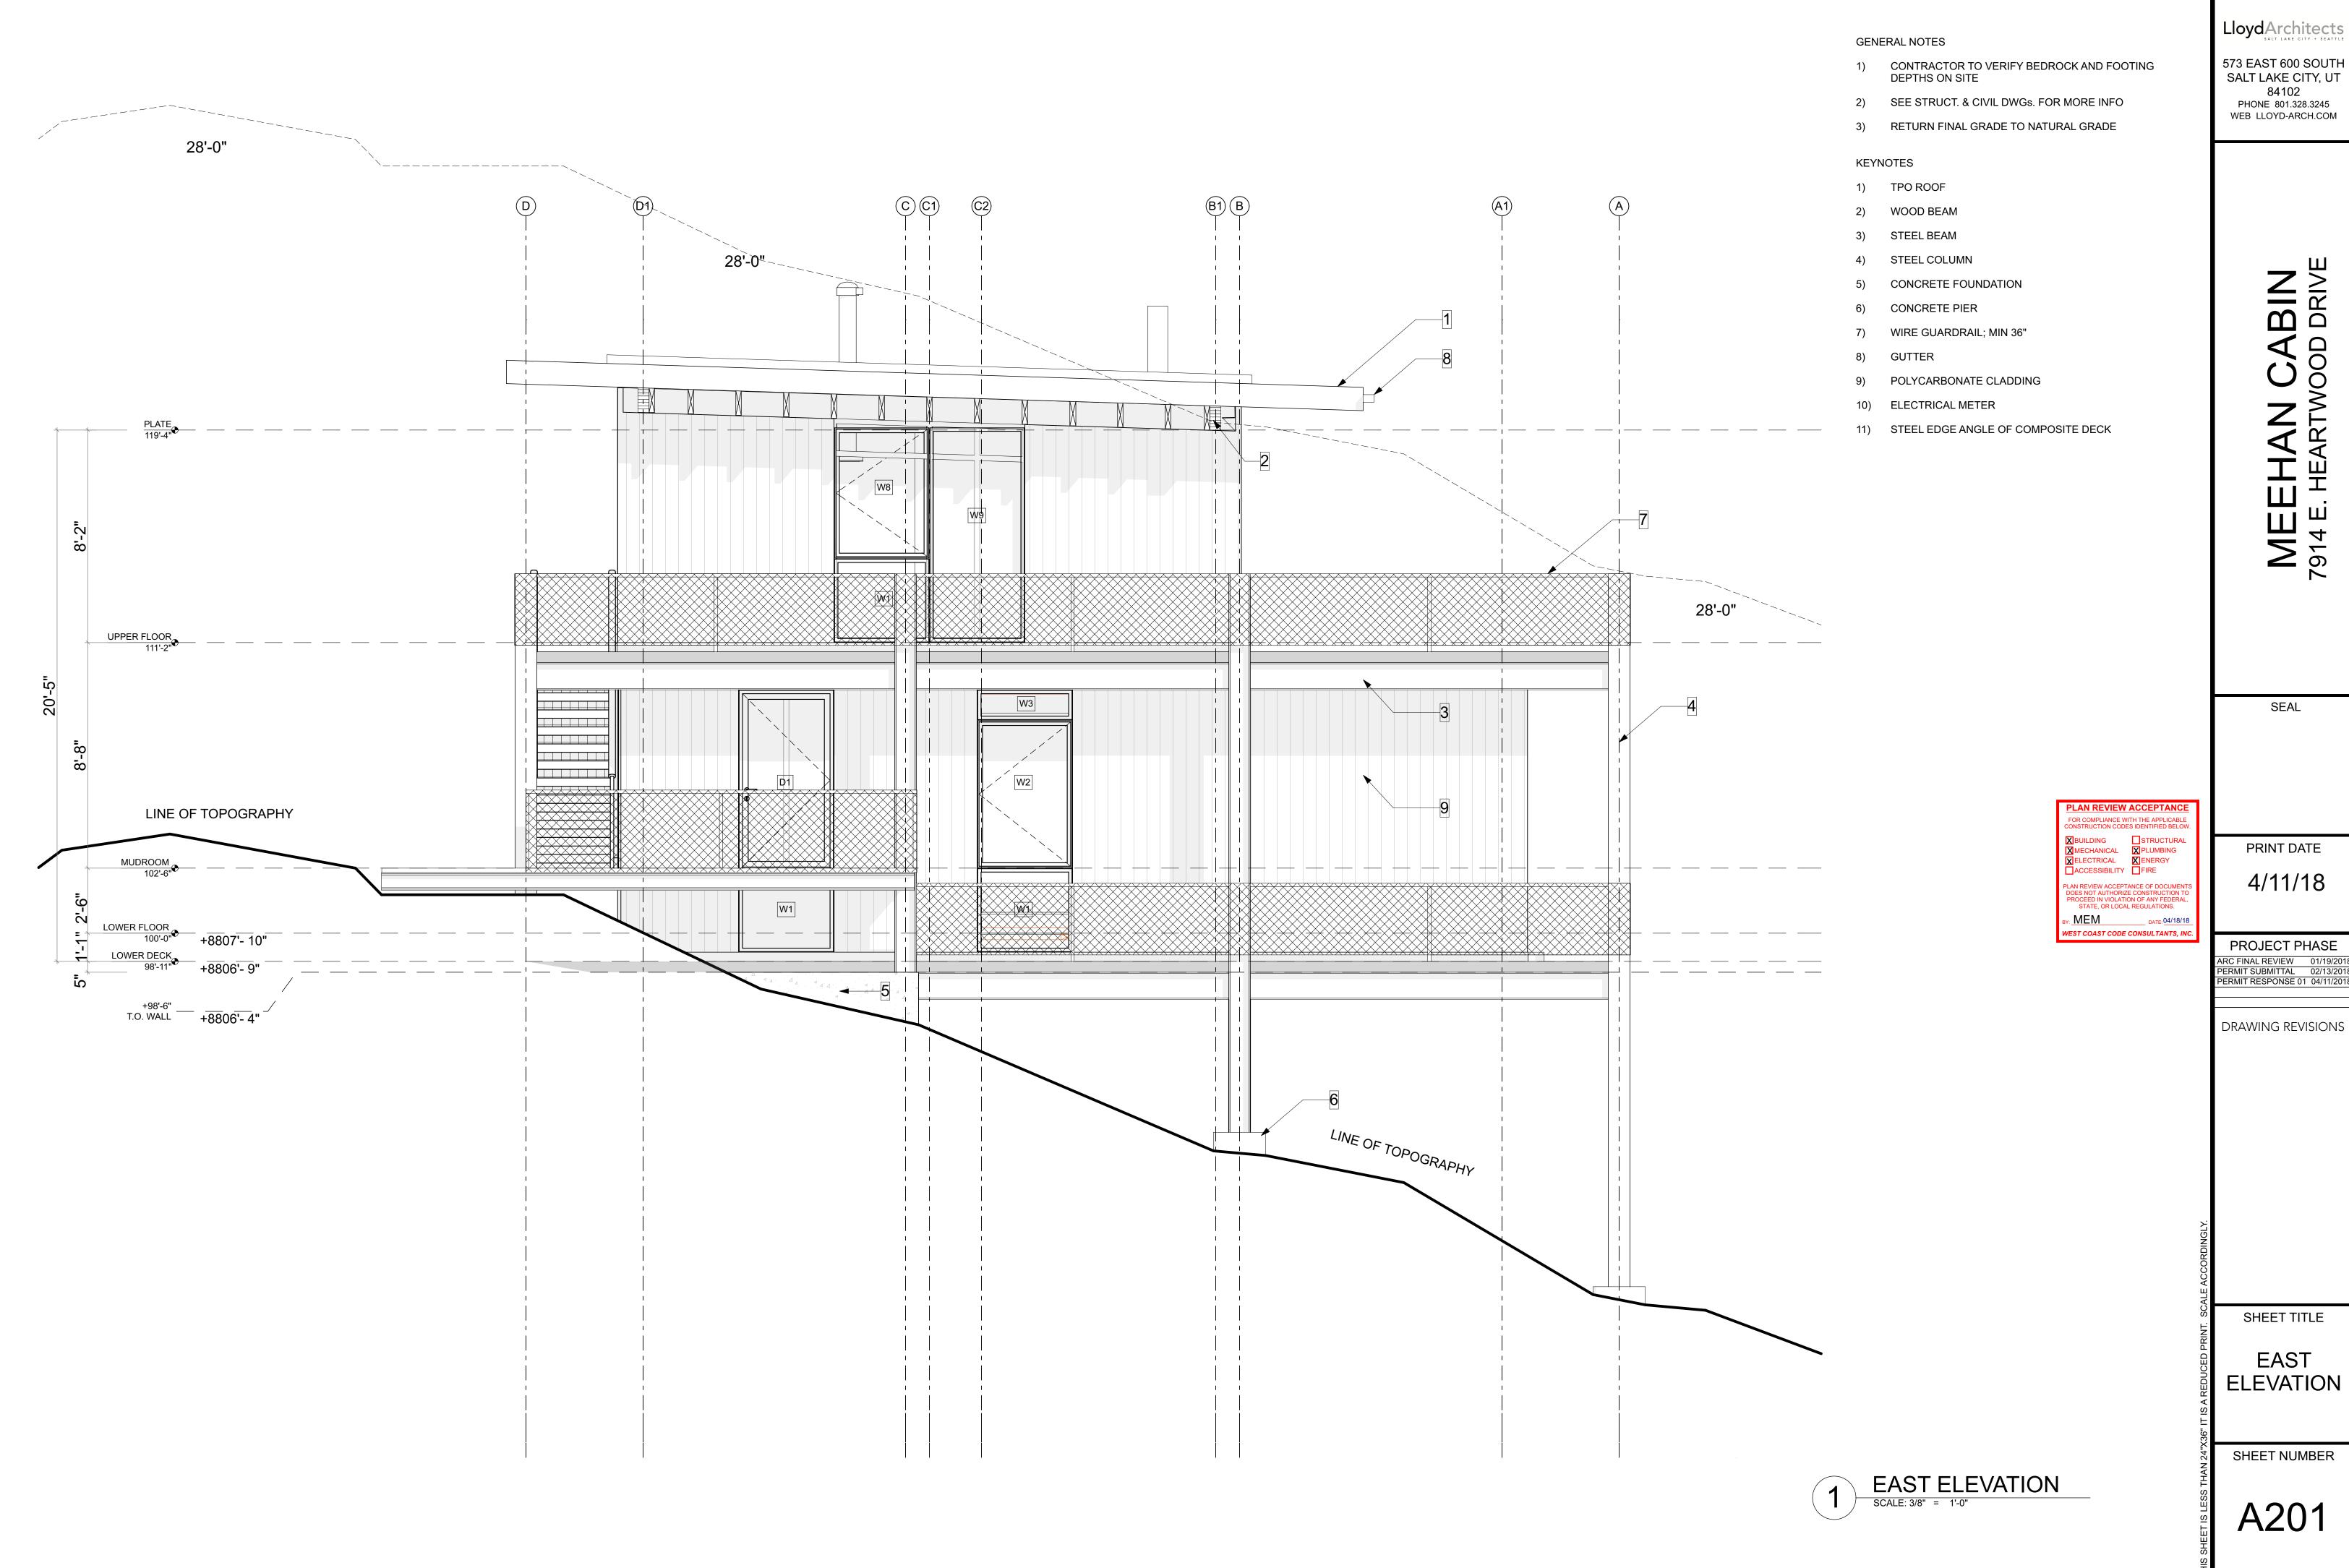
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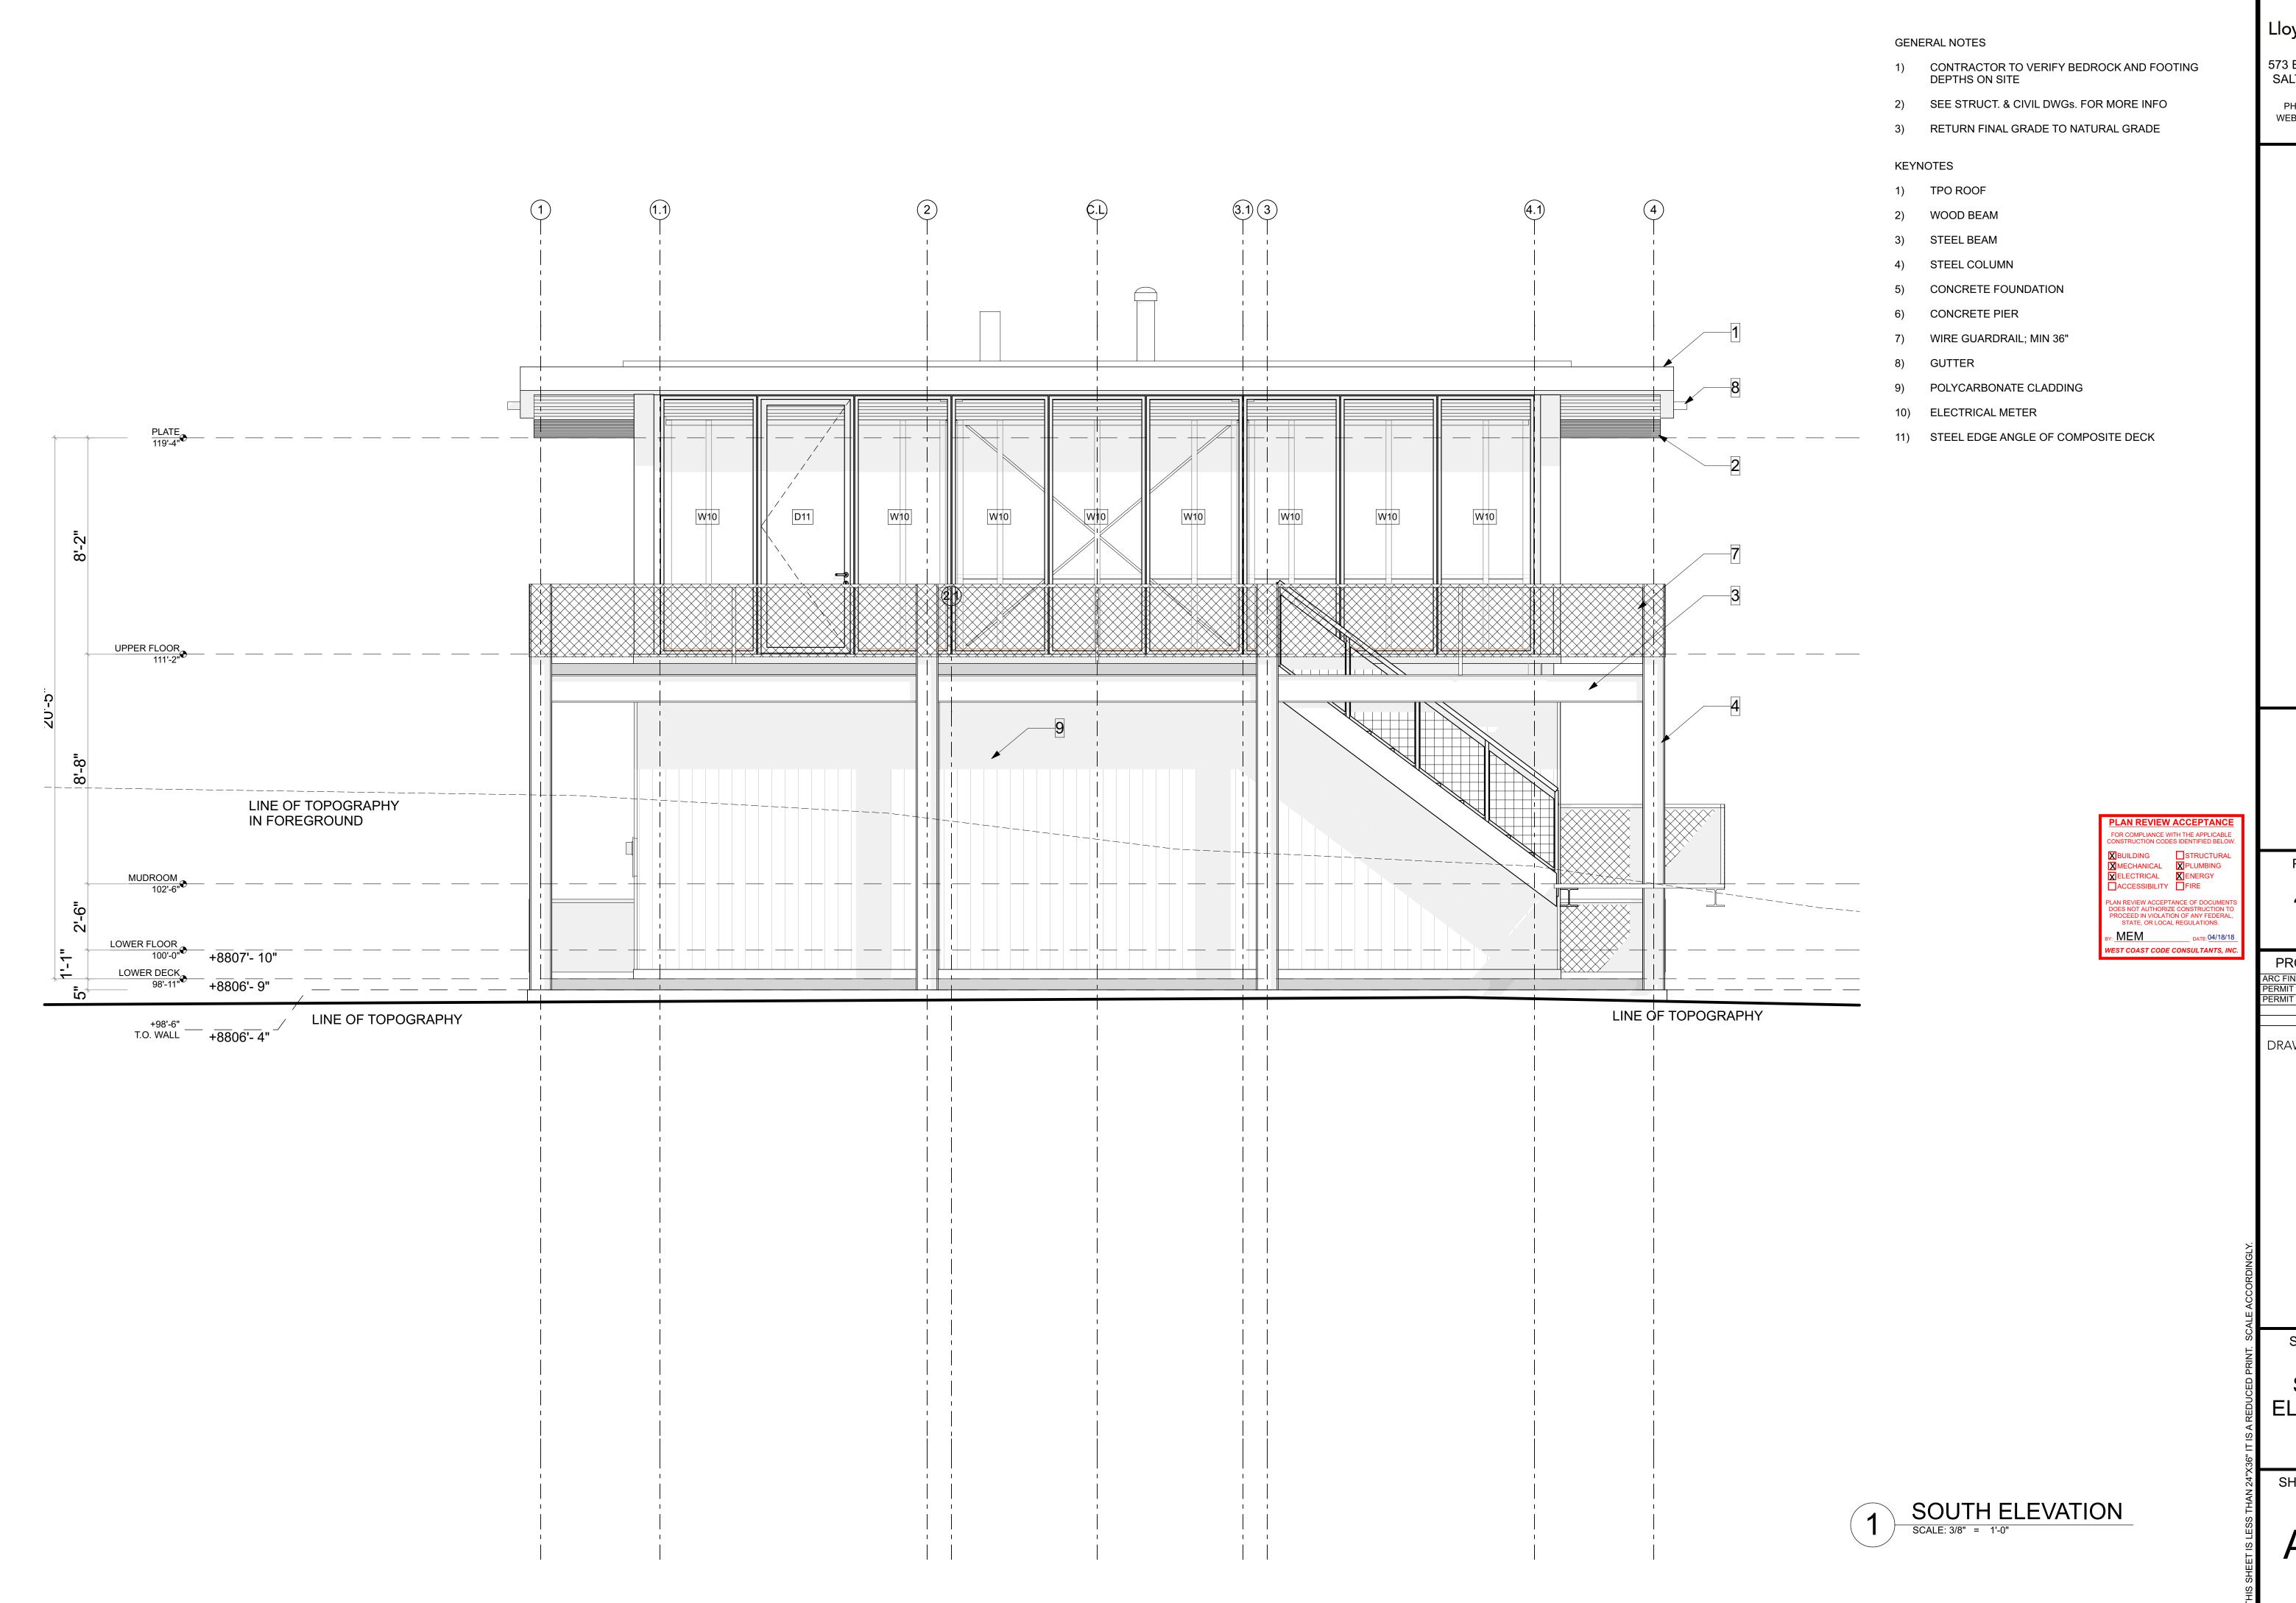
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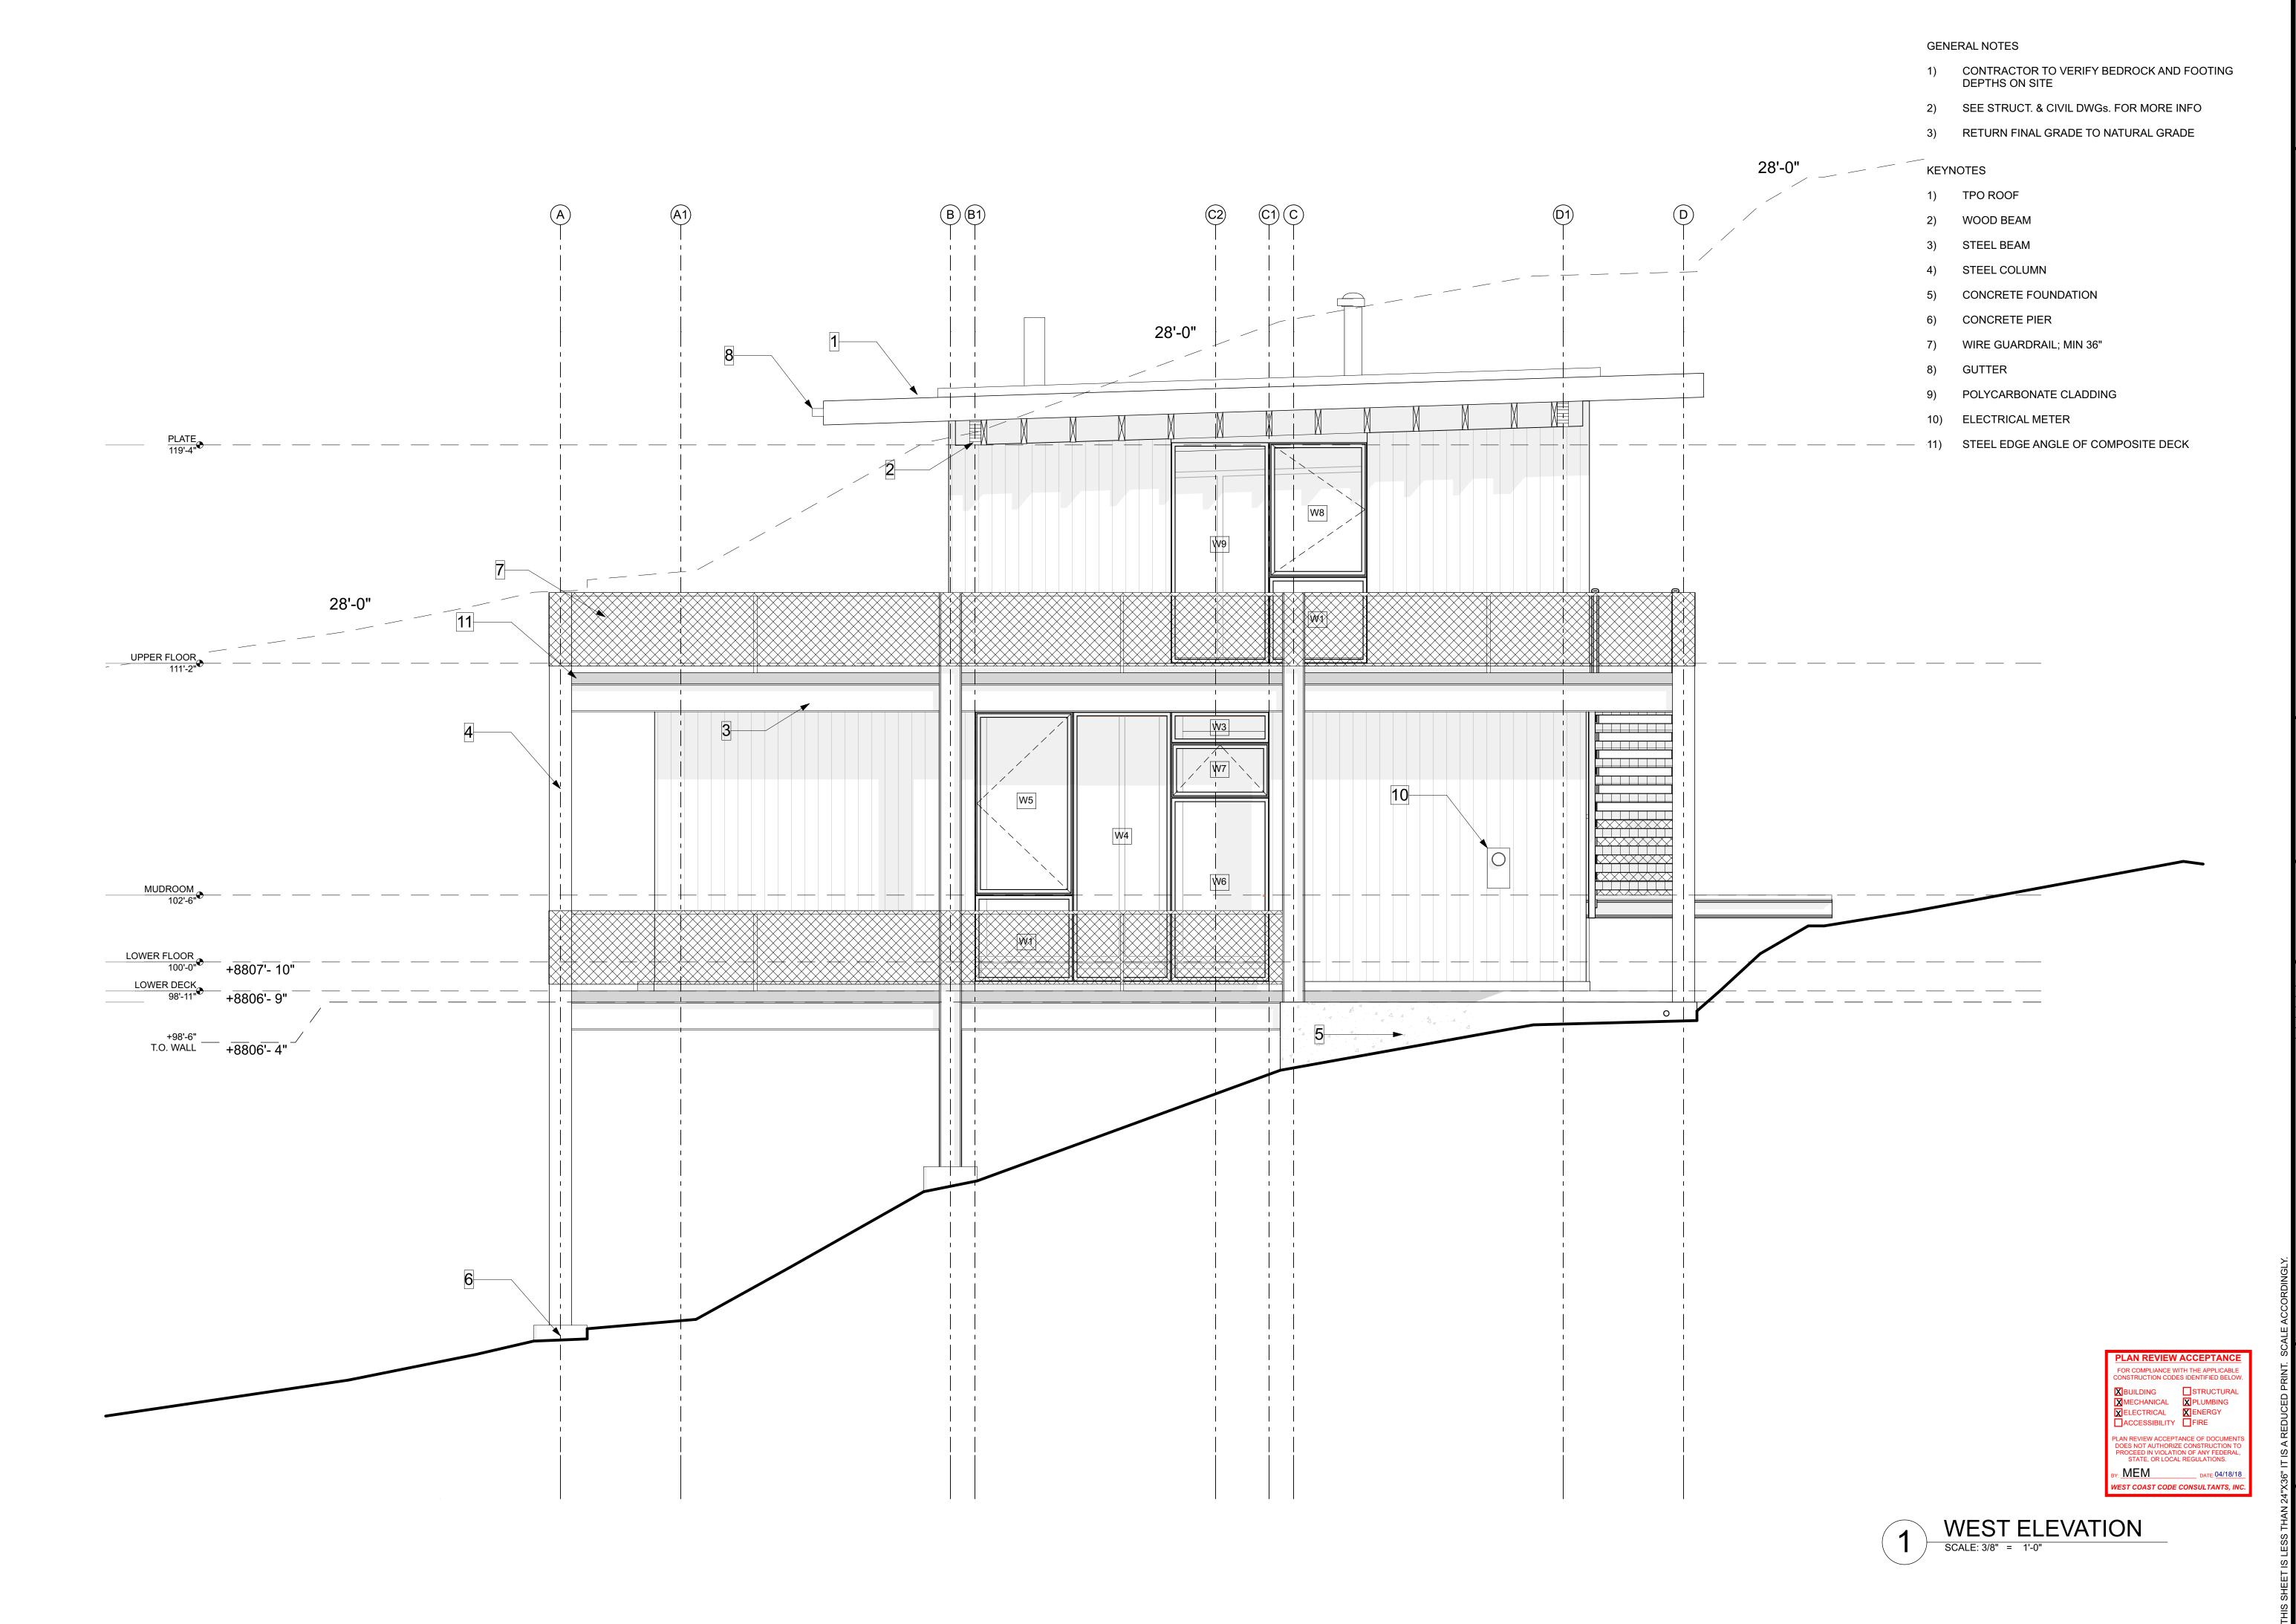
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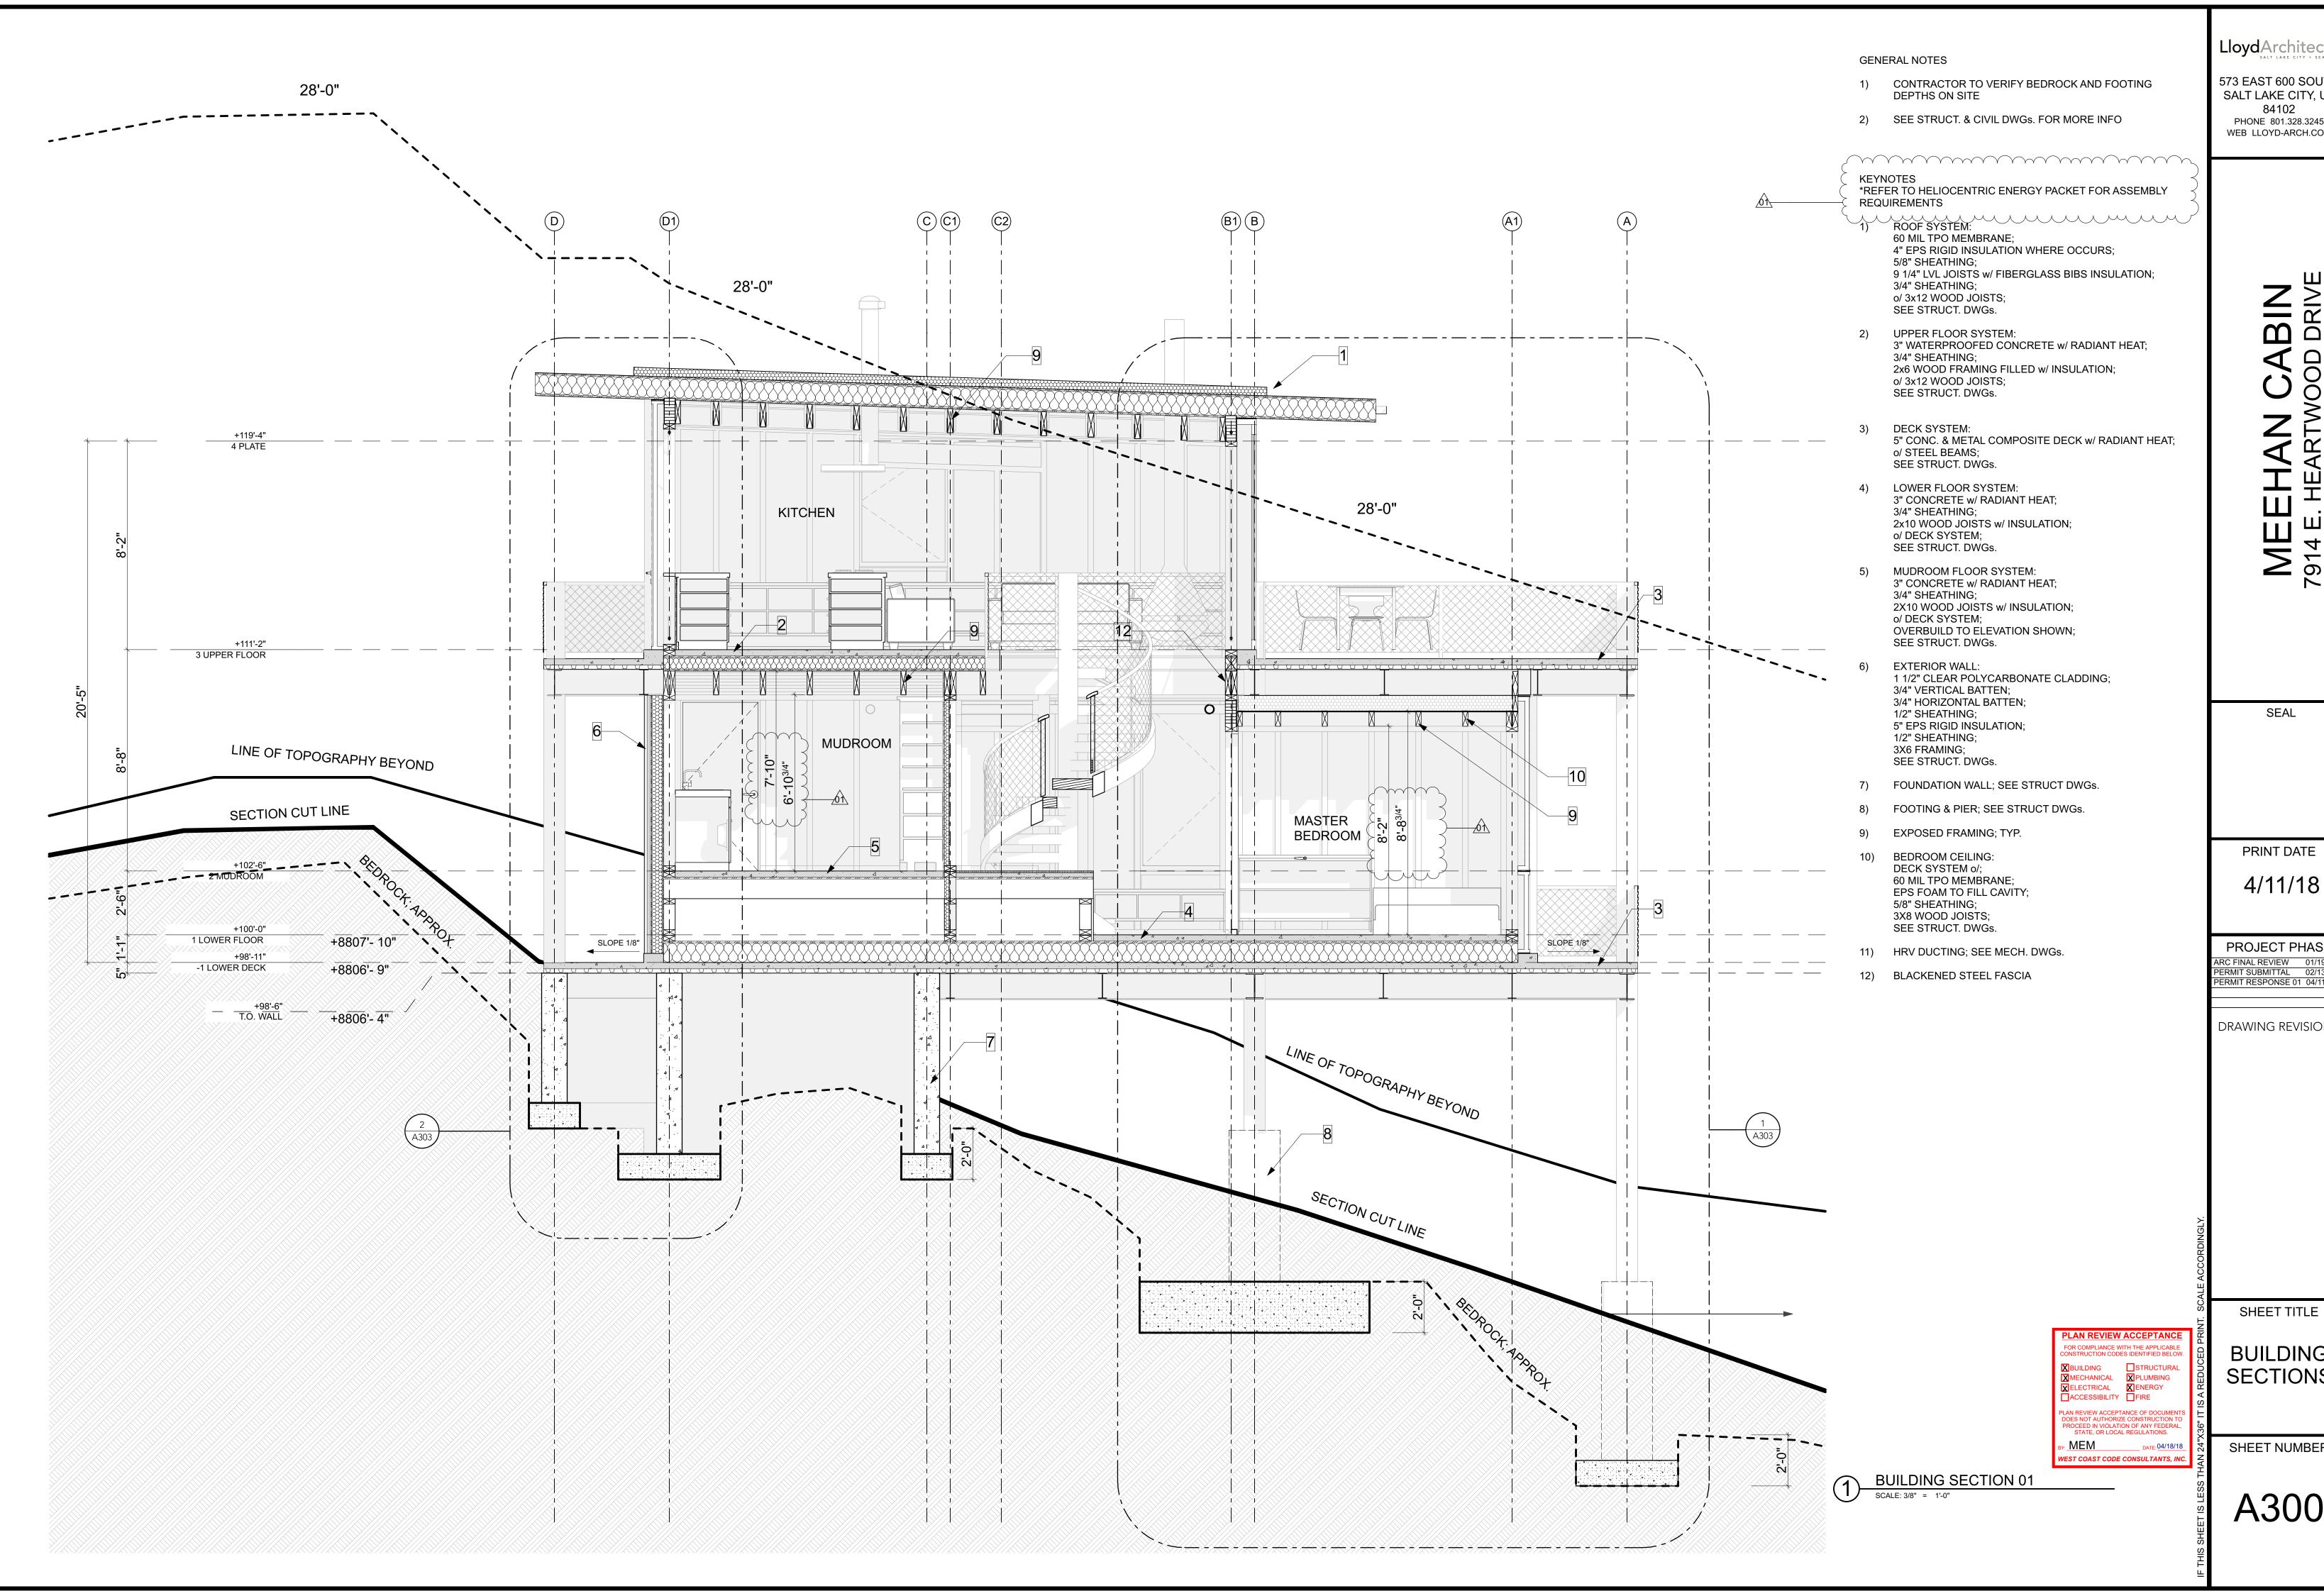
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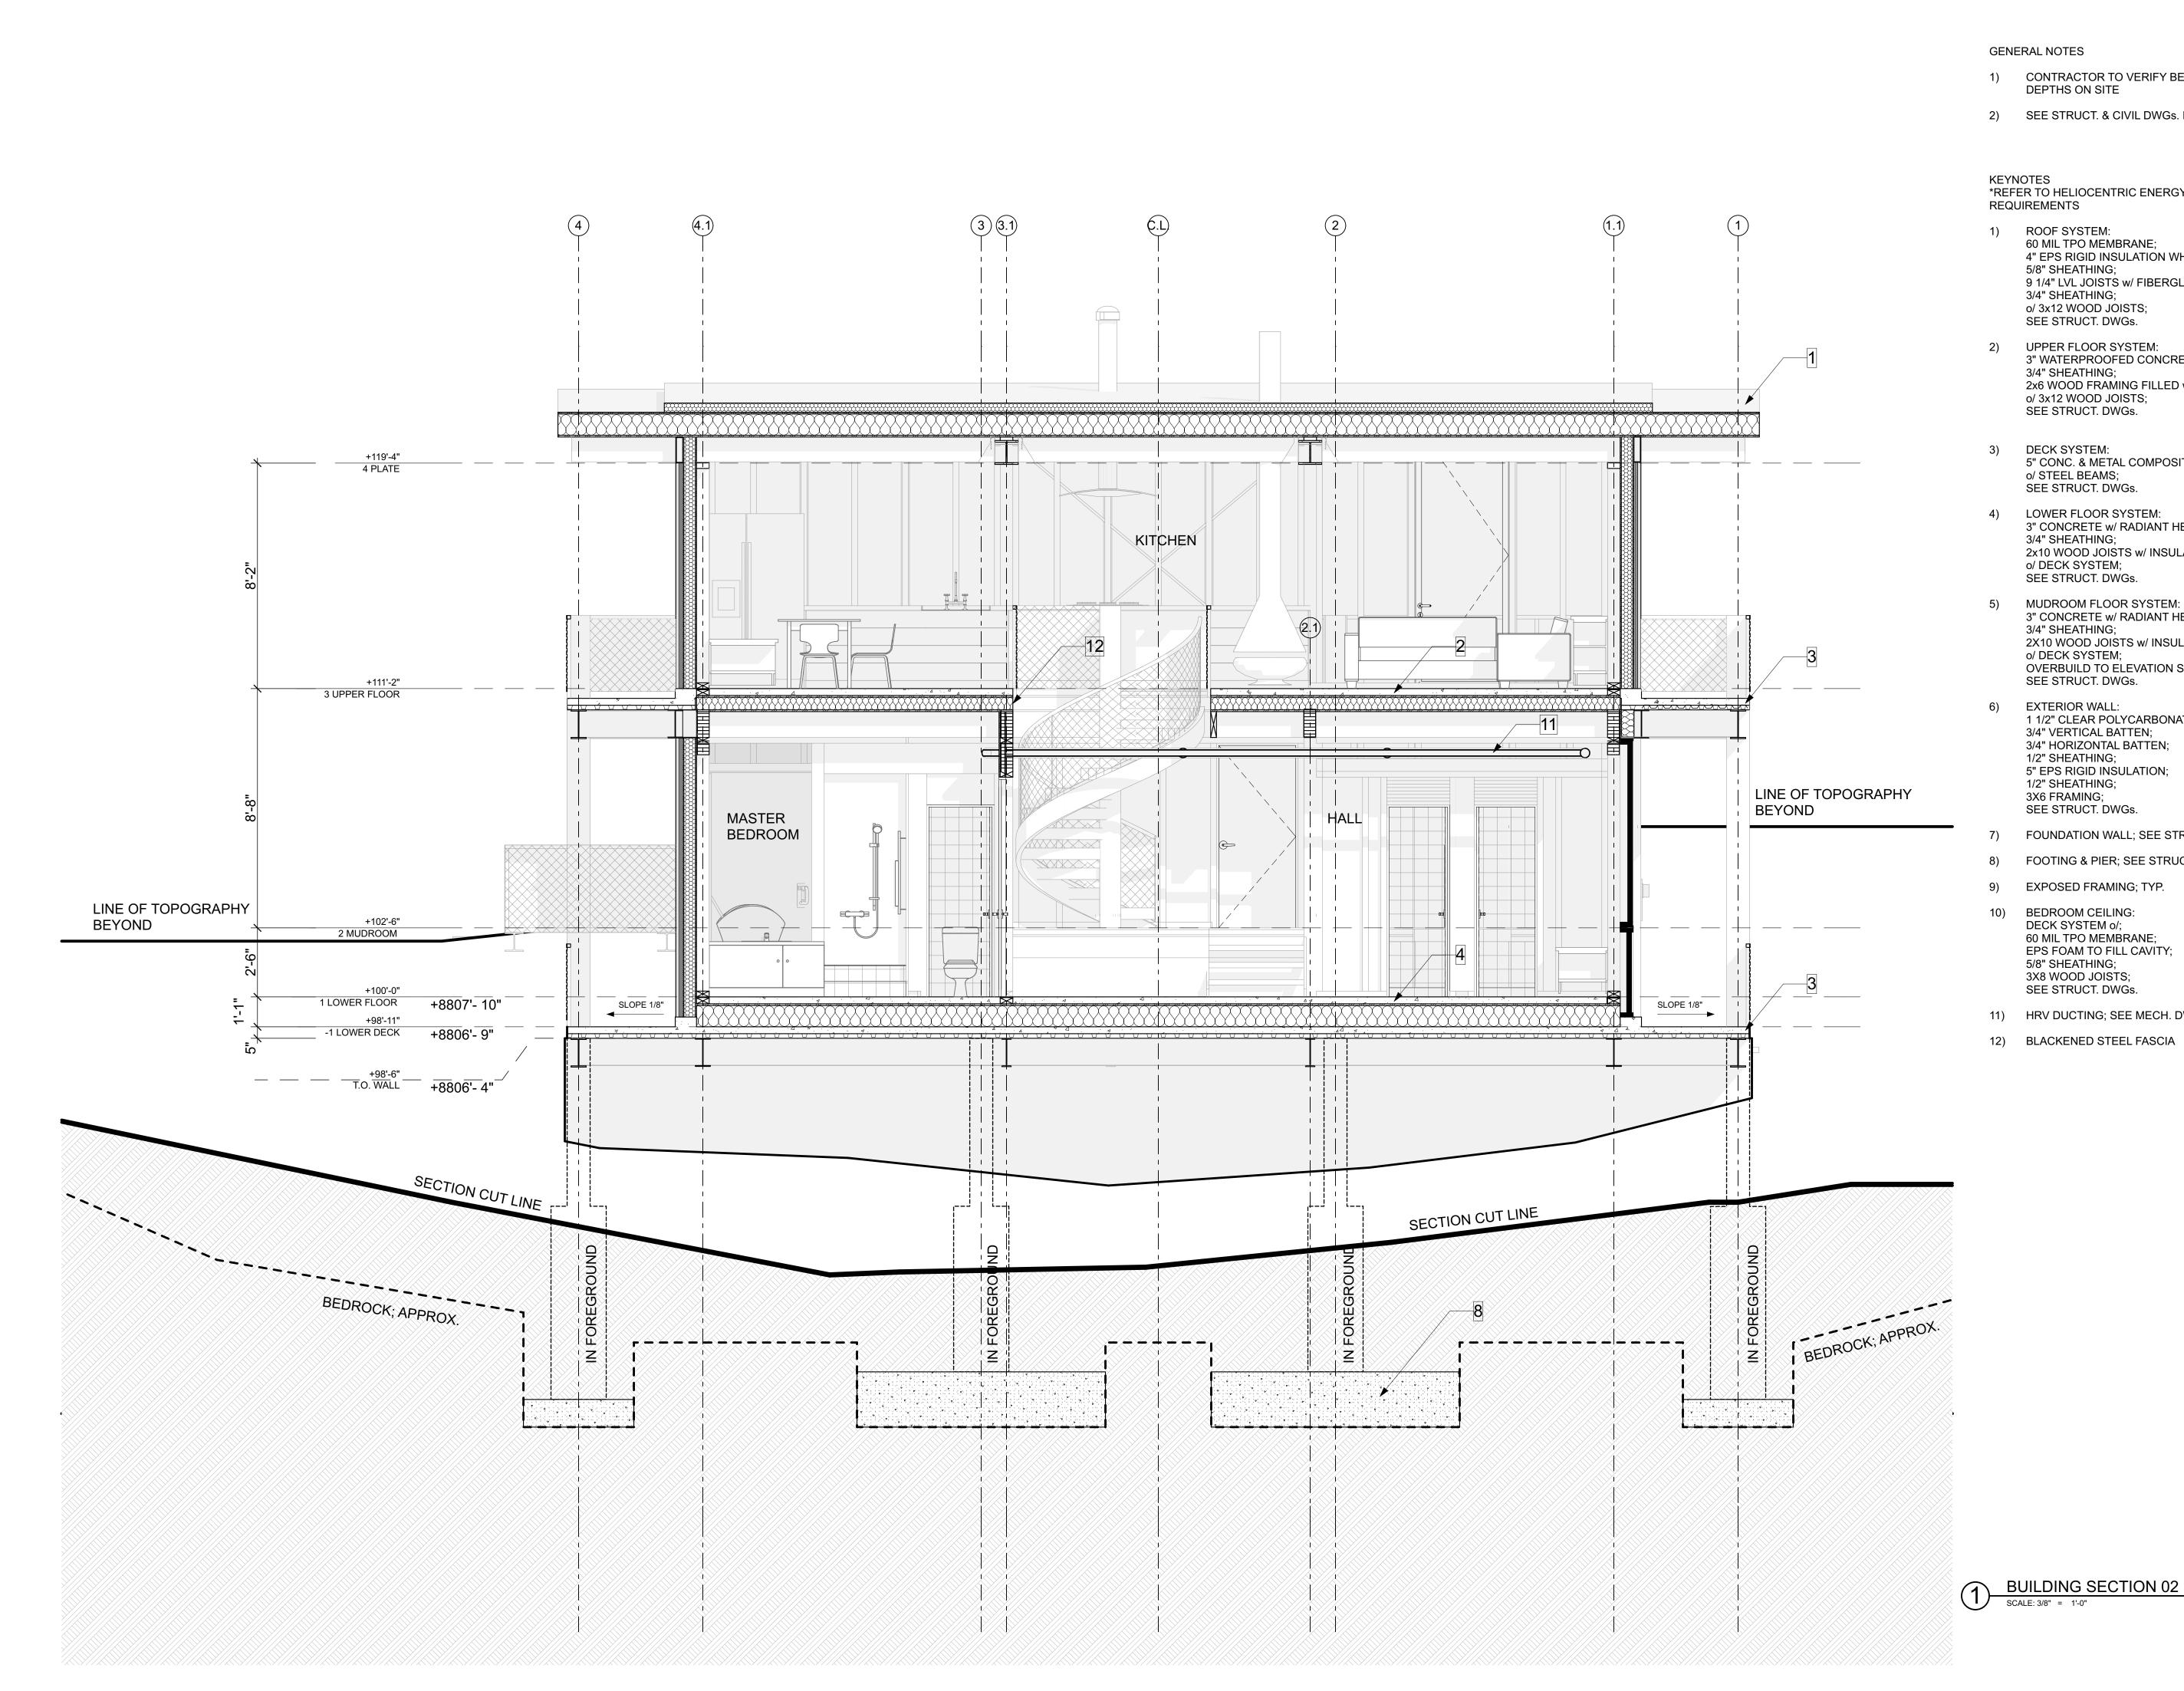
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SHEET TITLE

BUILDING SECTIONS

SHEET NUMBER



- 1) CONTRACTOR TO VERIFY BEDROCK AND FOOTING DEPTHS ON SITE
- 2) SEE STRUCT. & CIVIL DWGs. FOR MORE INFO

\*REFER TO HELIOCENTRIC ENERGY PACKET FOR ASSEMBLY

- ROOF SYSTEM: 60 MIL TPO MEMBRANE; 4" EPS RIGID INSULATION WHERE OCCURS; 5/8" SHEATHING; 9 1/4" LVL JOISTS w/ FIBERGLASS BIBS INSULATION; 3/4" SHEATHING; o/ 3x12 WOOD JOISTS;
- UPPER FLOOR SYSTEM: 3" WATERPROOFED CONCRETE w/ RADIANT HEAT; 3/4" SHEATHING; 2x6 WOOD FRAMING FILLED w/ INSULATION; o/ 3x12 WOOD JOISTS; SEE STRUCT. DWGs.
- DECK SYSTEM: 5" CONC. & METAL COMPOSITE DECK w/ RADIANT HEAT; o/ STEEL BEAMS;
- 4) LOWER FLOOR SYSTEM: 3" CONCRETE w/ RADIANT HEAT; 3/4" SHEATHING; 2x10 WOOD JOISTS w/ INSULATION; o/ DECK SYSTEM; SEE STRUCT. DWGs.
- 5) MUDROOM FLOOR SYSTEM: 3" CONCRETE w/ RADIANT HEAT; 3/4" SHEATHING; 2X10 WOOD JOISTS w/ INSULATION; o/ DECK SYSTEM; OVERBUILD TO ELEVATION SHOWN; SEE STRUCT. DWGs.
- 1 1/2" CLEAR POLYCARBONATE CLADDING; 3/4" VERTICAL BATTEN; 3/4" HORIZONTAL BATTEN; 1/2" SHEATHING; 5" EPS RIGID INSULATION; 1/2" SHEATHING; 3X6 FRAMING; SEE STRUCT. DWGs.
- 7) FOUNDATION WALL; SEE STRUCT DWGs.
- 8) FOOTING & PIER; SEE STRUCT DWGs.
- 9) EXPOSED FRAMING; TYP.
- 10) BEDROOM CEILING: DECK SYSTEM o/; 60 MIL TPO MEMBRANE; EPS FOAM TO FILL CAVITY; 5/8" SHEATHING; 3X8 WOOD JOISTS; SEE STRUCT. DWGs.
- 11) HRV DUCTING; SEE MECH. DWGs.
- 12) BLACKENED STEEL FASCIA

SHEET TITLE

BUILDING SECTIONS

SHEET NUMBER

PLAN REVIEW ACCEPTANCE FOR COMPLIANCE WITH THE APPLICABLE CONSTRUCTION CODES IDENTIFIED BELO

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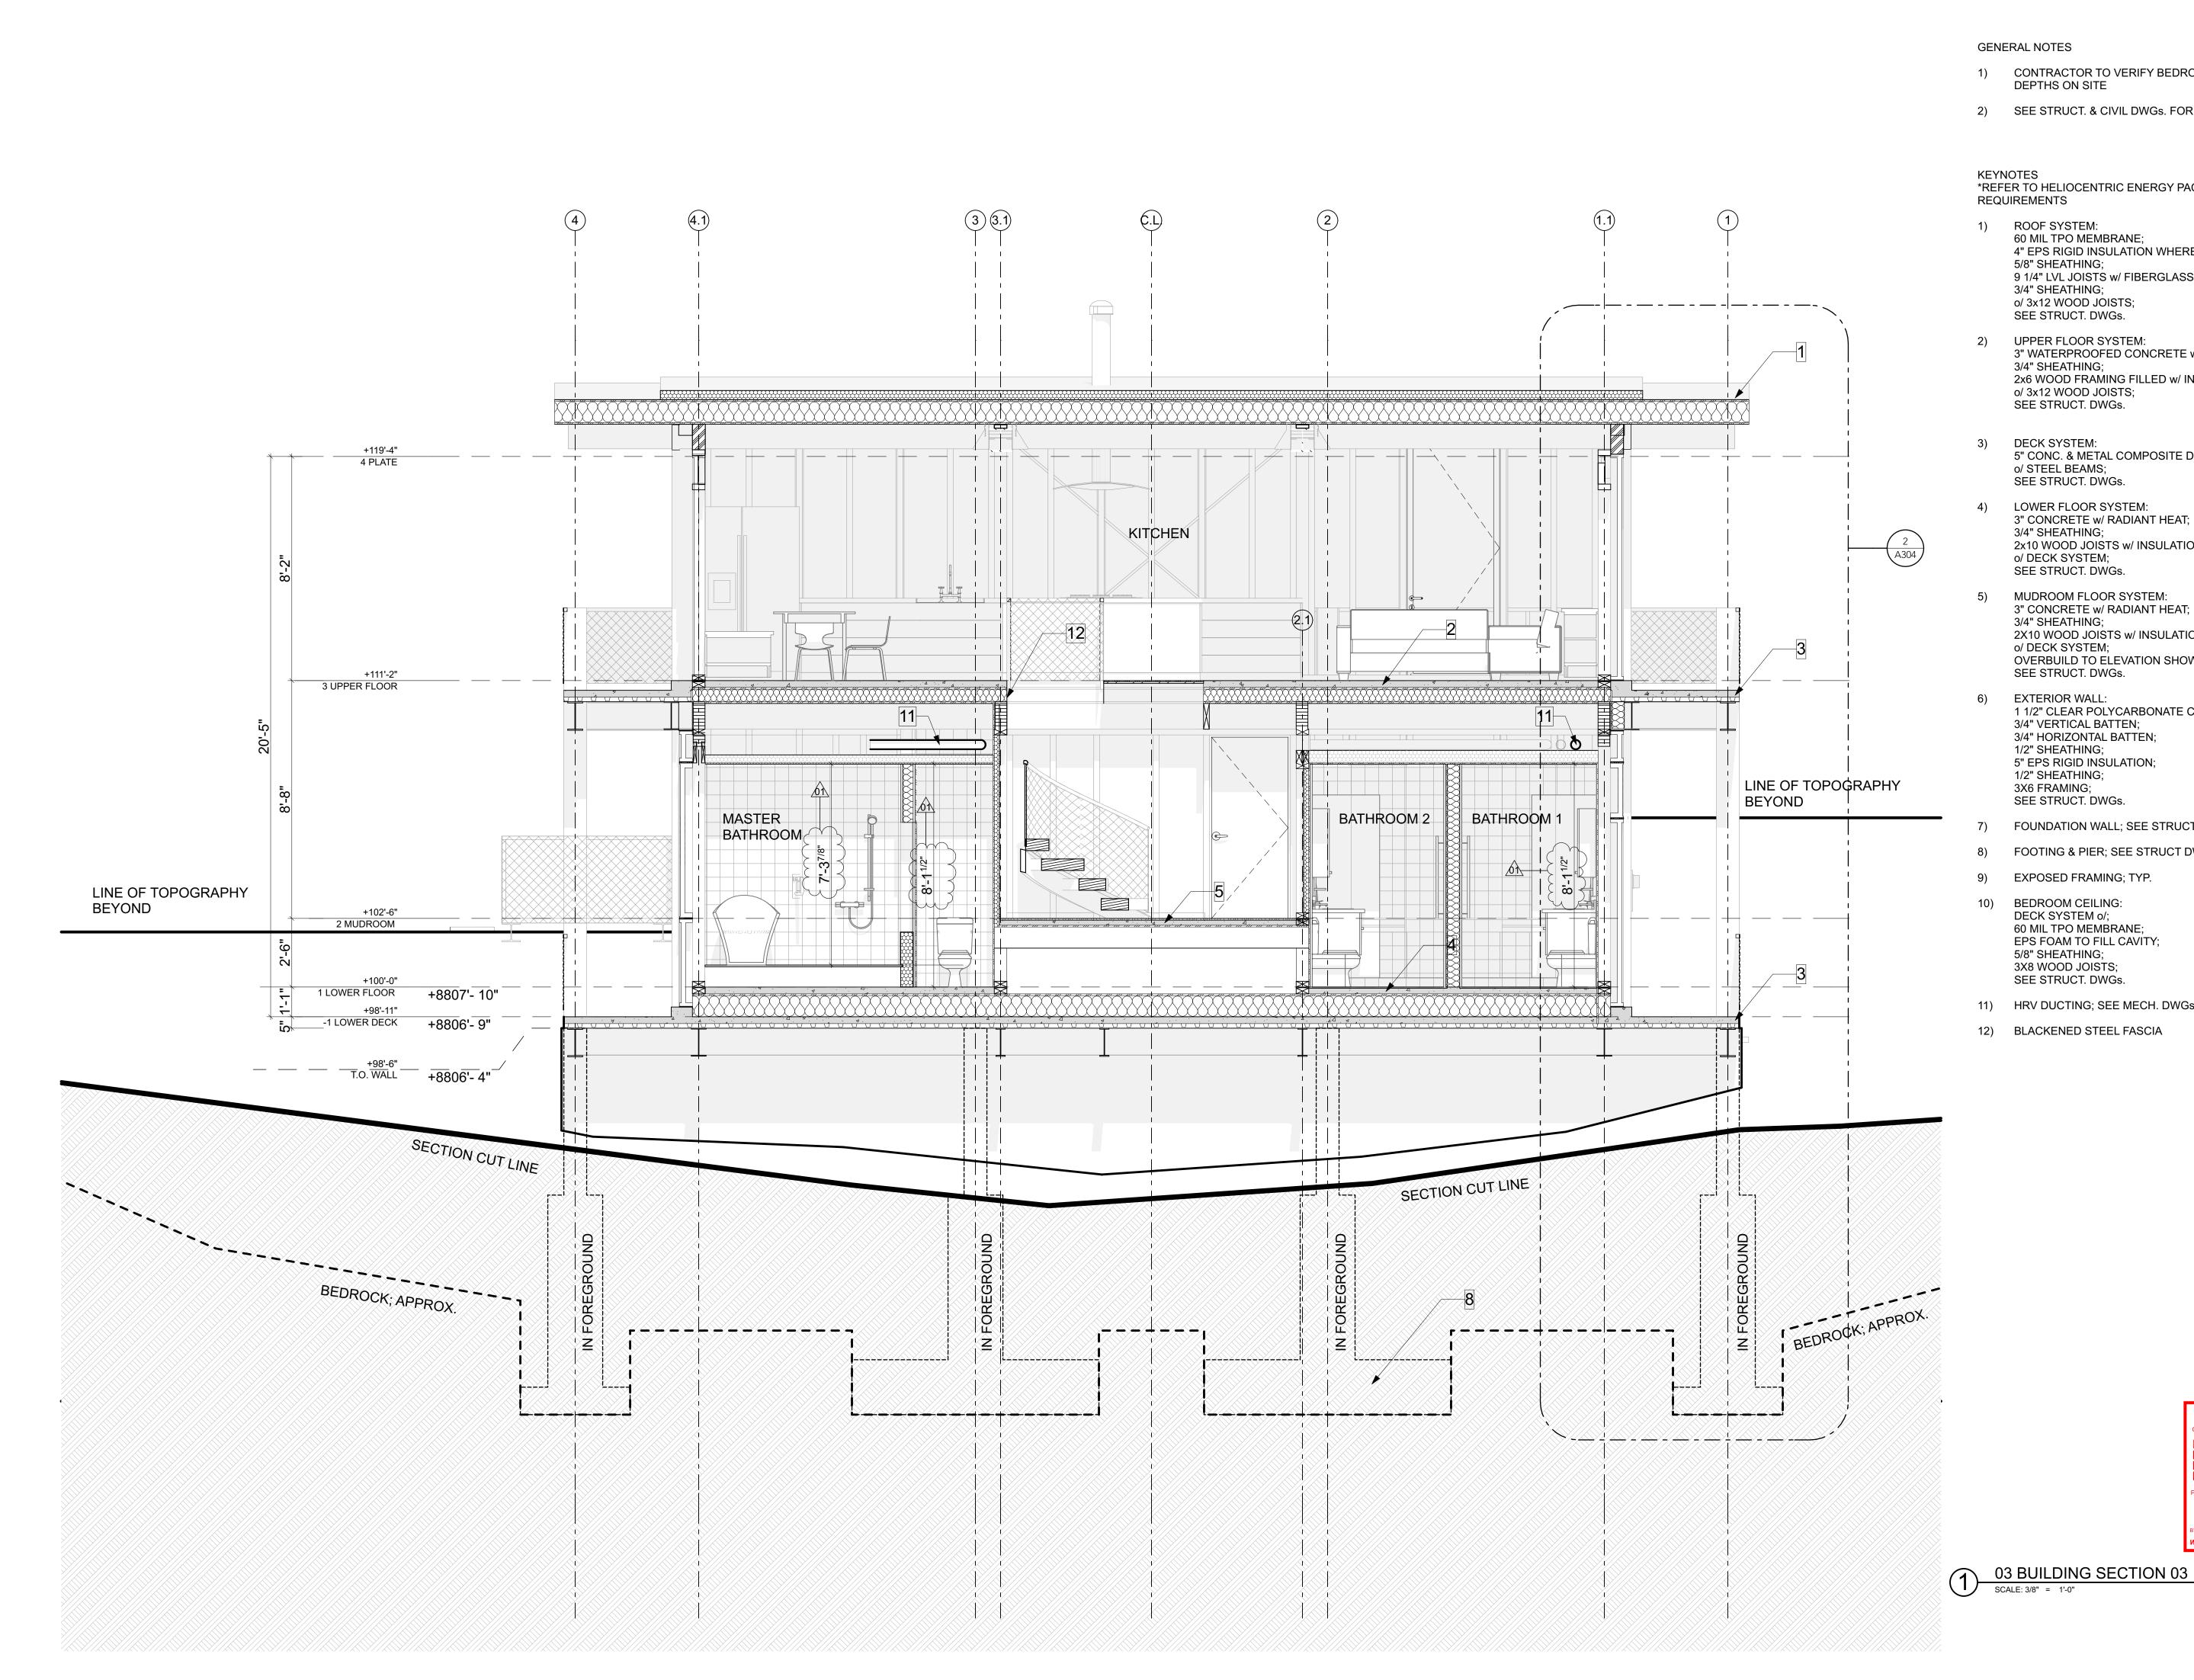
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- 1) CONTRACTOR TO VERIFY BEDROCK AND FOOTING DEPTHS ON SITE
- 2) SEE STRUCT. & CIVIL DWGs. FOR MORE INFO

\*REFER TO HELIOCENTRIC ENERGY PACKET FOR ASSEMBLY

- ROOF SYSTEM: 60 MIL TPO MEMBRANE; 4" EPS RIGID INSULATION WHERE OCCURS; 5/8" SHEATHING; 9 1/4" LVL JOISTS w/ FIBERGLASS BIBS INSULATION; 3/4" SHEATHING; o/ 3x12 WOOD JOISTS;
- UPPER FLOOR SYSTEM: 3" WATERPROOFED CONCRETE w/ RADIANT HEAT; 3/4" SHEATHING; 2x6 WOOD FRAMING FILLED w/ INSULATION; o/ 3x12 WOOD JOISTS; SEE STRUCT. DWGs.
- DECK SYSTEM: 5" CONC. & METAL COMPOSITE DECK w/ RADIANT HEAT; o/ STEEL BEAMS; SEE STRUCT. DWGs.
- LOWER FLOOR SYSTEM: 3" CONCRETE w/ RADIANT HEAT; 3/4" SHEATHING; 2x10 WOOD JOISTS w/ INSULATION; o/ DECK SYSTEM; SEE STRUCT. DWGs.
- MUDROOM FLOOR SYSTEM: 3" CONCRETE w/ RADIANT HEAT; 3/4" SHEATHING; 2X10 WOOD JOISTS w/ INSULATION; o/ DECK SYSTEM; OVERBUILD TO ELEVATION SHOWN; SEE STRUCT. DWGs.
- EXTERIOR WALL: 1 1/2" CLEAR POLYCARBONATE CLADDING; 3/4" VERTICAL BATTEN; 3/4" HORIZONTAL BATTEN; 1/2" SHEATHING; 5" EPS RIGID INSULATION; 1/2" SHEATHING; 3X6 FRAMING; SEE STRUCT. DWGs.
- 7) FOUNDATION WALL; SEE STRUCT DWGs.
- 8) FOOTING & PIER; SEE STRUCT DWGs.
- 9) EXPOSED FRAMING; TYP.
- 10) BEDROOM CEILING: DECK SYSTEM o/; 60 MIL TPO MEMBRANE; EPS FOAM TO FILL CAVITY; 5/8" SHEATHING; 3X8 WOOD JOISTS; SEE STRUCT. DWGs.
- 11) HRV DUCTING; SEE MECH. DWGs.
- 12) BLACKENED STEEL FASCIA

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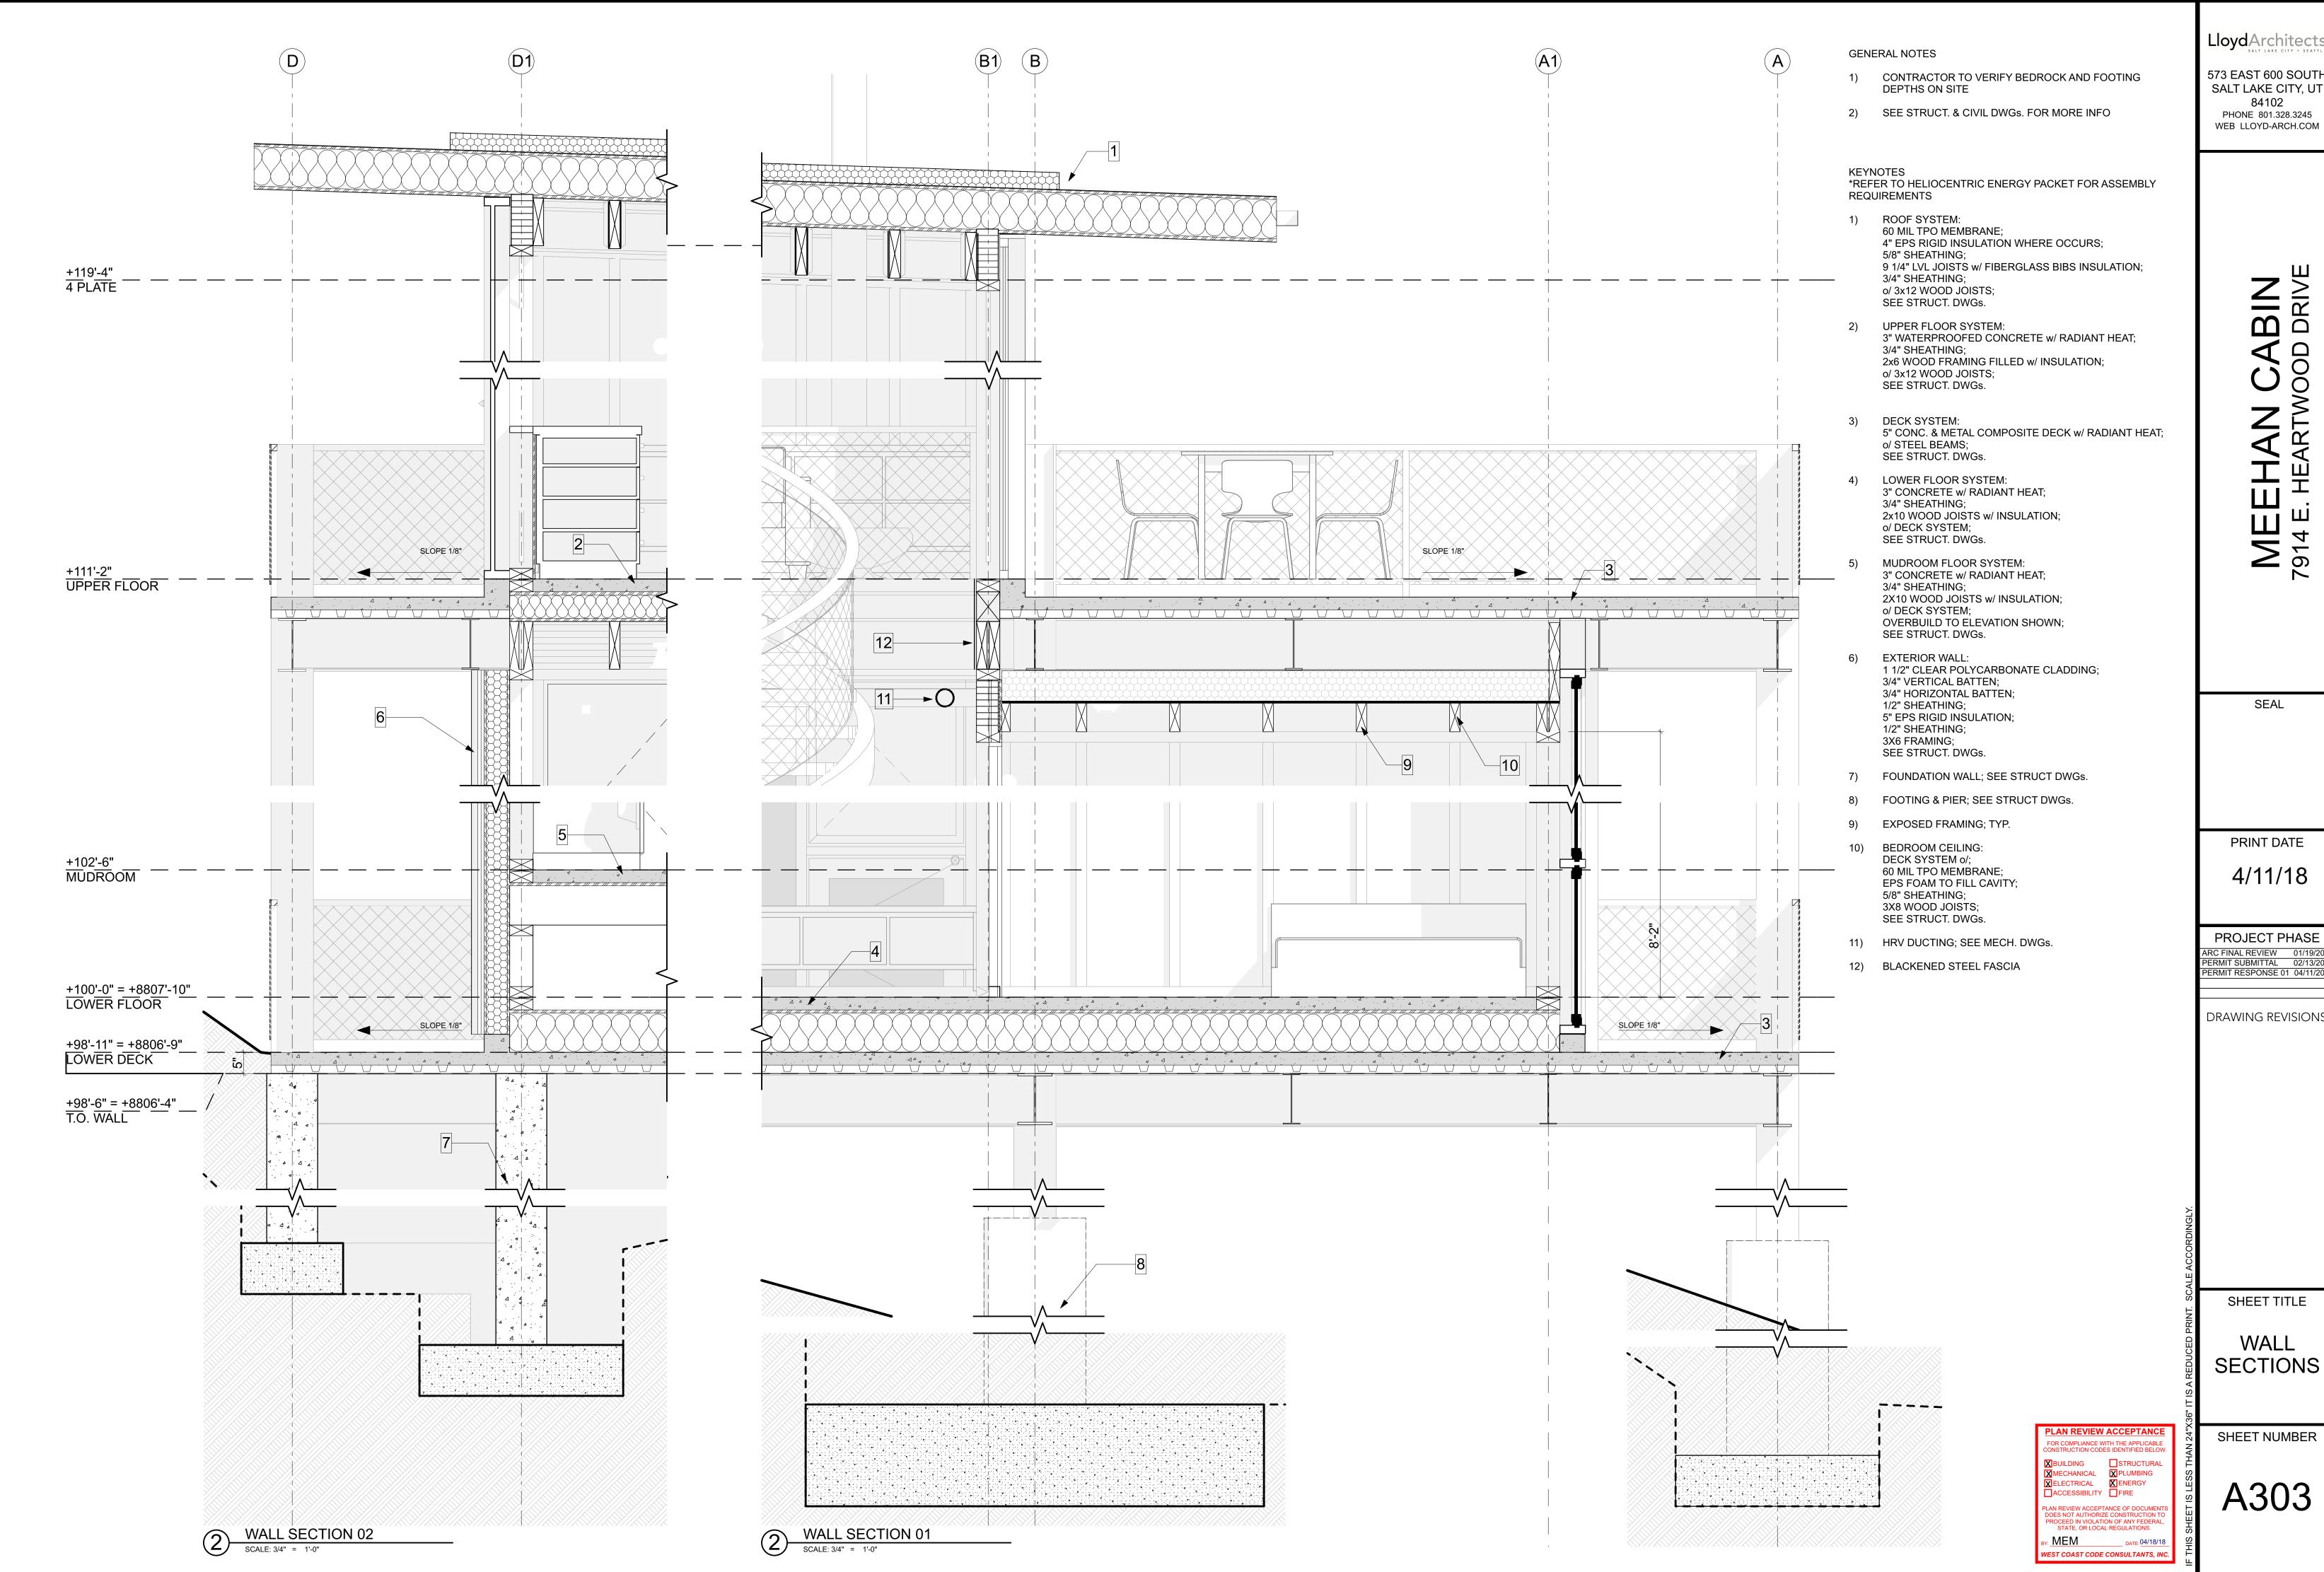
PLAN REVIEW ACCEPTANCE

MECHANICAL PLUMBING

X ELECTRICAL X ENERGY ACCESSIBILITY FIRE

Y: MEM

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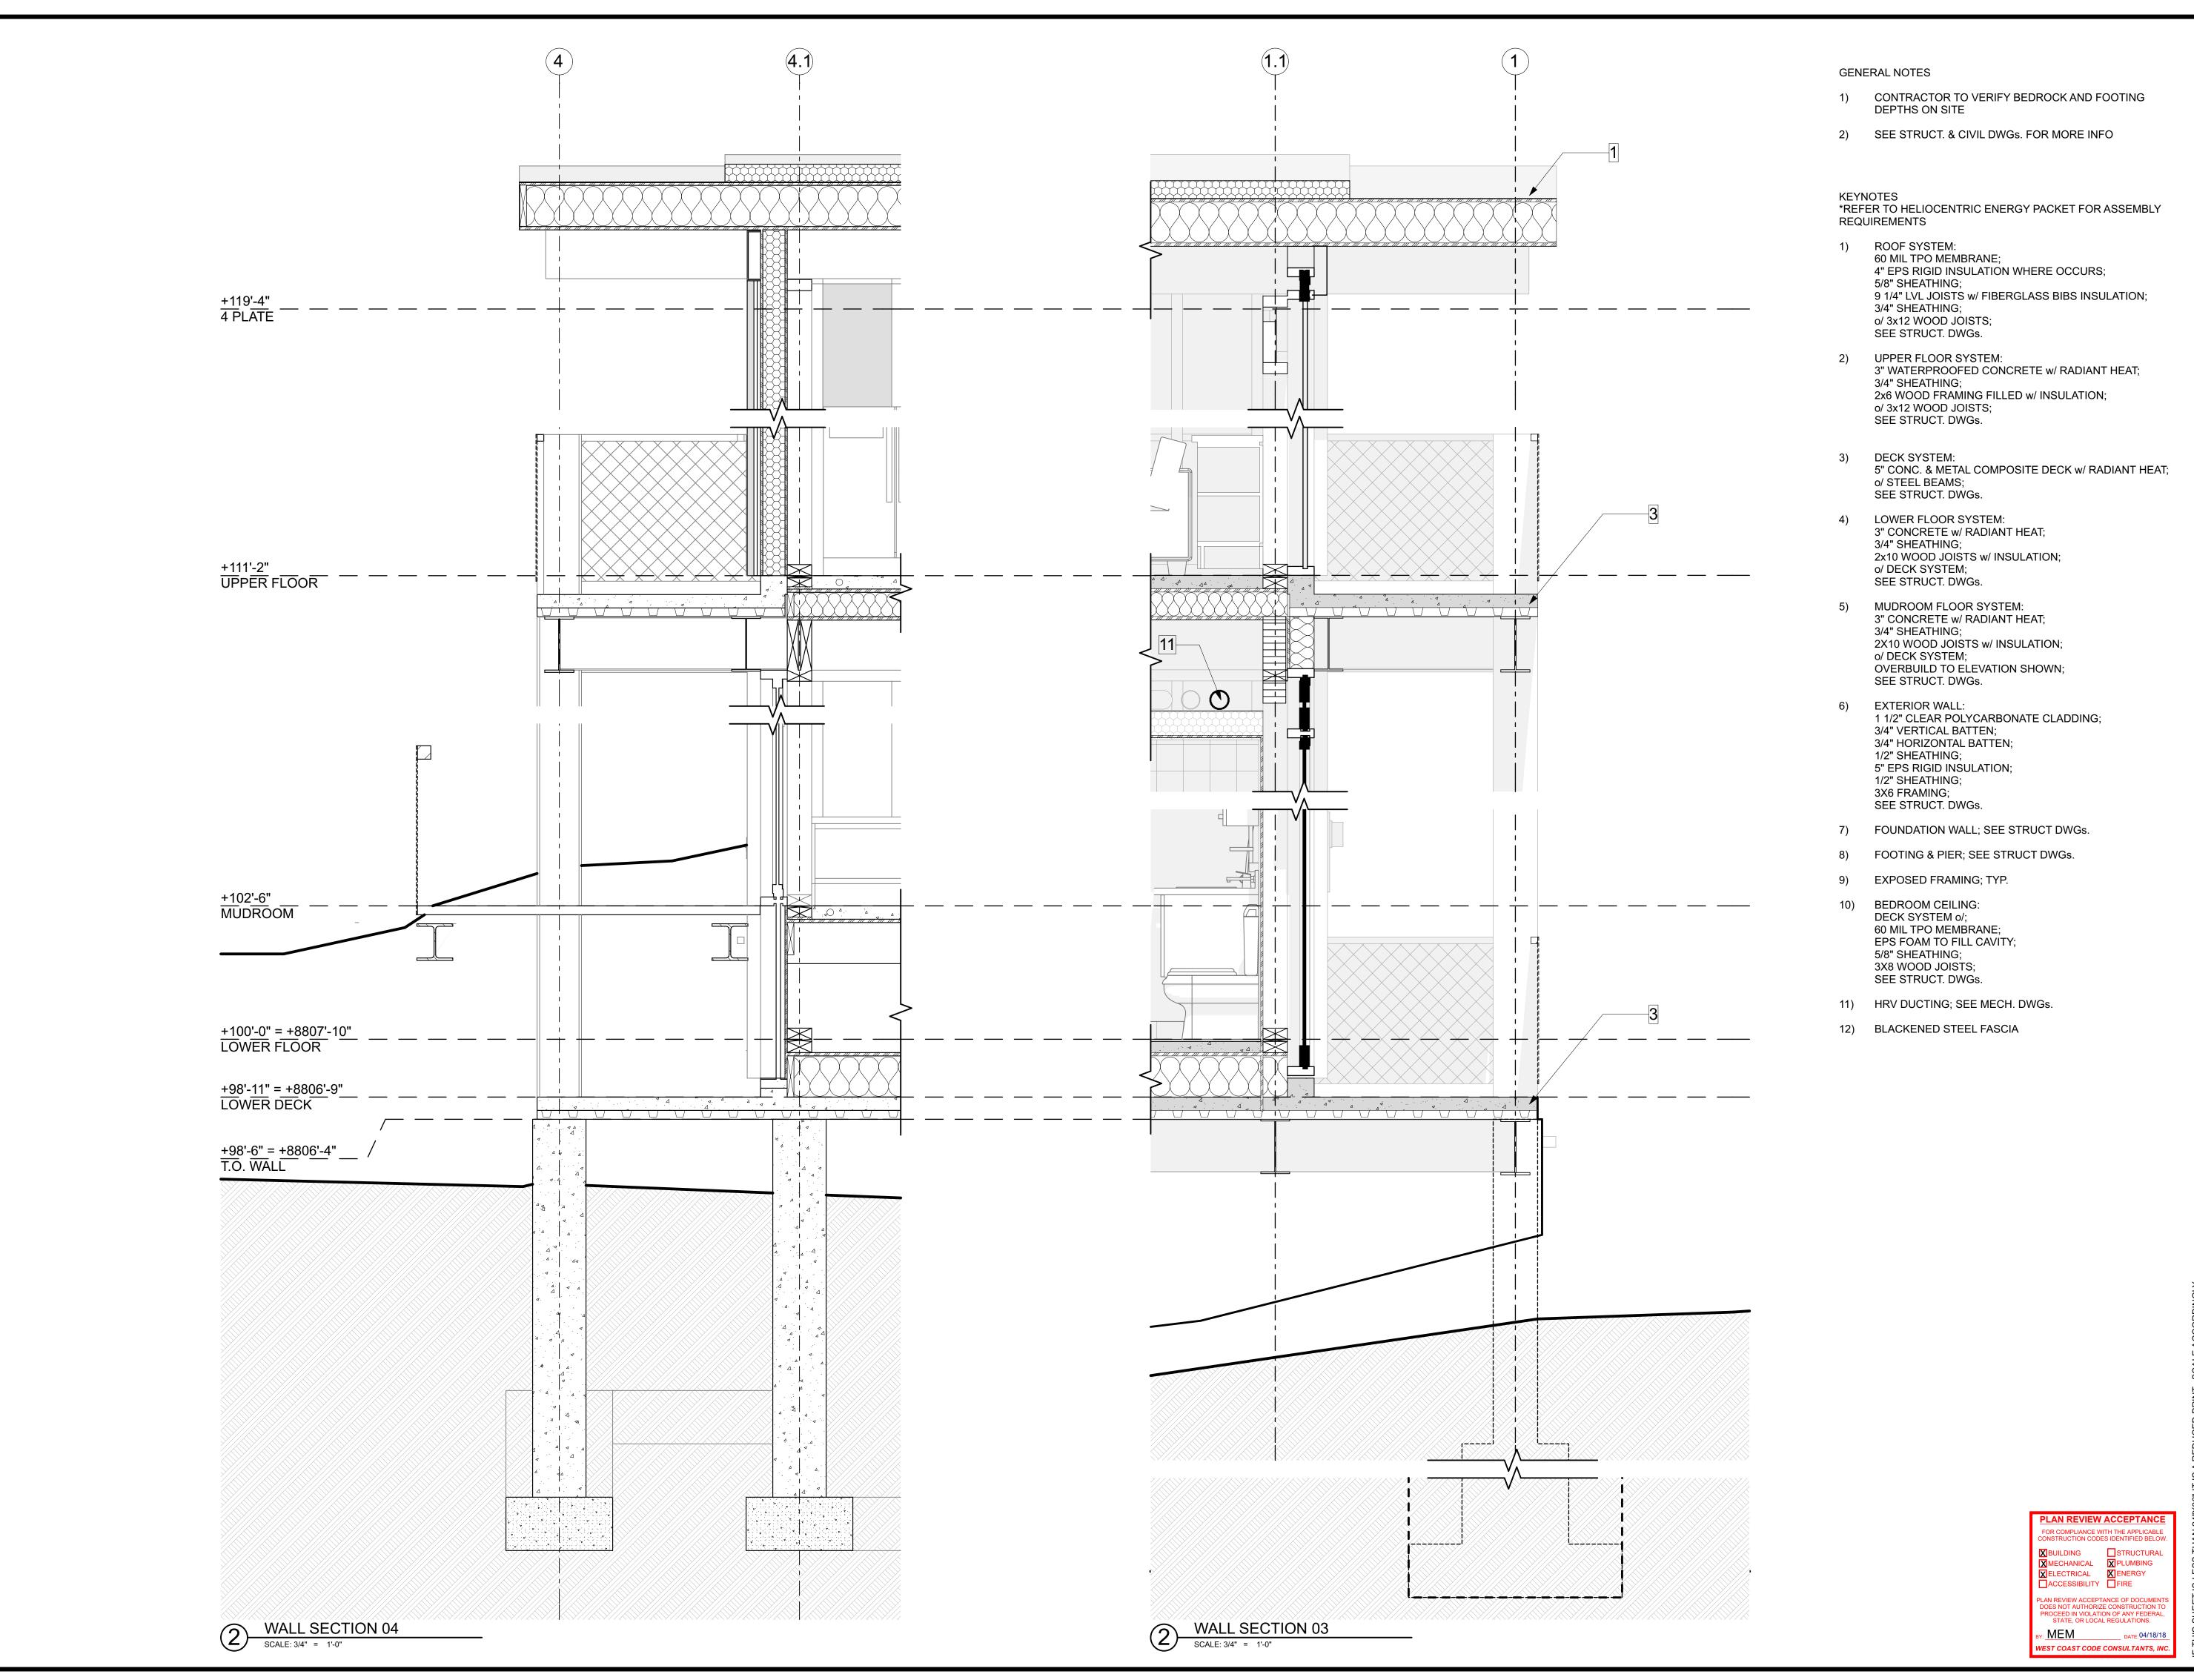
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SHEET TITLE

WALL SECTIONS

SHEET NUMBER



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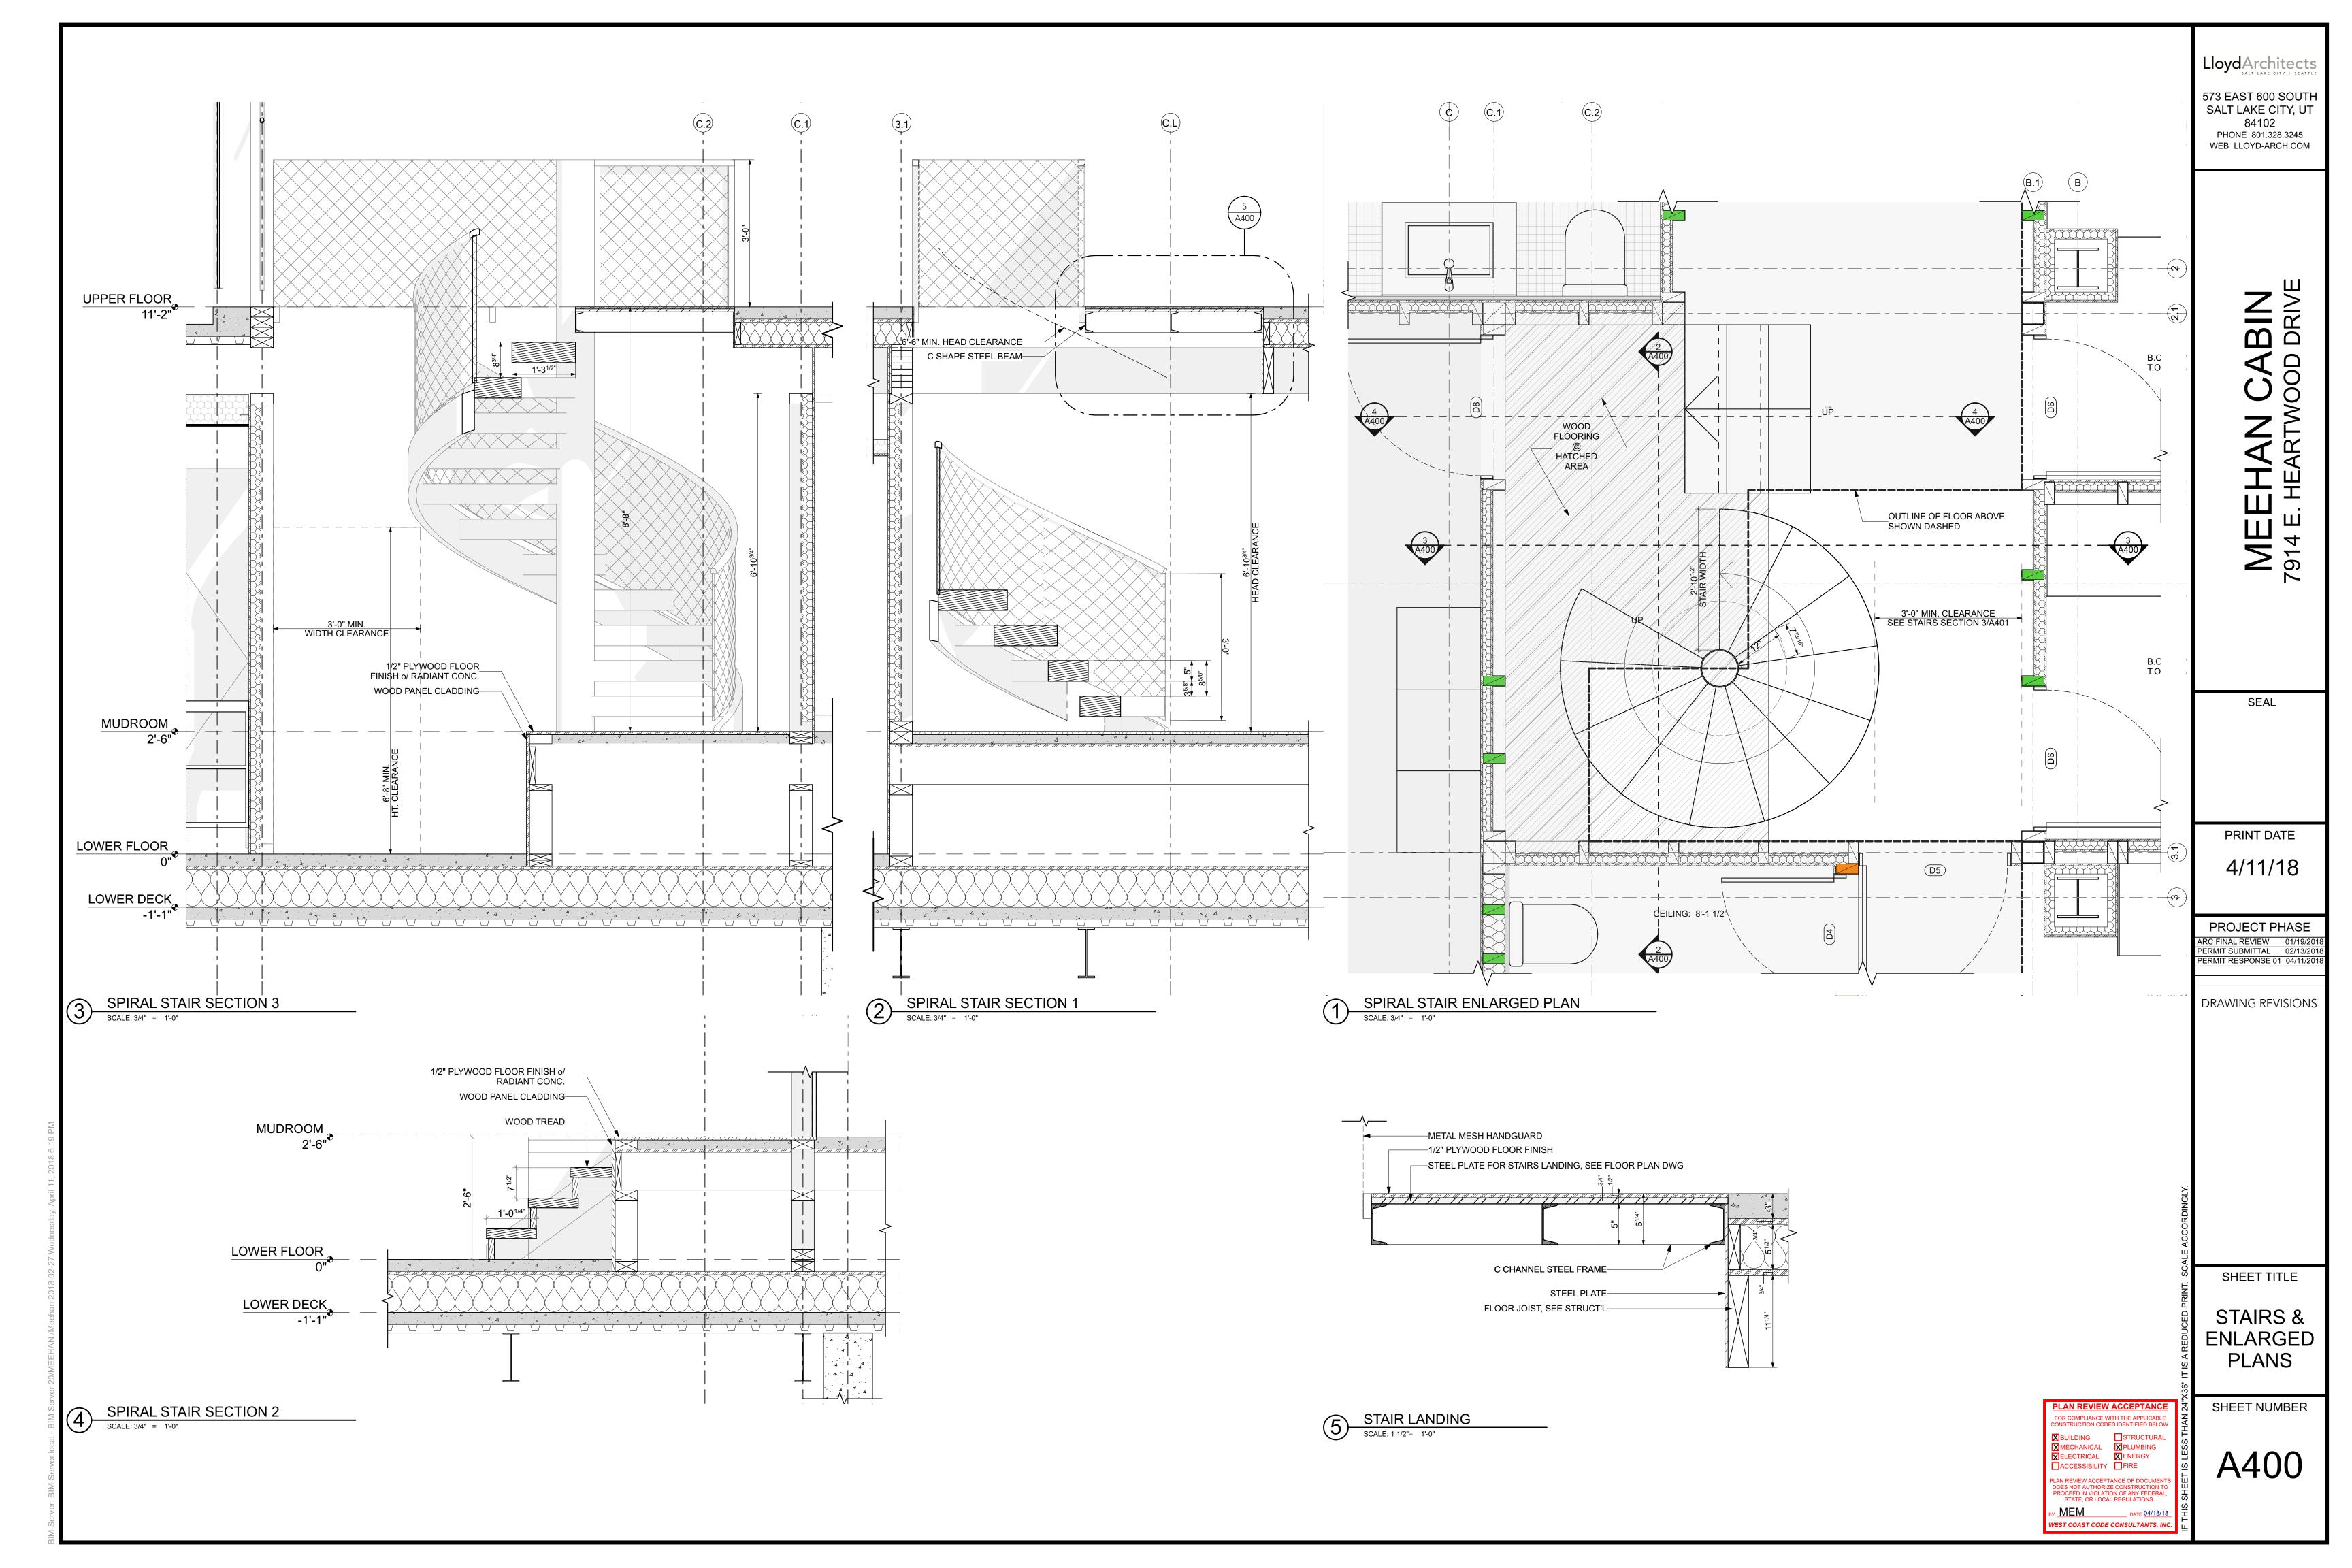
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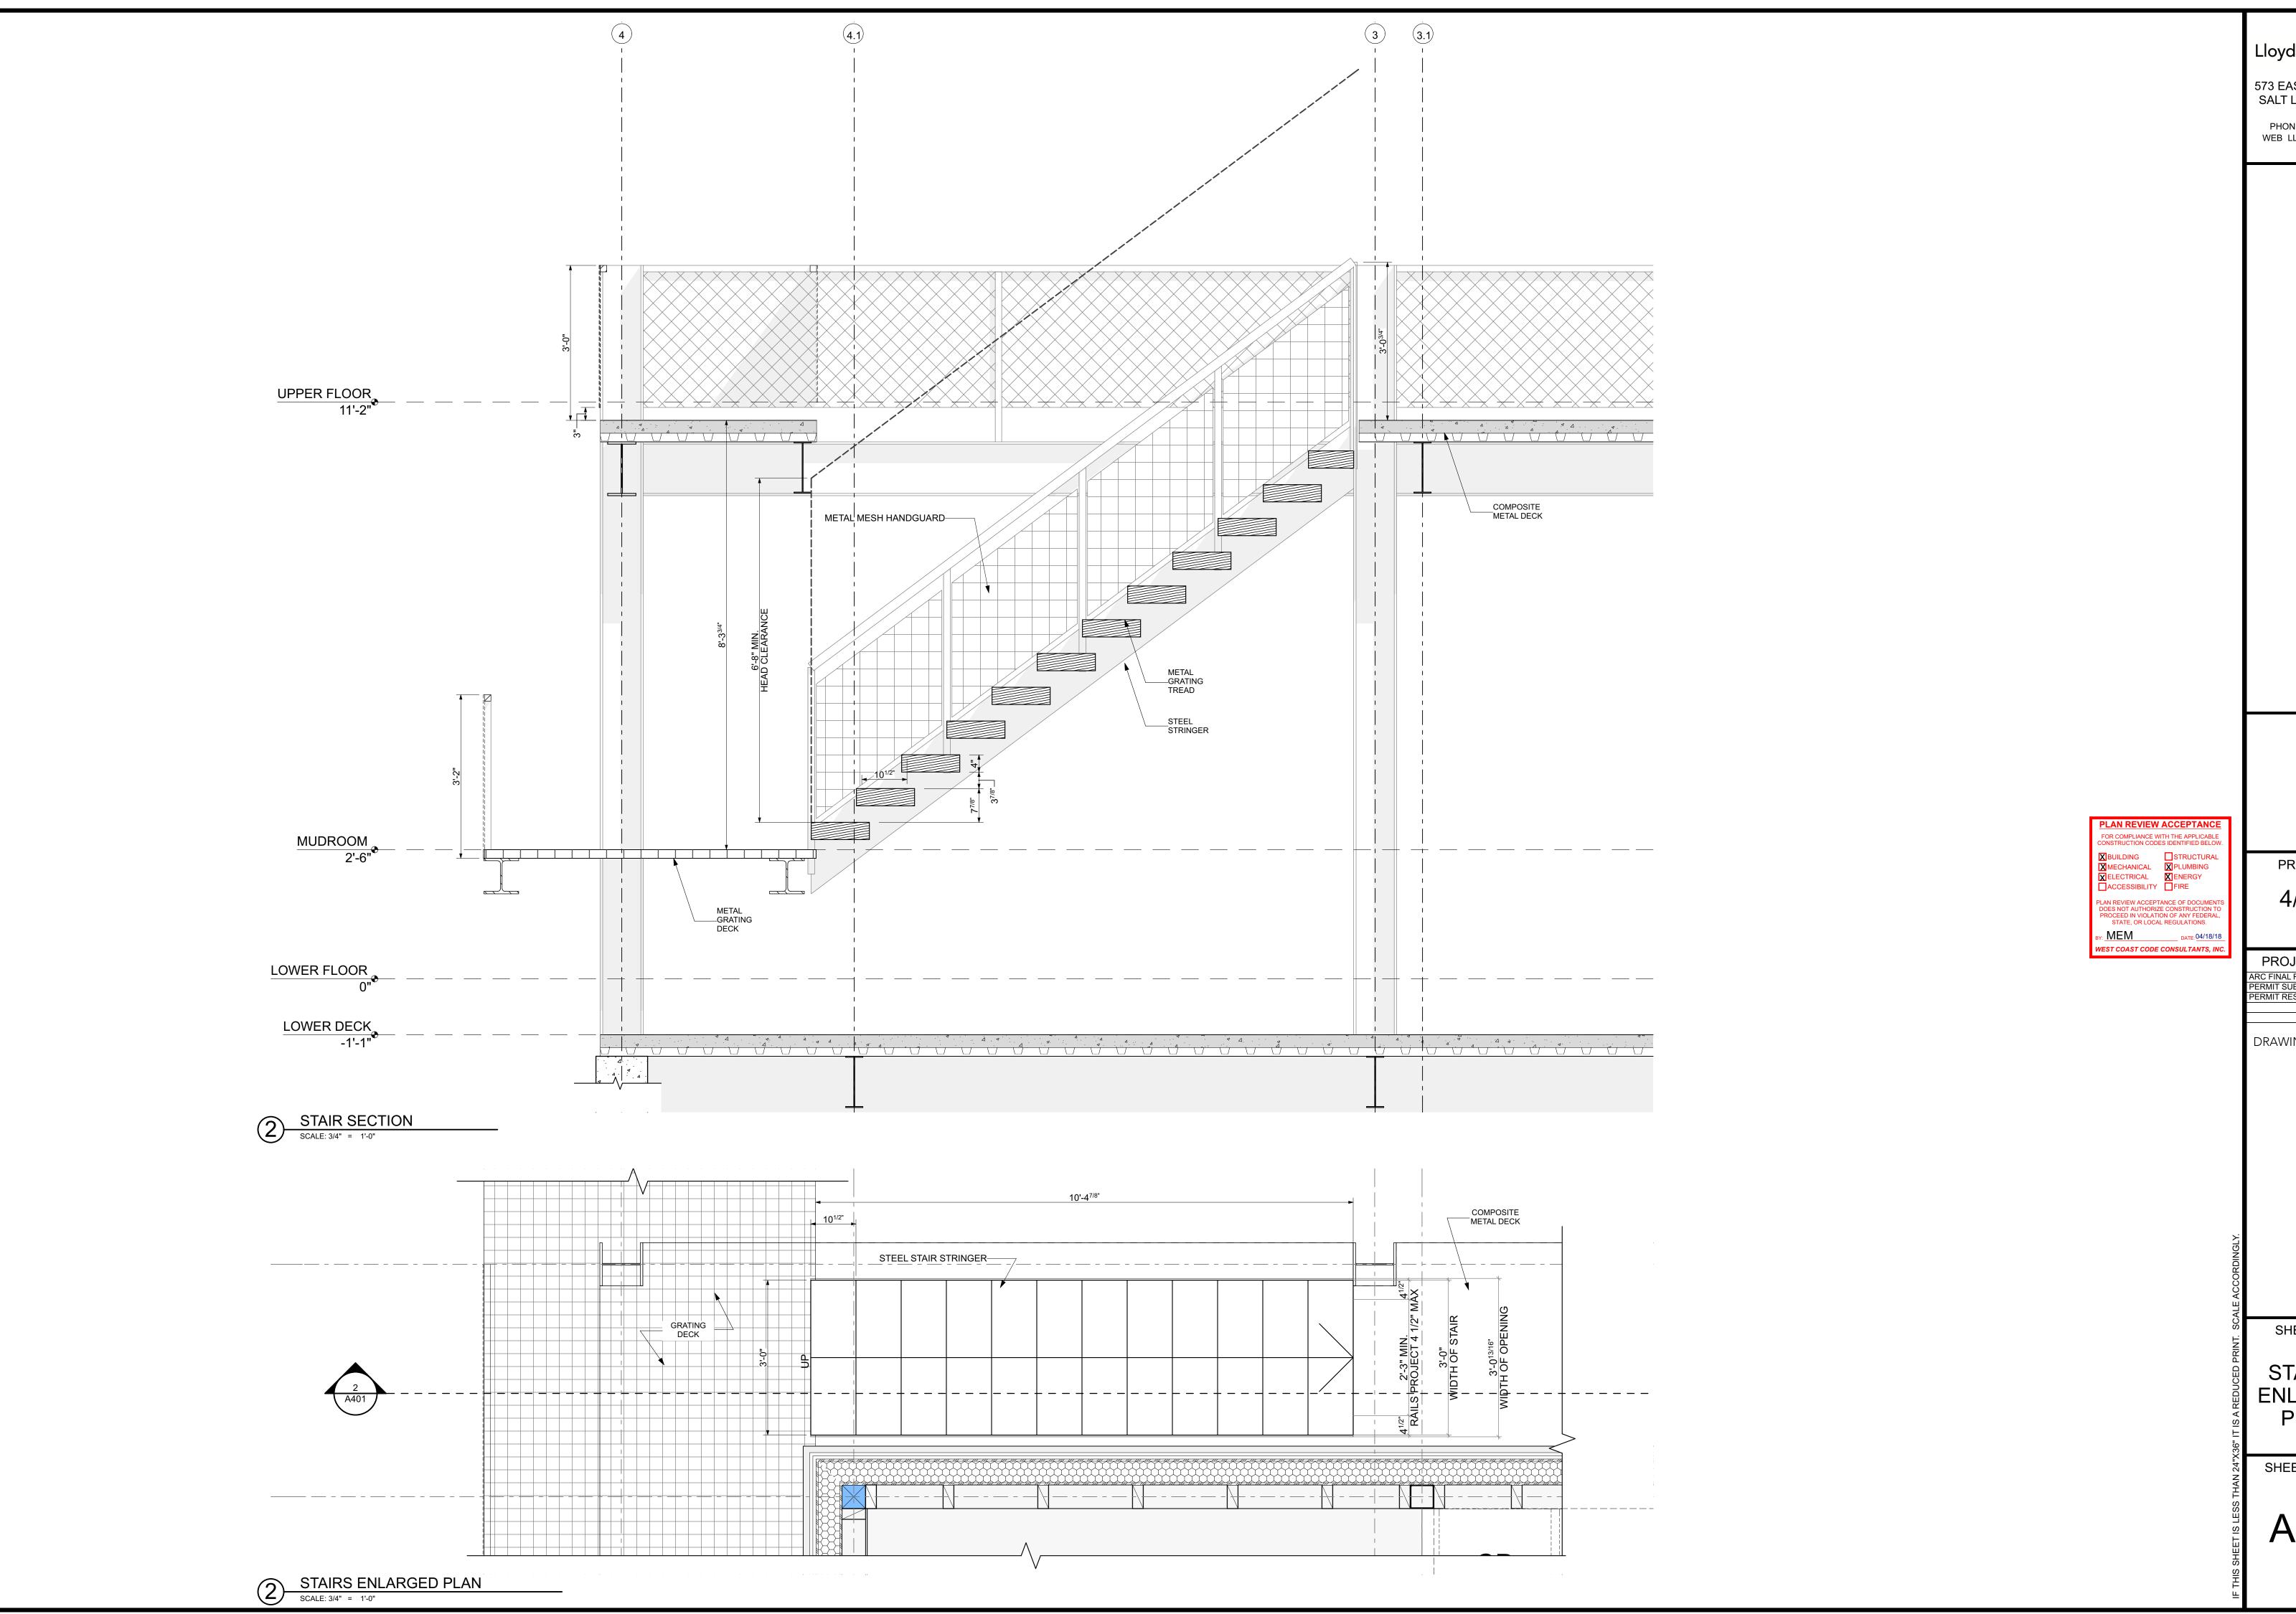
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SHEET TITLE

STAIRS & ENLARGED PLANS

SHEET NUMBER

**W**1 **W2 W**3 **W4** WALL ASSEMBLIES

SCALE: 1" = 1'-0"

—3x6 BOTT. PLATE EXPOSED; SEE WALL SECTION -3x6 STUD EXPOSED; SPACING PER DIMENSION PLAN -WEATHER BARRIER AT PLANE OF WINDOW —1/2" PLYWOOD, EXPOSED —5" THICK EPS RIGID INSULATION —1/2" WALL SHEATHING; SEE STRUCT'L DWG —2 LAYERS 1x FURRING STRIP (GRID) —POLYCARBONATE CLADDING

-3x6 STUD EXPOSED; SPACING PER DIMENSION PLAN —3x6 BOTT. PLATE EXPOSED; SEE WALL SECTION —1/2" PLYWOOD, EXPOSED —2" THICK EPS RIGID INSULATION —1/2" PLYWOOD, EXPOSED

NON-ABSORBENT CERAMIC TILE; TYP. o/ FIBER-CEMENTL FIBER-MAT REINFORCED —CEMENTIOUS BACKER UNITSL GLASS MAT GYSUM BACKERS OR FIBER-REINFORCED GYPSUM BACKERS PER IRC R702.4.2. —SOUND BATT INSULATION —1/2" PLYWOOD, EXPOSED -3x6 STUD EXPOSED; SPACING PER DIMENSION PLAN

> FOR COMPLIANCE WITH THE APPLICABLE —1/2" PLYWOOD, EXPOSED PLAN REVIEW ACCEPTANCE OF DOCUMENT DOES NOT AUTHORIZE CONSTRUCTION TO PROCEED IN VIOLATION OF ANY FEDERAL, STATE, OR LOCAL REGULATIONS. \_2" THICK EPS RIGID INSULATION (FACING STEEL COLUMN) BY: MEM DATE: 04/18/18
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ASSEMBLIES

SHEET NUMBER

**GENERAL NOTES:** 

1) SEE DRAWINGS FOR OPERATING DIRECTION

PLAN REVIEW ACCEPTANCE

FOR COMPLIANCE WITH THE APPLICABLE CONSTRUCTION CODES IDENTIFIED BELOW. XBUILDING STRUCTURAL

XMECHANICAL PLUMBING

XELECTRICAL ENERGY

ACCESSIBILITY FIRE PLAN REVIEW ACCEPTANCE OF DOCUMENT DOES NOT AUTHORIZE CONSTRUCTION TO PROCEED IN VIOLATION OF ANY FEDERAL, STATE, OR LOCAL REGULATIONS. BY: MEM DATE: 04/18/18
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SHEET TITLE

DOOR & WINDOW SCHEDULE


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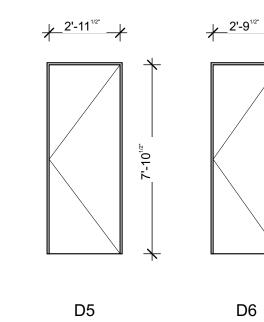
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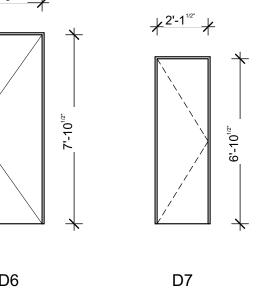
	WINDOW SCHEDULE					
ID	WIDTH	HEIGHT	FRAME TYPE	NOTE/REMARKS	QUANTITY	TEMPERED
W1	3'-7 <sup>1/2</sup> "	3'-21/4"		MUDROOM, BATROOM3, BEDROOM1, BEDROOM2, BEDROOM3, HALL, LIVINGROOM, DINING ROOM	8	Υ
W2	3'-7 <sup>1/2</sup> "	5'-7 <sup>3/4</sup> "		BATHROOM3	1	Υ
W3	3'-7 <sup>1/2</sup> "	1'-1 <sup>1/2</sup> "		BATHROOM1, BATHROOM3	2	
W4	3'-7 <sup>1/2</sup> "	10'-0 <sup>1/2</sup> "		HALL, BEDROOM1, BEDROOM2, BEDROOM3, MASTER BEDROOM, EGRESS	6	Υ
W5	3'-7 <sup>1/2</sup> "	6'-9 <sup>3/4</sup> "		BEDROOM1, BEDROOM2, BEDROOM3, HALL	4	Υ
W6	3'-7 <sup>1/2</sup> "	6'-10"		BATHROOM1	1	Υ
W7	3'-7 <sup>1/2</sup> "	2'-0"		BATHROOM1	1	
W8	3'-7 <sup>1/2</sup> "	5'-0"		LIVINGROOM, DININGROOM	2	Y
W9	3'-7 <sup>1/2</sup> "	8'-2 <sup>3/4</sup> "		LIVINGROOM,DININGROOM	2	Υ
W10	3'-7 <sup>1/2</sup> "	9'-9"		KITCHEN	8	Υ


3'-4<sup>3/8"</sup> 3'-4" D2





D3




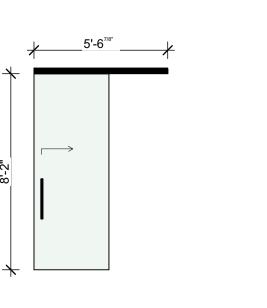

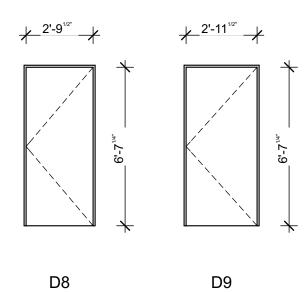

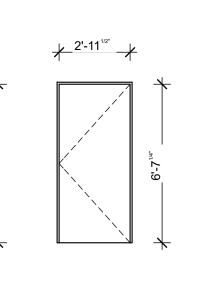

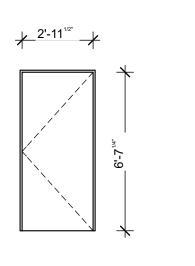

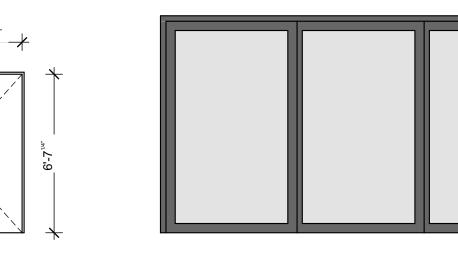

D10


16'-0<sup>5/8\*</sup>

D1 DOOR LEGEND SCALE: 1' = 1'-0"

	DOOR SCHEDULE										
ID	WIDTH	HEIGHT	FRAME TYPE	DOOR TYPE	LOCKSET	NOTE/REMARKS	QUANTITY	TEMPERED			
D1	3'-7 <sup>1/2</sup> "	6'-10"				EXTERIOR, MUDROOM	1	Υ			
D2	3'-7 <sup>1/2</sup> "	10'-0 <sup>3/4</sup> "				EXTERIOR, MASTER BEDROOM	1	Υ			
D3	2'-9 <sup>1/2</sup> "	8'-2 <sup>3/8</sup> "				INTERIOR, MASTER BATH BARN DOOR	1	Y			
D4	2'-3 <sup>1/2</sup> "	6'-10 <sup>1/2</sup> "				INTERIOR, BATHROOM3	1				
D5	2'-11 <sup>1/2</sup> "	7'-10 <sup>1/2</sup> "				INTERIOR, MASTER BEDROOM	1				
D6	2'-9 <sup>1/2</sup> "	7'-10 <sup>1/2</sup> "				INTERIOR, BEDROOM1, BEDROOM2, BEDROOM3	3				
D7	2'-1 <sup>1/2</sup> "	6'-10 <sup>1/2</sup> "				INTERIOR, BATHROOM1, BATHROOM2	2				
D8	2'-9 <sup>1/2</sup> "	6'-7 <sup>1/4</sup> "				INTERIOR, MUDROOM	1				
D9	2'-11 <sup>1/2</sup> "	6'-7 <sup>1/4</sup> "				INTERIOR, MECH. ROOM	1				
D10	16'-5 <sup>1/8</sup> "	9'-0"				EXTERIOR, UPPER FLOOR	2	Y			
D11	3'-7 <sup>1/2</sup> "	9'-9"				EXTERIOR, UPPER FLOOR	1	Y			

2'-31/2"

D4

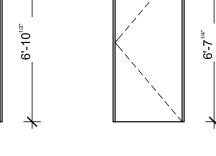

D8

D9

D11

3'-4<sup>3/8"</sup>

**573 EAST 600 SOUTH** 



HRV supply and exhaust ducts

hanging from the ceiling. exposed

to be confirmed by energy engineering 11

Gauge spiral pipe

HOME DEPOT

size/color | 4" dia. / galvanised steel



HRV grill

GCAM

BOFER

everywhere

light bulb

LTA19S80027MB

kitchen,bathrooms,bedrooms

2.4 dia. xH4.1" /2700 K silver

ARCHIPELAGO

for base lights

concent cover


everywhere

RACO

W2 5/16"xH4 3/16"xD1/4" /galvanised W2 5/16"xH4 3/16"xD1/4" / steel

4" dia. /aluminium

ceiling, wall mounted or exposed

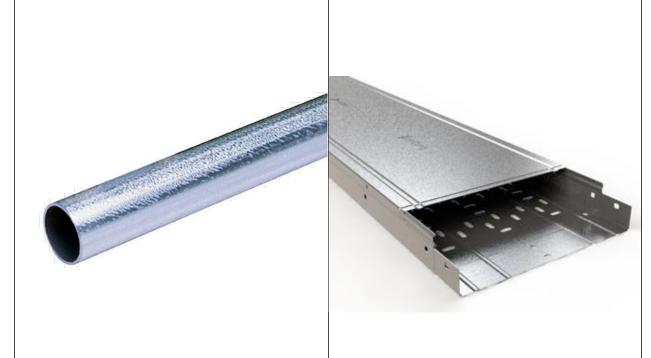

cable tray

ERE SS304 with cover

W4"xH1,5" / galvanised steel

52.5' to be confirmed by electrician

BASOR ELECTRIC

exposed with cover

light handy box

kitchen,bathrooms,bedrooms

for wall base lights and Tolomeo

W4"xH4"xD2 1/8" / galvanised steel

RACO



outdoor spotlight

PERFORMANCE IN LIGHTING

5.9" dia. x H3.3" / gray



exposed spotlight

H750ICAT

H7" DIA6"

toggle switch

LEVITON

everywhere

bathroom faucet

#B21020001010

D5,5"xH6,5" / chrome

bathrooms 1, 2, masterbedroom

DURAVIT

\_

15 Amp Duplex Outlet, White

W1.33"xH4.2"xD0.94" / white



Waterproof spotlight

7.48"x 7.48" / white

EV608941WH40

ENVIROLITE

light dimmer

TSL06-1LW

bathroom sink

DURAVIT

# 0347600000

bathrooms 1, 2, masterbedroom

W23,6"xD5,5"xH6,5" / white

bedrooms, living room

W1.33"xH4.2"xD0.94" / white

LEVITON



spot light

ARTEMIDE

with dimmer

concent

LEVITON

29

everywhere


15 Amp Duplex Outlet, White

W1.33"xH4.2"xD0.94" / white

bathrooms 1& 2, wetroom, master toilet pods 1, 2, 3, master bed, living room

TOLOMEO wall spot

5 7/8" dia. / aluminium

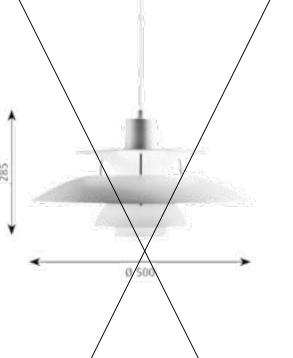

$\vdash$		
$\perp$		



name

number

brand

location

size/color quantity

notes

image

name

number

brand

location

notes

quantity 10

image

reference





pipe for electrical cables

length determined by constructor

Home depot

everywhere

light socket

LEVITON

R50-49875-000

for base lights

handy box

Memo:

kitchen,bathrooms,bedrooms

W4.5"xH4.5"xD2.12" /porcelain white

/ zinc coating



technical room, hallway, master bedroom outdoor



kitchen base light handy box

W4"xH4"xD2 1/8" / galvanised steel

exposed on exposed 3x6" studs

167TS

RACO

kitchen



technical room, mudroom, hallway

left exposed between studs





W2"xH4"xD1 7/8" / galvanised steel

for concents and switches, left exposed

19.7" dia.x H11.22" / mat white

to be confirmed by client

dining table light

LOUIS POULSEN

dining room

handy box

everywhere

611

RACO

PRINT DATE
4/11/18

PROJECT PH	HASE
ARC FINAL REVIEW	01/19/2018
PERMIT SUBMITTAL	02/13/2018
PERMIT RESPONSE 01	04/11/2018

SEAL

DRAWING REVISIONS

6	1	15
	(3)	
- Charles	0	

laundry sink LED tubes

1" dia.x3' / 6500 K

refer to furniture details

469460

PHILIPS

laundry

switch cover

everywhere

RACO





kitchen, mudroom, bathrooms, hallway

W4"xH4"xD2 1/8" / galvanised steel

for 2 switches or 1 switch + 2 concents



1 switch and 2 concents cover

mudroom,bathrooms,master,living room

W4"xH4"xD1/4" / galvanised steel

872











toilet paper holder
816663001
ROCA
bathrooms 1, 2, master toilets
W7.13xD2.56"xH1.97" / chrome
3
-

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EST COAST CODE CONSULTANTS, INC

Project: Check:

mudroom,hallway,masterbedroom

W4"xH4"xD1/4" / galvanised steel

2-toggle switch cover

Powder Mountain\_interior details

Title:

3

-

LIST\_equipements 1

SHEET NUMBER

A800

SHEET TITLE

SELECTIONS

Scale:

toilets

DURAVIT

# 212101..01

bathrooms 1, 2, master toilets

W13,9"xD27,9"xH29,3" / chrome

Date: 17.11.30

No: A-30

LloydArchitects
SALT LAKE CITY + SEATTLE

SHEET NUMBER

A801















name	shower drain	shower faucet	shower and bathtub faucet	wall outlet	hand shower set	swivel spout for bathtub	bathtub	towel warmer	mirror cabinet
reference		# B24210010010	#B25210012010	# UV0630006	100/3 stella	SU-363-MA	Napoli NAP-N-xx-SW-NO	Jeeves F Straight	Lillagen cabinet with 2 doors
brand	WONDERCAP	DURAVIT	DURAVIT	DURAVIT	ROCA	CENTRAL BRASS	VANDA BATHS	AMBA products	IKEA
location	wet room, bathroom 1 & 2	bathrooms 1 and 2	wet room	bathrooms 1, 2, wet room	bathrooms 1, 2, wet room	wet room	wet room	bathrooms 1, 2, master bedroom	bathrooms 1, 2
		6,7" dia.xD2,24" / chrome	6,7" dia.xD2,24" / chrome	- / chrome	4,17" dia. / chrome	W5,18"xH3,5"xD16,125" dia. / chrome	E   L74 3/4"xW33 5/8"xH19 3/4" / Engli	sh W20.5"xH40 15/16"xD4 1/2"/brush	ch W23 5/8"xD8 1/4"xH25 1/4"/ white
quantity notes	3	2	hand shower and spout logos	hand height	incl. Neo-flexPVC hose+swivel bracket	I	no overflow hole	3	2
image									
name	swivel miror	washer	dryer	laundry sink	laundry swivel faucet	boots dryer	kitchen sink	kitchen faucet	kitchen soap dispenser
number	21-63870-22959	EFLW317TIW	EFDE317TIW	DL-1	B-0231	thermo dry 10 pairs	VG3219C	VG02008	VGSD001
brand	WATERWORKS	ELECTROLUX	ELECTROLUX	HOME DEPOT	T&S BRASS	MONTANA	VIGO	VIGO	VIGO
location	master sink	mudroom	mudroom	mudroom	mudroom	mudroom	kitchen	kitchen	kitchen
size/color		W27"xD32"xH38"/white	W27"xD31-5/8"xH38"/ white	W24.5"xD22"xH15"/ white	W12 5/8"xD14 3/8"xH7 1/2"/ chrome	W22""xD13.4"xH74.86"/ RAL 7037	W30"xD17"xH9 7/8"/ stainless steel	1 3/8" dia.xH17"/ stainless steel	2 1/4" dia.xD3 1/2"xH11"/ stainless
quantity notes		I	I	I	I	paint the original blue grid with RAL 703		extensible	I

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# KOST107ESS

KITCHEN AID

exposed feets

number

location

quantity

dishwasher

KITCHEN AID

kitchen

# KDFE104DSS

W27"xD23 1/4"xH28 3/4"/ stainless st | W23.88"xD24.75"xH33.5"/ stainless st | W36"xD23.675"xH37"/ stainless steel

kitchen hood

island mounted

KECOMi-36

ZLINE

kitchen

Memo:

cooktop

COSMO

kitchen

# 950SLTX-E

Project:

SY: MEM

WEST COAST CODE CONSULTANTS, INC

refrigerator

# KRFF302ESS

W30.31"xD20"xH3.36"/ stainless steel | W32 7/8"xD32"xH70 1/8"/ stainless st | W30.7"xH25.4"/ aluminium

KITCHEN AID

Powder Mountain\_interior details

with dimmer and inset pivot base

pull out trash

SCB15-2-20PT

KNAPE & VOGT

kitchen counter

add 1 cover not door mounted

kitchen island light

A004800

ARTEMIDE

kitchen island

Title:

LIST\_equipements 2

Scale:

No: A-31

FIRE DRUM 3

BY OWNER

Check:

storage gliders

ELFA

16

SKU#: 10067241

kitchen island, mudroom

W14-3/8"xD20-1/8"xH17-5/16"/ platin W16 7/8"xD20 3/4"xH8 1/2"/ platinium <del>W30""xH31"/ black</del>

Date: 17.11.30

fireplace

MALM

zircon 30"

living room

wood burn