

COVER SHEET

2 GENERAL NOTES & SPECIFICATIONS



CLIENT: JIM & ALLY DEPIANO CONTRACTOR: SOLITUDE BUILDERS WARNING: electronic files including those in PDF format are to be used for bidding purposes only. Any COPY DRAWINGS OF THE MOST CURRENT REVISION ONLY.

CONSTRUCTION WORK THAT IS TO BE DONE ON THE HOME INCLUDING SITE WORK SHALL BE BASED ON APPROVED, STAMPED HARD

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ORIGINAL DESIGN AND ALL DOCUMENTATION.

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HABITATIONS

RESIDENTIAL DESIGN GROUP

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REAR / LEFT SIDE ELEVATIONS
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PROJECT INFORMATION

SQUARE FOOTAG	E CALCULATIONS	CLIENT:	JIM & ALLY DEPIANO	
UPPER FLOOR	1489 SQ. FT.	TYPE:	RESIDENTIAL PLAN	
MAIN FLOOR	1448 SQ. FT.	ISSUE DATE:	XX/XX/2016	
LOWER FLOOR	1163 SQ. FT.	REV. DATE:		
BASEMENT	365 SQ. FT.		LOCATION:	
	J J J J J J J J J J J J J J J J J J J		ASPEN DRIVE	
GARAGE	463 SQ. FT.		L <i>o</i> ⊤ #42-R	
		POWDER 1	MOUNTAIN WEST PHASE 2	
		EDEN CIT	Y, WEBER COUNTY, UTAH	
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2016 HADIIAIIUNU PLAN NUMBER: SHEET NUMBER

GENERAL MATERIALS SPECIFICATIONS:

"THE FOLLOWING GENERAL MATERIALS SPECIFICATIONS ARE PRESENTED FOR INFORMATION ONLY". THE GENERAL CONTRACTOR/OWNER/STRUCTURAL ENGINEER/PROFESSIONAL TRADE CONTRACTORS/GOVERNING JURISDICTIONS SHALL BE RESPONSIBLE FOR THE SELECTIONS AND APPLICATION OF ACTUAL MATERIALS UTILIZED. HABITATIONS MAKES NO GUARANTEE AS TO THE ACCURACY OR COMPLETENESS OF OR CODE COMPLIANCE OF THESE GENERAL MATERIALS.)

A. CONTRACTOR TO VERIFY SOIL CONDITION AND PROVIDE STABILIZATION AS REQUIRED (SEE SITE PLAN).

A. FOOTINGS AND FOUNDATIONS SHALL BE ON UNDISTURBED SOIL. IF ANY UNSTABLE OR COLLAPSIBLE OR OTHERWISE POOR SOIL CONDITIONS ARE DISCOVERED, A SOILS ENGINEER SHOULD BE NOTIFIED FOR SOILS STABILITY. SOILS BEARING CAPACITY SHALL BE 1,500 PSF.

- B. FOOTINGS: 3000 PSI MINIMUM COMPRESSIVE STRENGTH AFTER 28 DAYS. #4 REINFORCING BARS PER ASTM GR. 60, UNLESS OTHERWISE SPECIFIED BY ENGINEER. SEE ELEVATIONS FOR FOOTING DEPTH AS REQ'D BY LOCAL CONDITIONS/AUTHORITIES.
- C.FOUNDATIONS: 3000 PSI MINIMUM COMPRESSIVE STRENGTH AFTER 28 DAYS. #4 & 5 REINFORCING BARS PER ASTM 615 GR, 60, UNLESS OTHERWISE SPECIFIED BY ENGINEER. D. WATERPROOFING: TWO (2) COATS ASPHALT (TAR) EMULSION (BELOW GRADE).
- E. CONCRETE SLAB: 2500 PSI MINIMUM COMPRESSIVE STRENGTH AFTER 28 DAYS, 4" MIN. (INTERIOR), 5" MIN. (EXTERIOR) THICK OVER 4" COMPACTED GRAVEL. F. WATER DRAINAGE: PERFORATED ABS PIPE FULL PERIMETER OF FOUNDATION AND EXTENDING TO TERMINATION 20' FROM FOUNDATION AT ALL FOUNDATION CORNERS WITH

EXTERIOR WALLS:

A. STUDS: 2X6 #2 OR BTR HEMLOCK OR DOUGLAS FIR; 16" O.C. (UNLESS OTHERWISE NOTED). B. SHEATHING: 7/16" OSB WAFERBOARD SHEATHING UNLESS OTHERWISE SPECIFIED BY STRUCTURAL ENGINEERING LATERAL ANALYSIS. FASTEN SHEAR PANEL 25' O.C. AND CORNERS WITH 8D NAILS 6" O.C. AT EDGE, 12" O.C. IN FIELD. SOLID BLOCK ABOVE SHEAR PANELS MINIMUM AND NAIL WITH 4-10D NAILS PER BLOCK. METAL HURRICANE TIES EVERY RAFTER OR TRUSS END

- C. VAPOR BARRIER: WRAP EXTERIOR WALLS WITH TYPAR HOUSEWRAP UNLESS OTHERWISE SPECIFIED. D. MASONRY: (IF USED) NATURAL THIN CUT STONE BY NATURAL STONE CONNECTION ((801) 475-4216)) INSTALL AS PER MFG. SPECS (STYLE SHALL BE CONFIRMED WITH THE
- OWNER PRIOR TO INSTALLATION). E. STUCCO: (IF USED) SYNTHETIC TYPE OVER STYRENE BOARD WITH BROWN COAT CONCRETE MIX. DRIVIT TYPE OR EQUAL. INSTALL AS PER MFG. SPECS (THE COLOR AND
- STYLE SHALL BE CONFIRMED WITH THE OWNER PRIOR TO INSTALLATION). F. EXTERIOR WALL FINISHES MUST BE LISTED, LABELED AND INSTALLED AS PER MANUFACTURER'S INSTALLATION GUIDE. ALL INSTALLERS MUST BE APPROVED BY MANUFACTURER.

A. JOIST: TJI FLOOR JOISTS AS SHOWN ON PLANS BY TRUSS JOIST CORP. OR EQUAL (EXCEPT AS_OTHERWISE NOTED). MANUFACTURERS INSTRUCTIONS/SPECIFICATIONS SHALL BE FOLLOWED FOR INSTALLATION.

- B. RIM JOISTS: 1-1/4"XI1-7/8" TIMBERSTRAND AROUND ENTIRE PERIMETER OF STRUCTURE UNLESS OTHERWISE SPECIFIED.
- . BLOCKING: TJI TRUSS JOIST REQUIRED AT ALL LOAD BEARING WALLS ABOVE AND AT ALL CANTILEVERS
- E. SUB FLOOR: 3/4" T&G EXTERIOR WAFER BOARD OR (CDX) PLYWOOD, GLUED AND NAILED W/ 8D NAILS @ 6" OC EDGES, 12" OC ALONG INTERMEDIATE FRAMING MEMBERS.

- A. STUDS: 2X4 (2X6 WHERE NOTED) #2 OR BTR HEMLOCK OR DOUGLAS FIR, 16" O.C. B. FINISH: WALLBOARD (WALLS & CEILINGS): 1/2" GYPSUM BOARD (WATERPROOF AT ALL SPLASH AREAS), 5/8" ONE HOUR FIRE RATED WALL & CEILING IN GARAGE AND
- SHALL BE USED.

- ROOF/CEILING FRAMING: . TRUSSES: #2 OR BTR HEMLOCK OR DOUGLAS FIR. REFER TO MANUFACTURER'S SPECS FOR TRUSS ENGINEERING. SIMPSON METAL HURRICANE TIES SHALL BE INSTALLED AT
- B. RAFTERS: TJI ENGINEERED RAFTERS BY TRUSS JOIST CORP. OR EQ. OR 2X #2 OR BETTER HEMLOCK OR DOUGLAS FIR DIMENSIONAL LUMBER SHALL BE UTILIZED UNLESS
- . SHEATHING: 5/8" OR 11/16" 40/20 APA RATED SHEATHING OR EQUAL (GRAIN SHALL BE PERPENDICULAR TO SUPPORTS, EDGES SHALL BE FASTENED W/ 8D NAILS 6" O.C. @

- EXTERIOR. FLASHING SHALL BE INSTALLED AT THE PERIMETERS OF EXTERIOR DOOR AND WINDOW ASSEMBLIES, PENETRATIONS AND TERMINATION'S OF EXTERIOR WALL ASSEMBLIES, EXTERIOR WALL INTERSECTIONS WITH ROOFS, CHIMNEYS, PORCHES, DECKS, BALCONIES AND SIMILAR PROJECTIONS AND AT BUILT-IN GUTTERS AND SIMILAR LOCATIONS WHERE MOISTURE COULD ENTER THE WALL. FLASHING WITH PROJECTED FLANGES SHALL BE INSTALLED ON BOTH SIDES AND THE ENDS OF COPINGS, UNDER SILLS AND CONTINUOUSLY ABOVE PROJECTED TRIM. A FLASHING SHALL BE INSTALLED AT THE INTERSECTION OF THE FOUNDATION TO STUCCO, MASONRY, SIDING OR
- BRICK VENEER. THE FLASHING SHALL BE AN APPROVED CORROSION- RESISTANT FLASHING VENTILATION: RIDGE OR HIP ROOF VENTS AS SHOWN ON THE ELEVATIONS MEETING I.R.C. R806 AND SHALL BE A NET FREE VENTILATION AREA SHALL NOT BE LESS THAN 1/150TH OF THE AREA OF THE SPACE VENTILATED , EXCEPT THE AREA MAY BE 1/300TH PROVIDED THAT NO LESS THAN 40% AND NO MORE THAN 50% OF THE REQ'D. VENTILATING AREA IS LOCATED IN THE UPPER PORTION (36" MIN. ABOVE CORNICE VENTS OR EAVE) OF THE SPACE TO BE VENTILATED WHILE THE BALANCE OF
- D. SHINGLES: SEE ELEVATIONS FOR ROOFING STYLE. FOLLOW ALL MANUFACTURER SPECIFICATIONS FOR INSTALLATION. E. MISCELLANEOUS: 22"X30" ATTIC ACCESS SHALL BE PROVIDED FOR ALL SEPARATE ATTIC AREAS EXCEEDING 30 SQ. FT.. ACCESS LOCATED IN A HALLWAY OR OTHER

- MISC.: FOAM INSULATE UNDER ALL CONCRETE SILL PLATES, AROUND ALL OUTLET BOXES AND WINDOW AND DOOR FRAMES.
- . PROVIDE INSULATION DEPTH MARKERS EVERY 300 SQ. FT. OF ATTIC AREAS.
- G. CERTIFICATE: A PERMANENT CERTIFICATE SHALL BE POSTED ON OR IN THE ELECTRICAL DISTRIBUTION PANEL. THE CERTIFICATE SHALL BE COMPLETED BY THE BUILDER OR REGISTERED DESIGN PROFESSIONAL. THE CERTIFICATE SHALL LIST THE PREDOMINANT R-VALUES OF INSULATION INSTALLED IN OR ON CEILING/ROOF, WALLS, FOUNDATION (SLAB, BASEMENT WALL, CRAWLSPACE WALL AND /OR FLOOR) AND DUCTS OUTSIDE CONDITIONED SPACES. THE CERTIFICATE SHALL ALSO LIST THE TYPE AND EFFICIENCY OF

EXTERIOR TRIM:

- . DRIP EDGE: ALUMINUM OR AS SELECTED BY OWNER.
- 10. INTERIOR DETAILS: A. TRIM: DOOR/WINDOW CASINGS, BASEBOARDS, CHAIR RAIL AND CROWN MOLDING PAINT GRADE EXCEPT GREAT ROOM/KITCHEN/NOOK SHALL BE STAIN GRADE KNOTTY ALDER OR AS SELECTED BY OWNER.

- PANEL: MINIMUM 200 AMP SERVICE AND SHALL COMPLY WITH N.E.C. AND LOCAL CODES.
- MISCELLANEOUS: OUTDOOR FLOOD LIGHTING SHALL BE AS SELECTED BY CONTRACTOR/OWNER.
- INSTALL 110 VOLT GFI ELECTRICAL OUTLET WITHIN 25 FEET OF A/C UNIT. PROVIDE COMBINATION ARC FAULTS PROTECTION ON ALL BEDROOM LIGHTS, SWITCHES, SMOKE DETECTORS AND RECEPTACLES.
- G. PROVIDE A CONCRETE ENCASED ELECTRODE (UFER GROUND) AND WATER PIPE ELECTRODE FOR GROUNDING SYSTEM FOR ELECTRICAL SERVICE. UFER CONNECTIONS MUST BE

- A. HEATING: MINIMUM 90% ENERGY EFFICIENT GAS FIRED FORCED AIR HEATERS, QUANTITY PER HVAC CALCULATIONS WHICH ARE THE RESPONSIBILITY OF THE HVAC CONTRACTOR. DESIGN AND SELECTION SHALL BE BY HEATING/PLUMBING CONTRACTOR AND CONFIRMED BY OWNER. ALL MANUFACTURERS INSTALLATION INSTRUCTIONS AS WELL AS ALL APPLICABLE LOCAL AND FEDERAL CODES SHALL BE FOLLOWED BY THE CONTRACTOR.
- B. AIR CONDITIONING: CENTRAL AIR AIR CONDITIONING UNITS SHALL BE SUPPLIED AND LOCATED ON A CONCRETE PAD LOCATED AWAY FROM DECKS & BEDROOM WINDOWS. . DUCTING AND REGISTERS: DESIGN, LOCATION AND TYPE SHALL BE BY PLUMBING/HEATING CONTRACTOR AND SHALL BE CONFIRMED BY CONTRACTOR/OWNER AND SHALL MEET ALL APPLICABLE CODES.
- E. ALL BUILDINGS ARE CONSIDERED TO BE UNUSUALLY TIGHT CONSTRUCTION AND ALL COMBUSTION AIR TO ROOMS SPACES CONTAINING FUEL BURNING APPLIANCES SHALL BE OBTAINED FROM THE OUTDOORS OR FROM SPACES FREELY COMMUNICATING WITH THE OUTDOORS PER IRC MITOI.
- HEATING AND COOLING EQUIPMENT SHALL BE SIZED IN ACCORDANCE WITH ACCA (AIR CONDITIONING CONTRACTORS OF AMERICA) MANUAL J OR OTHER APPROVED CALCULATIONS. DUCT SYSTEMS SERVING HEATING OR COOLING EXHAUST SYSTEMS SHALL BE DESIGNED IN ACCORDANCE WITH ACCA MANUAL D OR OTHER APPROVED METHODS. CALCULATIONS AND DOCUMENTATION IS NOW REQUIRED, IRC M 1301 & MIGO!
- DISCHARGE INTO A STREET, ALLEY, OR OTHER AREAS SO AS TO CAUSE A NUISANCE. I.R.C.MI4II.3
- DAMAGE TO ANY BUILDING COMPONENTS WILL OCCUR AS A RESULT OF OVERFLOW FROM THE EQUIPMENT DRAIN PAN OR STOPPAGE IN THE CONDENSATE DRAIN PIPING. DRAIN PIPING SHALL BE A MINIMUM OF 3/4" (19.1 MM) NOMINAL PIPE SIZE. I.R.C. MI411.3.1 RADIANT IN FLOOR HEATING: AN IN-FLOOR RADIANT HEAT SYSTEM SHALL BE INSTALLED (AS SELECTED BY OWNER). THE SYSTEM SHALL BE WIRSBRO OR EQUAL BOILER \$ TUBING.
- SUB-FLOOR INSTALLATION:(IF APPLICABLE): TUBING SHALL BE STAPLED TO SUBFLOOR ON 6" OR 12" O.C. (DEPENDING ON HEAT LOAD). SHALL BE COVERED W/1-1/2" LIGHTWEIGHT GYPSUM OR 6-1/2 BAG MIX PORTLAND CONCRETE MIX W/PEA GRAVEL (10-12 LBS/SQ. FT. LOADING). AREA OF HARDWOOD SHALL RECEIVE 2X2 DF SLEEPERS AS COORDINATED WITH FLOOR MANUFACTURER. IN LIEU OF CONCRETE FLOOR IN HARDWOOD AREAS, QUICK TRACK SYSTEM (1/2" PLYWOOD PANELS) SHALL BE INSTALLED FOR INSERTION OF TUBING.

SEWER/DRAIN: PLASTIC ABS TYPE.- BACKWATER VALVE IF REQUIRED PER IRC. P3008, WATER PIPE: COPPER SUPPLY TO METER.

- B. WATER HEATER: TWO (2) GAS FIRED, GLASS LINED A.O. SMITH SUB CHAMBER OR EQUAL, MINIMUM 50 GALLON EACH. WATER HEATERS SHALL BE ANCHORED OR STRAPPED TO RESIST HORIZONTAL DISPLACEMENT DUE TO EARTHQUAKE MOTION.
- FIXTURES: ALL FIXTURES SHALL BE SELECTED BY OWNER.
- MISCELLANEOUS: FAUCETS SELECTED BY OWNER. COLD WATER SUPPLY (NO WATER SOFTENER) TO KITCHEN SINK AND REFRIGERATOR. SHOWERS: ALL SHOWER COMPARTMENTS SHALL HAVE A MIN. FINISHED INTERIOR OF 1024 SQ. IN. AND SHALL ALSO HAVE A MIN. IMPACT RESISTANT SAFETY GLASS SHOWER DOOR
- . SHOWER PAN LINERS MUST EXTEND 3 INCHED ABOVE THE SHOWER DOOR THRESHOLD HEIGHT AND SOLID BLOCKING IS REQUIRED BEHIND ALL LINER LOCATIONS. SHOWER PAN LINERS MUST BE INSTALLED ON BUILT UP FLOORS AND MUST BE INSPECTED.
- BATHTUBS AND WHIRLPOOL (JETTED TUBS MUST NOW HAVE A TEMPERATURE LIMITING (120 DEGREES) MIX VALVE.

- D. SILLPLATE: 2X REDWOOD OR PRESSURE TREATED FIR (INSULATE WITH POLYSTYRENE FOAM STRIP AGAINST (OVERHANGS) CONCRETE SURFACES)
- F. MAIN FLOOR DIAPHRAGM BLOCKING REQUIRED FOR ALL FLOOR JOIST BAYS RUNNING PARALLEL WITH THE FOUNDATION (MUST HAVE FULL HEIGHT BLOCKING 48" O.C.)

B. ALL EARTH UNDER STRUCTURE OR SLAB SHALL BE STERILIZED.

GRAVEL OVERLAY (IF DETERMINED NECESSARY BY CONTRACTOR AND OWNER).

- UNDER ALL STAIRWAYS PER I.R.C. SECT. R302.6 & R302.7. APPLIED WITH SCREWS OR NAILS 6" OC CEILING, 7" OC WALLS. ROUNDED CORNERS TO MATCH THE EXISTING
- C. TUBS AND SHOWERS WITH TILE WALLS REQUIRE CEMENT, FIBER-CEMENT OR GLASS MAT GYPSUM BACKERS. GREEN BOARD IS NOT ALLOWED.
- EACH TRUSS TO BEARING WALL INTERFACE. OTHERWISE NOTED BY ENGINEER. SIMPSON METAL HURRICANE TIES SHALL BE INSTALLED AT EACH RAFTER TO BEARING WALL INTERFACE.
- 3/8" FROM EDGE OF PANEL AT ALL PANEL ENDS, SUPPORTED EDGES, SHEAR WALL TOPS AND ALL BLOCKING. NAIL @ 12" OC ALONG ALL INTERMEDIATE FRAMING MEMBERS.

A. UNDERLAY: 30 # FELT PAPER (WATER AND ICE SHIELD AT ALL VALLEYS AND AT ALL OVERHANGS)

- B. FLASHING: ALUMINUM- SHALL BE INSTALLED IN SUCH A MANNER SO AS TO PREVENT MOISTURE FROM ENTERING A WALL, ROOF OR FLOOR AND REDIRECT IT TO THE
- REQ'D. VENTILATION IS PROVIDED BY EAVES OR CORNICE VENTS.
- READILY ACCESSIBLE LOCATION PER IRC R807.1.

- A. WALLS: FIBERGLASS BATT OR BLOWN WET CELLULOSE (AS SELECTED BY OWNER) TYPE MINIMUM R-23 (2X6) OR R-19 (2X4) VALUE DEPENDING ON WALL TYPE B. BLOWN OR SPRAYED ROOF/CEILING: BLOWN ROCKWOOL OR FIBERGLASS MINIMUM R-49 VALUE. THE THICKNESS OF BLOWN IN OR SPRAYED ROOF/CEILING INSULATION (FIBERGLASS OR CELLULOSE) SHALL BE WRITTEN IN INCHES ON MARKERS THAT ARE INSTALLED AT LEAST ONE FOR EVERY 300 FT THROUGHOUT THE ATTIC SPACE. THE MARKERS SHALL BE AFFIXED TO THE TRUSSES OR JOIST AND MARKED WITH THE MINIMUM INITIAL INSTALLED THICKNESS WITH NUMBERS A MINIMUM OF 1" HIGH. EACH MARKER SHALL FACE THE ATTIC ACCESS OPENING.
- WINDOW TAPE: ALL WINDOWS SHALL BE TAPED WITH A WATER BARRIER TAPE TO SEAL AGAINST MOISTURE AND AIR INFILTRATION.
- F. ALL MATERIALS, SYSTEMS AND EQUIPMENT SHALL BE INSTALLED IN ACCORDANCE WITH THE MANUFACTURER'S INSTALLATION INSTRUCTIONS AND THE PROVISIONS OF THIS CODE.

- A. FASCIA: SEE ELEVATIONS (CONFIRM W/ OWNER) B. SOFFIT: ALUM. W/ VENTILATION OR AS SELECTED BY OWNER.
- D. DOWNSPOUTS/GUTTERS: ALUMINUM OR AS SELECTED BY OWNER.

HEATING, COOLING AND SERVICE WATER HEATING EQUIPMENT.

- 5. CABINETS: ALL CABINETRY SHALL BE HARDWOOD OR AS SELECTED BY OWNER.
- C. COUNTERTOPS/BACKSPLASH: GRANITE IN KITCHEN, LAUNDRY, BASEMENT KITCHEN AND IN ALL BATHROOMS.

- B. WIRING/OUTLETS: SHALL BE AS SHOWN ON THE PLANS AND PER N.E.C. AND LOCAL CODES. LIGHTING, EXHAUST FANS, DOOR CHIME, SMOKE DETECTORS, ETC. SHALL BE
- SELECTED BY OWNER. ALL SMOKE DETECTORS SHALL BE WIRED IN SERIES WITH BATTERY BACKUP SO THE ALARM IS AUDIBLE IN ALL SLEEPING AREAS PER IRC R314 ATTIC ACCESS AREA SHALL HAVE A SWITCHED LIGHT FIXTURE. CARBON MONOXIDE ALARMS SHALL BE INSTALLED PER IRC 315.
- . INSTALL WEATHER PROOF BUBBLE COVERS ON ALL EXTERIOR ELECTRICAL OUTLETS.

HEATING/AIR CONDITIONING:

- D. MISCELLANEOUS: ALL HEATING IS TO BE PERFORMED BY A LICENSED CONTRACTOR IN KEEPING WITH THE PRACTICES OR THE INTERNATIONAL MECHANICAL CODE.
- G. CONDENSATE FROM ALL COOLING COILS OR EVAPORATORS SHALL E CONVEYED FROM THE DRAIN PAN OUTLET TO AN APPROVED PLACE OF DISPOSAL. CONDENSATE SHALL NOT
- . IN ADDITION TO THE REQUIREMENTS OF SECTION 1411.3, A SECONDARY DRAIN OR AUXILIARY DRAIN PAN SHALL BE REQUIRED FOR EACH COOLING OR EVAPORATOR COIL WHERE
- TUBING SHALL BE CROSSLINK POLYETHYLENE W/BRASS FITTINGS AND MANIFOLD. ONE 83% EFFICIENT BOILER SHALL BE USED IN CONJUNCTION W/(2) 80 GAL. WATER TANKS. • SLAB INSTALLATION: TUBING SHALL INSTALLED ON 12" CENTERS TIED TO 6X6 WIRE MESH MAT.

- WIDTH OF 22". IF GLASS SHOWER ENCLOSURES ARE UTILIZED, GLASS SHALL BE IMPACT RESISTANT SAFETY RATED.
- G. APPLIANCES: ALL APPLIANCES (WATER HEATER, BOILER, STEAM GENERATOR, ETC.) WHICH REQUIRE PRESSURE RELIEF VALVES SHALL BE PROVIDED WITH A FULL SIZE DRAIN
- BACKMATER VALVES- FIXTURES THAT HAVE FLOOD LEVEL RIMS LOCATED BELOW THE ELEVATION OF THE NEXT UPSTREAM MANHOLE COVER OF THE PUBLIC SEWER SERVING SUCH FIXTURES SHALL BE PROTECTED FROM BACK FLOW OF SEWAGE BY INSTALLING AN APPROVED BACKWATER VALVE. FIXTURES HAVING FLOOD LEVEL RIMS ABOVE THE ELEVATION OF THE NEXT UPSTREAM MANHOLE SHALL NOT DISCHARGE THROUGH THE BACKWATER VALVE. BACKWATER VALVES SHALL BE PROVIDED WITH ACCESS. I.R.C. P3008

- A. EXTERIOR: SOLID CORE WOOD WITH WEATHER-STRIPPING, EXTERIOR DOORS WITH SIDELIGHTS OR AN INDIVIDUAL FIXED OR OPERABLE PANEL ADJACENT TO A DOOR WHERE THE NEAREST VERTICAL EDGE IS WITHIN A 24" ARC OF THE DOOR IN A CLOSED POSITION & WHOSE BOTTOM EDGE IS LESS THAN 60 INCHES ABOVE THE FLOOR OR WALKING SURFACE SHALL HAVE IMPACT RESISTANT GLAZING PER I.R.C. 308.4 EXTERIOR DOORS TO GARAGE SHALL BE A 20 MIN. FIRE RATED FEATURE WITH A
- SELF CLOSING FEATURE PER I.R.C. R309.1 (STYLE AND TYPE SELECTED BY OWNER, SEE PLAN DRAWING) B. INTERIOR: HOLLOW CORE MASONITE AS INDICATED ON THE DOOR SCHEDULE. (STYLE AND TYPE SELECTED BY OWNER, SEE PLAN DRAWINGS)
- C. GARAGE: INSULATED OVERHEAD METAL SECTIONAL TYPE MARTIN DOORS OR EQUAL WITH ELECTRICAL/MECHANICAL DOOR OPERATOR(DOOR SHALL BE WIRED ON SEPARATE CIRCUIT TO ALLOW. SHUTOFF AT INTERIOR OF HOME. (STYLE AND TYPE
- D. PATIO/GLASS DOORS: ALL PATIO/GLASS DOORS SHALL BE SAFETY RATED TEMPERED GLASS. (STYLE AND TYPE SELECTED BY E. PROVIDE CORROSION RESISTANT METAL L FLASHING OVER ALL EXTERIOR DOORS INCLUDING GARAGE DOORS WITHOUT NAILING
- FINS OR FLANGES.

15. <u>WINDOWS/SKYLIGHTS:</u>

SELECTED BY OWNER)

- A. MARVIN, ANDERSON OR EQUAL SUPPLIED BY BMC (COLOR AND STYLE BY OWNER). MANUFACTURERS DETAILS SHALL BE FOLLOWED FOR ROUGH FRAMING AND INSTALLATION (SEE PLAN DRAWINGS). B. GLAZING TO BE DOUBLE ARGON GAS FILLED WITH LOW E RATING OR AS SELECTED BY OWNER. ALL WINDOWS LOWER THAN 18"
- FROM THE FLOOR SHALL BE IMPACT RESISTANT SAFETY GLASS. C. SCREENS SHALL BE NYLON FABRIC. D. WINDOW WELLS: WINDOW WELL SHALL MEET I.R.C. R3IO.2 WITH A CLEAR HORIZONTAL AREA OF 9 SQ. FT. AND A MINIMUM WIDTH
- OF 3'-O". WINDOW WELL WITH A DEPTH OF 44" OR GREATER SHALL BE PROVIDED WITH A STAIR OR AN APPROVED LADDER. E. EGRESS: ALL BEDROOM WINDOWS SHALL HAVE A WINDOW OPENING OF 44" MAX. FROM THE FINISHED FLOOR, HAVE WINDOW GLASS OPENINGS OF 20" MIN. CLEAR WIDTH, AND 24" MIN. CLEAR HEIGHT. WITH A MIN. NET CLEAR OPENING OF 5.7 SQ. FT.
- EGRESS PER I.R.C. R310.1 F. WINDOWS OVER ALL BATHTUBS AND SHOWERS SHALL BE IMPACT RESISTANT SAFETY GLASS AS WELL AS WINDOWS WITHIN 24" OF
- G. GLAZING IN WALLS ENCLOSING STAIRWAY LANDINGS OR WITHIN 60 " OF THE TOP AND BOTTOM OF STAIRWAYS WHERE THE BOTTOM EDGE OF THE GLASS IS LESS THAN 60 " ABOVE THE WALKING SURFACE SHALL HAVE IMPACT RESISTANT GLAZING PER
- I.R.C. R308.4.6 \$ R308.4.7 H. FLASH AND CAULK ALL EXTERIOR WINDOWS AND DOORS AS PER MANUFACTURERS INSTALLATION INSTRUCTIONS. PROVIDE 9 INCH FLASHINGS FOR WINDOWS AS PER MANUFACTURER INSTALLATION INSTRUCTIONS.

WINDOWS WITH SILL HEIGHTS LESS THAN 18 INCHES ABOVE THE FINISHED FLOOR AND WHEN THE EXTERIOR SILL HEIGHT IS

GREATER THAN 6 FEET ABOVE GRADE MUST BE FIXED WINDOWS OF LABELED SAFETY GLAZING OR MUST HAVE 36 INCH HIGH GUARD WITH 4" MAX. OPENINGS TO PROTECT PERSON(S) FROM FALLING THROUGH (R613.2) K. PROVIDE CORROSION RESISTANT METAL L FLASHING OVER ALL EXTERIOR DOORS INCLUDING GARAGE DOORS WITHOUT NAILING FINS OR FLANGES.

A. WALL PAINT SHALL BE LATEX BASED SEALER, PRIMER AND 2 COATS OF ALKYD FINISH. (ALL PAINT AND COLORS SHALL BE CONFIRMED BY OWNER)

- 17. FIREPLACES/ STOVES: A. FIREPLACES SHALL CONSIST OF NATURAL GAS, DIRECT VENT, SEALED COMBUSTION, METAL FIREBOX AS MANUFACTURED BY HEAT-N-GLO MODEL 6000XT OR EQUAL OR AS SELECTED BY OWNER. MANUFACTURERS INSTRUCTIONS AND ALL LOCAL CODES
- SHALL BE FOLLOWED FOR INSTALLATION. B. ACTUAL FIREBOX OPENING/ FRAMING PER CONTRACTOR/ OWNER & FIREBOX SELECTED CONTACT ENGINEER FOR APPROVAL FOR SHEER WALL OPENING

18. HANDRAILINGS:.

AS SELECTED BY OWNER).

- A. REQUIRED GUARDS ON OPEN SIDES OF STAIRWAYS, RAISED FLOOR AREAS, BALCONIES AND PORCHES SHALL HAVE INTERMEDIATE RAILS OR ORNAMENTAL CLOSURES WHICH DO NOT ALLOW PASSAGE OF A SPHERE 4 INCHES (102 MM) OR MORE IN
- B. EXTERIOR: HAND RAILING SHALL BE POWDER COATED STEEL RAILING SYSTEM (OR AS SELECTED BY OWNER). C. INTERIOR: HAND RAILING SHALL BE KNOTTY ALDER RAIL AND NEWELS WITH WROUGHT IRON BALUSTERS (STAIN AND FINISH OR

- A. CARPET: AREAS TO BE CARPETED SHALL BE SHOWN ON PLANS (CARPET AND PADDING SELECTED BY OWNER). B. WOOD FLOOR: AREAS TO BE COVERED WITH HARDWOOD SHALL SHOWN ON PLANS (STYLE AND TYPE TO BE SELECTED BY THE
- OWNER). C. TILE/STONE: AREAS TO BE COVERED WITH TILE/NATURAL STONE SHALL BE SHOWN ON PLANS (STYLE AND TYPE TO BE SELECTED BY THE OWNER).

20. APPLIANCES:

ALL APPLIANCES SHALL BE SELECTED BY OWNER.

BATHROOM EXHAUST FAN DUCTS MUST CONTINUE AND DISCHARGE DIRECTLY OUTSIDE THE STRUCTURE. CLOSE PROXIMITY TO ATTIC VENTS OR TO SOFFIT AREAS ARE SPECIFICALLY PROHIBITED. ALL EXHAUST DUCTS MUST NOW CONNECT TO AN OPENING WITH PROPER SCREEN FOR TERMINATIONS IN WALL AREAS OR TO AN APPROVED THROUGH THE ROOF DISCHARGE FITTING INSTALLED AS NOT TO BE BLOCKED OR STOPPED BY SNOW OR ICE.

GENERAL DRAWING NOTES HABITATIONS MAKES EVERY EFFORT TO PRESENT ACCURATE & RELIABLE INFORMATION, HOWEVER IT DOES NOT ENDORSE, APPROVE, OR CERTIFY THE INFORMATION PROVIDED BY OTHERS, NOR DOES HABITATIONS GUARANTEE IT'S ACCURACY OR COMPLETENESS. USE OF THIS INFORMATION IS VOLUNTARY AND RELIANCE ON IT SHOULD ONLY BE UNDERTAKEN AFTER CAREFUL REVIEW AND INDEPENDENT VERIFICATION OF ITS ACCURACY AND COMPLETENESS. THE CONTRACTOR/OWNER/ TRADE CONTRACTORS SHALL ASSUME ALL RISKS FOR THE USE OF THE INFORMATION CONTAINED HEREIN, UNDER NO CIRCUMSTANCES WILL HABITATIONS, IT'S OFFICERS, EMPLOYEES OR AGENTS BE LIABLE FOR YOUR USE, MISUSE, REFERENCE TO, OR RELIANCE ON ANY OF THE INFORMATION PROPOSED OR THAT RESULT FROM MISTAKES, ERRORS, OMISSIONS, INTERPRETATIONS, OR DEFECTS

SQUARE FOOTAGE IS DETERMINED TO THE OUTSIDE OF ALL EXTERIOR WALLS IN EVERY LOCATION WHERE THE FLOOR JOISTS PROJECT FROM THE FOUNDATION FLOOR PLAN EXTERIOR DIMENSIONS ARE TO THE OUTSIDE FACE OF THE STUDS. (EXCLUDING SHEATHING). 3. AN ATTEMPT HAS BEEN MADE TO DESIGN TO FEDERAL, STATE AND LOCAL BUILDING CODES AND ORDINANCES HOWEVER THE CONTRACTOR/ OWNER SHALL HAVE RESPONSIBILITY TO INSURE THAT ALL APPLICABLE FEDERAL, STATE & LOCAL BUILDING CODES AND ORDINANCES ARE MET. THE CONTRACTOR/OWNER SHALL CHECK AND VERIFY ALL DIMENSIONS AND

1. FLOOR PLAN INTERIOR DIMENSIONS ARE TO INSIDE OF UNFINISHED (STUD) WALLS (UNFINISHED WALL THICKNESS EQUALS 3 1/2").

SPECIFICATIONS AND ASSUME RESPONSIBILITY FOR ALL DAMAGES OR STRUCTURAL FAILURES DUE TO ANY OMISSIONS OR ERRORS IN THE DESIGN AND/OR USE OF THESE DRAWINGS/SPECIFICATIONS. 4. ELECTRICAL, PLUMBING AND HVAC DETAILS ARE NOT SHOWN. THE GENERAL CONTRACTOR SHALL HAVE THE RESPONSIBILITY

AND FINAL PLACEMENT AND ELEVATIONS OF FOOTINGS/FOUNDATIONS AND TO MEET ALL LOCAL ZONING CODES/ORDINANCES.

- TO INSURE THAT SUBCONTRACTORS FOLLOW ALL APPLICABLE CODES. 5. STRUCTURAL ROOF, FLOOR AND WALL FRAMING DETAILS ARE SHOWN FOR INFORMATION ONLY. THE CONTRACTOR SHALL BE RESPONSIBLE FOR FRAMING TO MEET STRUCTURAL REQUIREMENTS OF ALL APPLICABLE CODES.
- 6. CABINET DETAILS ARE NOT SHOWN. DESIGN, STYLE AND COLOR SHALL BE THE RESPONSIBILITY OF THE CONTRACTOR/OWNER 7. SITE PLAN IS SHOWN FOR INFORMATION ONLY. OWNER /CONTRACTOR SHALL HAVE RESPONSIBILITY TO DETERMINE GRADES
- 8. A TRASH DUMPSTER AND PORTA-POTTY SHALL BE PROVIDED AT ALL NEW CONSTRUCTION SITES. CAN NOT BE PLACED IN STREET OR ACROSS SIDEWALK AND PARKSTRIP. 9. A CERTIFICATE MUST BE POSTED IN OR BY THE ELECTRICAL PANEL OR FURNACE ROOM LISTING THE R VALUES OF THE INSULATION INSTALLED IN THE WALLS, CEILINGS, FOUNDATION WALLS, SLAB, CRAWLSPACE AND DUCTS OUTSIDE CONDITIONED

SPACES. WINDOWS U-FACTORS AND SOLAR HEAT GAIN CONSTANTS MUST ALSO BE LISTED AND SHOWN. THE TYPE AND

EFFICIENCY OF THE FURNACE, BOILER, WATER HEATER AND AIR CONDITIONING EQUIPMENT SHALL ALSO BE LISTED.

	NOMEN	NCLATURE	
ABBREVIATION	DESCRIPTION	ABBREVIATION	DESCRIPTION
ALUM	ALUMINUM	LIN	LINEN
A/R	AS REQUIRED	MFG	MANUFACTURER
AV	AUDIO VIDEO	MECH	MECHANICAL
BSMNT	BASEMENT	MIN	MINIMUM
BRG.	BEARING		
BTR	BETTER	MOD	MODIFIED
BKS	B00KS	MTR	MOTOR
Б	BUILT IN	NTS	NOT TO SCALE
CAB	CABINET	00	ON CENTER
CLG	CEILING	PAN	PANTRY
CV	CENTRAL VACUUM	P SI	POUNDS PER SQUARE INCH
CONC.	CONCRETE	PLCS	PLACES
CTR	COUNTER	₽L	POINT LOAD
DW	DISH WASHER	PDR	POWDER ROOM
DBL	D <i>O</i> UBLE	REF	REFRIGERATOR
DF	DOUGLAS FIR	R \$ S	ROD AND SHELF
DN	DOWN	RB	ROOF BEAM
ELEV.	ELEVATION	SHLVS	SHELVES
EQ	EQUAL	SPECS	SPECIFICATIONS
-	FIREPLACE	SURF.	SURFACE
₽	FLOOR BEAM	SUSP.	SUSPENDED
FTG	FOOTING	SQ.	SQUARE
FDN	FOUNDATION	T # <i>G</i>	TONGUE AND GROOVE
⊨⊤.	FEET	T.O.F	TOP OF FOUNDATION
FURN.	FURNACE	TYP	TYPICAL
GYP.	G YPSUM	UNCL	UNDER COUNTER LIGHTING
HVAC	HEATING, VENTILATION, AIR CONDITIONING	uno	UNLESS NOTED OTHERWISE
HT/HGT	HEIGHT	MIC	WALK-IN-CLOSET
IRC	INTERNATIONAL RESIDENTIAL CODE	MO	WALL OVEN
LAUN	LAUNDRY	MH	WATER HEATER

NOMENCI ATURE




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DRAWN BY:

T. RICKS SSUE DATE: XX/XX/201 PLAN NUMBER: 15446 SHEET NUMBER

2 0 15

M. STEELE

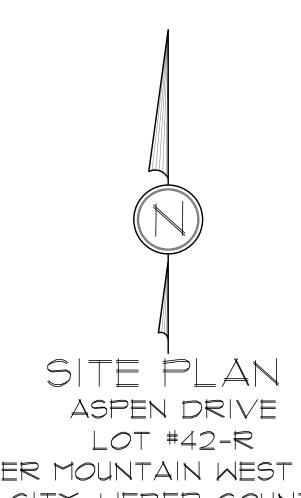

POWDER MOUNTAIN WEST PHASE 2 EDEN CITY, WEBER COUNTY, UTAH

> SCALE: 1" = 10'-0" Area = 9,559 Sq. Ft. = 0.22 ACRE

PLEASE NOTE:

- 1. SITE PLAN IS SHOWN FOR INFORMATION ONLY, OWNER /CONTRACTOR SHALL HAVE RESPONSIBILITY TO DETERMINE GRADES AND FINAL PLACEMENT AND ELEVATIONS OF FOOTINGS/FOUNDATIONS AND SHALL BE RESPONSIBLE FOR COMPLIANCE WITH ALL STATE, NATIONAL, AND LOCAL BUILDING CODES & ORDINANCES
- 2. THIS SITE PLAN IS A REPRESENTATION OF CONCRETE FOUNDATIONAL BUILDING FOOTPRINT ONLY. ALL SETBACK INFORMATION SHOWN IS TO CONCRETE FOUNDATION WALLS ONLY. SITE PLAN DOES NOT INDICATE THE LOCATION OF ROOF OVERHANGS OR CANTILEVERS (WALL POPOUTS OR FLOOR OVERHANGS) OR OTHER ARCHITECTURAL ELEMENTS THAT MAY PENETRATE THE PROPERTY SETBACKS OR EASEMENTS. THE PLAN COUNTY, CITY OR OTHER JURISDICTION REVIEWER, CONTRACTOR AND OWNER SHALL REVIEW ALL PLAN SUBMITTAL DRAWINGS (FLOOR PLANS ELEVATIONS, DETAILS, ETC ...) IN CONJUNCTION WITH THE SITE PLAN TO IDENTIFY ANY PROPOSED WALL CANTILEVERS OR OTHER FEATURES THAT MAY ENCROACH INTO SETBACKS AND SHALL REPORT ANY CONCERNS TO THE DESIGNER PRIOR TO EXCAVATION AND/OR CONSTRUCTION.


LINETYPE LEGEND

	——————————————————————————————————————	ROPERTY LINE TBACK LINE SEMENT LINE OME FOOTPRINT	ALL D OF TH PIPED BEHIN
		ROPOSED CONT.	
		CONT. LINE	
		RECTIONAL DRAINAGE ARROWS	
1.	ALL STORM WATER AND DIRT WILL BE KEPT ON S LANDSCAPING IS DONE.	SITE DURING CONSTRUCTION UNTIL FINAL	
2.	THE GRADE AWAY FROM FOUNDATION WALLS SHA	LL FALL A MINIMUM OF 6 INCHES WITHIN TH	E
3.	STREET, CURB AND GUTTER WILL BE INSPECTED, END OF EVERY DAY.	AND CLEANED OF ALL MUD AND DIRT AT TH	4 E
4.	STRAW WATTLES (OR EQUIVALENT) TO BE PLACE INLET ADJACENT TO OR IMMEDIATELY DOWNSTRE		RAIN
5.	BERMS OR SWALES MAY BE REQUIRED ALONG PR FLOW ONTO ADJACENT LOTS. FINAL GRADING SH	OPERTY LINES TO PREVENT STORM WATER	2
6.	ALL REAR DRAINAGE TO BE RETAINED ON THE P	ROPERTY.	
٦.	FIXTURES THAT HAVE FLOOD LEVEL RIMS LOCATS UPSTREAM MANHOLE COVER OF THE PUBLIC SEWE PROTECTED FROM BACK FLOW OF SEWAGE BY IN FIXTURES HAVING FLOOD LEVEL RIMS ABOVE THE SHALL NOT DISCHARGE THROUGH THE BACKWATE PROVIDED WITH ACCESS.	ER SERVING SUCH FIXTURES SHALL BE ISTALLING AN APPROVED BACKWATER VAL E ELEVATION OF THE NEXT UPSTREAM MANH	40LE
8.	LONG-TERM DRAINAGE CONTROL BY STANDARD TREES AND BUSHES AND AN AUTOMATIC SPRINKL	,	?A55,



NOTES:

- 1. EXCESS AND WASTE CONCRETE SHALL NOT BE WASHED INTO THE STREET OR INTO A DRAINAGE SYSTEM.
- 2. FOR WASHOUT OF CONCRETE AND MORTAR PRODUCTS, A DESIGNATED CONTAINMENT FACILITY OF SUFFICIENT CAPACITY TO RETAIN LIQUID AND SOLID WASTE SHALL BE PROVIDED ON SITE. THIS DISCHARGE AREA MUST BE LINED WITH AN IMPERMEABLE BARRIER.
- 3. SLURRY FROM CONCRETE AND ASPHALT SAW CUTTING SHALL BE VACUUMED OR CONTAINED, DRIED, PICKED UP, AND DISPOSED OF PROPERLY.

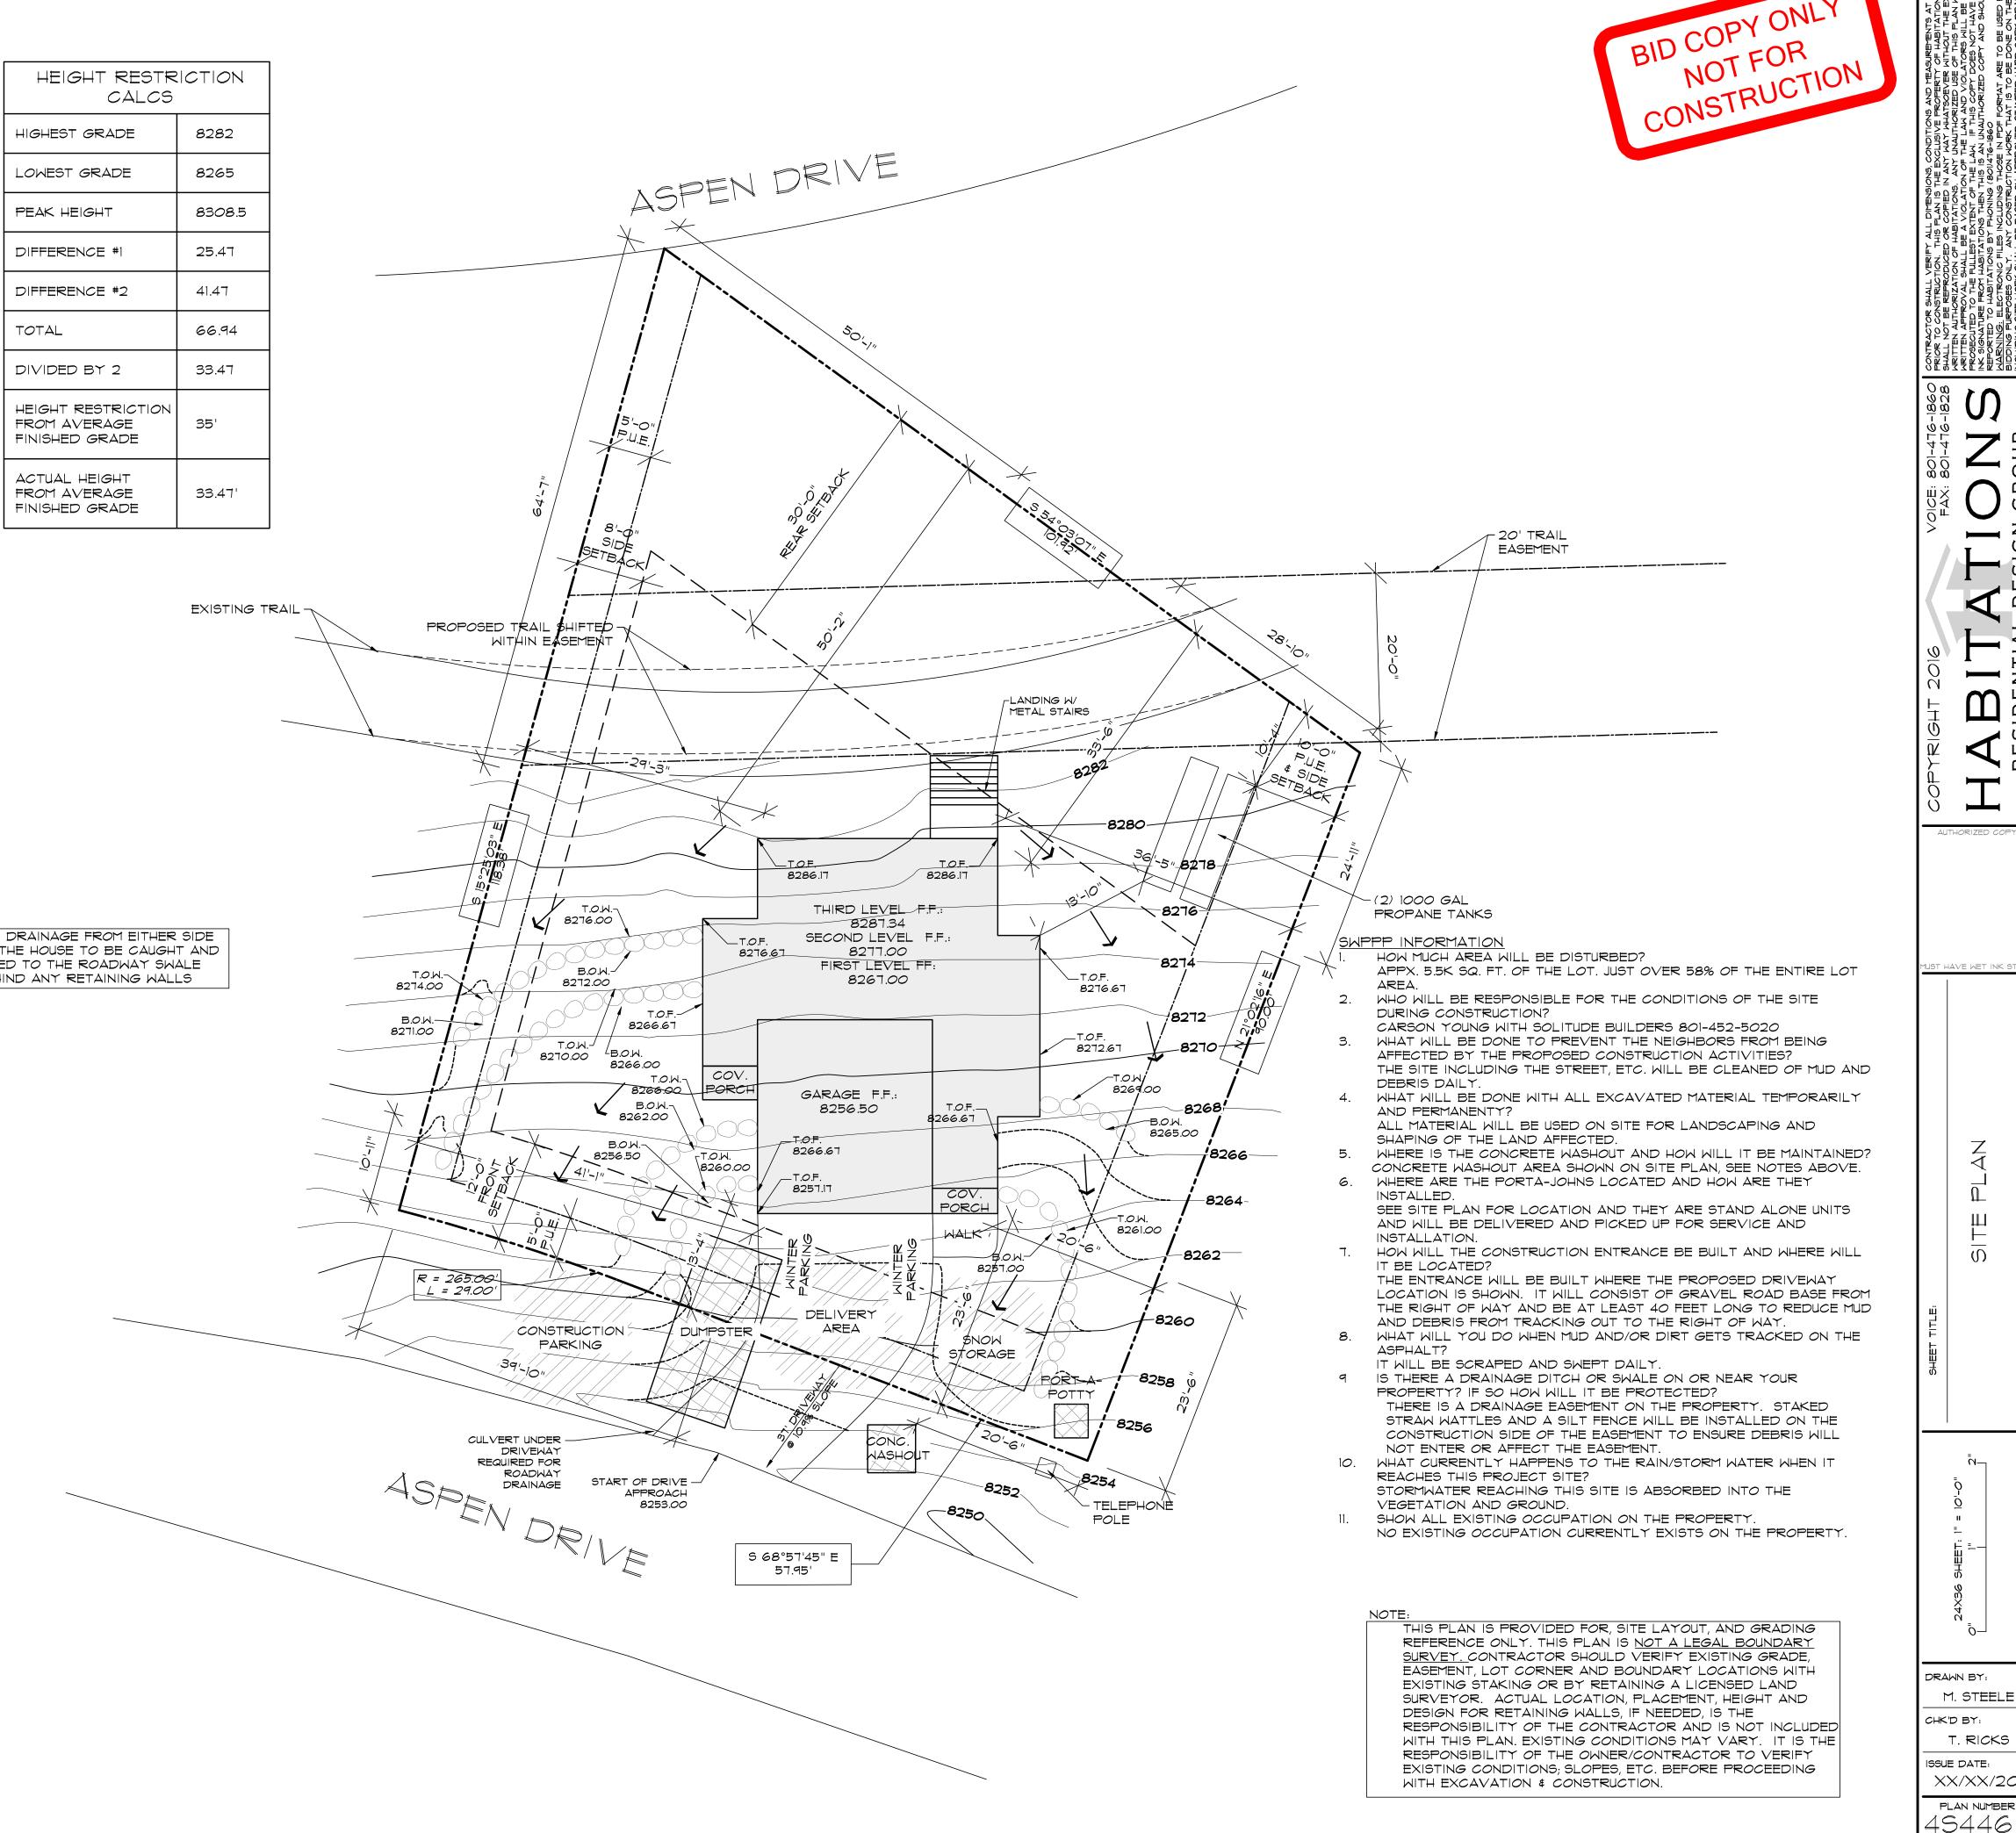

M. STEELE


T. RICKS


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PLAN NUMBER: 45446

SHEET NUMBER:

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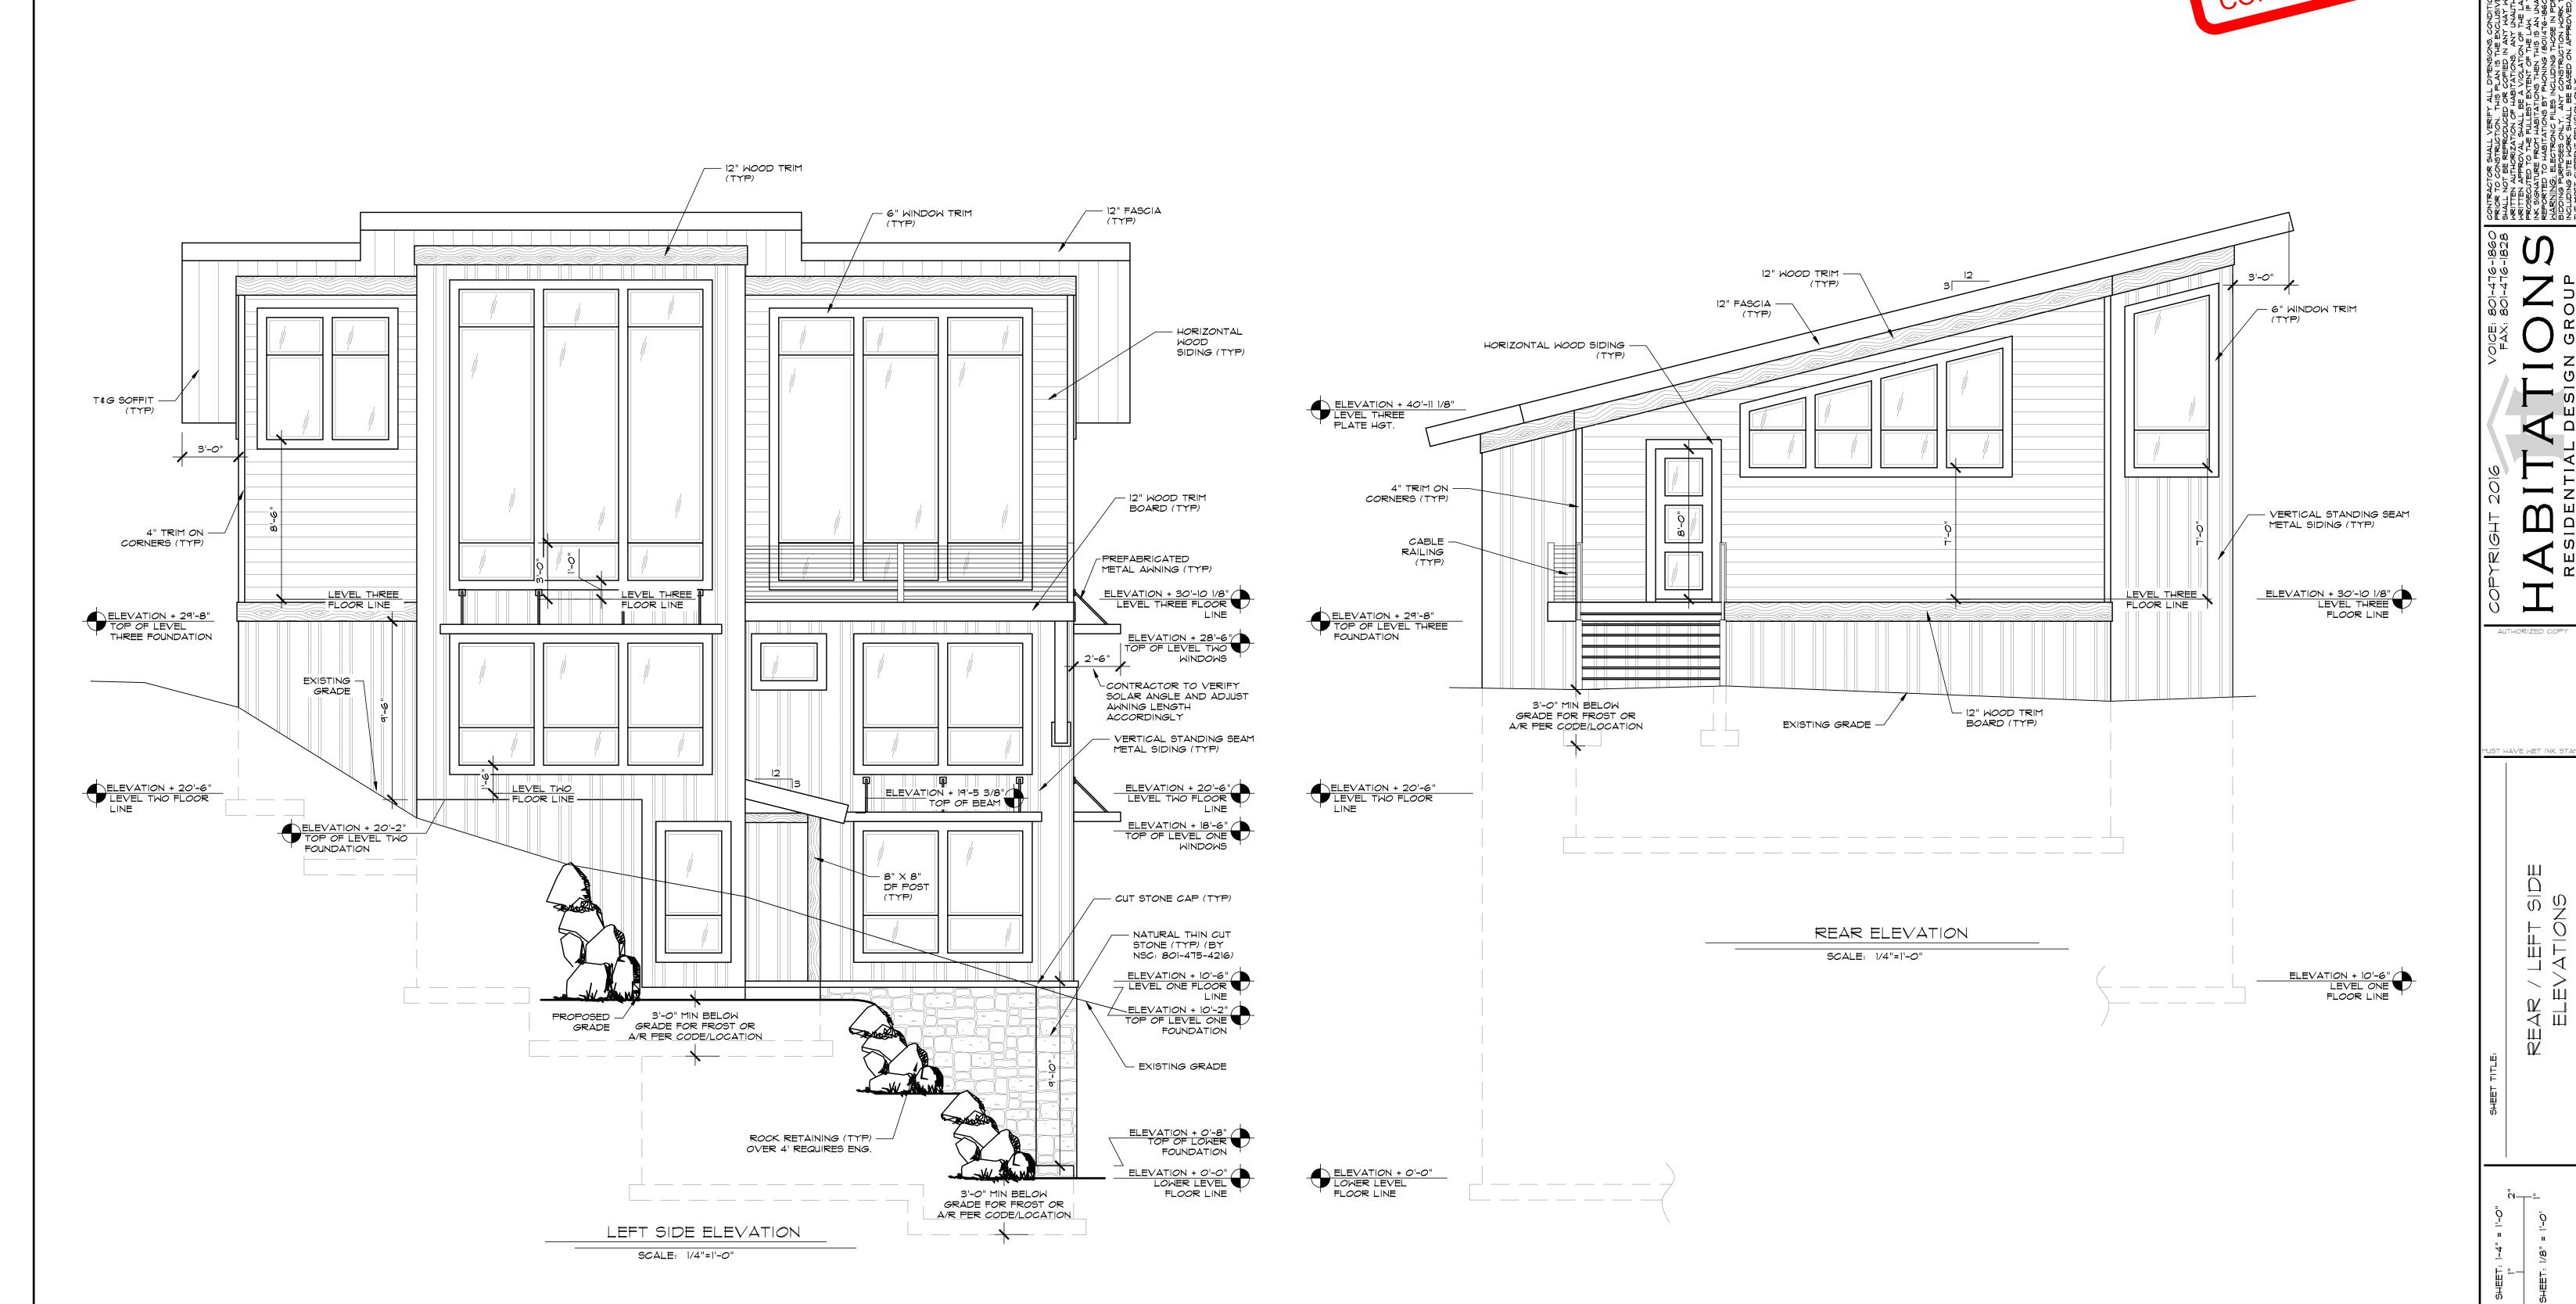
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DRAWN BY: M. STEELE CHK'D BY: T. RICKS ISSUE DATE: XX/XX/201

PLAN NUMBER: 454465 SHEET NUMBER:

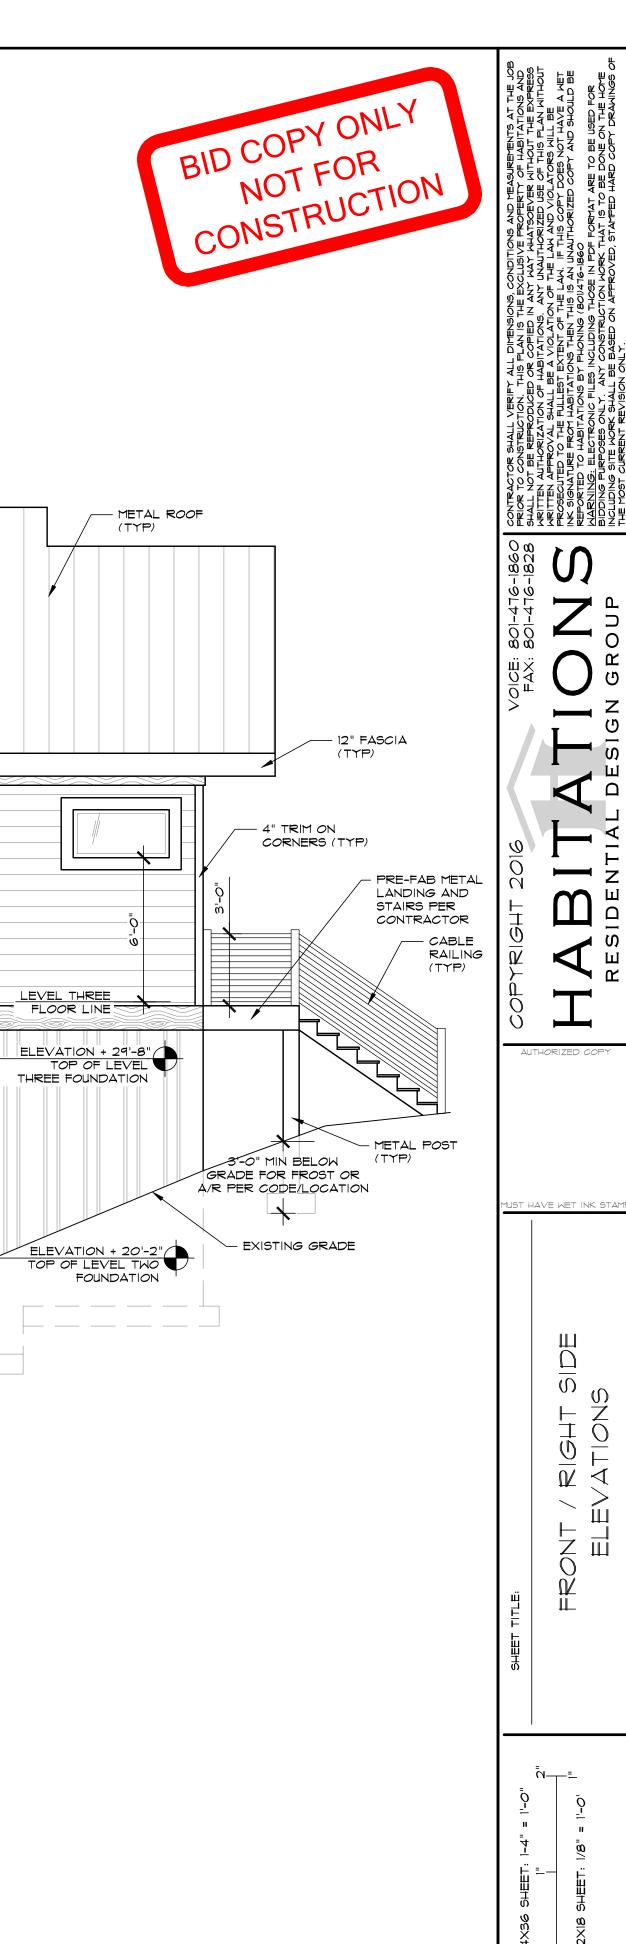4 of 15

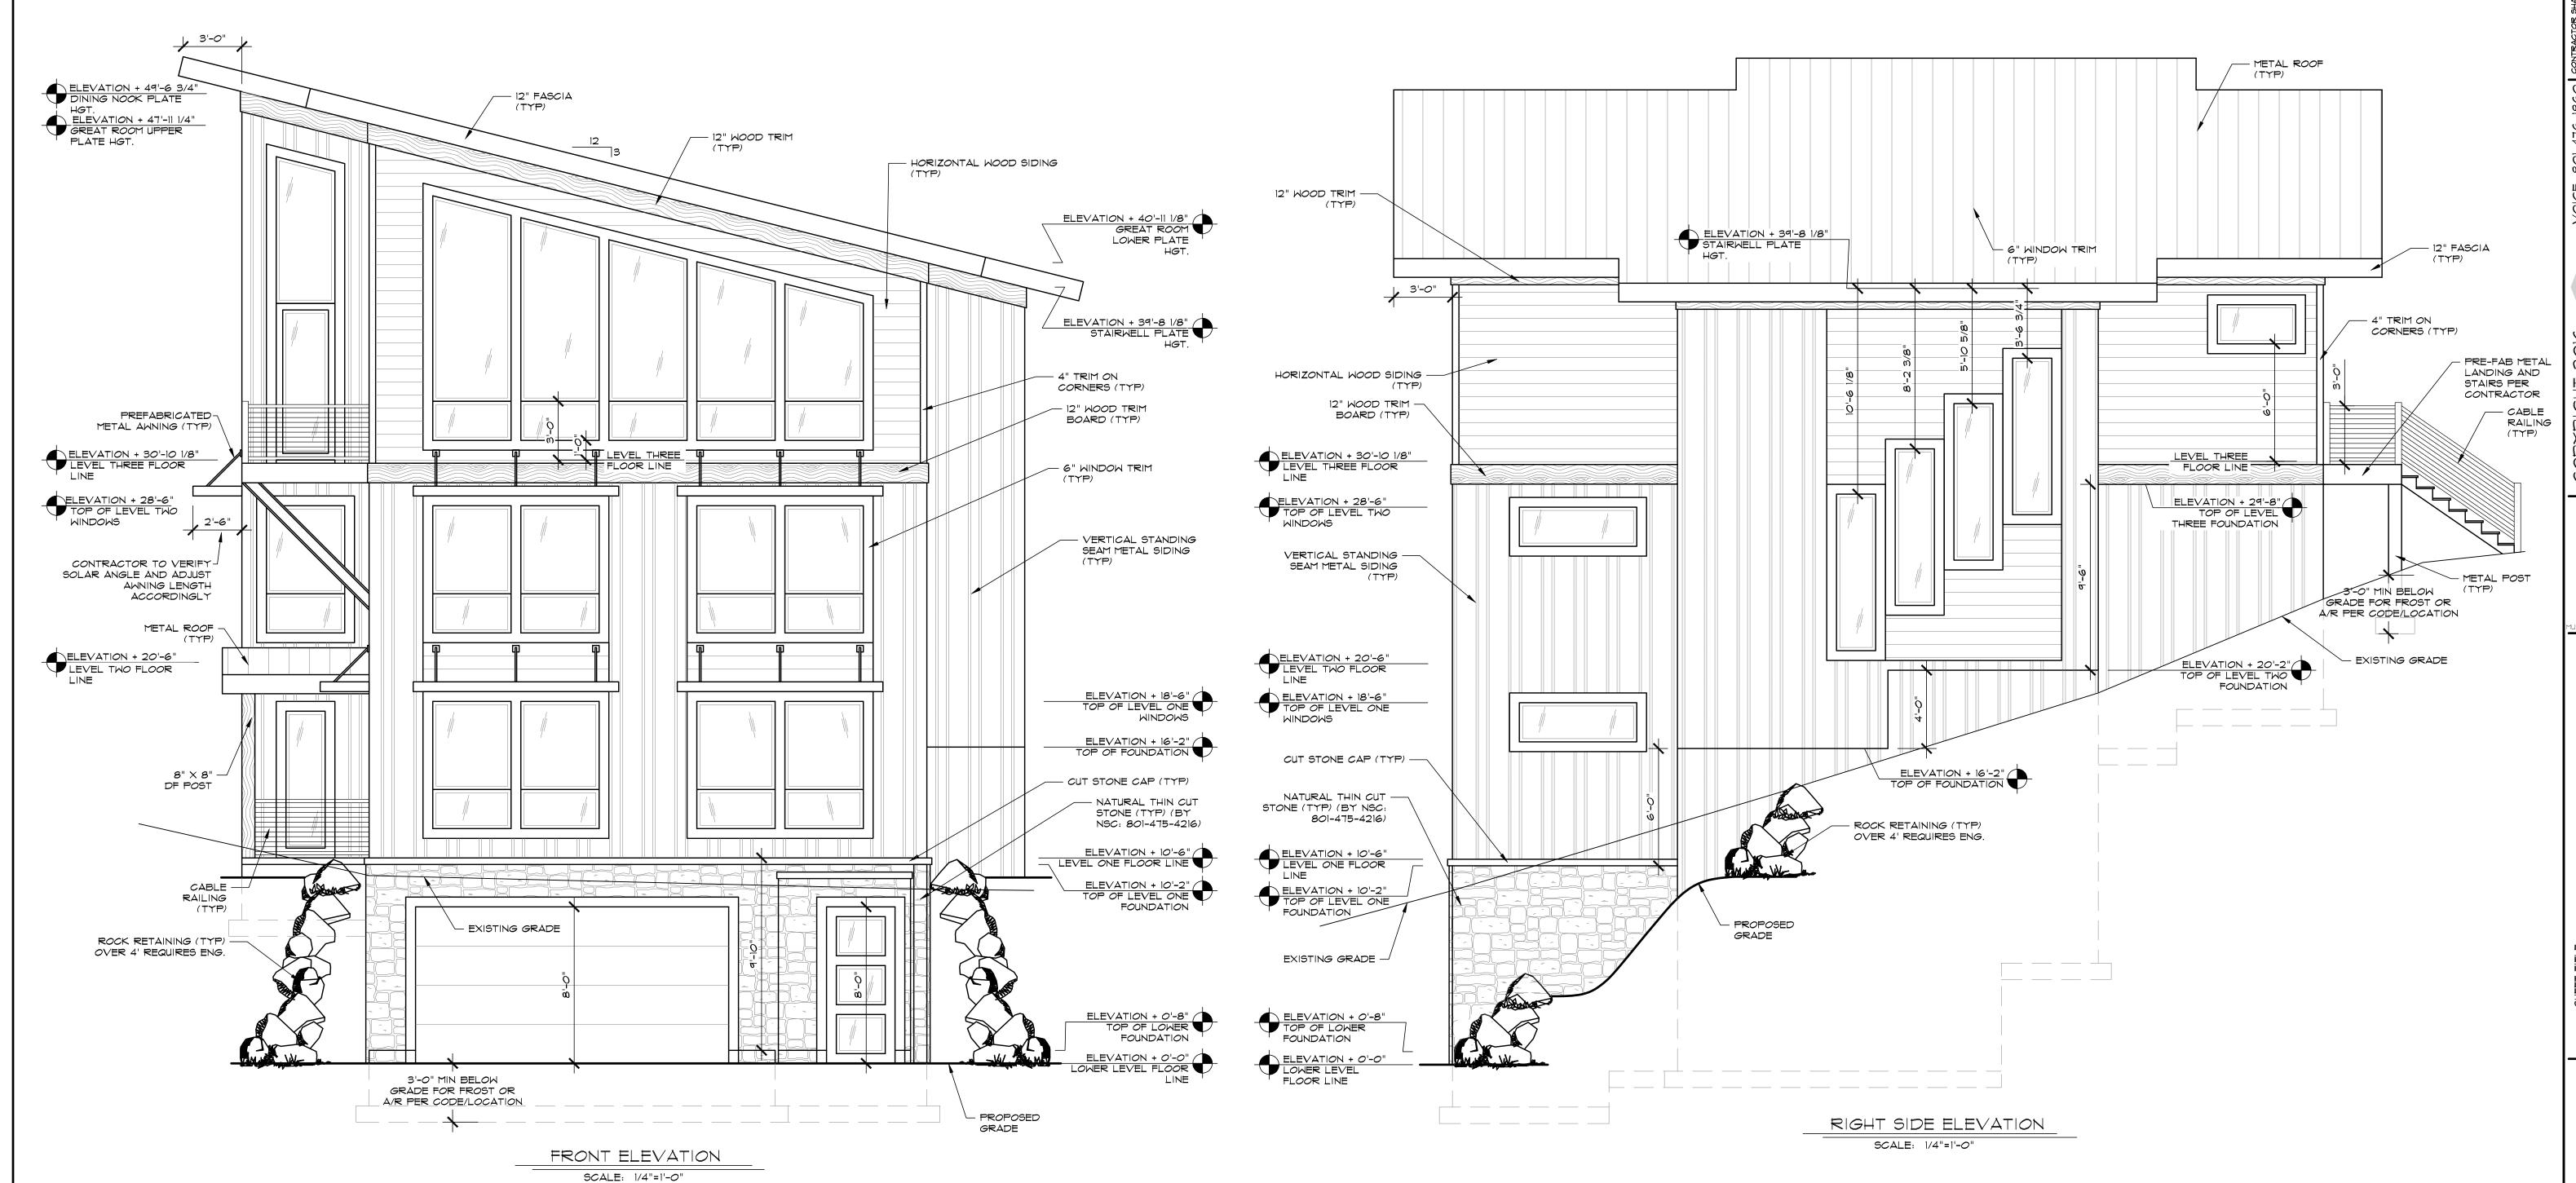




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<u>~</u>——<u>-</u>

DRAWN BY: M. STEELE CHK'D BY: T. RICKS ISSUE DATE: XX/XX/201 PLAN NUMBER: 454465

SHEET NUMBER:

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MPORTANT NOTE:

THE CONTRACTOR IS REQUIRED TO CONSULT WITH A GEO-TECHNICAL ENGINEER
TO VERIFY ALLOWABLE SOIL BEARING PRESSURE, AND THAT EXPANSIVE SOILS DO
NOT EXIST IN THE VICINITY OF CONSTRUCTION PRIOR TO INSTALLING THE
FOUNDATION. ALL FINDINGS ARE TO BE REPORTED TO THE STRUCTURAL ENGINEER

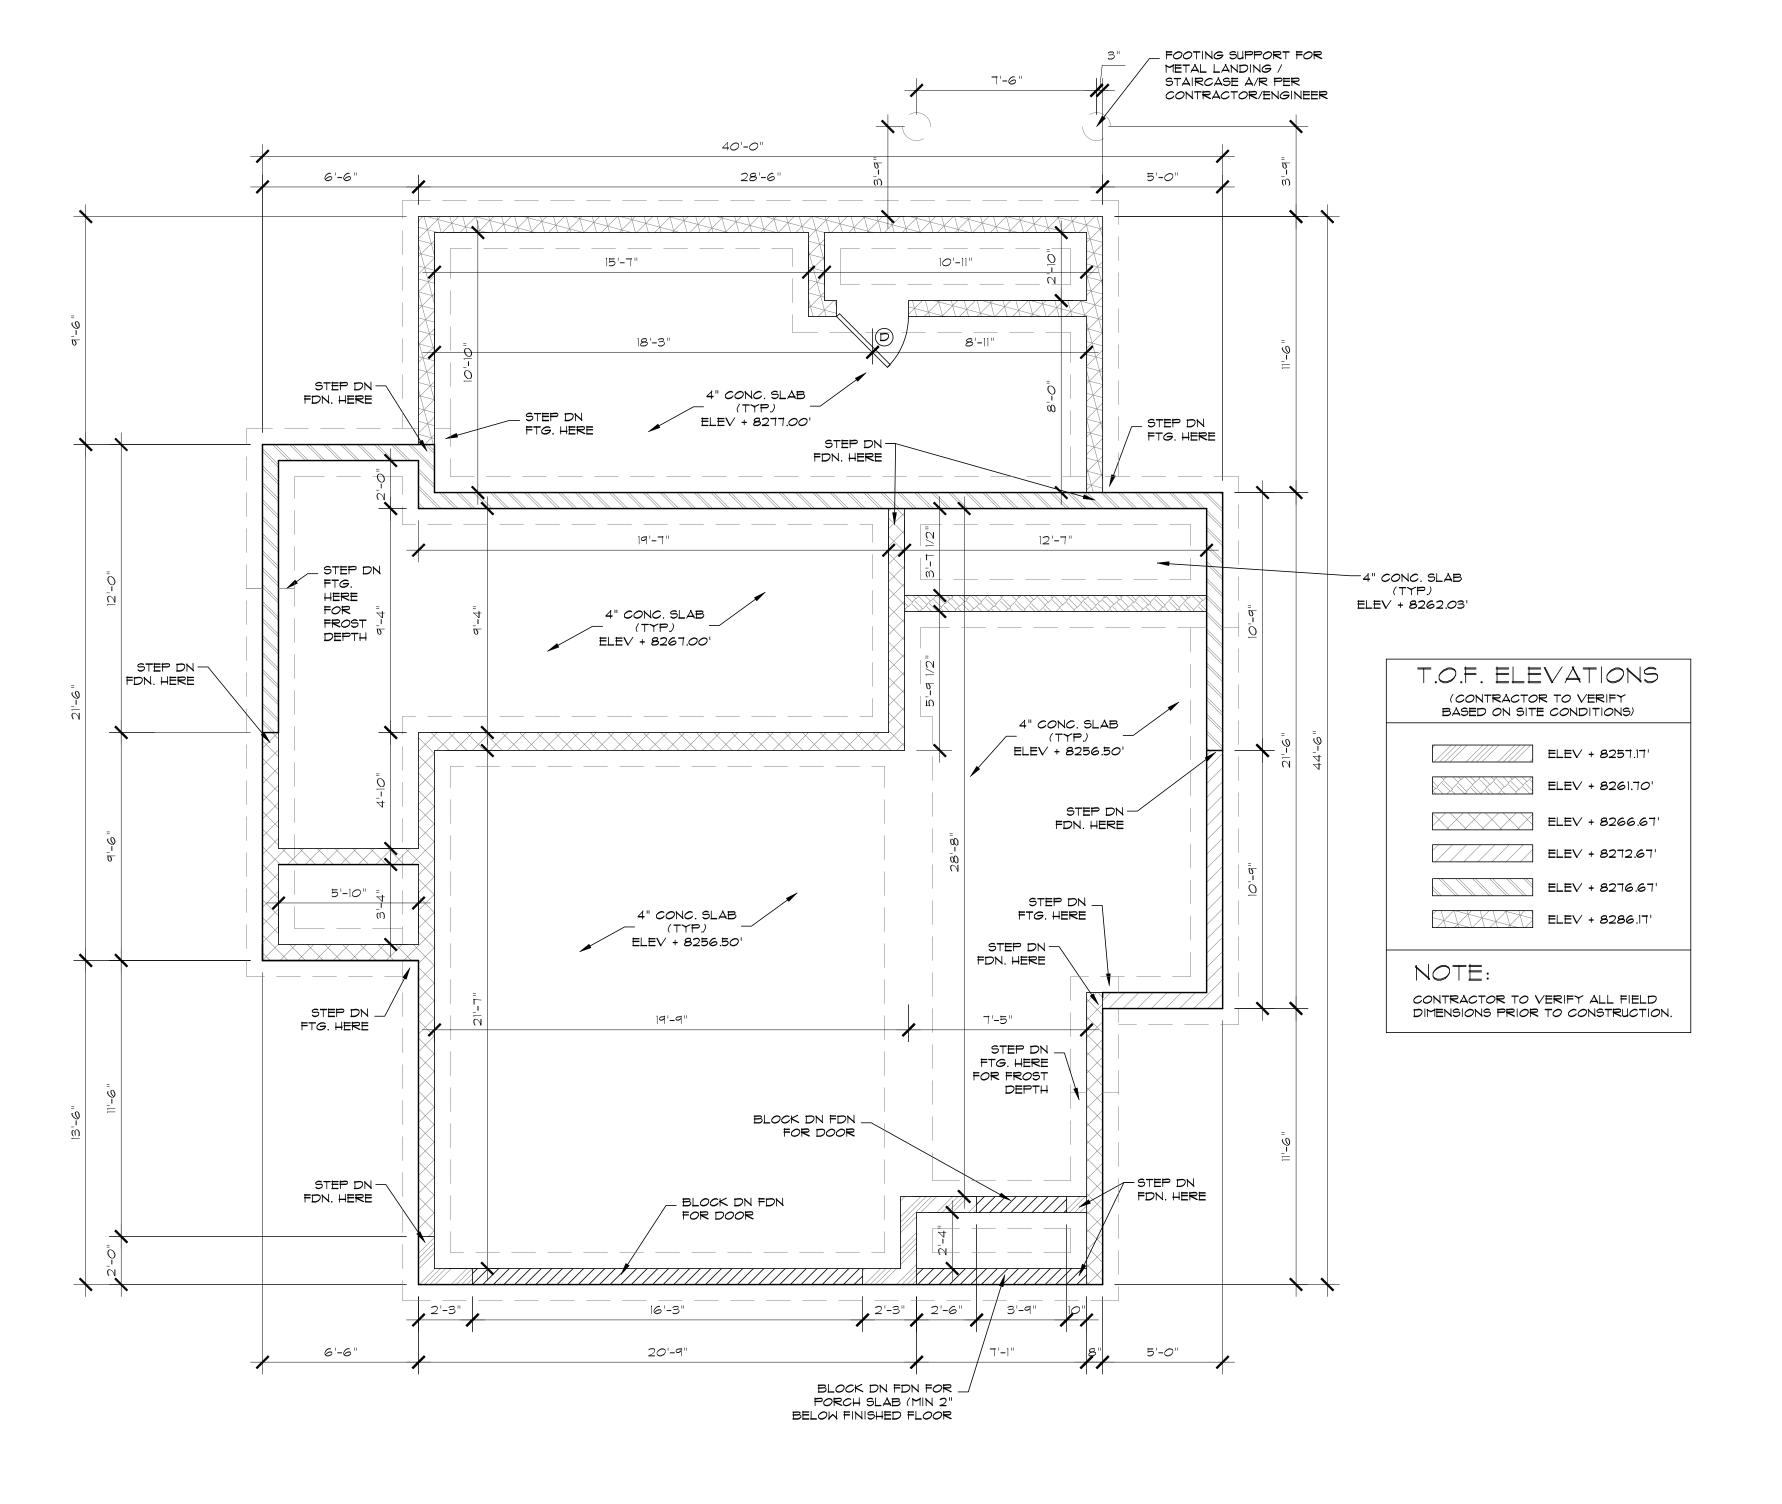PRIOR TO PROCEEDING.

THE FOOTING/ FOUNDATION PLAN INFORMATION PRESENTED HEREIN IS "FOR INFORMATION ONLY." THE STRUCTURAL ENGINEER SHALL BE RESPONSIBLE FOR FOOTING/ FOUNDATION PLAN DETAILS AND REQUIREMENTS, ELEVATIONS OF FOOTINGS OR TOP OF FOUNDATIONS SHOULD BE DETERMINED BY THE GENERAL CONTRACTOR BASED ON SITE CONDITIONS AND OWNER DESIRES.

FIELD VERIFY ALL DIMENSIONS PRIOR TO CONSTRUCTION
 FOUNDATION MUST BE INSULATED WITH A MIN. OF R-10 RIGID INSULATION.

SEE PAGE 7 FOR WINDOW AND DOOR SCHEDULE HABITATION GROUP

'ING / FOUNDATION PLAN

DRAWN BY:

M. STEELE

CHK'D BY:

T. RICKS

ISSUE DATE:


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PLAN NUMBER:

454465

SHEET NUMBER:



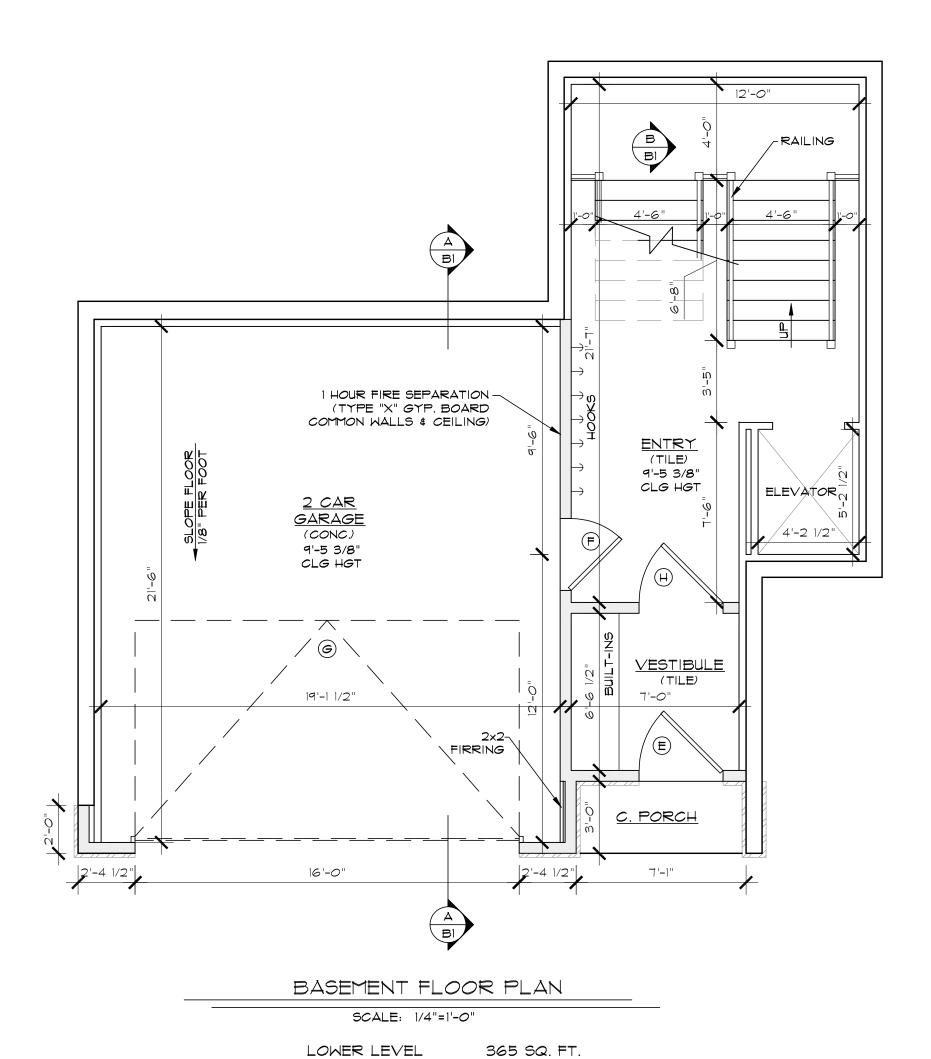



GARAGE

463 SQ. FT.

		DOOR SCHEDULE
	QTY	DESCRIPTIONS
Д	1	2'-4" X 8'-0" PKT DOOR
B	4	2'-6" X 8'-0" PKT DOOR
C	5	2'-6" X 8'-0" INTERIOR 2 PANEL DOOR
D	8	3'-0" X 8'-0" INTERIOR 2 PANEL DOOR
E	3	3'-0" X 8'-0" EXTERIOR GLASS DOOR
F	1	3'-0" X 8'-0" 20 MIN FIRE RATED W/ SELF CLOSE
G	1	18'-0" X 8'-0" INSULATED OVERHEAD DOOR
H	3	3'-0" X 8'-0" EXTERIOR 2 PANEL DOOR
	2	6'-0" X 8'-0" INTERIOR 2 PANEL DBL. DOOR
J	1	5'-0" X 8'-0" INTERIOR 2 PANEL DBL. DOOR
K	1	3'-0" X 8'-0" EXTERIOR FULL GLASS DOOR W/ 7'-
NOT	 =	TRAPEZOID TRANSOM Ess otherwise specified all interior doors shall have pine jambs

		WINDOW SCHEDULE
D	QTY	DESCRIPTIONS
1	16	4'-0" X 4'-6" FIXED W/ 2'-0" BOTTOM TRANSOM
2	4	2'-0" x 8'-0" FIXED (TEMPERED)
3	1	3'-0" X 2'-0" AWNING
4	1	4'-0" X 6'-0" FIXED TRAPEZOID W/ 2'-0" BOTTOM TEMPERED TRANSOM
5	1	4'-0" X 7'-1 1/2" FIXED TRAPEZOID W/ 2'-0" BOTTOM TEMPERED TRANSOM
6	1	4'-0" X 8'-3" FIXED TRAPEZOID W/ 2'-0" BOTTOM TEMPERED TRANSOM
٦	1	4'-0" X 9'-4 1/2" FIXED TRAPEZOID W/ 2'-0" BOTTOM TEMPERED TRANSOM
8	1	4'-0" X 10'-6" FIXED TRAPEZOID W/ 2'-0" BOTTOM TEMPERED TRANSOM
9	1	4'-0" × 2'-0" FIXED
10	3	4'-0" X 10'-0" FIXED W/ 2'-0 TOP TRANSOM & 2'-0" BOTTOM TEMPERED TRANSOM
11	3	4'-0" X 11'-6" FIXED W/ 2'-0" TOP TRANSOM \$ 2'-0" BOTTOM TEMPERED TRANSOM
12	1	3'-0" X 1'-9" FIXED TRAPEZOID W/ 2'-0" BOTTOM TRANSOM
13	1	3'-0" X 2'-7 1/2" FIXED TRAPEZOID W/ 2'-0" BOTTOM TRANSOM
14	1	3'-0" X 3'-6" FIXED TRAPEZOID W/ 2'-0" BOTTOM TRANSOM
15	1	4'-0" X 4'-4 1/2" FIXED TRAPEZOID W/ 2'-0" BOTTOM TRANSOM
16	1	4'-0" X 7'-2 1/2" FIXED TRAPEZOID W/ 2'-0" BOTTOM TRANSOM
17	1	3'-0" X 4'-6" FIXED W/ 2'-0" BOTTOM TRANSOM
18	2	3'-0" X 4'-6" FIXED W/ 2'-0" TRANSOM
19	2	6'-0" X 2'-0" FIXED
MAF	RVIN OR	ESS OTHERWISE NOTED ALL WINDOWS SHALL BE ALUMINUM CLAD WOOD BY VINYL SUPPLIED BY BMC WEST OR EQUAL. MANUFACTURERS DIRECTIONS

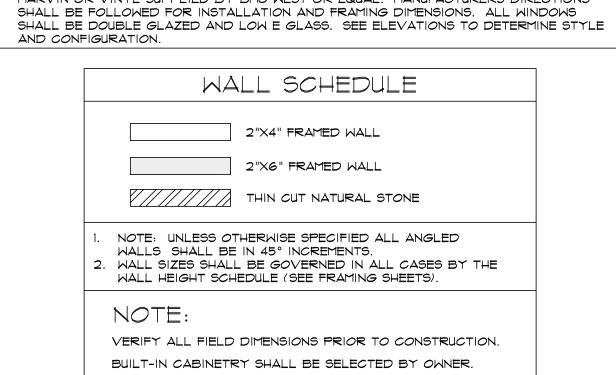

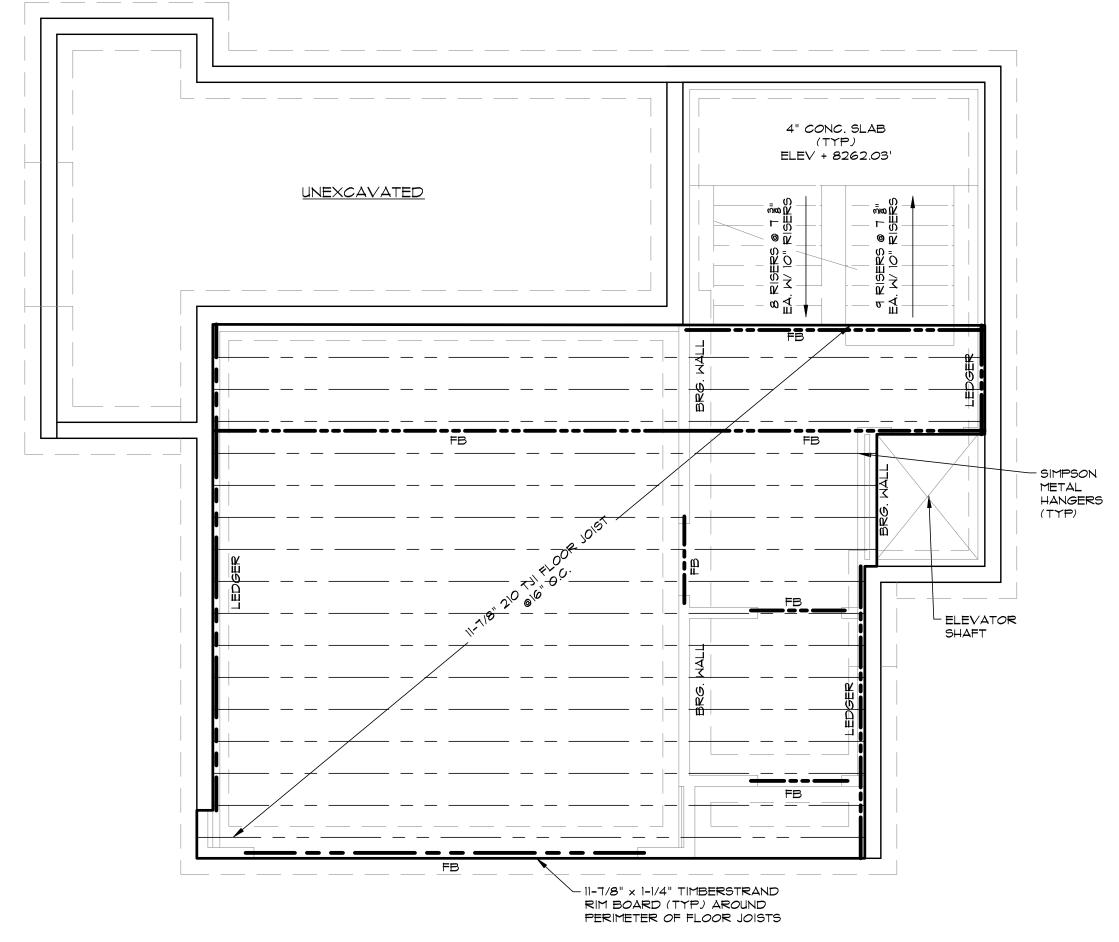

LEVEL ONE FLOOR FRAMING PLAN

SCALE: 1/4"=1'-0"

IMPORTANT NOTE:

THE FLOOR FRAMING PLAN INFORMATION PRESENTED HEREIN IS "FOR INFORMATION ONLY." THE ACTUAL FLOOR FRAMING PLAN SHALL BE THE RESPONSIBILITY OF THE STRUCTURAL ENGINEER. HABITATIONS MAKES NO GUARANTEE TO THE PLAN ACCURACY OR COMPLETENESS AND ASSUMES NO LIABILITY FOR SUCH.

BASEMENT LEVEL 365 SQ. FT.

GARAGE 463 SQ. FT.

XX/XX/2016

PLAN NUMBER:

454465

SHEET NUMBER:

7 of 15

DRAWN BY:

CHK'D BY:

ISSUE DATE:


M. STEELE

T. RICKS

EVEL FLOOM

BASEY LEVEL



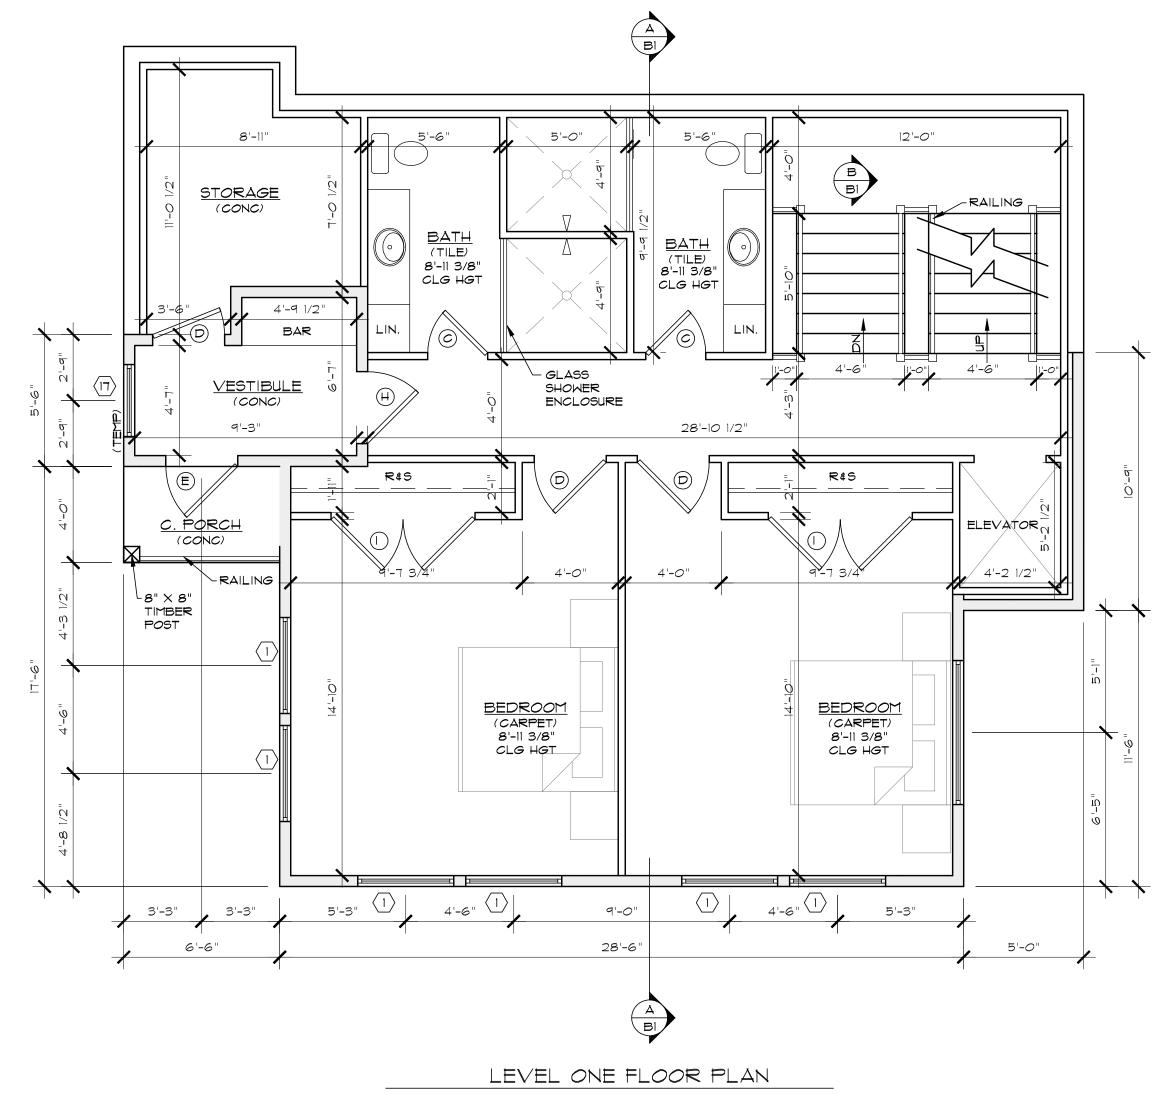

SCALE: 1/4"=1'-0"


LEVEL ONE 1163 SQ. FT.


	T	DOOR SCHEDULE
ID	QTY	DESCRIPTIONS
Д	1	2'-4" X 8'-0" PKT DOOR
В	4	2'-6" X 8'-0" PKT DOOR
C	5	2'-6" X 8'-0" INTERIOR 2 PANEL DOOR
D	8	3'-0" X 8'-0" INTERIOR 2 PANEL DOOR
E	3	3'-0" X 8'-0" EXTERIOR GLASS DOOR
F	1	3'-0" X 8'-0" 20 MIN FIRE RATED W/ SELF CLOSER
G	1	18'-0" X 8'-0" INSULATED OVERHEAD DOOR
H	3	3'-0" X 8'-0" EXTERIOR 2 PANEL DOOR
	2	6'-0" X 8'-0" INTERIOR 2 PANEL DBL. DOOR
J	1	5'-0" X 8'-0" INTERIOR 2 PANEL DBL. DOOR
K	1	3'-0" \times 8'-0" Exterior full glass door $\text{W}/\text{T}'\text{-6}'$ trapezoid transom

NOTE: UNLESS OTHERWISE SPECIFIED ALL INTERIOR DOORS SHALL HAVE PINE JAMBS. ALL EXTERIOR DOORS SHALL HAVE PINE JAMBS, DEAD BOLTS AND WEATHER-STRIPPING. ALL GLASS ENTRY & PATIO DOORS SHALL HAVE LOW-E, DOUBLE GLAZED, TEMPERED SAFETY GLASS.

		WINDOW SCHEDULE	
ID	QTY	DESCRIPTIONS	
1	16	4'-0" X 4'-6" FIXED W/ 2'-0" BOTTOM TRANSOM	
2	4	2'-0" x 8'-0" FIXED (TEMPERED)	
3	1	3'-0" X 2'-0" AWNING	
4	1	4'-0" X 6'-0" FIXED TRAPEZOID W/ 2'-0" BOTTOM TEMPERED TRANSOM	
5	1	4'-0" X 7'-1 1/2" FIXED TRAPEZOID W/ 2'-0" BOTTOM TEMPERED TRANSOM	
6	1	4'-0" X 8'-3" FIXED TRAPEZOID W/ 2'-0" BOTTOM TEMPERED TRANSOM	
٢	1	4'-0" X 9'-4 1/2" FIXED TRAPEZOID W/ 2'-0" BOTTOM TEMPERED TRANSOM	
8	1	4'-0" X 10'-6" FIXED TRAPEZOID W/ 2'-0" BOTTOM TEMPERED TRANSOM	
9	1	4'-0" X 2'-0" FIXED	
0	3	4'-0" X 10'-0" FIXED W/ 2'-0 TOP TRANSOM \$ 2'-0" BOTTOM TEMPERED TRANSOM	
11	3	4'-0" X 11'-6" FIXED W/ 2'-0" TOP TRANSOM \$ 2'-0" BOTTOM TEMPERED TRANSOM	
12	1	3'-0" X 1'-9" FIXED TRAPEZOID W/ 2'-0" BOTTOM TRANSOM	
13	1	3'-0" X 2'-7 1/2" FIXED TRAPEZOID W/ 2'-0" BOTTOM TRANSOM	
14	1	3'-0" X 3'-6" FIXED TRAPEZOID W/ 2'-0" BOTTOM TRANSOM	
15	1	4'-0" X 4'-4 1/2" FIXED TRAPEZOID W/ 2'-0" BOTTOM TRANSOM	
16	1	4'-0" X 7'-2 1/2" FIXED TRAPEZOID W/ 2'-0" BOTTOM TRANSOM	
17	1	3'-0" X 4'-6" FIXED W/ 2'-0" BOTTOM TRANSOM	
18	2	3'-0" X 4'-6" FIXED W/ 2'-0" TRANSOM	
19	2	6'-0" X 2'-0" FIXED	
NOTE: UNLESS OTHERWISE NOTED ALL WINDOWS SHALL BE ALUMINUM CLAD WOOD BY			

NOTE: UNLESS OTHERWISE NOTED ALL WINDOWS SHALL BE ALUMINUM CLAD WOOD BY MARVIN OR VINYL SUPPLIED BY BMC WEST OR EQUAL. MANUFACTURERS DIRECTIONS SHALL BE FOLLOWED FOR INSTALLATION AND FRAMING DIMENSIONS. ALL WINDOWS SHALL BE DOUBLE GLAZED AND LOW E GLASS. SEE ELEVATIONS TO DETERMINE STYLE AND CONFIGURATION.

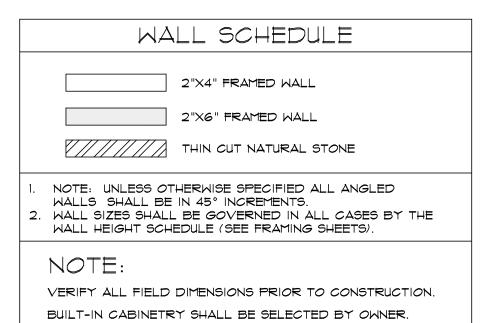

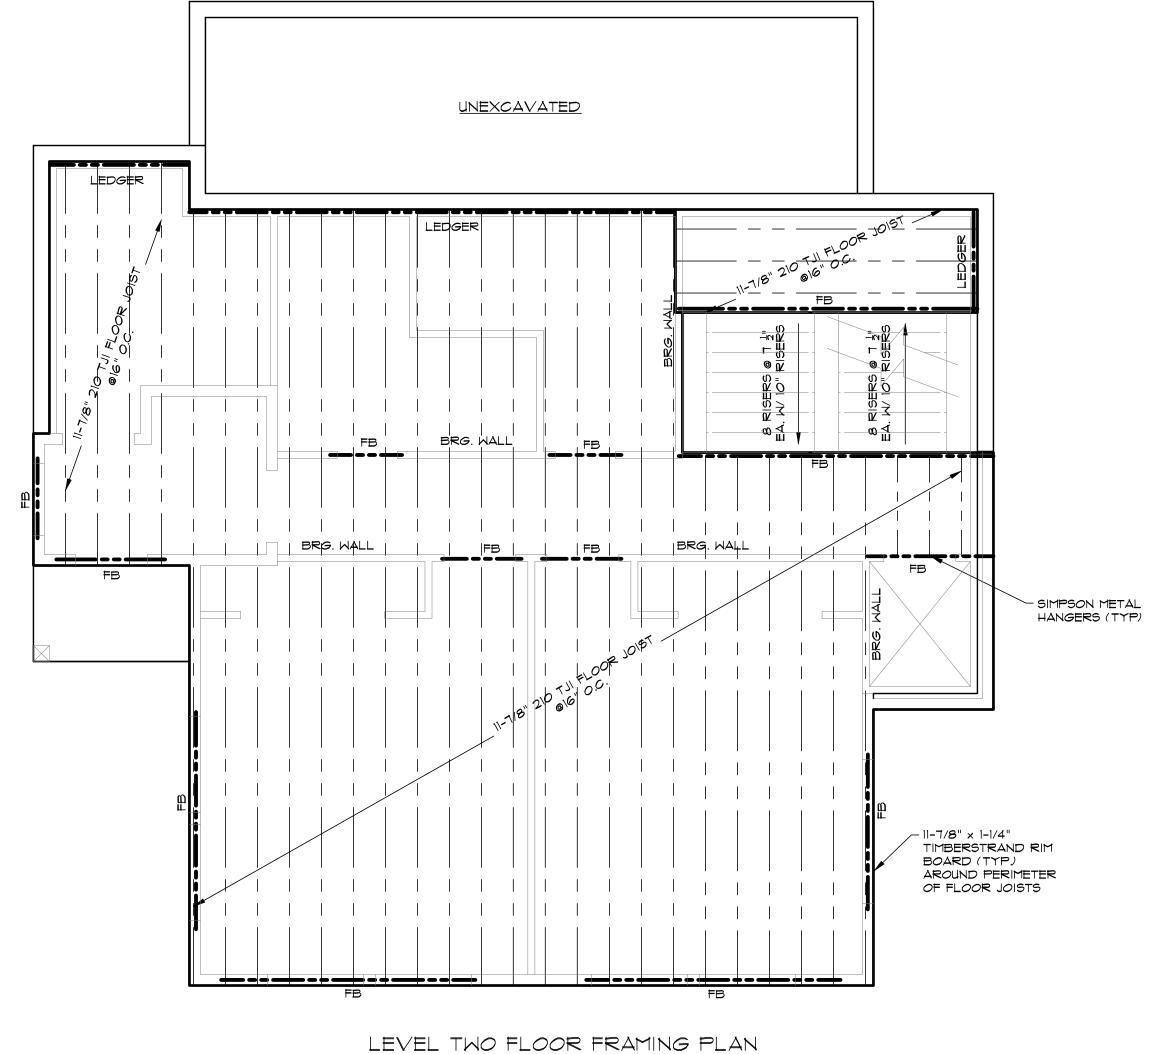

SCALE: 1/4"=1'-0"

IMPORTANT NOTE:

 THE FLOOR FRAMING PLAN INFORMATION PRESENTED HEREIN IS "FOR INFORMATION ONLY." THE ACTUAL FLOOR FRAMING PLAN SHALL BE THE RESPONSIBILITY OF THE STRUCTURAL ENGINEER. HABITATIONS MAKES NO GUARANTEE TO THE PLAN ACCURACY OR COMPLETENESS AND ASSUMES NO LIABILITY FOR SUCH.


> CHK'D BY: T. RICKS ISSUE DATE: XX/XX/201 PLAN NUMBER: 454465 SHEET NUMBER:

> > 7 of 15

DRAWN BY:

M. STEELE

LOWER FLOOR 1163 SQ. FT.

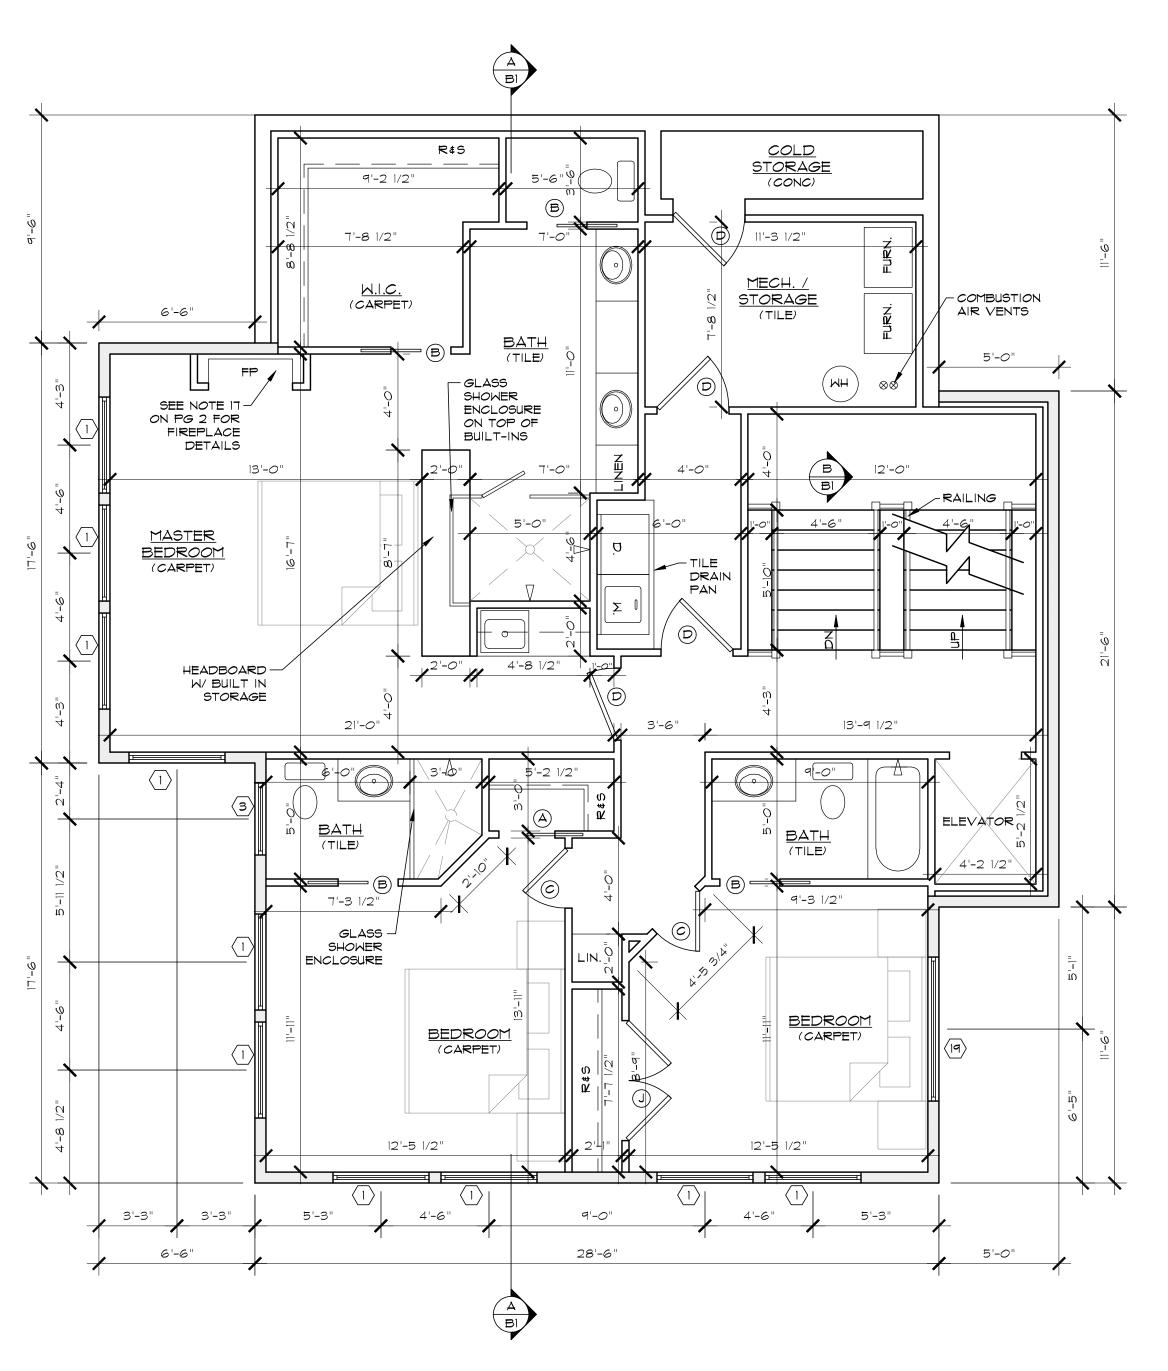


LEVEL TWO FLOOR PLAN

LEVEL TWO 1448 SQ. FT.

SCALE: 1/4"=1'-0"

DOOR SCHEDULE DESCRIPTIONS ID QTY A | 1 | 2'-4" X 8'-0" PKT DOOR B | 4 | 2'-6" X 8'-0" PKT DOOR C | 5 | 2'-6" X 8'-0" INTERIOR 2 PANEL DOOR 3'-0" X 8'-0" INTERIOR 2 PANEL DOOR E | 3 | 3'-0" X 8'-0" EXTERIOR GLASS DOOR 3'-0" X 8'-0" 20 MIN FIRE RATED W/ SELF CLOSER 2 6'-0" X 8'-0" INTERIOR 2 PANEL DBL. DOOR TRAPEZOID TRANSOM NOTE: UNLESS OTHERWISE SPECIFIED ALL INTERIOR DOORS SHALL HAVE PINE JAMBS. ALL EXTERIOR DOORS SHALL HAVE PINE JAMBS, DEAD BOLTS AND WEATHER-STRIPPING. ALL GLASS ENTRY & PATIO DOORS SHALL HAVE LOW-E, DOUBLE GLAZED, TEMPERED SAFETY GLASS.

		WINDOW SCHEDULE
ID	QTY	DESCRIPTIONS
1	16	4'-0" X 4'-6" FIXED W/ 2'-0" BOTTOM TRANSOM
2	4	2'-0" x 8'-0" FIXED (TEMPERED)
3	1	3'-0" X 2'-0" AWNING
4	1	4'-0" X 6'-0" FIXED TRAPEZOID W/ 2'-0" BOTTOM TEMPERED TRANSOM
5	1	$4'-0" \times 7'-1 1/2"$ FIXED TRAPEZOID W/ $2'-0"$ BOTTOM TEMPERED TRANSOM
6	1	4'-0" X 8'-3" FIXED TRAPEZOID W/ 2'-0" BOTTOM TEMPERED TRANSOM
7	1	4'-0" X 9'-4 1/2" FIXED TRAPEZOID W/ 2'-0" BOTTOM TEMPERED TRANSOM
8	1	4'-0" X 10'-6" FIXED TRAPEZOID W/ 2'-0" BOTTOM TEMPERED TRANSOM
9	1	4'-0" X 2'-0" FIXED
10	3	4'-0" X 10'-0" FIXED W/ 2'-0 TOP TRANSOM & 2'-0" BOTTOM TEMPERED TRANSOM
11	3	4'-0" X 11'-6" FIXED W/ 2'-0" TOP TRANSOM \$ 2'-0" BOTTOM TEMPERED TRANSOM
12	1	3'-0" X 1'-9" FIXED TRAPEZOID W/ 2'-0" BOTTOM TRANSOM
13	1	3'-0" X 2'-7 1/2" FIXED TRAPEZOID W/ 2'-0" BOTTOM TRANSOM
14	1	3'-0" X 3'-6" FIXED TRAPEZOID W/ 2'-0" BOTTOM TRANSOM
15	1	4'-0" X 4'-4 1/2" FIXED TRAPEZOID W/ 2'-0" BOTTOM TRANSOM
16	1	4'-0" X 7'-2 1/2" FIXED TRAPEZOID W/ 2'-0" BOTTOM TRANSOM
17	1	3'-0" X 4'-6" FIXED W/ 2'-0" BOTTOM TRANSOM
18	2	3'-0" X 4'-6" FIXED W/ 2'-0" TRANSOM
19	2	6'-0" X 2'-0" FIXED
MAF	EVIN OR	VINYL SUPPLIED BY BMC WEST OR EQUAL. MANUFACTURERS DIRECTIONS

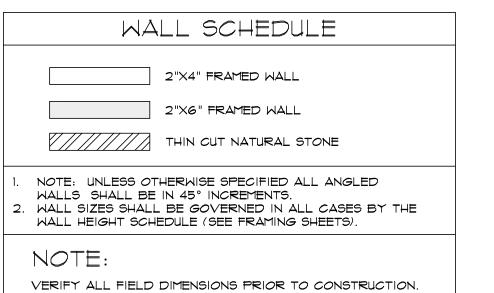


BUILT-IN CABINETRY SHALL BE SELECTED BY OWNER.

SHALL BE FOLLOWED FOR INSTALLATION AND FRAMING DIMENSIONS. ALL WINDOWS

AND CONFIGURATION.

SHALL BE DOUBLE GLAZED AND LOW E GLASS. SEE ELEVATIONS TO DETERMINE STYLE

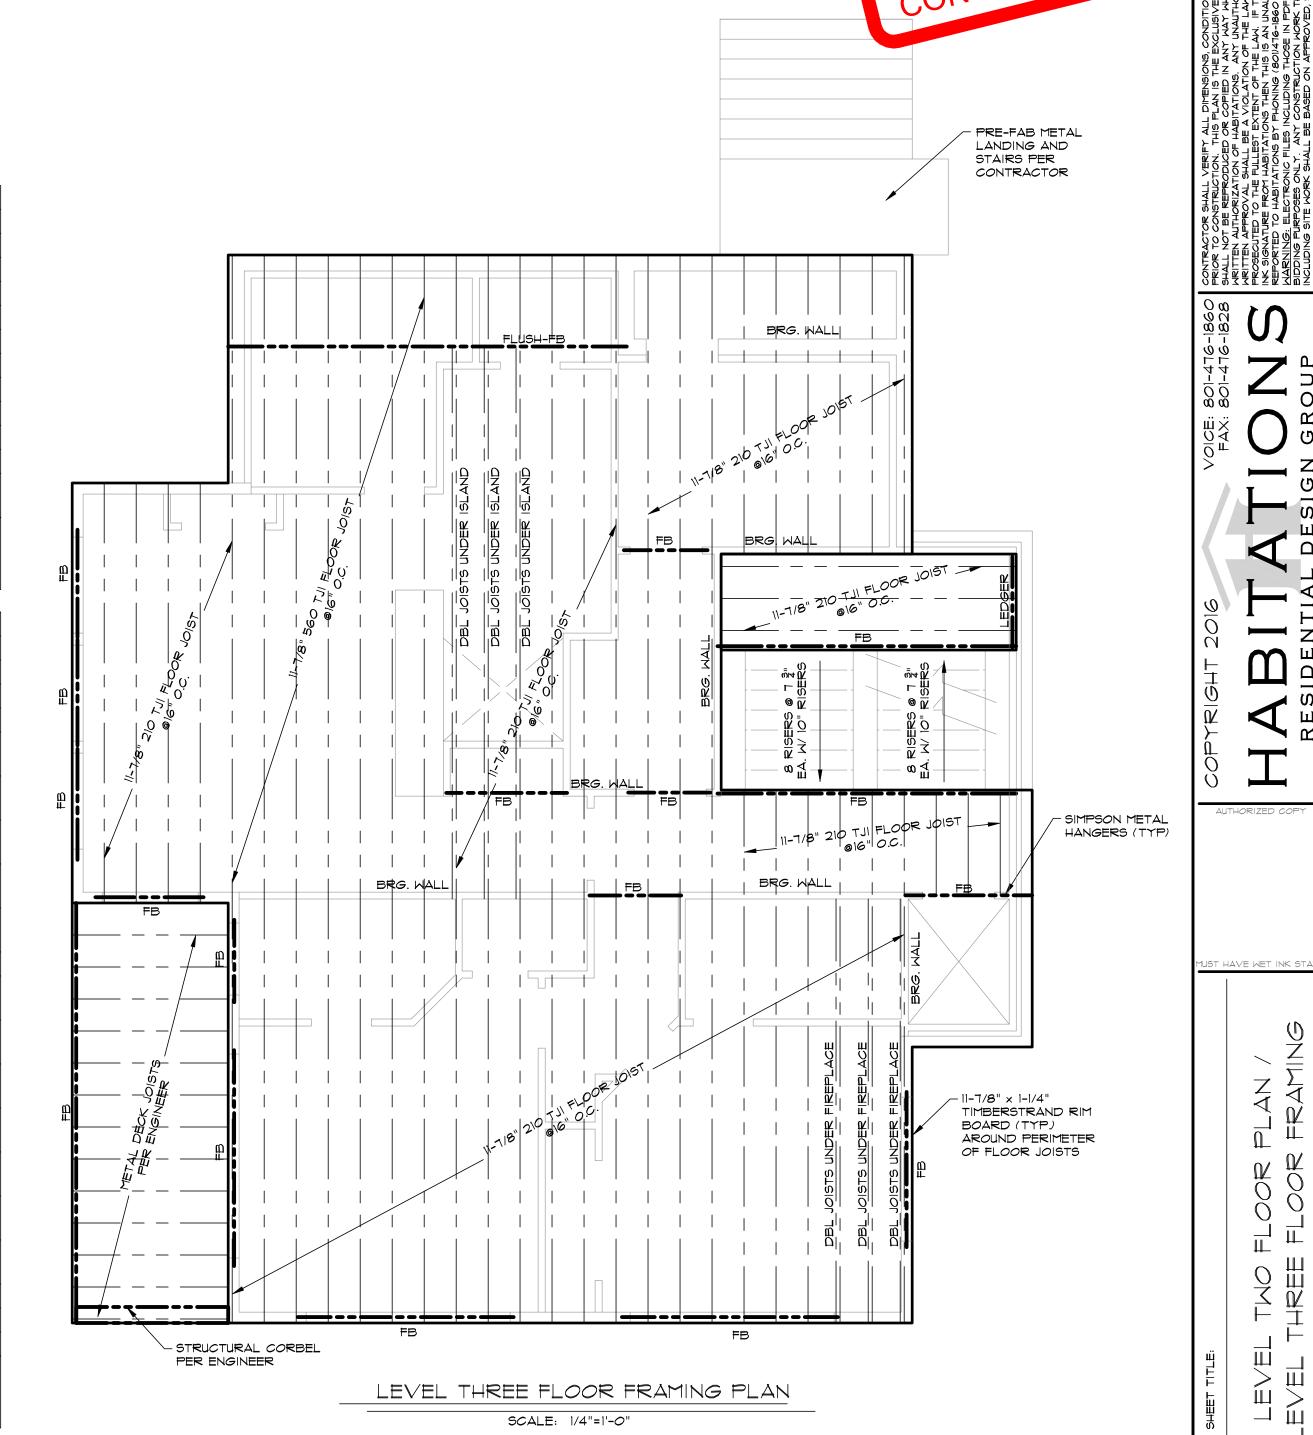


IMPORTANT NOTE:

THE FLOOR FRAMING PLAN INFORMATION PRESENTED HEREIN IS "FOR INFORMATION ONLY." THE ACTUAL FLOOR FRAMING PLAN SHALL BE THE RESPONSIBILITY OF THE STRUCTURAL ENGINEER. HABITATIONS MAKES NO GUARANTEE TO THE PLAN ACCURACY OR COMPLETENESS AND ASSUMES NO LIABILITY FOR SUCH.

DRAWN BY: M. STEELE CHK'D BY: T. RICKS ISSUE DATE: XX/XX/201

PLAN NUMBER: 454465 SHEET NUMBER: 9 of 15


SECOND LEVEL 1448 SQ. FT.

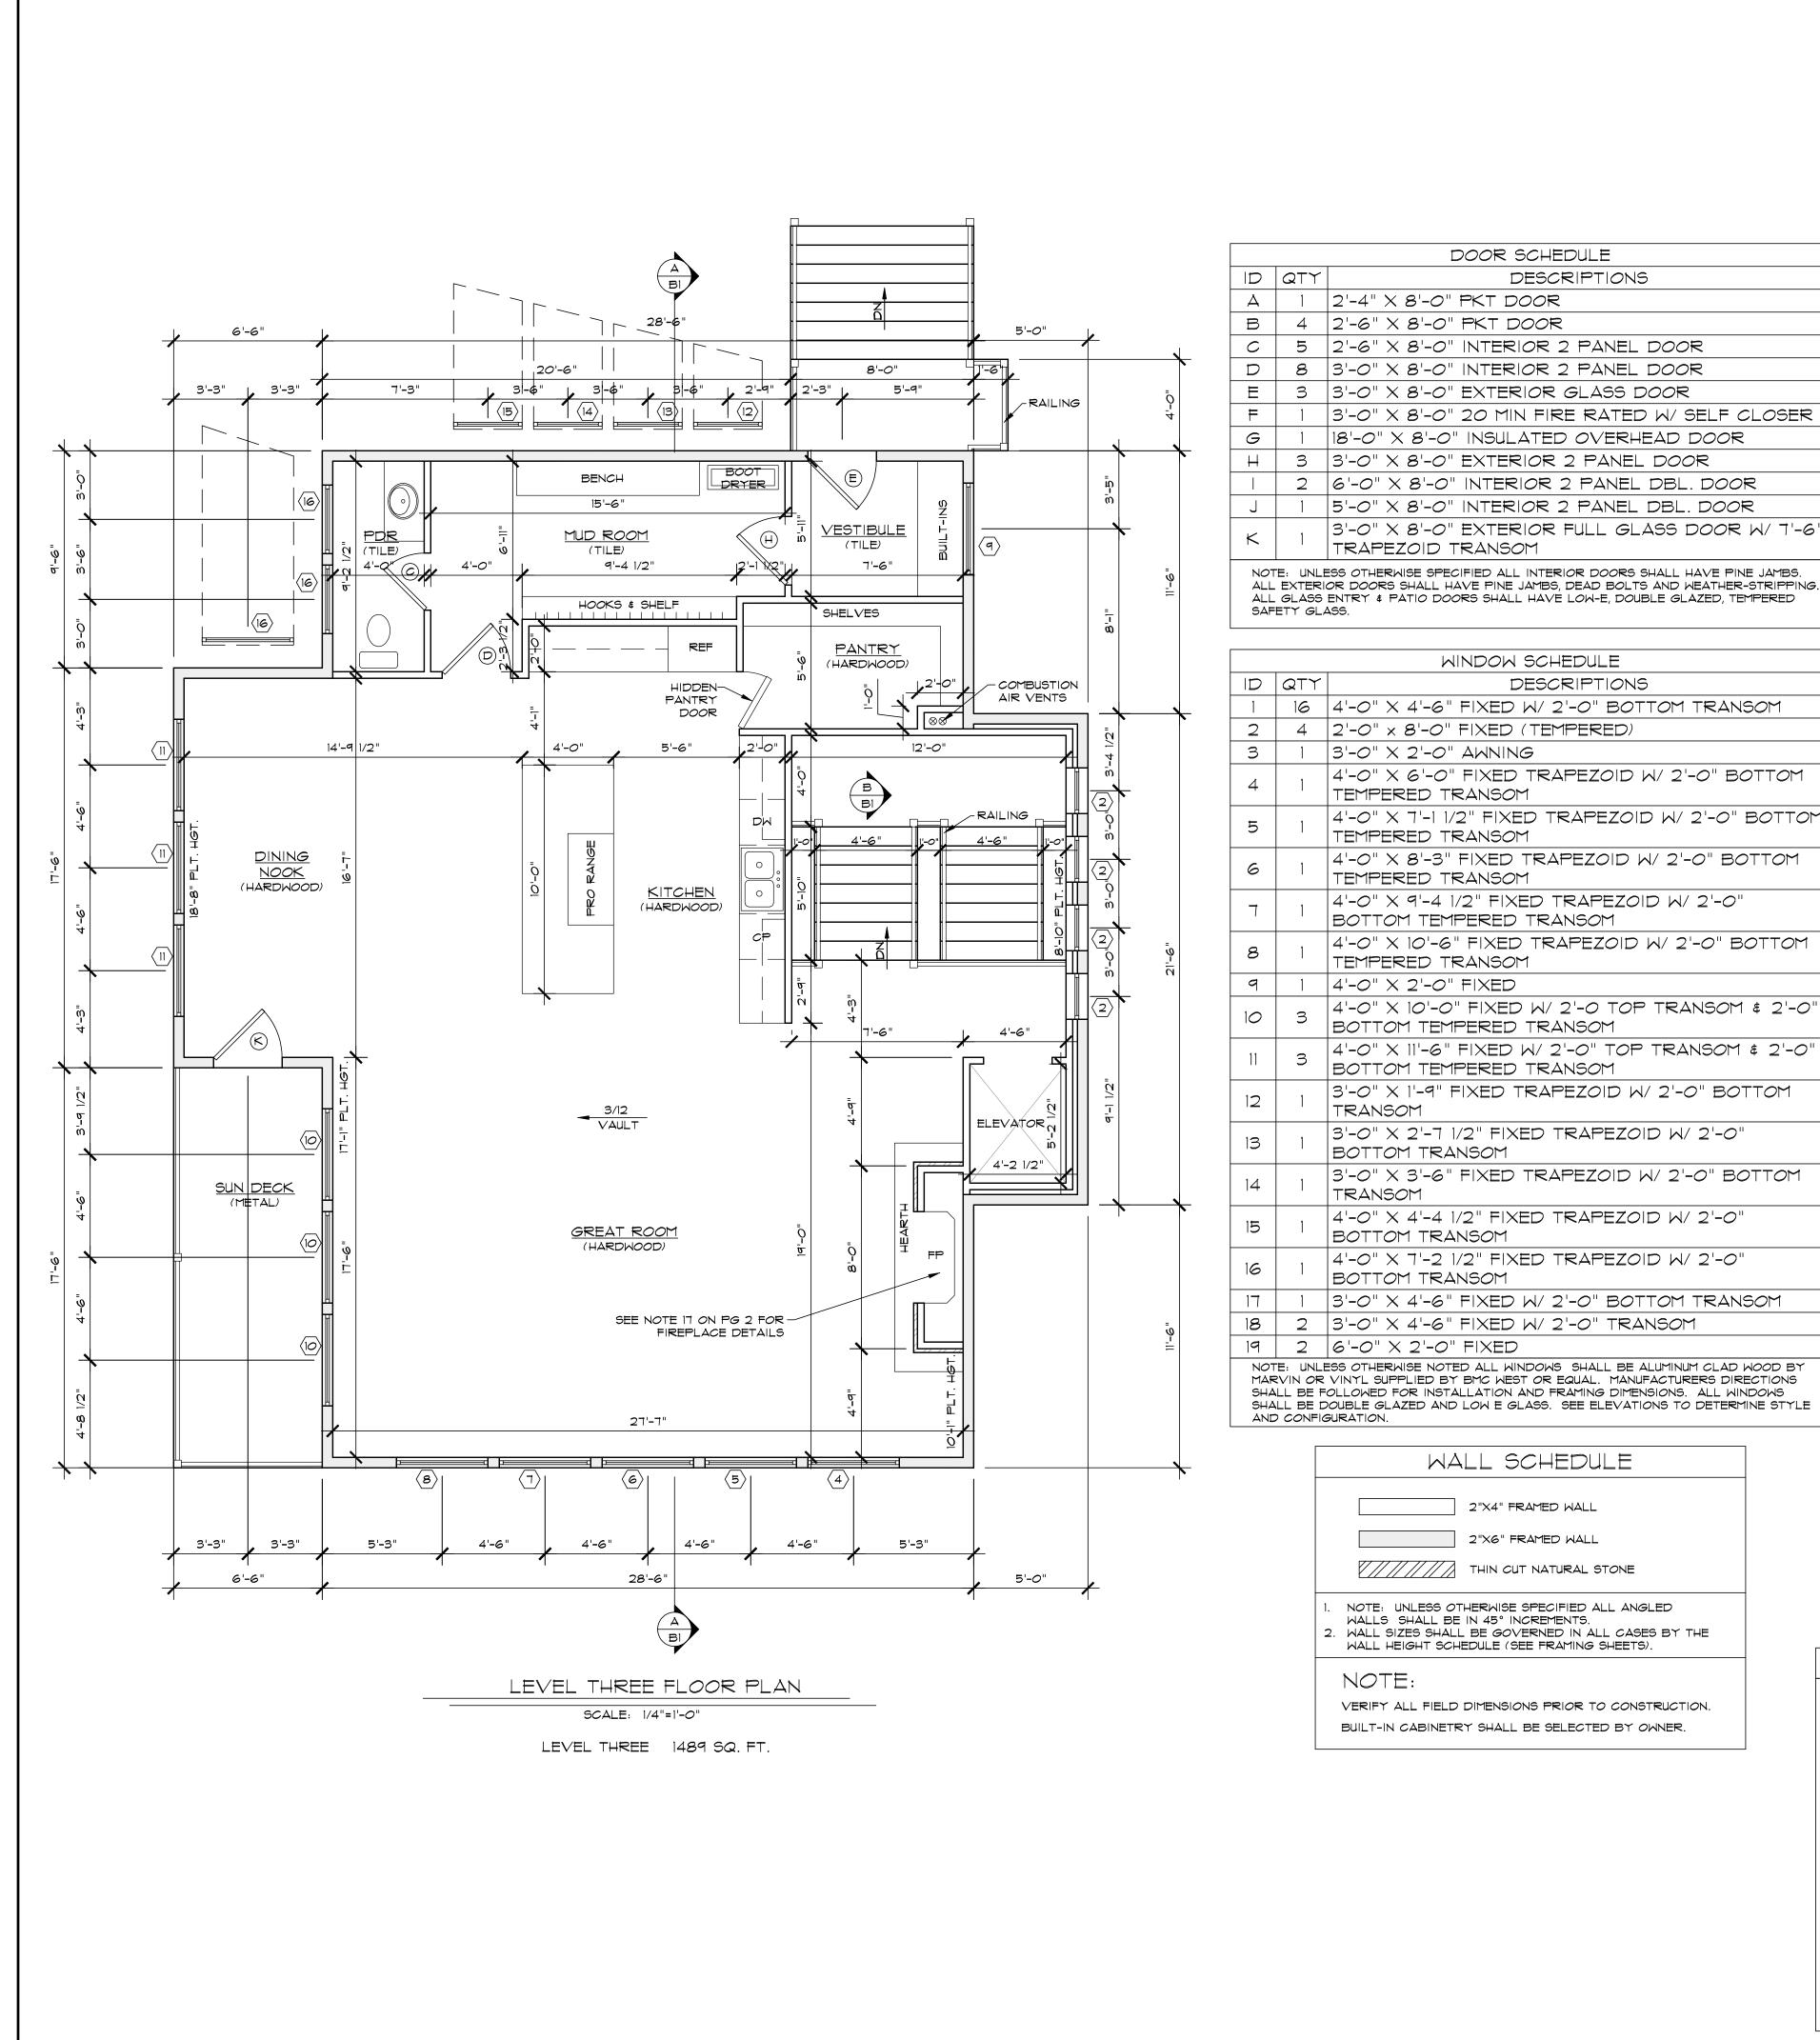

DOOR SCHEDULE DESCRIPTIONS |2'-4" X 8'-0" PKT DOOR |2'-6" X 8'-0" PKT DOOR '-6" X 8'-0" INTERIOR 2 PANEL DOOR |3'-0" X 8'-0" 20 MIN FIRE RATED W/ SELF CLOSER

		WINDOW SCHEDULE
ID	QTY	
1	16	4'-0" X 4'-6" FIXED W/ 2'-0" BOTTOM TRANSOM
2	4	2'-0" x 8'-0" FIXED (TEMPERED)
3	1	3'-0" X 2'-0" AWNING
4	1	4'-0" X 6'-0" FIXED TRAPEZOID W/ 2'-0" BOTTOM TEMPERED TRANSOM
5	1	$4'-O" \times 7'-1 1/2"$ FIXED TRAPEZOID W/ $2'-O"$ BOTTOM TEMPERED TRANSOM
6	1	4'-0" X 8'-3" FIXED TRAPEZOID W/ 2'-0" BOTTOM TEMPERED TRANSOM
٦	1	4'-0" X 9'-4 1/2" FIXED TRAPEZOID W/ 2'-0" BOTTOM TEMPERED TRANSOM
8	1	4'-0" X 10'-6" FIXED TRAPEZOID W/ 2'-0" BOTTOM TEMPERED TRANSOM
9	1	4'-0" X 2'-0" FIXED
10	3	4'-0" X 10'-0" FIXED W/ 2'-0 TOP TRANSOM \$ 2'-0" BOTTOM TEMPERED TRANSOM
11	3	4'-0" X 11'-6" FIXED W/ 2'-0" TOP TRANSOM & 2'-0" BOTTOM TEMPERED TRANSOM
12	1	3'-0" X 1'-9" FIXED TRAPEZOID W/ 2'-0" BOTTOM TRANSOM
13	1	3'-0" X 2'-7 1/2" FIXED TRAPEZOID W/ 2'-0" BOTTOM TRANSOM
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16	1	4'-0" X 7'-2 1/2" FIXED TRAPEZOID W/ 2'-0" BOTTOM TRANSOM
17	1	3'-0" X 4'-6" FIXED W/ 2'-0" BOTTOM TRANSOM
18	2	3'-0" X 4'-6" FIXED W/ 2'-0" TRANSOM
19	2	6'-0" X 2'-0" FIXED

NOTE: UNLESS OTHERWISE NOTED ALL WINDOWS SHALL BE ALUMINUM CLAD WOOD BY MARVIN OR VINYL SUPPLIED BY BMC WEST OR EQUAL. MANUFACTURERS DIRECTIONS SHALL BE FOLLOWED FOR INSTALLATION AND FRAMING DIMENSIONS. ALL WINDOWS SHALL BE DOUBLE GLAZED AND LOW E GLASS. SEE ELEVATIONS TO DETERMINE STYLE

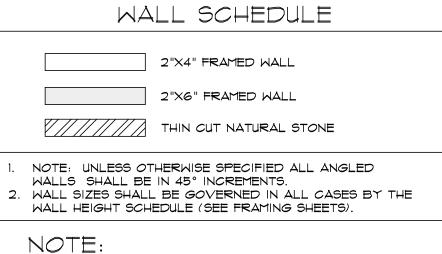

IMPORTANT NOTE:

THE ROOF FRAMING PLAN INFORMATION PRESENTED HEREIN IS "FOR INFORMATION ONLY." THE ACTUAL ROOF FRAMING PLAN DESIGN SHALL BE THE RESPONSIBILITY OF THE ROOF TRUSS MANUFACTURER AND STRUCTURAL ENGINEER. HABITATIONS MAKES NO GUARANTEE TO THE PLAN ACCURACY OR COMPLETENESS AND ASSUMES NO LIABILITY FOR SUCH. THE GENERAL CONTRACTOR/ ROOFING CONTRACTOR SHALL DETERMINE RAIN GUTTERS/ DOWN SPOUT REQUIREMENTS AND LOCATION OF SUCH AS WELL AS AREAS OF ROOF CRICKETS AND ROOF DRAINAGE/ FLASHING AND MEMBRANE LOCATIONS TO ADDRESS DRAINAGE ISSUES AT THE LOCATIONS.

FEILD VERIFY ALL DIMENSIONS PRIOR TO TRUSS MANUFACTURING.

THE TRUSS MANUFACTURER IS REQUIRED TO CONTACT THE OWNER/CONTRACTOR IF THERE ARE ANY ISSUES DISCOVERED ON THE ROOF FRAMING PLAN DURING THE TRUSS DESIGN, PRIOR TO TRUSS MANUFACTURE. NO CHANGES WILL BE ALLOWED TO BE MADE TO THE FOLLOWING; ROOM CEILING HEIGHTS, VAULTS, INTERIOR OR EXTERIOR PITCHES OR FASCIA HEIGHTS WITHOUT RECEIVING APPROVAL.

TRUSSES SHALL BE DESIGNED FROM APPROVED HARD COPY PLANS WITH THE RED AUTHORIZATION STAMP ONLY. THE OWNER/CONTRACTOR IS RESPONSIBLE TO ENSURE THAT ALL SUBCONTRACTORS AND SUPPLIERS INCLUDING THE TRUSS MANUFACTURER HAVE THE MOST CURRENT AND UP TO DATE PLANS IN STAMPED AND APPROVED HARD COPY FORMAT PRIOR TO COMMENCING WITH CONSTRUCTION. FIELD MEASUREMENTS SHALL BE MADE AND VERIFIED PRIOR TO THE FINAL TRUSS DESIGN COMPLETION AND MANUFACTURE. TRUSSES SHALL NOT BE DESIGNED OR CONSTRUCTED FROM ELECTRONIC OR PDF TYPE DOCUMENTS.

NOTE FOR ENGINEER: ROOF FRAMING MEMBERS CAN BE 18" TALL BEFORE RUNNING INTO ISSUES WITH THE HEIGHT RESTRICTION. CONTRACTOR 95
PRIOR TO CONS
SHALL NOT BE R
WRITTEN AUTHOR
WRITTEN APPROCECUTED TO
INK SIGNATURE IN
KEPORTED TO H
MARNING: ELE
BIDDING PURPO
NCLUDING SITE
NCONTRACTOR
NCLUDING SITE

ROOF FRAMING PLAN


SCALE: 1/4"=1'-0"


 $ec{\square}$


DRAWN BY: M. STEELE CHK'D BY: T. RICKS ISSUE DATE: XX/XX/201 PLAN NUMBER: 45446

THIRD LEVEL 1489 SQ. FT.

SHEET NUMBER: 11 of 15

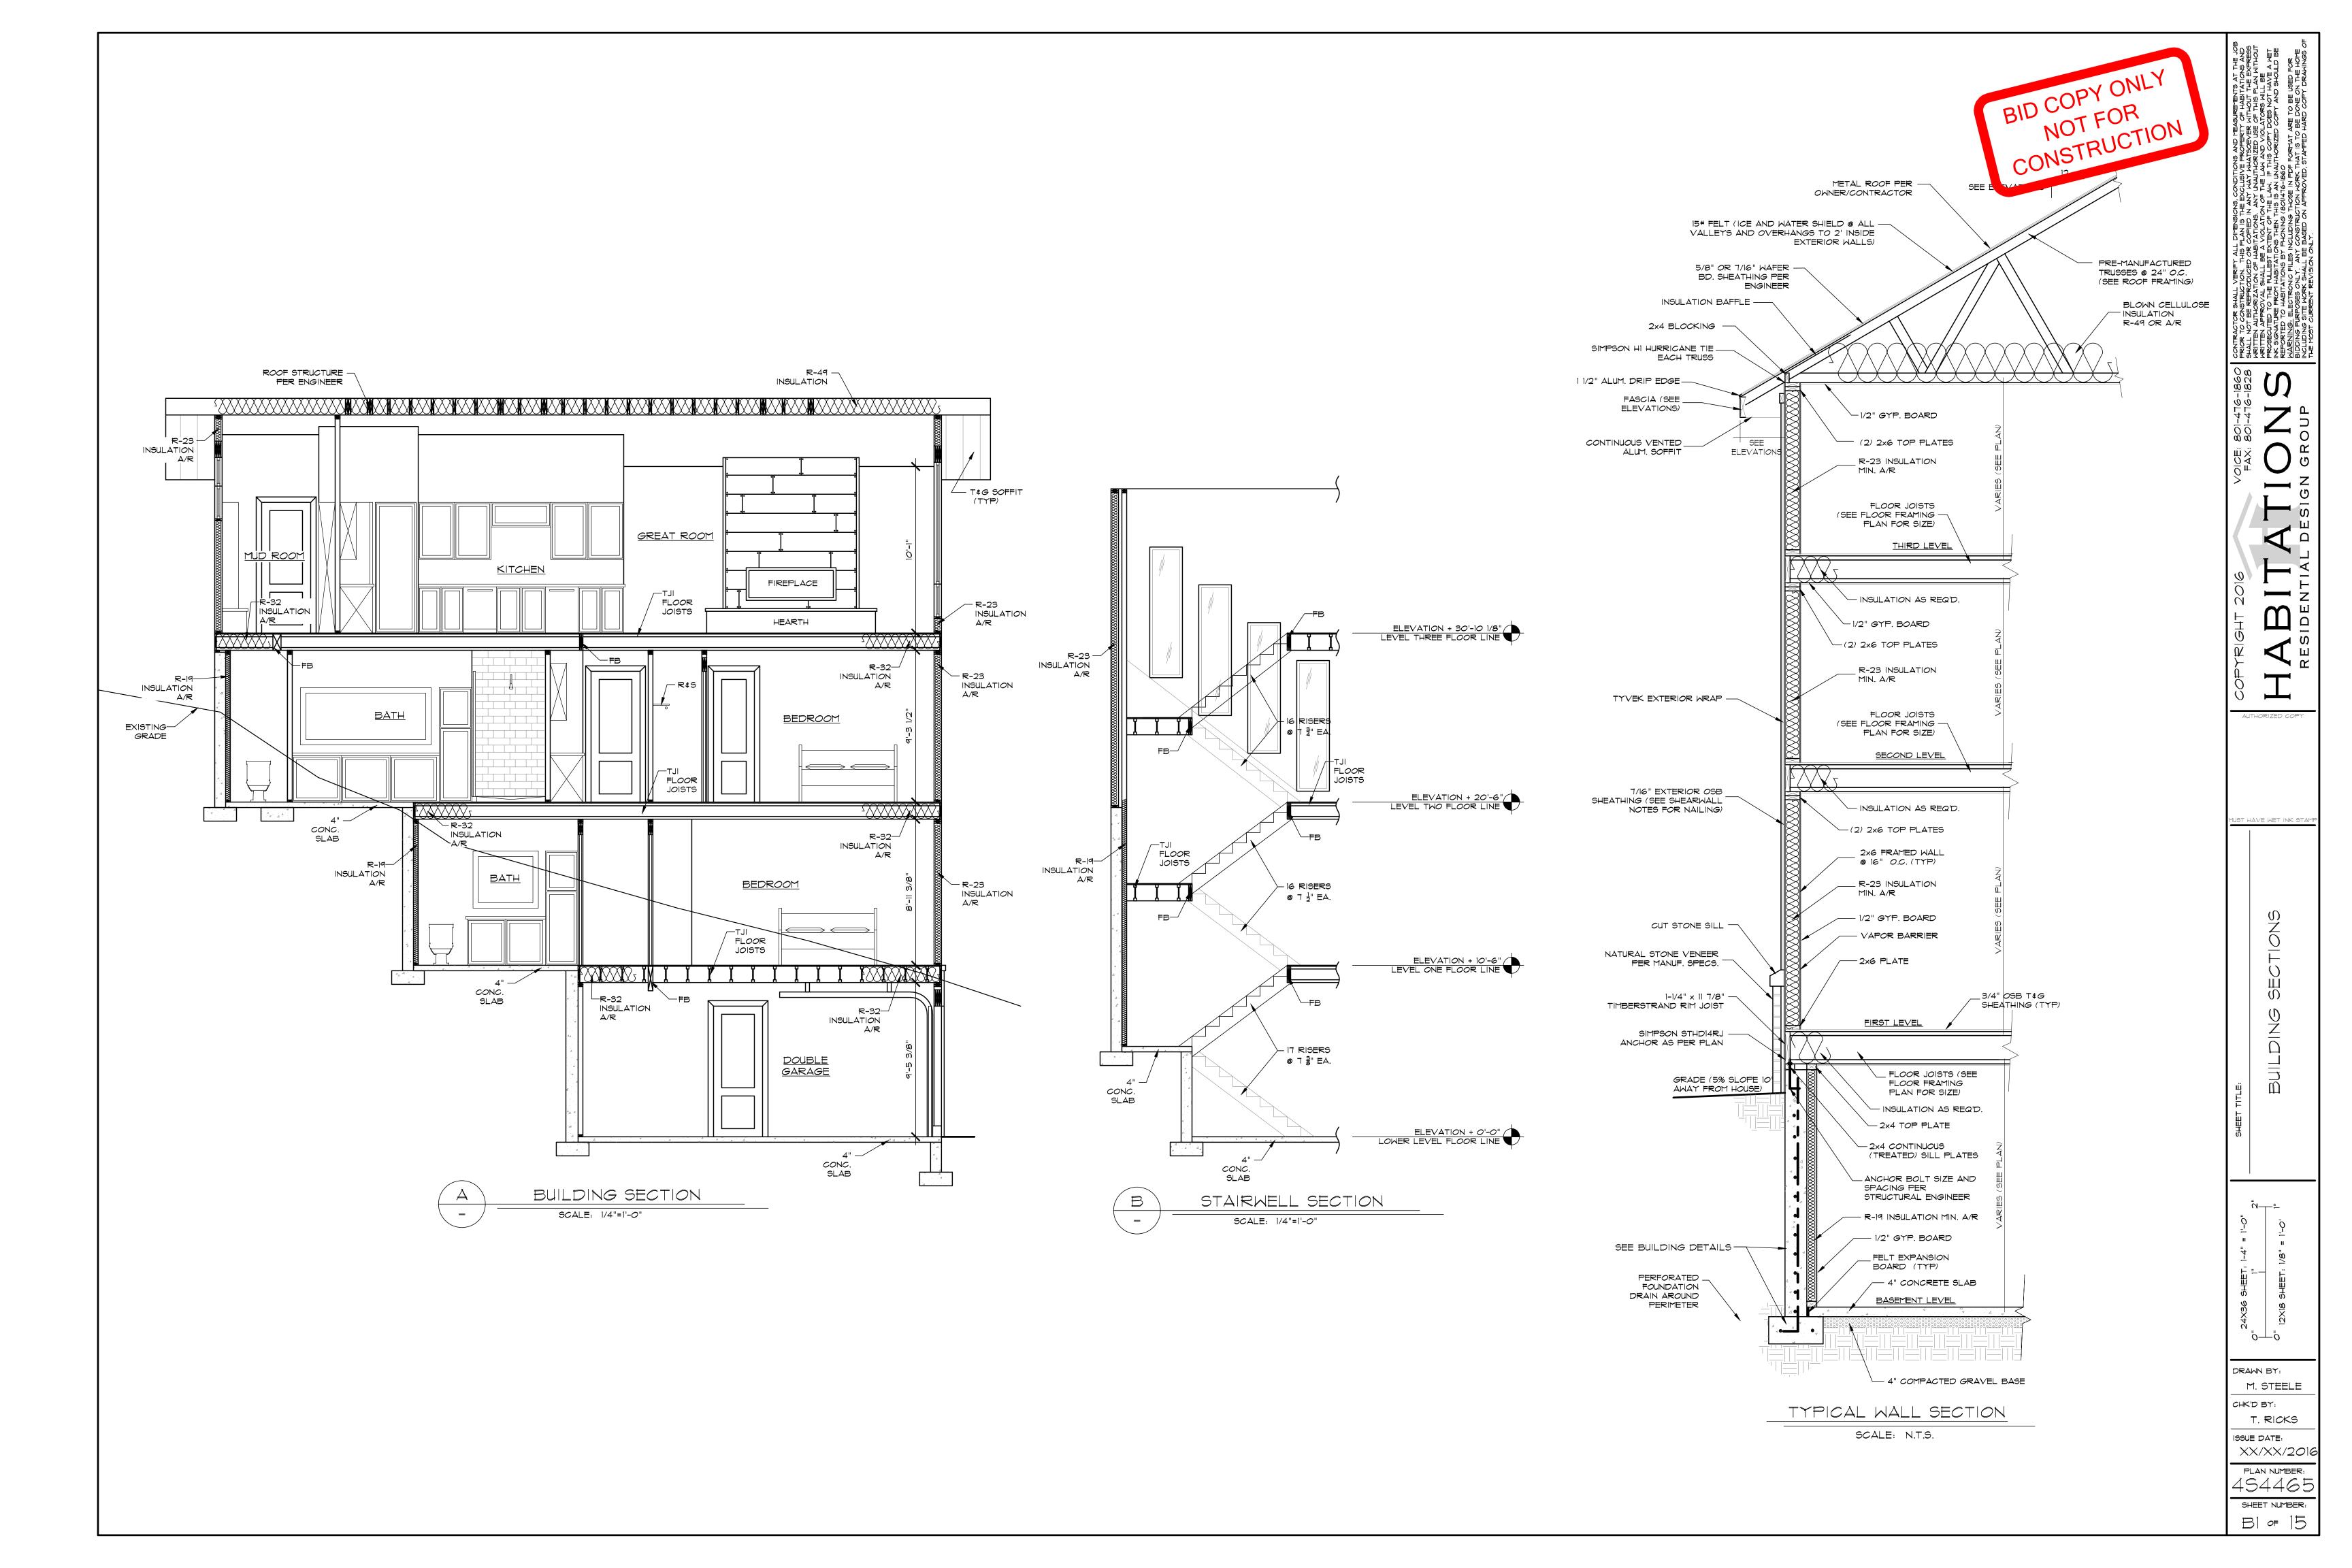

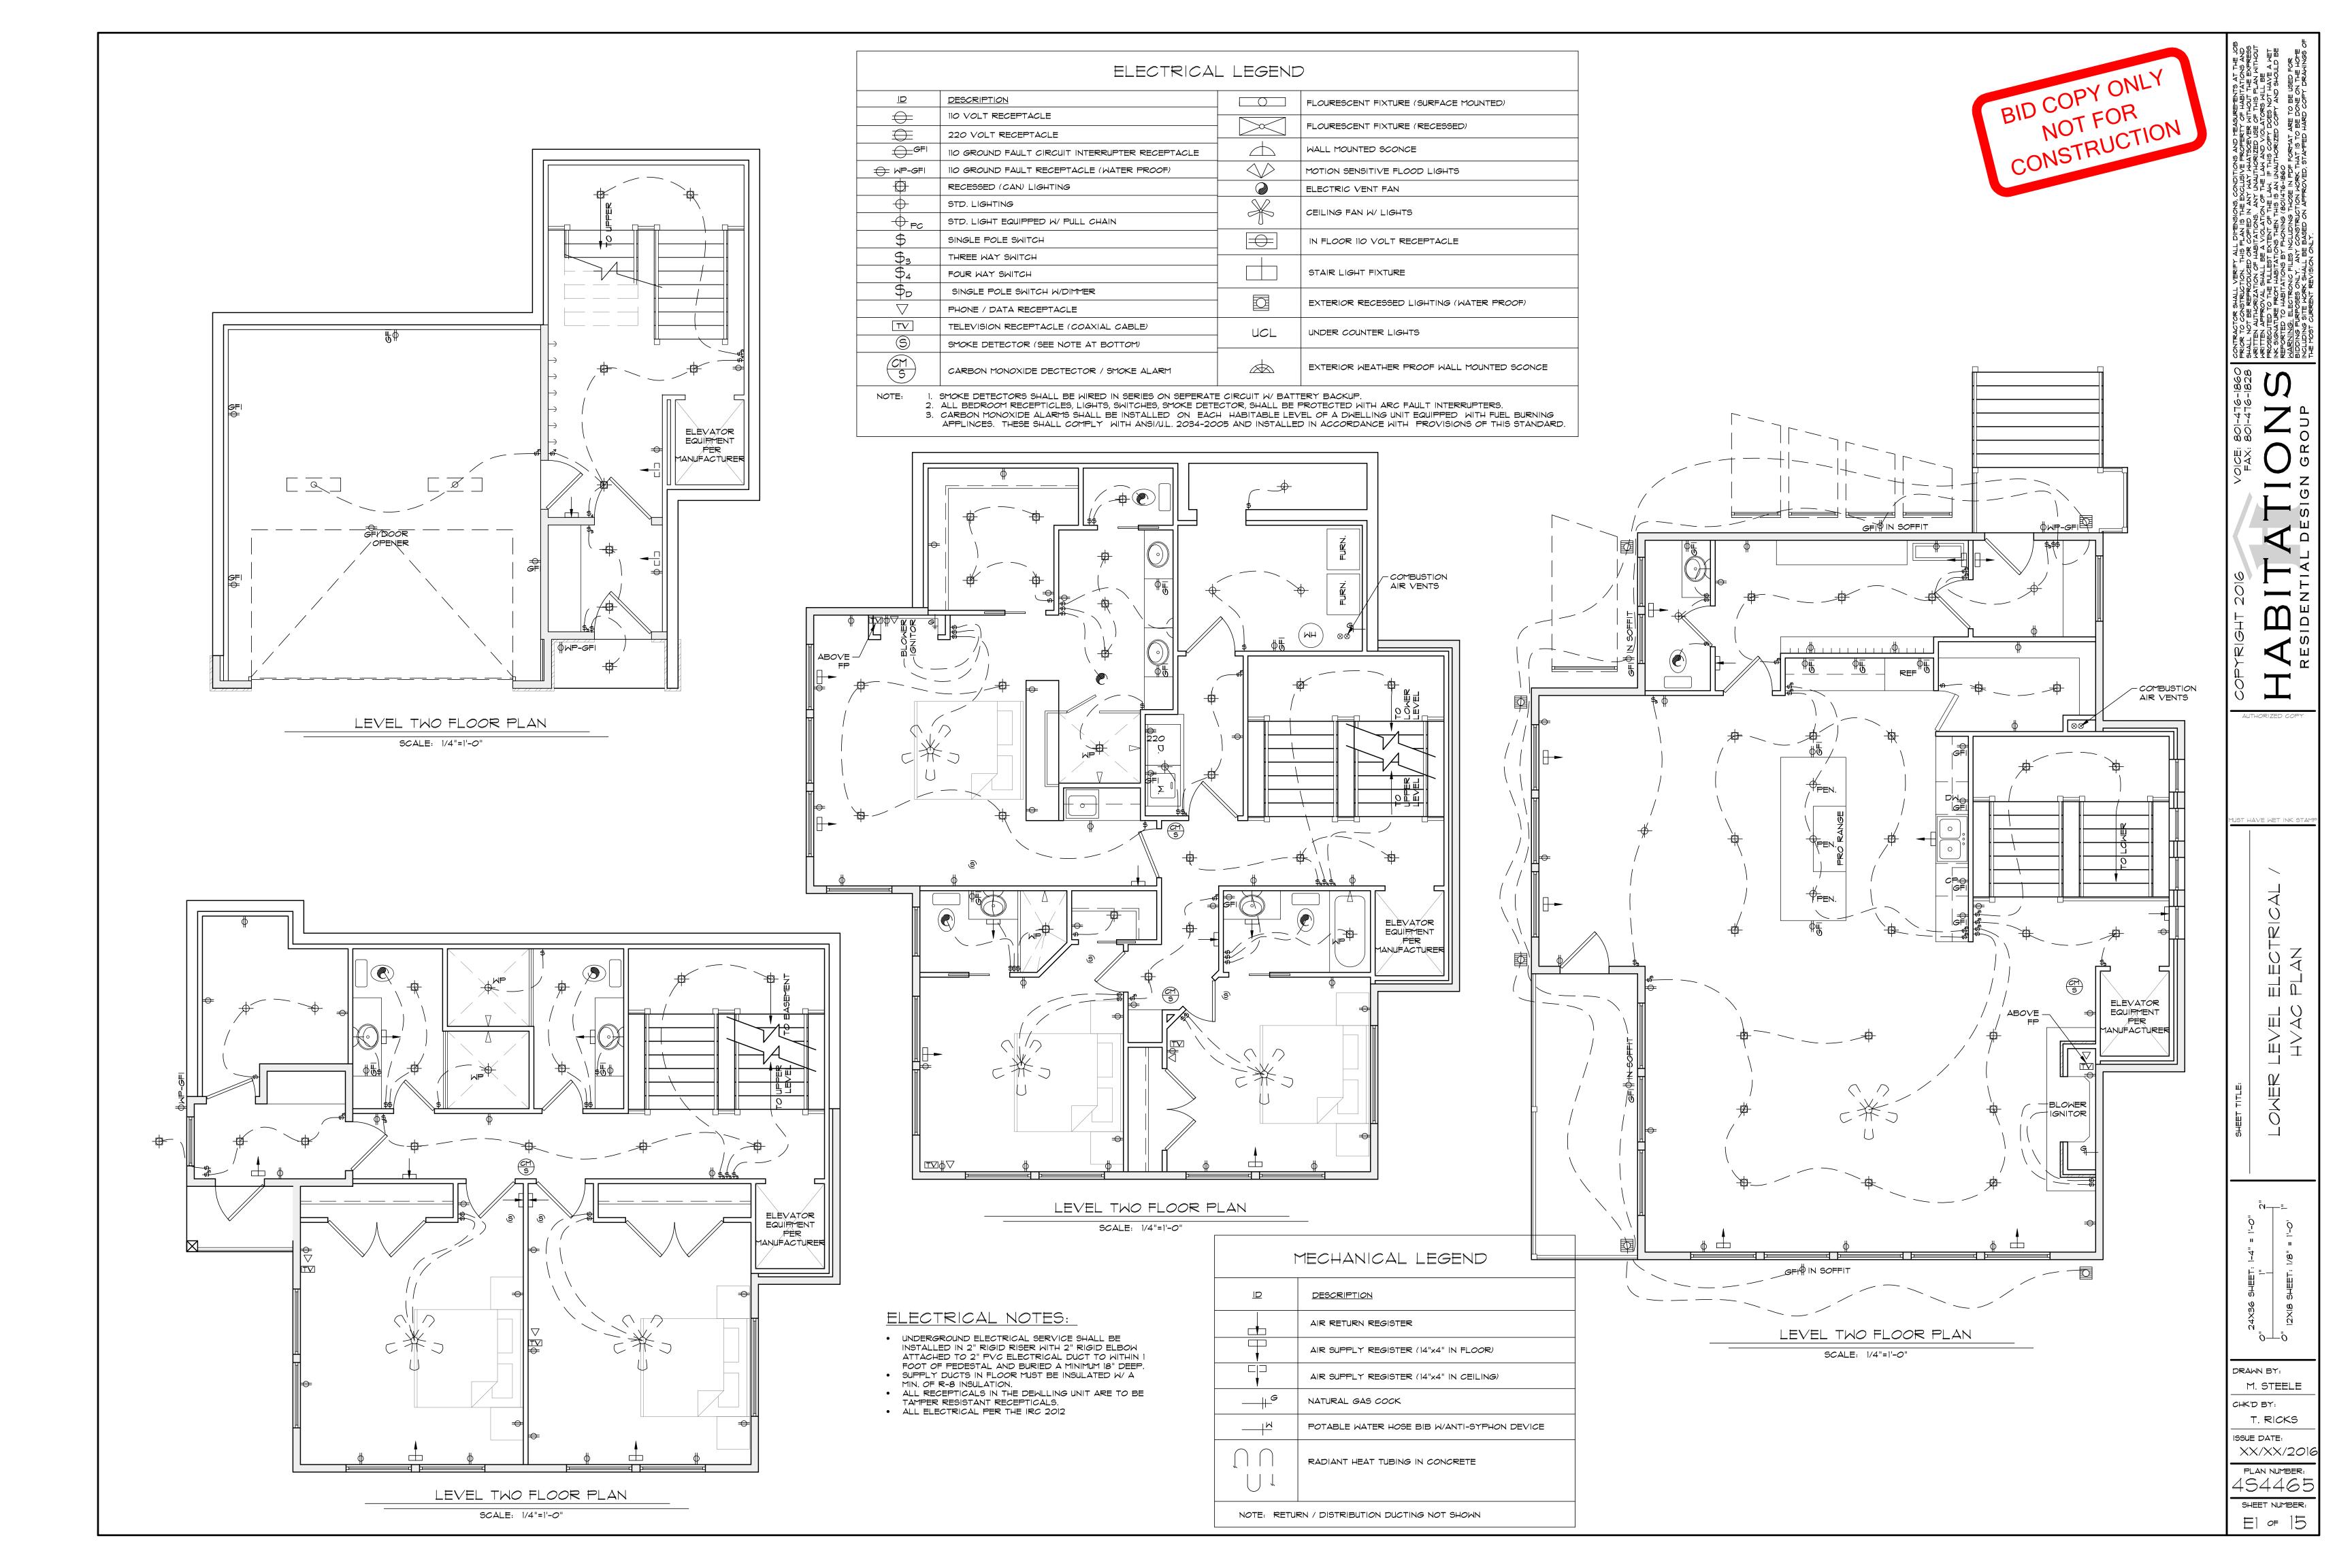

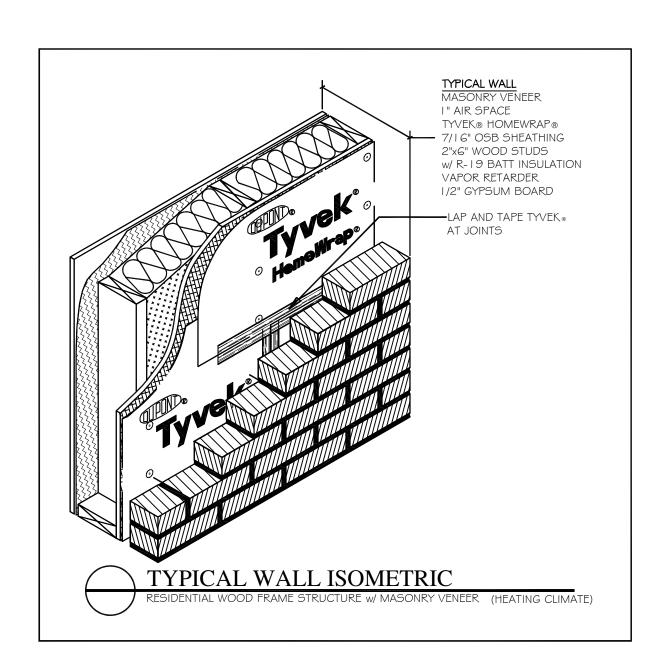

- STEEL SAFETY GRATE

WINDOW WELL DETAIL

WINDOW AS PER .

FLOOR PLAN

FINISHED GRADE LINE APPROX.

3" BELOW WELL, SLOPE GRADE

PRE -MANUFACTURED WINDOW

WELLS W/ A DEPTH MORE THAN 44"

MUST HAVE A PERMANENTLY AFFIXED

OPEN AS PER IRC 310.2 \$ 310.2.1


WELL OR LANDSCAPE ROCKS


LADDER OR STEPS THAT ARE


- 6" GRAVEL FILL


- CONCRETE FDN. AS PER FTG. & FDN. PLAN


AWAY FROM WELL

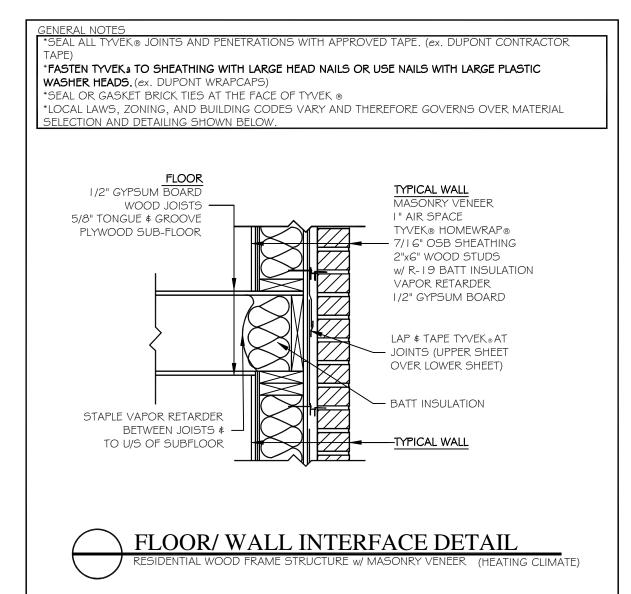


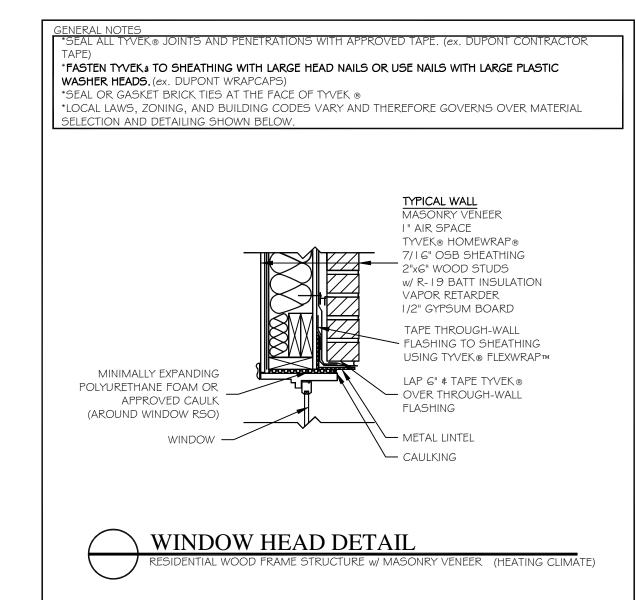


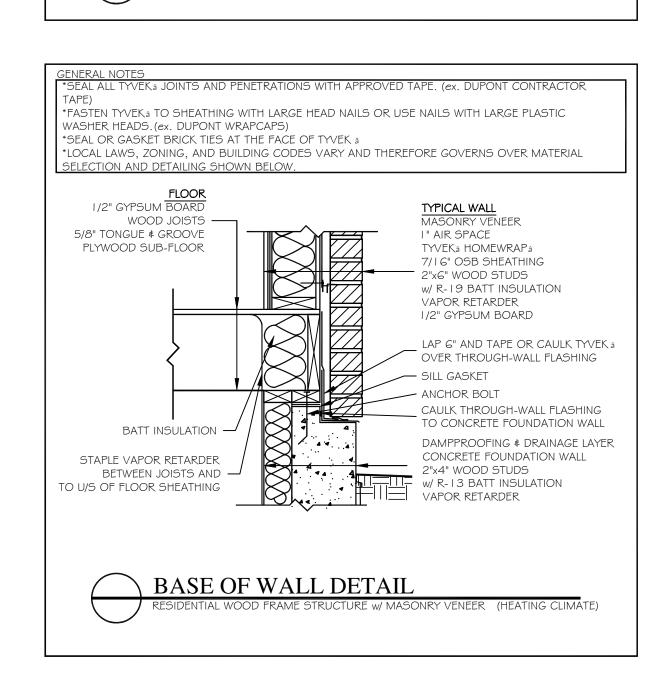


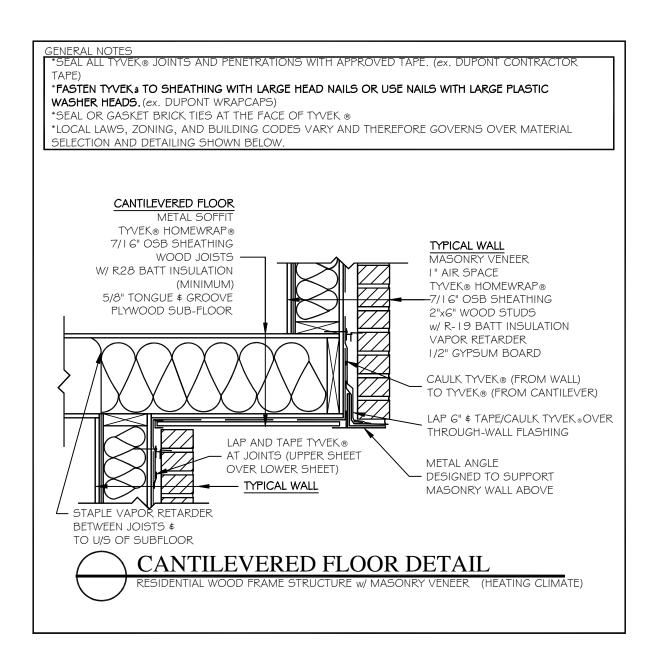

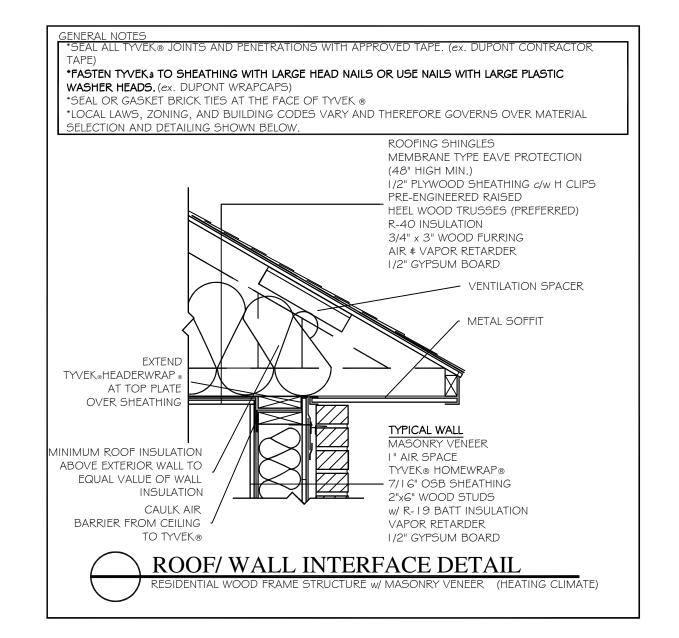

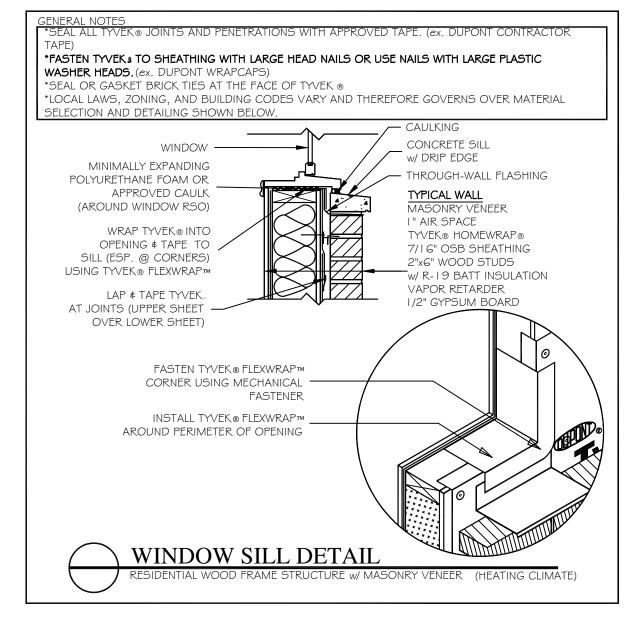

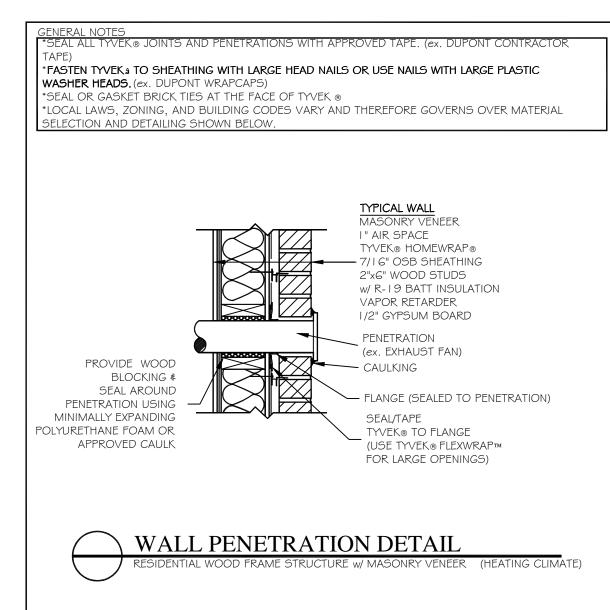

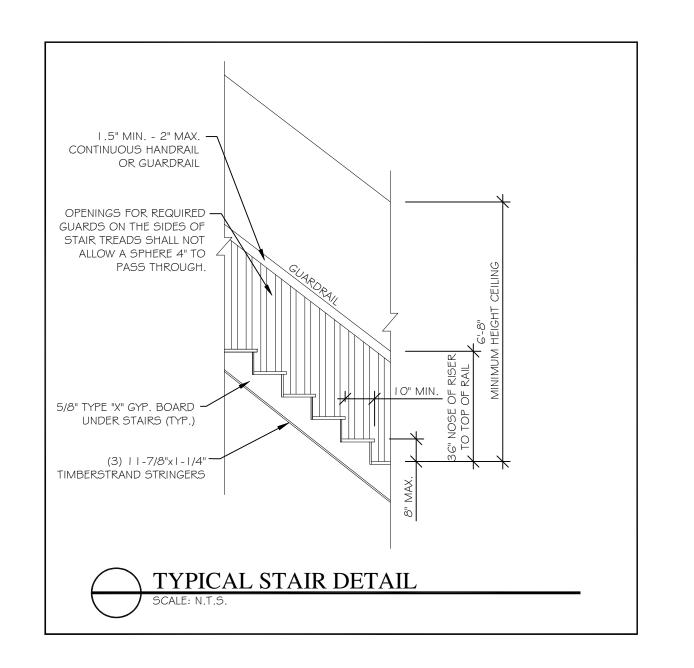

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T 2016

VOICE: 801-476-18

FAX: 801-476-18

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AUTHORIZED COPY

MUST HAVE WET INK STAMP

P DETAILS

DRAWN BY:

M. STEELE

CHK'D BY:

T. RICKS

159UE DATE:

XX/XX/2016

PLAN NUMBER:

454465

SHEET NUMBER:

AD1 of 15