ROSENTHAL CABIN

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Lloyd∧rchitect

EXTERIOR PERSPECTIVES



NORTH



NORTHWEST

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ROSENTHAL CABIN 7958 E. HEARTWOOD DRIVE EDEN, UTAH 84310

SEAL

PRINT DATE **8/10/16**

PROJECT PHASE
- ARC SUBMITTAL 07/22/2011
- HDR SET 08/10/2010

DRAWING REVISIONS

PROJECT TEAM

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SCOPE

NEW CONSTRUCTION OF FAMILY CABIN IN LOT 34R OF SUMMIT POWDER MOUNTAIN DEVELOPMENT

VICINITY MAP

CODE ANALYSIS

PARCEL ID:

CACHE COUNTY #16-112-0034, LOT 34R

ZONE:

RR, w/ SUMMIT POWDER MOUNTAIN DEVELOPMENT PRUD OVERLAY, PERMIT REVIEW PERFORMED BY

FREE COLINITY

BUILDING USE:

SINGLE FAMILY DWELLING

OCCUPANCY TYPE:

CONSTRUCTION TYPE:

STORIES ABOVE GRADE:

1 STORY FRONT YARD (STREET FACING), 2 STORY REAR YARD

LOT AREA:

34,050

R-3

ALLOWABLE HEIGHT/AREA:

35 FT / 4500 BUILDING SF / 6309 FOOTPRINT SF

ACTUAL HEIGHT/AREA:

APPLICABLE CODES:

ACTUAL HEIGHT: TOTAL FOOTPRINT AREA: TOTAL CONDITIONED AREA:

LOWER FLOOR CONDITIONED: 1895 SF
MAIN FLOOR CONDITIONED: 2121 SF

2012 INTERNATIONAL RESIDENTIAL CODE (IRC)

33.75 FT

4669 SF

4016 SF

2011 NATIONAL ELECTRICAL CODE (NEC)
2012 INTERNATIONAL PLUMBING CODE (IPC)

2012 INTERNATIONAL MECHANICAL CODE (IMC)
2006 INTERNATIONAL ENERGY CONSERVATION CODE (IECC)
2009 INTERNATIONAL EXISTING BUILDING CODE (IEBC)

2009 ACCESSIBILITY CODE ANSI A117.1

SHEET TITLE

COVER SHEET

SHEET NUMBER

G100


DRAWING ABBREVIATIONS

A.B.	ANCHOR BOLT	ELEV.	ELEVATOR	L.A.	LANDSCAPE AREA	SGL.	SINGLE SHEATHING
ABV.	ABOVE	E.O.C.	EMERGENCY OPERATIONS CENTER	LAM.	LAMINATED	SHTG. SHLV.	SHELVING
A.C.	ASPHALTIC CONCRETE	EQ.	EQUAL	LAV.	LAVATORY	SHLV. SHT.	SHEET
ACOUS.	ACOUSTICAL	EQUIP.	EQUIPMENT	LBS. LIB.	POUNDS LIBRARY	SIM.	SIMILAR
A.C.T. ADJ.	ACOUSTICAL CEILING TILE	ETC. E.W.C.	ETCETERA ELECTRIC WATER COOLER	L.P.	LOW POINT	SL.	SLOPE
ALF.	ADJUSTABLE, ADJACENT ACCESS FLOORING	EXH.	EXHAUST	LTG.	LIGHTING	S.M.	SHEET METAL
A.F.F.	ABOVE FINISH FLOOR	EXP'D.	EXPOSED			S.M.D.	SEE MECHANICAL DRAWINGS
ALUM.	ALUMINUM	EXT.	EXTERIOR	M.B.	MACHINE BOLT	S.P.D.	SEE PLUMBING DRAWINGS
ANOD.	ANODIZED			MAT'L. MAX.	MATERIAL MAXIMUM	SPEC.	SPECIFICATIONS
A.P.	ACCESS PANEL	F.D. F.E.	FLOOR DRAIN FIRE EXTINGUISHER	MDL.	MODEL	SQ.	SQUARE
ARCH.	ARCHITECTURAL	F.E.C.	FIRE EXTINGUISHER CABINET	MECH.	MECHANICAL	S.R.F.	SHEET RUBBER FLOORING
ASPH.	ASPHALT	F.F.	FINISH FLOOR	MED.	MEDIUM	S.S. S.S.D.	STAINLESS STEEL SEE STRUCTURAL DRAWINGS
A.W.P.	ACOUSTICAL WALL PANEL	F.G.	FINISH GRADE	MFR.	MANUFACTURER	ST.	STONE
BD.	BOARD	F.H.C.	FIRE HOSE CABINET	MFRD.	MANUFACTURED	STD.	STANDARD
BLDG.	BUILDING	FIN.	FINISH	MIN.	MINIMUM	STL.	STEEL
BLK.	BLOCK OR BLOCKING	FIXT.	FIXTURE	MOUNT.	MOUNTED	STN.	STAIN
BM.	BEAM	FL. F.O.	FLOOR FACE OF	M.R.G.B. M.S.	MOISTURE RESISTANT GYP BD MAGNETIC SWITCH	STOR.	STORAGE
BRKT.	BRACKET	F.O.C.	FACE OF CONCRETE	MTL.	METAL	STRUCT.	
B.U.R.	BUILT UP ROOF	F.O.S.	FACE OF STUD		NORTH	SUSP.	SUSPENDED
BOT.	BOTTOM	1.0.0.	TAGE OF GIGE	N. N/A	NOT APPLICABLE	SW.	SWITCH
C.	CARPET	FRAM'G.	FRAMING	N.I.C	NOT APPLICABLE	T.	TREAD
CAB.	CABINET	F.S.	FINISH SURFACE	N-R	NON-RATED	T&B	TOP & BOTTOM
C.B.	CATCH BASIN	FT.	FOOT OR FEET			T.C.	TOP OF CURB
CEM.	CEMENT	FTG.	FOOTING	O/	OVER	TEL. TEMP.	TELEPHONE TEMPERED
C.I.	CAST IRON	FURR.	FURRING	O.C	ON CENTER	T & G	TONGUE & GROOVE
C.I.P.	CAST IN PLACE	G.	GAS LINE	OCCUP.	OCCUPANCY	T.G.	TREE GRATE
C.J.	CONTROL JOINT	GA.	GAUGE	O.D.	OUTSIDE DIAMETER	THK.	THICK
C.L. CLG.	CHAIN LINK CEILING	GALV.	GALVANIZED	OPP. O.T.S.	OPPOSITE OPEN TO STRUCTURE	TJI	TRUSS JOIST
CLG.	CLEAR	G.C.	GENERAL CONTRACTOR GALVANIZED IRON	0.1.5.	OPEN TO STRUCTURE	T.O.	TOP OF
CLOS.	CLOSET	G.I. GL.	GLASS	PL.	PLATE	T.O.C.	TOP OF CONCRETE
C.M.U.	CONCRETE MASONRY UNIT	GLZ.	GLAZING	PL. CEM.		T.O.P. T.O.PL.	TOP OF PARAPET
COL.	COLUMN	GYP.	GYPSUM WALLBOARD	P.LAM. PLAS.	PLASTIC LAMINATE PLASTIC	T.P.	TOP OF PLATE TOILET PARTITION
COMM.	COMMUNICATION	GWB	GYPSUM WALLBOARD	PLAS. PLY.	PLYWOOD	T.W.	TOP OF WALL
	. COMPUTER			P.P.	POWER POLE	TYP.	TYPICAL
CONC. CONST.	CONCRETE CONSTRUCTION	Н.	HIGH	PR.	PAIR	TS	TUBE STEEL
CONST.	CONTINUOUS, CONTROL	H.C.	HOLLOW CORE OR	PRE.	FACTORY PREFINISHED	U.B.C.	UNIFORM BUILDING CODE
CORR.	CORRIDOR	H.D.	HANDICAPPED SURFACE HARDENER	PROJ.	PROJECTION	U.N.O.	UNLESS NOTED OTHERWISE
C.P.	CONTROL POINT	H.D.G.	HOT DIPPED GALVANIZED	PT. PTD.	PAINT PAINTED	U.O.C.	UNLESS OTHERWISE CALLED
C.T.	CERAMIC TILE	HDR.	HEADER	PVMT.	PAVEMENT	U.O.N.	UNLESS OTHERWISE NOTED
C.T.B.	CERAMIC TILE BASE	HDWD.	HARDWOOD	R.	RADIUS		VIII OCUPACITION THE
DEPT.	DEPARTMENT	HDWR.	HARDWARE	R.A.	RETURN AIR	V.C.T.	VINYL COMPOSITION TILE
DET.	DETAIL	H.M.	HOLLOW METAL			VCP. VERT.	VITRIFIED CLAY PIPE VERTICAL
D.F.	DRINKING FOUNTAIN	HORIZ.	HORIZONTAL	R.B.	RUBBER BASE	VEST.	VESTIBULE
DIA.	DIAMETER	H.P. HR.	HIGH POINT HOUR	R.C.P.	REFLECTED CEILING PLAN	V.P.	VENEER PLASTIC
DIAG.	DIAGONAL	HT.	HEIGHT	RE:	REFER TO		
DIM.	DIMENSION	HTR.	HEATER	REF. REINF.	REFRIGERATOR REINFORCING	W.	WEST
DIV.	DIVISION(S)	HYDR.	HYDRAULIC	REQ'D.	REQUIRED	WAINS.	WAINSCOT
DN. DR.	DOWN DOOR			REV.	REVISION	W.C. WD.	WATER CLOSET WOOD
DS.	DOWNSPOUT	IN.	INCHES	RI.	RISER	W/H	WATER HEATER
DWGS.	DRAWINGS	INSUL.	INSULATION	RM.	ROOM	WDW.	WINDOW
		INT.	INTERIOR	R.R.	RUBBER FLOORING W/	W.M.	WIRE MESH
EA. E.	EACH EAST	JAN.	JANITOR		PROFILE RINGS	WP.	WEATHERPROOF
(E)	EXISTING	JST.	JOIST	R.T.	RUBBER TREAD/RISER	W/	WITH
EXIST.	EXISTING			S.	SOUTH	W.R.	WATER RESISTANT
EXT'G.	EXISTING	KITCH.	KITCHEN	S.A.	SUPPLY AIR	W.R.G.B.	
E.J.	EXPANSION JOINT			S.AQ.D.	SEE AQUATICS DRAWINGS	10/10/10	GYPSUM BOARD
EL.	ELEVATION			S.C.	SOLID CORE	W.W.M.	WELDED WIRE MESH
ELEC.	ELECTRICAL			SCHED.	SCHEDULE	Ø	DIAMETER
				SEAL.	CONCRETE OR STONE SEALER	#	POUND OR NUMBER
				SECT.	SECTION	Q.	CENTERLINE
				S.E.D.	SEE ELECTRICAL DRAWINGS	&	AND
				SERV. S.F.	SERVER SQUARE FEET	@	AT
				3.1.	OQUITE I LLI		


GRAPHIC NOTES

NOTE: DIMENSIONS IN THESE DRAWINGS ARE GENERALLY PLACED AS INDICATED BELOW, UNLESS NOTED OTHERWISE.

- MASONRY: TO UNFINISHED FACE (NOTE @ SPLIT FACE CONDITION THESE DRAWINGS ASSUME STANDARD 8" OR 12" WIDE BLOCK)
- 2. CONCRETE: TO UNFINISHED FACE
- 3. STRUCTURAL: TO STEEL OR TUBING FACE OR CENTER LINE
- 4. COLUMNS: CENTER LINE
- 5. NONBEARING PARTITIONS: TO FACE OF STUD. SEE NOTE 9 BELOW
- 6. THE CONTRACTOR SHALL BE RESPONSIBLE FOR COORDINATING ALL ARCHITECTURAL DIMENSIONS TO ASSURE PROPER PLACEMENT OF ALL PARTS AND MATERIALS IN CONJUNCTION WITH ALL OTHER DISCIPLINES REPRESENTED IN THESE DOCUMENTS, PRIOR TO COMMENCING WORK.
- 7. VERIFY ALL DIMENSIONS INCLUDING SITE CONDITIONS BEFORE STARTING WORK.
- 8. WRITTEN DIMENSIONS SHALL TAKE PRECEDENCE OVER SCALE.
- 9. DIMENSION GRAPHICS:

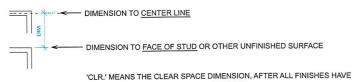


BEEN APPLIED TO THE SUBJECT SURFACES

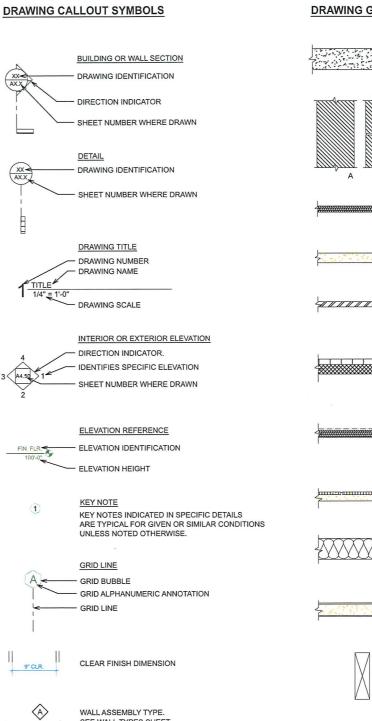

SEE WALL TYPES SHEET.




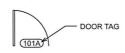

- WINDOW TAG

B.O. CEILING CEILING HEIGHT

DRAWING GRAPHIC SYMBOLS

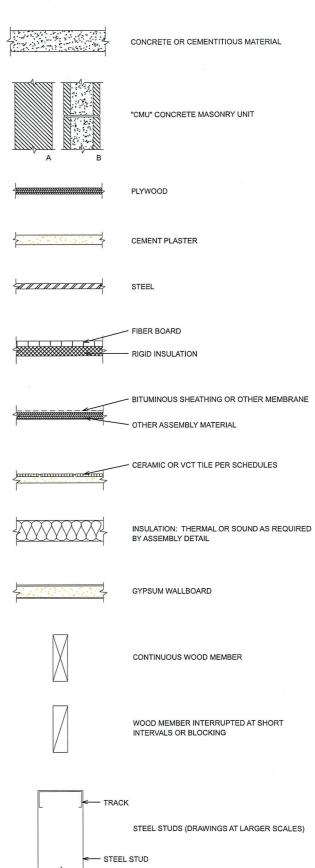

Lloyd<u>Architects</u>

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- ARC SUBMITTAL 07/22/2010 - HDR SET 08/10/2016

DRAWING REVISIONS

SHEET TITLE

SYMBOLS & **ABBREVIAT** IONS

SHEET NUMBER

G101

GENERAL CONSTRUCTION

- 1. These plan shall be designed and reviewed under 2012 IBC.
- 2. The contractor shall be responsible for obtaining all permits required for construction by the permitting authorities having jurisdiction
- 3. The contractor shall carefully read, study, and understand all plans and specifications for trades. Coordination between trades will be necessary and the responsibility of the contractor, any questions that arise shall be clarified by the architect prior to construction.
- 4. Drawings are not to be scaled. Dimensional discrepancies are to be clarified with the architect before proceeding with construction.
- 5. The contractor shall verify existing power, water, data cable and other utilities prior to excavation. Contact blue-stakes or authorities having jurisdiction
- 6. The contractor shall notify the designer of discrepancies in the documents, and of any field conditions that deviate from the documents.
- 7. The architects approval must be obtained for any deviations from the construction documents, including but not limited to changes in dimensions, design, materials, products, and finishes. In no case may the contractor make these changes without the approval of the architect.
- 8. Shop drawings and other submittals are to be submitted for approval by the architect with sufficient time for review prior to execution of work. Submittals must conform to the requirements indicated on construction documents, structural notes, and specifications.
- 9. See door and window schedule for sizes, types, and finishes.
- 10. All construction shall conform to and strictly comply with all applicable codes, covenants, restrictions, and Weber County building standards.
- 11. In no event shall the contractor substitute a standard construction detail for a detail specified in these documents. The contractor shall bring all work into conformity with the construction documents, as the designer orders, before approval of that construction will be granted
- 12. The contractor is to verify all dimensions, datum & levels prior to construction. Exterior walls are dimensioned from face of exterior wall sheathing or face of concrete unless otherwise noted. Exterior wall studs at heated spaces shall be 2x6 except as noted. All other wall study shall be 2x4
- 13. Glazing in locations subject to human impact such as panes in doors, glazing within 12" of door opening, glazing within 18" of floor, and shower doors shall be tempered or laminated safety glass as per 2012 IBC.
- 14. Provide and install smoke detectors as per 2012 IBC.
- 15. Provide attic access, minimum 22" x 30" with minimum 30" headroom at unobstructed readily accessible opening as per 2012 IBC.
- 16. Building shall comply with Utah State Energy Code. The contractor is to seal and caulk all cracks to prevent air infiltration. The contractor shall insulate the walls to R-19, ceilings to R-38, and floors over unheated spaces to R-38 unless
- 17. These drawings are the exclusive property of Lloyd Architects and may be reproduced only with the written permission of the architect. Authorized oductions must bear the name of the architect
- 18. Fireplaces shall conform to 2012 IBC. UL listing on fireplaces are as follows: Wood burning units, UL#MH5850 Enclosed gas units; ICBO #4030
- 19. SITE PLAN & GRADING: remove stumps, shrubs and clear and grub site near house as indicated on site plans including legal off-site disposal of all debris and unusable fill. Scrape topsoil layer before excavation and place onsite for finish landscape use. Excavate, trench, and backfill as required for footings, foundations, slabs, utility lines, mechanical, electrical and other work below grade required to complete the project. Maintain excavation free of water and provide an adequate system for the handling and removal of surface
- 20. Contact the Utah Division of Air Quality on all remodel projects: 536-4000

FOUNDATION

- 1. GEOTECHNICAL: SOIL BEARING: Assume 1500 psf soil load pressure per R401.4. CONCRETE: 3,000 psi in slabs and footings, 3000 psi in foundation walls, 3500 psi in garage slab and exterior steps.
- 2. CONCRETE FOOTING SIZES AND DEPTH: see footing schedule on structural sheets (minimum footing size 9" by 20", minimum depth 30" below grade).
 MINIMUM REBAR: see structural sheets for minimum reinforcing requirements.
- 3. ANCHOR BOLTS TO FOUNDATION: minimum 7" embedment per R403.1.6(maximum spacing allowed by code is 32" O.C.)
- 4. CONCRETE FOUNDATION WALLS: see structural drawings for size and
- 5. HEIGHT ABOVE FINISHED GRADE: concrete foundation wall to be 6" minimum above finish grade. Use treated sill plate where required.
- 6. FOUNDATION WALL DAMP-PROOFING AND FOUNDATION DRAIN: bituminous coating or equal to be applied on basement walls per R406. Foundation drain to be installed by new footings per R405.
- 7. PLATE WASHERS: All plate washers to be 3"X3"X.227" (1/4") square slotted
- 8. WINDOW WELLS AND LADDERS: 9 sq ft min area, 36 inches out from window, if deeper than 44 inches affix a ladder.

CONSTRUCTION

- 1. EMERGENCY ESCAPE AND RESCUE OPENINGS: 44 inches max above floor, in every sleeping room, 5.7 sq ft or 5 sq ft if within 44 inches of grade, 20 inch min width, 24 inch min height.
- 2. EXIT DOORS AND HALLWAYS: one 3'-0" x 6'-8" door required, 36 inch min. width in hallways.
- 3. LANDINGS AT DOORS AND STAIRWAYS: 36" min. out from door and door
- 4. RAMPS, SLOPES AND RAILS: maximum slope 1 in 8, railing required on ramps
- 5. STAIRWAYS: 36" width minimum, TREADS AND RISERS: 8" rise and 9" tread minimum, HEADROOM: 6"-8" minimum, UNDER STAIR PROTECTION: 1/2" GWB, HANDRAILS: required with (2) or more risers, 34" to 38" in height and 1 1/4 to 2
- 6. GUARDRAILS (GUARDS): required at floors over 30" above grade, 36" min. height, a 4"sphere shall not pass through with design as to eliminate ladder effect.
- 7. LUMBER PROTECTION AGAINST DECAY: 18" minimum to grade under floor joists, 12" minimum to grade under floor girders. Provide treated plate on concrete slab less than 8" above exposed ground and framing and siding less than 6" from the ground. All lumber in contact with concrete, earth, or within 18" of finish grade shall be pressure treated. Pressure treat above ground items with water-borne preservatives complying with AWPB LP-2. Wood members in contact with ground shall be pressure treated with water-borne preservative complying AWPB I b-2? members in contact with ground shall preservative complying AWPB LP-22.
- 8. WOOD COLUMNS: required to be 1" above the floor or finish grade, See structural for connection to foundation or slab.
- 9. MINIMUM AREA DIMENSIONS AND HEIGHTS: see all plan sheets for room sizes. All room minimums shall be: (1) 120 sf room, 70 sf bedrooms, 50 sf kitchen, 7 feet min. heights, sloping to 5 feet min. 3 feet min. passageways in
- 10. INTERIOR MOISTURE VAPOR RETARDERS: on "warm-in-winter" side of wall.

- 1. INTERIOR WALL COVERINGS: 5/8" GWB. Green Gyp. board to be limited to R702.3.8.1 for no direct contact to moisture.
- 2. EXTERIOR WALL COVERINGS AND WEATHER BARRIERS: 15# felt paper or
- 3. STRUCTURAL COLUMNS: see structural sheets for all column sizes and
- 4. MID-HEIGHT BRIDGING: in unfinished walls
- 5. BRACED WALL LINES AND PANELS: see structural notes. Minimum requirement are to provide within 12-6" of wall corner, at 4"-0" in length for plywood w/ nailing @ 6" O.C. @ edges and 12" O.C. in field, at 8'-0" for GWB w/screws @ 7" O.C. @ edges and field.
- 6. HABITABLE ROOMS AND BATHROOMS: 8% of area in glazing, 4% in openings, and 3 sf window in bathrooms or bathrooms to have exhaust fan per IRC 303.3
- 7. GARAGE SEPARATION FROM DWELLING: 1 hour separation. Walls shall have 1/2" GWB on walls and attic. If garage is below habitable rooms the ceiling shall have 5/8" type "X" GWB. Door shall have a 20 min. fire-resistance rating and shall be self-closing.

FLOOR CONSTRUCTION

- 1. FLOOR JOISTS: double joists under bearing partitions and blocking shall be
- 2. DRAFT-STOPPING: shall be installed in all concealed spaces over 1,000 sq ft.
- 3. FIREBLOCKING: shall be installed in all concealed spaces at 10'-0" O.C.
- 4. SUBFLOOR SHEATHING: see structural sheets for all floor sheathing callout (minimum requirements are as follows; 5/8 inch thick tongue & groove osb for joists @ 16" to 20" O.C. and 3/4" thick tongue & groove osb @ 24" O.C.)
- 5. FLOOR JOISTS SUPPORTING BEARING PARTITIONS OFFSETS: offset minimum
- 6. EXPOSED LAMINATED TIMBERS: ATIC Rated Architectural grade inated Timbers: See structural sheets for sizes and locations. not

ROOF CONSTRUCTION

- 1. ROOF FRAMING: see structural sheets pre-engineered truss type and layout. Submit shop drawings to architect/engineer for approval.
- 2. ATTIC VENTILATION: Provide a 1 to 150 sq.ft. (or 1 to 300 if 50% is in soffit and 50-80% located more than 3'0" above soffits) of the attic area in ventilation. Provide insulation baffles to insure air flow through space. Cut or drill holes in truss blocking for vent air passage from soffit vents.
- 3. ROOF SLOPES and DRAINAGE: felt paper, 1/4" per foot minimum. provide "ice and water shield" at all valleys U.N.O.
- 4. ICE DAM PROTECTION: "ice and water shield" at eaves to 36" inside the wall
- 5. CHIMNEY TERMINATION: chimney shall be 2'-0" higher than any portion of building within 10'-0", 3'-0" tall minimum

MASONRY

- MASONRY VENEERS, AND TIES: see structural sheets. provide minimum brick ties at 16 inches on center in either direction, with horizontal 9 gage wire mechanically attached to ties (if applicable)
- 2. LINTELS: see structural drawings for lintel sizes and locations. SHEARWALLS & HOLDDOWN SCHEDULE: see structural sheets

MECHANICAL

- 1. GAS FIREPLACE: ICBO #4030 on typical gas unit
- 2. FIREPLACE HEARTHS: Extend 20" min. from front of firebox and 12" min.
- 3. RES-CHECK: 2009 IECC See attached REScheck report.
- 4. CENTRAL FURNACE, CLEARANCE, ACCESS, PLATFORM, LIGHT: provide 3" side and rear of platform, space is 12 inches wider than furnace, 6 inches in front if door or 30 inches in front, 30 x 30 inch access platform with light for servicing
- 5. BTU SIZES OF WATER HEATERS, FURNACES: see mechanical
- 6. COMBUSTION AIR: provide duct or opening within 12 inches of ceiling and size of 1 sq inch for every 3000 btu/h.
- 7. ELEVATION OF COMBUSTION SOURCE OF APPLIANCES: see floor plans for
- 8. APPLIANCE PROTECTION FROM IMPACT: N/A (mechanical not in garage).
- 9. CONDENSATE DISPOSAL: provide an indirect drain, secondary condensate if located in attic or on wood floor (to be trap seal primer type)
- 10. GAS LINE SCHEMATIC: See mechanical sheets.
- 11. WATER HEATERS, LOCATIONS, EXPANSION TANKS, AND PRESSURE RELIEF VALVES: can not be located in closets, bedrooms, or bathrooms. If located within sealed enclosures provide combustion air vent. Direct-vent water heaters are okay. Provide and install high-efficiency radiant hydronic heat system including connection of hot water storage tank, gas hot water heaters and piping from the hot water tank to all fixtures as indicated in drawings. Installation shall conform to all local codes, ordinances and regulations pertaining to this work. Manifold and thermostat locations to be approved by the Architect. Provide tran seal prings tree frains at water heaters. Provide trap seal primer type drain at water heaters
- 12. WATER HEATER ANCHORAGE, FLOOR DRAIN, AND PANS FOR DRAINAGE: provide seismic strap to top third and bottom third of water heater. Provide an indirect drain for water heaters. Provide pan
- 13. CLOTHES DRYER EXHAUST: maximum 25'-0" to outside with 5'-0"
- 14. EXHAUST VENT TERMINATIONS: 4'-0" below or beside and 1'-0" above
- 15. SHOWER SIZE AND DOOR: 900 sq inches and 30" diameter, door
- 16. HEATING: new construction to have a gas fired forced air furnace with air conditioning condenser unit. Heating facility to maintain 68 degrees.

PLUMBING

- 1. WATER PIPING: Shall be pex.
- 2. VENT PIPING: shall be ABS.
- 3. HOSE CONNECTION BACKFLOW PREVENTER: provide at all exterior hose bib locations. Use frostproof type with vacuum break
- 4. FLOOR DRAINS: Deep seal or Trap seal primer required in laundry or mechanical rooms per IbC 3201.2
- 5. WASTE INTERIOR TO BE ABS, WASTE INTERIOR UNDER SLAB AND EXTERIOR TO BE ABS.

ELECTRICAL

- 1. WHIRLPOOL BATHTUB ACCESS PANEL; see plans for size and locations.
- 2. ELECTRICAL SERVICE PANEL LOCATION: shall not be located in bathrooms or firewalls. provide 30° clearance side to side and 36° clearance in front. Provide a minimum of 6'-6" in height.
- 3. RECEPTACLE OUTLETS: see electrical drawings for all outlet locations. Electrical sub-contractor to walk through project with owner to verify all electrical fixture locations prior to commencing work. Follow all local electrical
- 4. ARC-FAULT CIRCUIT-INTERRUPTER PROTECTION: provide in bedrooms.
- 5. GFCI PROTECTION: see electrical sheets for all locations. Provide in bathrooms and jetted tub motors, garage, outdoor, crawlspace, kitchen counters, kitchen istands, and wet-bar.
- 6. LIGHTING WALL SWITCHES: see electrical drawings for all switch locations. Electrical sub-contractor to walk through project with owner to verify all electrical fixture locations prior to commencing work. Follow all local
- 7. RECEPTACLES AND LIGHTING IN DAMP AND WET LOCATIONS: provide weatherproof covers for outlets, lighting to be listed for wet or damp locations.
- 8. LIGHT FIXTURES IN CLOSETS: incandescent fixtures 12" minimum to storage, fluorescent fixtures 6" minimum to storage
- 9. SUPPORT OF CEILING FANS: as per manufacturer's recommendations.
- 10. ELECTRICAL: all wiring to be in accordance with the National Electrical Code and applicable local codes. Locate main panel and meter where indicated on the Drawings. Provide underground power connection from
- 11. SMOKE DETECTORS: locate (1) inside each sleeping room, in corridors outside sleeping rooms, and on each level. All smoke detectors to be wired in series.
- 12. CO2 DETECTORS: Locate (1) on each level

Lloyd/Architects

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> BN DRIVE 10 ₹ C E. HEARTWOOD EDEN, UTAH 8431 ENTHAL

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SEAL

PRINT DATE

8/10/16

PROJECT PHASE ARC SUBMITTAL 07/22/20
HDR SET 09/40/20


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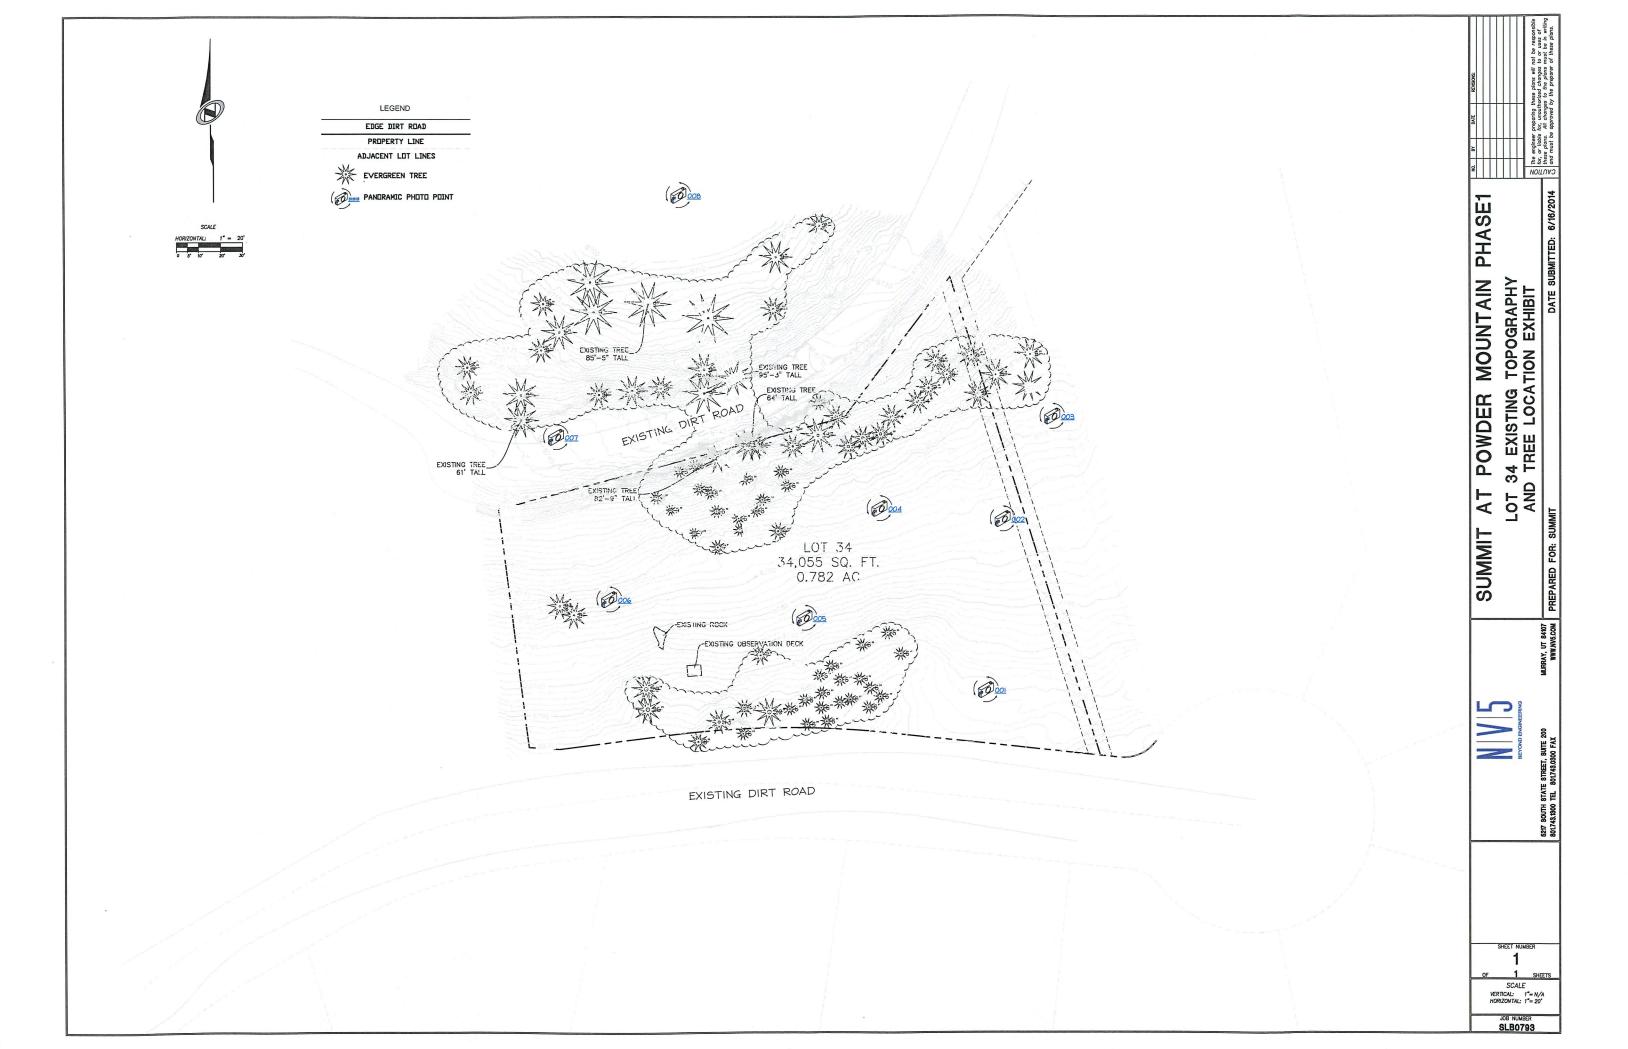
SHEET TITLE

GENERAL NOTES

SHEET NUMBER

G102



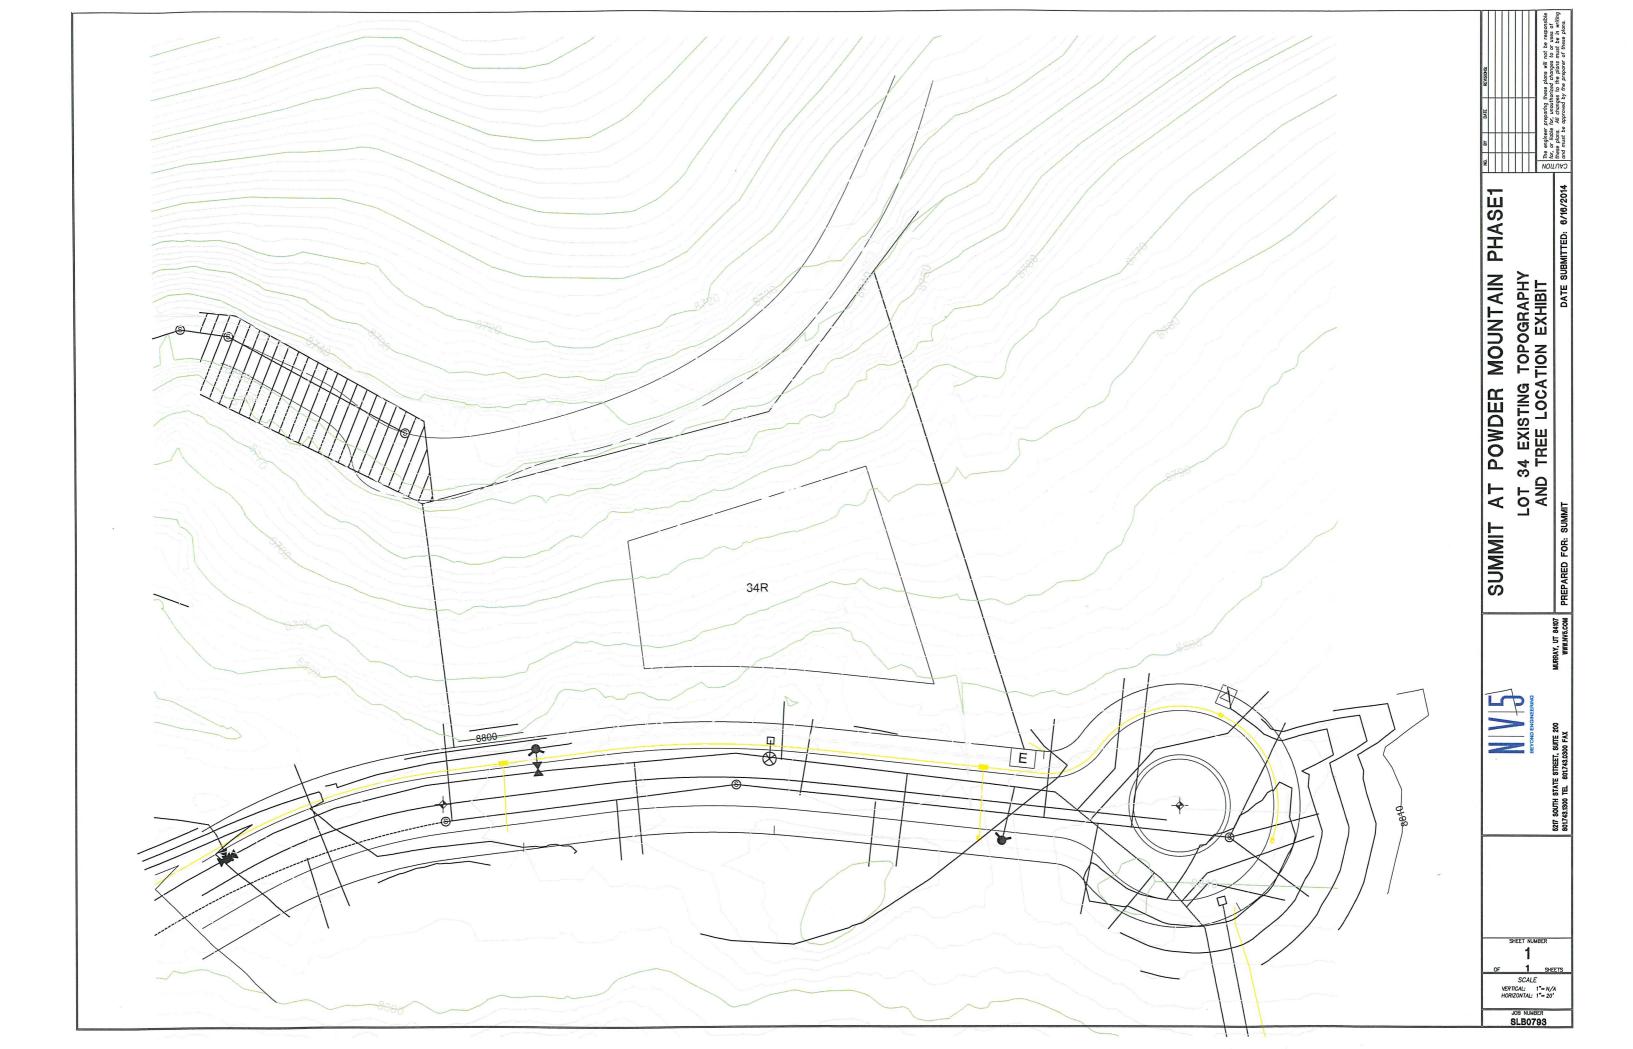

I, RICHARD M, MILLER, DO HEREBY CERTIFY THAT I AM A REGISTERED PROFESSIONAL LAND SURVEYOR IN THE STATE OF UTAH IN ACCORDANCE WITH TITLE 58, CHAPTER 22, PROFESSIONAL ENGINEERS AND LAND SURVEY OR THAT I HAVE COMPLETED A SURVEY OF THE PROPERTY DESCRIBED ON THIS PLAT IN ACCORDANCE WITH SECTION 17-23-17 AND HAVE VERIFIED ALL MEASUREMENTS AND HAVE PLACED MONUMENTS AS REFRESENTED IN THIS PLAT, AND THAT THIS PLAT SUMMIT EDEN PHASE IB, IN MEBER COUNTY, THAH, HAS BEEN DRAWN CORRECTLY TO THE DESIGNATED SCALE AND IS A TRUE AND CORRECT. THAT HE PREVENTATION OF THE HEREON DESCRIBED LANDS INCLUDING SAID SUBDIVISION, BASED UPON DATA COMPILED FROM RECORDS IN THE MEBER COUNTY RECORDER'S OFFICE AND FROM SAID SUBVEY MADE BY ME ON THE GROUND. I FURTHER CERTIFY THAT THE EQUIREMENTS OF ALL APPLICABLE STATUTES AND ORDINANCES OF MEBER COUNTY CONCERNING ZONING REQUIREMENTS HAVE BEEN COMPILED WITH. REQUIREMENTS REGARDING LOT MEASUREMENTS HAVE BEEN COMPLIED WITH.



RICHARD W. MILLER PROFESSIONAL LAND SURVEYOR UTAH CERTIFICATE NO. 1556

LEGAL DESCRIPTION

BEGINNING AT A POINT THAT IS SOUTH 0'09'01" WEST 995.75 FEET ALONG THE SECTION LINE AND EAST 915.18 FEET, FROM THE MEST QUARTER CORNER OF SECTION 5, TOWNSHIP 7 NORTH, RANGE 2 EAST, SALT LAKE BASE AND MERIDIAN, (BASIS OF BEARING IS NORTH 975'51" HEST ALONG THE LINE BETHEEN THE NORTHEAST CORNER OF SECTION 1, TOWNSHIP 7 NORTH, RANGE I EAST, SALT LAKE BASE AND MERIDIAN AND THE SET WEBER COUNTY MOVIMENT ON THE INTERSECTION OF THE WEBER/CACHE COUNTY LINE AND THE SECTION LINE.), RUNNING THENCE NORTH 87'12'92" EAST 272.77 FEET, THENCE SOUTH 02'47'31" EAST 224.41 FEET, THENCE SOUTH 48'36'24" EAST 13.68 FEET, THENCE SOUTH 04'47'44" EAST 184.04 FEET, THENCE SOUTH 83'04'25' EAST 36.76 FEET, THENCE NORTH 89'26'39" EAST 30.79 FEET, THENCE NORTH 83'08'05' EAST 30.86 FEET, THENCE SOUTH 82'06'33' EAST 416.15 FEET, THENCE SOUTH 49'05'13' EAST 210.20 FEET, THENCE SOUTH 30'26'35' EAST 270.66 FEET, THENCE SOUTH 49'05'14' EAST 391.77 FEET, THENCE SOUTH 62'09'42' EAST 391.77 FEET, THENCE FEET, THENCE SOUTH 62'09'42' EAST 391.77 FEET, THENCE 60.77 FEET, THENCE SOUTH 62'09'42' EAST 391.77 FEET, THENCE 50.77 FEET, THENCE SOUTH 62'09'42' EAST 391.77 FEE PIELLI, I HENCE EAST 495.99 FEET, THENCE SOUTH 35'0'14" NEST 550.33 FEET, THENCE NORTHHEISTERLY ALONG A 455.00 FOOT RADIUS NON-TANGENT CURVE TO THE LEFT, (CHORD BEARS NORTH 64'45'19" NEST A DISTANCE OF 247.34 FEET, THENCE SOUTH 09'40'13" NEST 25.00 FEET, THENCE WESTERLY ALONG A 430.00 FOOT RADIUS NON-TANGENT CURVE TO THE LEFT, (CHORD BEARS NORTH 57'04'17" WEST A DISTANCE OF 100.96 FEET, THENCE HESTERLY ALONG A 430.00 FOOT RADIUS NON-TANGENT CURVE TO THE LEFT, (CHORD BEARS NORTH 57'04'17" WEST A DISTANCE OF 100.96 FEET, THENCE SOUTH 66'11'14" WEST 193.22 FEET; THENCE WESTERLY ALONG A 570.00 FOOT RADIUS TANGENT CURVE TO THE RIGHT, (CHORD BEARS NORTH 80'46'24" WEST 10 SISTANCE OF 100.10 FEET), THROUGH A CENTRAL ANGLE OF 1004'29", A DISTANCE OF 100.23 FEET; THENCE SOUTH 66'19'42" WEST 107.00 FEET TO THE NORTHERLY RIGHT OF NAY LINE OF SUMMIT PASS; THENCE ALONG SAID NORTHERLY LINE THE FOLLOWING THIRTY THO (32) COURSES: 1) NORTH 83'44'19" WEST 164.74 FEET, 2) NORTH-18'25'19", A DISTANCE OF 223.27 FEET), THROUGH A CENTRAL ANGLE OF 35'15'14", A DISTANCE OF 255.81 FEET, 3) NORTH 48'24'04' WEST 164.39.35 FEET, 4) NORTH-148'25'14' A DISTANCE OF 155.41 FEET), THROUGH A CENTRAL ANGLE OF 155'14' A DISTANCE OF 155.41 FEET), THROUGH A CENTRAL ANGLE OF 155'14' A DISTANCE OF 155.41 FEET), THROUGH A CENTRAL ANGLE OF 155'14' A DISTANCE OF 155'41' FEET), THROUGH A CENTRAL ANGLE OF 156'41' NEST A DISTANCE OF 155'41' FEET), THROUGH A CENTRAL ANGLE OF 156'42' A DISTANCE OF 156'41' WEST 164'28'44' WEST 164'35'57' NEST A DISTANCE OF 156'41' FEET, 1 THROUGH A CENTRAL ANGLE OF 156'42' A DISTANCE OF 156'41' FEET, 1 THROUGH A CENTRAL ANGLE OF 156'42' A DISTANCE OF 156'41' FEET, 1 THROUGH A CENTRAL ANGLE OF 156'42' A DISTANCE OF 156'41' FEET, 1 THROUGH A CENTRAL ANGLE OF 156'42' A DISTANCE OF 156'41' FEET, 1 THROUGH A CENTRAL ANGLE OF 156'42' A DISTANCE OF 156'41' FEET, 1 THROUGH A CENTRAL ANGLE OF 156'42' A DISTANCE OF 156'41' FEET, 1 THROUGH A CENTRAL ANGLE OF 156'42' A DISTANCE OF 156'41' FEET, 1 THROUGH A CENTRAL ANGLE OF 156'42' A DISTAN DISTANCE OF 195.47 FEET, 5) NORTH 662'93" WEST 225.56 FEET, 6)
NORTH-WESTERLY ALONG A 367.00 FOOT RADIUS TANGENT CURVE TO THE
RIGHT, COLORD BEARS NORTH 562'93" NEST 225.56 FEET, 6)
NORTH-WESTERLY ALONG A 367.00 FOOT RADIUS TANGENT CURVE TO THE
RIGHT, COLORD BEARS NORTH 562'93" NEST A DISTANCE OF 182.22 FEET), THROUGH A
CENTRAL ANGLE OF 24'05'53", A DISTANCE OF 184.36 FEET, 7) NORTH 42'22'41" MEST
74.01 FEET, 8) NORTH-WESTERLY ALONG A 367.00 FOOT RADIUS TANGENT CURVE TO
THE RIGHT, COLORD BEARS NORTH 29'31" MEST A DISTANCE OF 186.25 FEETT, 9)
THROUGH A CENTRAL ANGLE OF 25'42'21", A DISTANCE OF 186.25 FEETT, 9) NORTH
16'40'20" MEST 28:155 FEET, 10) NORTH-BELLY ALONG A 557.42 FOOT RADIUS TANGENT
16'40'20" MEST 28:155 FEET, 10) NORTH-BELLY ALONG A 557.42 FOOT RADIUS
TANGENT CURVE TO THE LEET, (CHORD BEARS NORTH 11'39'00" MEST A DISTANCE OF 94.09
FEET), THROUGH A CENTRAL ANGLE OF 17'44"11", A DISTANCE OF 94.01
FEET), THROUGH A CENTRAL ANGLE OF 17'44"11", A DISTANCE OF 186.75 FEET, 13)
NORTH 06'37'40" MEST 118.34 FEET, 12) NORTH-BELLY ALONG A 633.00 FOOT RADIUS
TANGENT CURVE TO THE LEET, (CHORD BEARS NORTH 35'09'41" MEST A DISTANCE OF
195.17 FEET), THROUGH A CENTRAL ANGLE OF 17'44"11", A DISTANCE OF 186.30 FEET,
15) NORTH 47'59'31" MEST 81.02 FEET, 16) MESTERLY ALONG A 433.00 FOOT RADIUS
TANGENT CURVE TO THE LEET, (CHORD BEARS NORTH 36'09'41" MEST A DISTANCE OF
286.47 FEET), THROUGH A CENTRAL ANGLE OF 23'34'07, A DISTANCE OF 30.30 FEET,
15) NORTH 67'59'31" MEST 81.02 FEET, 16) MESTERLY ALONG A 433.00 FOOT RADIUS
TANGENT CURVE TO THE LEET, (CHORD BEARS NORTH 81'03'41" MEST A DISTANCE OF
326.12 FEET), THROUGH A CENTRAL ANGLE OF 22'12'58", A DISTANCE OF 334.37 FEET,
17) SOUTH 57'49'40" MEST 21.01 FEET, 20) MESTERLY ALONG A 533.00 FOOT RADIUS
TANGENT CURVE TO THE LEET, (CHORD BEARS NORTH 81'03'41" MEST A DISTANCE OF
16.03 FEET), THROUGH A CENTRAL ANGLE OF 10'10'57", A DISTANCE OF 184.35 FEET,
19) NORTH 62'71'04" MEST 241.01 FEET, 20) MESTERLY ALONG A 533.00 FOOT RADIUS
TANGENT CURVE TO THE LEET, (CHORD BEARS NORTH 81'03'5

CONTAINING 2.502.914 SQUARE FEET OR 57.459 ACRES.

PLAT NOTES:

I. THIS PLAT IS SUBLECT TO THAT CERTAIN NEIGHBORHOOD DECLARATION OF COVENANTS, CONDITIONS, EASEMENTS AND RESTRICTIONS FOR SUMHIT EDEN MOUNTAIN HOMES ("NEIGHBORHOOD DECLARATION") EXECUTED BY SHIME PHASE I, LLC ("DECLARATION") AS MIELL AS THAT CERTAIN HASTER DECLARATION OF COMPANTS, CONDITIONS, EASEMENTS AND RESTRICTIONS FOR SUMHIT EDEN ("MASTER DECLARATION") THAT HAVE BEEN OR MILL BE RECORDED IN THE OFFICE OF THE MEBER COUNTY RECORDER WHICH SHALL SET FORTH THE RESTRICTIONS AND GENERAL PLAN OF INPROVEMENT FOR THE PROPERTY DESCRIBED IN THIS PLAT. CERTAIN TERMS NOT OTHERWISE DEFINED IN THIS PLAT SHALL HAVE THE MEANINGS SET FORTH IN THE NEIGHBORHOOD DECLARATION OR MASTER DECLARATION. THIS PLAT IS SUBJECT TO THAT CERTAIN NEIGHBORHOOD DECLARATION OF COVENANTS,

2. PURSUANT TO THE NEIGHBORHOOD DECLARATION, THE SUMMIT EDEN MOUNTAIN HOMES ASSOCIATION, INC., A UTAH NONPROPIT CORPORATION ("NEIGHBORHOOD ASSOCIATION") IS RESPONSIBLE FOR MAINTAINING ALL COMMON AREA, IF ANY, AND SHALL HAVE A PERPETUAL NON-EXCLUSIVE EASE-INT OVER ALL LOTS AND PARCELS FOR SUCH MAINTENANCE PURPOSES AS FURTHER DESCRIBED IN THE NEIGHBORHOOD DECLARATION. SUCH RESPONSIBILITY AND EASE-INST MAY BE DELEGATED AND ASSIGNED TO THE SUMMIT HAY BE DELEGATED AND ASSIGNED TO THE SUMMIT EDEN CANDERS ASSOCIATION, INC., A UTAH NONPROFIT CORPORATION ("COMMUNITY ASSOCIATION").

3. INTENTIONALLY DELETED.

4. THE PROPERTY AS DEPICTED ON THIS PLAT IS SUBJECT TO THE RIGHTS OF DECLARANT AS DESCRIBED IN THE NEIGHBORHOOD DECLARATION, AND THE RIGHTS OF MASTER DEVELOPER AS DESCRIBED IN THE MASTER DECLARATION, AND DECLARANT AND MASTER DEVELOPER SHALL HAVE THE RIGHT TO EXERCISE ANY APPLICABLE RIGHTS PROVIDED FOR IN SAID DECLARATIONS, INCLUDING, WITHOUT LINITATION, RESERVATION AND GRANTING OF CERTAIN EASIERING, REDUCING OR RELOCATING IMPROVEMENTS WITHIN THE COMMUNITY, ADDING ADDITIONAL FACILITIES AND MAKING SUCH OTHER DEVELOPMENT DECISIONS AND CHANGES AS DECLARANT OR MASTER DEVELOPER SHALL DETERMINE IN EACH OF THEIR SOLE AND EXCLUSIVE DISCRETION.

THE LOTS ARE SERVED BY PRIVATE MATER AND MASTEMATER LATERAL LINES, EACH CONNER SHALL BE RESPONSIBLE FOR THE MAINTENANCE AND REPLACEMENT OF ALL MATER AND SANITARY SEMER LATERALS SERVING THE RESIDENCE ON SUCH OWNER'S LOT IN ACCORDANCE MITH THE REQUIREMENTS OF THE POWDER MOUNTAIN MATER AND SEMER IMPROVEMENT DISTRICT.

6. ALL UTILITIES WITHIN THE PROJECT SHALL BE UNDERGROUND. NOTWITHSTANDING DECLARANT'S GRANT OF BLANKET UTILITY EASEMENTS, DECLARANT RESERVES THE RIGHT TO RECORD ONE OR MORE INSTRUMENTS WHICH NARROW AND LIMIT SUCH GRANT OF UTILITY EASEMENT TO THE ACTUAL WIDTH OF THE UTILITY IN THOSE SPECIFIC AREAS WHICH ACTUALLY CONTAIN THE UTILITY FACILITIES AS DESCRIBED IN SUCH INSTRUMENT AND FOR THE PURPOSES DESCRIBED THERRIN, SUCH RESERVED RIGHT IS SUBJECT TO THE UTILITY COMPANIES' RIGHTS THEN LOCATED UNDER THE REAL PROPERTY DEPICTED ON THIS PLAT.

THEN LOCATED UNDER THE REAL PROPERTY DEPICTED ON THIS PLAT.

7. DECLARANT HEREBY GRANTS TO ALL UTILITY PROVIDERS AN EASEMENT OVER AND ACROSS ALL AREAS SHOWN HEREON AS PUBLIC UTILITY EASEMENTS FOR THE PURPOSE OF INSTALLING, MAINTAINING AND OPERATING EQUIPMENT AND FACILITIES ABOVE AND BELION GROUND AS HAY BE RECESSARY OR DESIRABLE IN PROVIDING THEIT SHOWN AND INTHOUT THE LOTS, INCLUDING THE RIGHT OF ACCESS TO SUCH FACILITIES AND THE RIGHT TO REQUIRE REMOVAL OF ANY OBSTRUCTIONS INCLUDING STRUCTURES, THESES, AND VEGETATION THAT MAY HAVE BEEN PLACED WITHIN THE PASSITIENTS. AT NO TIME MAY ANY PERMANENT STRUCTURES BE PLACED WITHIN THE PUBLIC UTILITY EASEMENTS WHICH INTERFERED WITH THE USE OF THE EASEMENTS WITHOUT THE PRIOR WRITTEN APPROVAL OF THE APPLICABLE UTILITY PROVIDERS.

NITHOUT THE PRIOR NRITTEN APPROVAL OF THE APPLICABLE UTILITY PROVIDERS.

6. THIS PLAT ESTABLISHES HEARTWOOD DRIVE, SHOWN HEREON AS 'ROAD PARCEL A,' AS A LEGALLY RECORNIZED AND PROPERLY SUBDIVIDED SEPARATE PARCEL OF REAL PROPERTY AND AS A PUBLIC UTILITY EASEHENT. HEARTWOOD DRIVE IS A PRIVATE ROAD OPERATED, HAINTAINED AND REPRIARED BY THE NEIGHBORHOOD ASSOCIATION FOR THE USE AND BENEFIT AND AT THE EXPENSE OF ITS METHERS IN ACCORDANCE WITH THE NEIGHBORHOOD DECLARATION AND MASTER DECLARATION. DECLARANT SHALL CONVEY ROAD PARCEL A TO THE NEIGHBORHOOD ASSOCIATION IN ACCORDANCE WITH THE MASTER DECLARATION. HEARTWOOD DRIVE FIN THE REPORT OF DECLARATION AND IN ACCORDANCE WITH APPLICABLE MEBER COUNTY ORDINANCES. HEARTWOOD DRIVE IS NOT A PUBLIC ROAD OR RIGHT OF WAY. THIS PLAT SHALL NOT BE DEETED TO GRANT ANY RIGHTS IN THE PUBLIC TO USE HEARTWOOD DRIVE OR CREATE ANY OBLIGATIONS ON THE PART OF MEBER COUNTY TO MAINTAIN OR REPAIR HEARTMOOD DRIVE. ALL SUCH USE AND MAINTAIN OR REPAIR HEARTMOOD DRIVE. ALL SUCH USE AND MAINTAINANCE SHALL BE GOVERNED BY THE TERMS AND PROVISIONS OF THE NEIGHBORHOOD DECLARATION.

9. ALL COMMON WATER AND SEWER MAINS WITHIN THE COMMUNITY WILL BE OWNED AND MAINTAINED BY POWDER MOUNTAIN WATER AND SEWER IMPROVEMENT DISTRICT.

IO. AS PURTHER DESCRIBED IN THE MASTER DECLARATION, ALL LOTS, AND ALL RESIDENCES AND IMPROVEMENTS CONSTRUCTED THEREON, SHALL COMPLY MITH THE DESIGN GUIDE. NO CONSTRUCTION, INSTALLATION, OR OTHER WORK WHICH IN ANY MAY ALLERS THE APPEARANCE OF ANY PROPERTY OR LOT WITHIN THE PROJECT, OR ANY RESIDENCES OR IMPROVEMENTS LOCATED THEREON, SHALL BE MADE OR DONE WITHOUT COMPLIANCE WITH THE DESIGN GUIDE AS DESCRIBED IN THE THASTER DECLARATION.

II. DECLARANT RESERVES FOR THE BENEFIT OF ITSELF, ITS SUCCESSORS AND ASSIGNS, THE RIGHT TO UNILATERALLY AFIEND THE PLAT, WITHOUT THE CONSENT OF THE AFFECTED CHARF, AT ANY THE AND FROM THE TO THISE IF SUCH AMENDHENT IS NECESSARY TO SATISFY THE REQUIREMENTS OF ANY GOVERNMENTAL AUTHORITY, TO CORRECT MISTAKES, REMOVE/CLARIFY AND ISSUED OF FOR ANY OTHER PURPOSE SO LONG AS SUCH AMENDMENT TO THE TAT DOES NOT PATERIALLY ADVERSELY AFFECT THILE TO ANY PROPERTY AND IS IN ACCORDANCE WITH MEBER COUNTY OFFICIARCES AND UTAH LAM.

NEBER COUNTY ORDINANCES AND UTAH LAM.

2. DECLARANT HEREBY RESERVES FOR THE BENEFIT OF ITSELF, ITS SUCCESSORS AND ASSIGNS, A BLANKET EASEMENT ACROSS ALL LOTS AND PARCELS, EXCLUDING THE BUILDING ENVELOPES, FOR CONSTRUCTING AND HAINTAINING HIKING AND BIKING TRALLS ("TRALL"). THE EXACT LOCATION OF THE TRAILS HAY BE DESIGNATED, ADDED TO, DELETED, OR NODIFIED BY DECLARANT WITHOUT AN ATRIDITION TO THIS FLAT AS SOORE FULLY. DESCRIBED IN THE REGISCORD DECRAPATION. DECLARANT HEREBY GRANTS TO THE NEIGHBORHOOD SECULTION, CONTINUITY ASSOCIATION, ADDED THE PRIBERS AND EASEMENT FOR BY A BASE OF THE ASSOCIATION, CONTINUITY ASSOCIATION, AND CONFIRM METIBERS AND EASEMENT FOR BY A BASE OF THE ASSOCIATION OF THE PRIBERS AND EASEMENT FOR BY A BASE OF THE ASSOCIATION OF THE TOTTIME, IN ACCORDANCE WITH ANY RULES AND REGULATIONS ADOPTED BY DECLARANT.

REGULATIONS ALDVIED BY DELLAKANT.

B. DECLARANT HEREBY RESERVES FOR THE BENEFIT OF ITSELF, ITS SUCCESSORS AND ASSIGNS, A BLANKET EASPHENT ACROSS ALL LOTS AND PARCELS, EXCLUDING THE BUILDING MEMBERS, POR CONSTRUCTING AND MAINTAINING SKI TRAILS AND OTHER SKI INFROVEMENTS ("SKI EASPHENT"). DECLARANT MAY DESIGNATE, DEFINE, LOCATE, RELOCATE, AND MODIFY THE EXACT LOCATION OF THE SKI EASPENT HITHOUT AN AMBIONMENT TO THIS PLAT AS PROPERLY HITHOUT AN AMBIONMENT TO THIS PLAT AS PROPERLY DESCRIBED IN THE SKI EASPENT HOT AND MEMBERS FOR USE AND SHOTHER SPOCHATION, DECLARANT HEREBY GRANTS AN EASPENENT IN FAVOR OF THE NEIGHBORNHOOD DECLARATION. DECLARANT HEREBY GRANTS AN HEREBY FOR USE AND SHOTHENT OF THE SKI EASPHENT IN THE ASSOCIATION, AND THEIR DECLARANTS, AS MAY BE MODIFIED OR RELOCATIONS OF THIS, IN ACCORDANCE WITH ANY RULES AND REGULATIONS ADOPTED BY DECLARANT.

SURVEY NARRATIVE:

I-THIS SURVEY SUBDIVIDED THE AFORESAID TRACT OF LAND INTO LOTS, STREETS, PARCELS, AND EASEMENTS AS SHOWN HEREON AND AS DIRECTED BY THE CLIENT

2-BASIS OF BEARINGS FOR THIS PLAT IS NORTH 84765'S! MEST ALONG THE LINE BETMEEN THE NORTHEAST CORNER OF SECTION I, TOWNSHIP 7 NORTH, RANGE I EAST, SALT LAKE BASE AND MEDIDAM AND THE SET MEBER CAMPT, MOMINION ON THE INTERSECTION OF THE MEBER/CAMPT COMMITY LINE AND THE SECTION LINE. THIS BASIS DIFFERS PROFI MEBER COUNTY THE MEDIDAM ON COUNTY LINE DECLARATION RECORDED PLAT BOOK 74, PAGE 64.

PLAT NOTES (CONT.):

ILLA I NO LED (CONT.):

II. DECLARANT HEREBY RESERVES FOR THE BENEFIT OF ITSELF, ITS SUCCESSORS AND ASSIGNS, A TEMPORARY BLANKET EASEMENT ACROSS ALL LOTS ADJACENT TO A PRIVATE ROAD ("SLOPE EASEMENT") AS MORE FULLY DESCRIBED IN THE NEIGHEORHOOD DECLARATION. SUCH SLOPE EASEMENT IS FOR THE BENEFIT OF DECLARANT, ITS EMPLOYEES, AND CONTRACTORS, FOR THE PURPOSE OF STABILIZING, CONSTRUCTING CUT SLOPES AND FILL SLOPES, AND PERFORMING OTHER CONSTRUCTION AND MANTENANCE TO PREVENT ERSION ALONG THE PRIVATE ROADS. THE SLOPE EASEMENT ON EACH LOT SHALL AUTOMATICALLY BRITISHED AT SUCH TIME AS SCREENING TO COLUMNOT IS ISSUED FOR A RESIDENTIAL BUILDING CONSTRUCTED ON SUCH LOT, AT WHICH TIME A SUBSTITUTE EASEMENT MAY BE REQUIRED FOR CANGENING MAINTENANCE AND REPAIR. LOTS ADJACENT TO SUMMIT PASS OR SPRING PARK MAY HAVE ADDITIONAL SLOPE EASEMENTS AS SHOWN ON THE ROAD DEDICATION THE WEBER COUNTY RECORDER.

IND ECLERANT HEREBY RESERVES FOR THE BENEFIT OF ITSELF, ITS SUCCESSORS AND ASSIGNS, A BLANKET EASEMENT AND RIGHT ON, OVER, UNDER AND ACROSS HEARTWOOD DRIVE FOR THE CONSTRUCTION, THANTENANCE, AND OPERATION OF TUNNELS, BRIDGES AND/OR SKI LIFTS OVER AND UNDER THE ROAD. DECLARANT MAY CONVEY, TRANSFER, OR ASSIGN ITS RIGHTS HITH RESPECT TO SUCL EASEMENT.

ITS RIGHTS WITH RESPECT TO SUCH EASEMENT. I

16. CERTAIN PARCELS MAY BE DESIGNATED HEREON AS "OPEN SPACE." SUCH OPEN SPACE
PARCELS SHALL BE INITIALLY OWNED BY DECLARANT AND ARE NOT PART OF ANY COMING
AREA UNLESS DESIGNATED AS SUCH BY DECLARANT OR CONVEYED BY DECLARANT TO THE
RIGHBROWNOOD ASSOCIATION OR COTHUNITY ASSOCIATION. NOTHINTSTANDING THE
DESIGNATION AS OPEN SPACE, THE PERHITTED USES AND ANY APPLICABLE RESTRICTIONS
FOR SUCH PARCELS SHALL BE AS SET FORTH IN THE NEIGHT TO BUILD FACILITIES AND
MASTER DECLARATION. DECLARANT RESSERVES THE RIGHT TO BUILD FACILITIES AND
MASTER DECLARATION. DECLARANT RESSERVES THE RIGHT TO BUILD FACILITIES AND
MAISTER DECLARATION. DECLARANT RESSERVES THE RIGHT TO BUILD FACILITIES AND
AMENITES WITHIN ANY AREA DESIGNATED AS OPEN SPACE, AND RESERVES THE RIGHT TO
AMEND, RELOCATE, REDUCE, OR OTHERWISE CHANGE THE AREAS DESIGNATED AS OPEN SPACE
SO LONG AS THE ANDOUNT OF DESIGNATED OFN SPACE FOR THE BYTICE CONTINUENT
COTTPUES WITH THE OPEN SPACE REQUIREMENTS INFOSED BY MEER CONTINUENT
TO THE AND THE CONTINUE THAT THE LITTS INFOSED BY MEER CONTINUENT
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TO THE BYTICE THAT THE LITTS INFOSED BY MEET BY BYTICE THE PROPERTY BYTICE THAT THE LITTS INFOSED BY MEET BY BYTICE THAT THE LITTS INFOSED BY MEET BYTICE THE BYTICE THAT THE LITTS INFOSED BY MEET BYTICE THAT THE LITTS INFOSED BY MEET BYTICE THAT BYTICE THAT THE LITTS INFOSED BY MEET BYTICE THAT BYTICE THAT BYTICE THE BYTICE THAT BYTICE THAT BYTICE THAT BYTICE THAT BYTICE THE BYTICE THAT BYTICE

COTPLIES WITH THE OPEN SPACE REQUIREMENTS IMPOSED BY WEBER COUNTY.

17. DECLARANT GIVES NOTICE THAT THE LOTS SHOWN HEREON ARE IN A SKI RESORT AREA ("SKI RESORT") IN WHICH HEAVY SHOW FALLS, WIND PATTERNS, AND OTHER CONDITIONS HAVE THE POTENTIAL TO CAUSE MACHIES IN CERTAIN AREAS. NO STUDIES HAVE BEEN CONDUCTED TO ENTERHINE MHETHER ANY OF THE LOTS OR BUILDING ENVELOPES SHOWN HEREON ARE HEREOTHER THAT WALANCHE INFLUENCE AND AVALANCHE CONTROL SCANES. HEREON ARE SHITHIN THE SKI RESORT THAY BE SUBJECT TO AVALANCHE CONTROL, SOC STORE OF THE SKI RESORT THAY BE SUBJECT TO AVALANCHE CONTROL, SOC STORE OF THE SKI RESORT THAY BE SUBJECT TO AVALANCHE CONTROL, SOC STORE OF THE SKI RESORT THAY BE SUBJECT TO AVALANCHE CONTROL, SOC STORE OF THE SKI RESORT OF THE SKI RESORT OR THE SOC SEPENATION HOW LINE USE OF DEPLAYING AND SKIT TRAIL (LOSURES) DECLARANT HAKES NO REPRESENTATION HITH RESPECT TO THE OPERATIONS OF THE SKI RESORT OR THE POTENTIAL RISKS OR HAZARDS ASSOCIATED WITH AVALANCHES OR AVALANCHE CONTROL. EACH OWNER OF A LOT SHOULD CONDUCT ITS OWN STUDIES PRIOR TO CONSTRUCTING ANY IMPROVEMENTS ON A LOT.

III. DEVELOPMENT PARCEL B IS INTENDED FOR FUTURE DEVELOPMENT INTO LOTS, UNITS, OR OTHER SUBDIVIDED PROPERTY INTERESTS AND IS VESTED WITH FIFTEEN (IS) EQUIVALENT RESIDENTIAL UNITS OF DENSITY.

RESIDENTIAL UNITS OF DENSITY.

19. ALL LOTS AS DEPICTED ON THIS PLAT ARE LOCATED IN A LIGHTLY DEVELOPED SEPTI-HILDENESS AREA CONTAINING ANIMALS TYPICALLY FOUND IN THE ROCKY MOUNTAINS, INCLUDING HITHOUT LIMITATION, BEARS, MOUNTAIN LIONS, MOOSE, DEER, ELK, SKUNKS, SOURRELS, RACCOONS, AND OTHER ANIMALS BIRDS, INSECTS, AND EPTILES NATIVE OR HIGRATORY TO THE AREA. SUCH ANIMALS ROAM FREELY AND MAY ENTER THE LOTS AND OTHER PRIVATELY ONDED PROPERTIES, SCAUPROING, EATING AND DATAGING PLANTS, FLONERS, SHRUBS AND TREES, AND CREATING POTENTIAL HAZARDS, NUISANCES AND DAMAGE TO PERSONS AND PROPERTY. EACH OWNER SHALL ASSUME ALL SUCH RISKS AND CONDITIONS FOR ANY SUCH DAMAGE.

20. DECLARANT HEREBY RESERVES FOR THE BENEFIT OF ITSELF, ITS SUCCESSORS AND ASSIGNS, AN EASEINAT OVER LOTS 31 AND 32 AS INDICATED HEREON FOR THE FUTURE EXTENSION OF HEARTHOOD DRIVE AS A PRIVATE ROAD, INCLUDING ALL CONSTRUCTION, USE, MAINTENANCE, AND OPERATION OF THE EXTENSION IS CONSTRUCTED, THE OWNERS OF LOTS 31 AND 32 SHALL DEED TO DECLARANT OR ITS SUCCESSORS AND ASSIGNS FEE TITLE TO THE EASEMENT PROPERTY. DECLARANT HAS THE RIGHT TO CONVEY, TRANSFER, OR ASSIGN SUCH EASEMENT RIGHTS, OR GRANT SUB-EASEMENTS OVER THE EASEMENT PROPERTY.

21. DECLARANT HEREBY RESERVES FOR THE BENEFIT OF ITSELF, ITS SUCCESSORS AND ASSIGNS, A BLANKET EASPIENT OVER PARCEL D FOR A FUTURE ROADWAY, INCLIDING ALL CAISTRICTION, USE, MAINTENANCE AND OPERATION OF SUCH ROAD. DECLARANT HAS THE RIGHT TO CONVEY, TRANSFER, OR ASSIGN SUCH EASEMENT RIGHTS, OR GRANT SUB-EASEMENTS OVER THE EASEMENT PROPERTY.

22. DUE TO THE TOPOGRAPHY AND THE LOCATION OF THIS SUBDIVISION, ALL CANERS WILL ACCEPT RESPONSIBILITY FOR ANY STORM WATER RUNOFF FROM THE ROAD ADJACENT TO THIS PROPERTY UNTIL CURB AND GUTTER IS INSTALLED.

23. NOTICE TO PURCHASERS OF RESTRICTED (R) LOTS LOTS DESIGNATED BY THE LETTER IN AFTER THE LOT NUMBER ARE RESTRICTED LOTS AND BUILDING DEVELOPMENT ON SUCH LOTS IS SUBJECT TO THE PROVISIONS OF SECTION 108-14 OF THE MEBER COUNTY LAND USE CODE. APPROVAL OF A RESTRICTED LOT DOES NOT GUARANTEE THE LOT IS BUILDABLE. A HILLSIDE REVIEW AS OUTLINED IN THE LAND USE CODE SHALL BE DONE TO DETERMINE IF A LOT IS BUILDABLE.

24. PARKING ON ANY STREETS AND ROADS SHOWN HEREON IS PROHIBITED.

25. THE NEIGHBORHOOD DECLARATION AND MASTER DECLARATION SET FORTH THE TERMS AND RESTRICTIONS FOR NIGHTLY RENTALS AND LEASING OF LOTS IN THE PROJECT.

26. ACCESS TO THE PROJECT IS BY WAY OF A STATE HIGHWAY MAINTAINED BY THE UTAH DEPARTMENT OF TRANSPORTATION, MEBER COUNTY PUBLIC ROADS, AS MELL AS PRIVATE ROADS. SEVERE MEATHER CONDITIONS MAY MAKE CERTAIN ROADS IMPASSABLE OR SUBJECT TO REDUCED VISIBILITY, SHOW, ICE, AND OTHER RISKS, AND ROADS MAY BE CLOSED DURING CERTAIN PERIODS.

27. THIS PLAT DOES NOT AMEND ANY WEBER COUNTY ORDINANCES. IN THE EVENT OF A CONFLICT BETWEEN THIS PLAT AND WEBER COUNTY ORDINANCES, THE WEBER COUNTY ORDINANCES SHALL CONTROL.

OWNER'S DEDICATION:

STHIG PHASE I LLC ("DECLARANT"), AS THE OWNER OF THE HEREIN DESCRIBED TRACT OF LAND, DOES HEREBY SET APART AND SUBDIVIDE THE SAME INTO LOTS AND PARCELS AS SHOWN HEREON, SUBJECT TO ALL OF THE RESTRICTIONS, RIGHTS AND LIMITATIONS SET FORTH IN THE PLAT NOTES, AND NAME SAID TRACT, TO BE KNOWN AS SUMMIT EDEN PHASE IB, AND COSES LIESBY.

AND LIMITATIONS SET FORTH IN THE PLAT NOTES, AND NAME SAID TRACT, TO BE KNOWN AS SUMMIT EDEN PHASE IS, AND DOES HEREBY

PRIVATE STREETS, ACCESS, RIGHTS-OF-MAY. DEDICATE AND RESERVE UNTO DECLARANT, ITS HEIRS, GRANTEES AND ASSIGNS, A RIGHT-OF-MAY TO BE USED IN COTHON WITH ALL OTHERS WITHIN SAID SUBDIVISION (AND THOSE ADJOINING ASSIGNS) AND THAT MAY BE SUBDIVIDED BY THE UNDERSIGNED CHAIR, ITS SUCCESSORS OR ASSIGNS) ON, OVER AND ACROSS ALL THOSE PORTIONS OR PARTS OF SAID TRACT OF LAND DESIGNATED ON SAID PLAT AS PRIVATE STREETS AS ACCESS TO THE INDIVIDUAL LOTS, TO BE MAINTAINED BY SUTHIT EDEN MOUNTAIN HOTES ASSOCIATION, INC., A UTAH NORPROFIT CORPORATION ("NEIGHBORNOOD ASSOCIATION"), WHOSE HEMBERSHIP CONSISTS OF DECLARANT AND THE CHAIRS OF THE LOTS DEPICTED HEREON.

PUBLIC UTILITY AND DRAINAGE FASPIENTS. GRANT AND DEDICATE A PERPETUAL RIGHT AND EASPENT OVER, UPON AND UNDER THE LANDS DESIGNATED HEREOF AS PUBLIC UTILITY, STORM WATER DETENTION PONDS AND DRAINAGE EASPENTS, THE SAPIE TO BE USED FOR THE INSTALLATION HAINTENANCE AND OPERATION OF PUBLIC UTILITY SERVICE LINE, STORM DRAINAGE FACILITIES, OR FOR THE PERPETUAL PRESERVATION OF WATER CHANNELS IN THEIR NATURAL STATE WHICHEVER IS APPLICABLE AS MAY BE AUTHORITYDE BY THE GOVERNING AUTHORITY, WITH NO BUILDINGS OR STRUCTURES BEING ERECTED WITHIN SUCH EASPENDING.

PRIVATE EASPENDENTS. GRANT AND DEDICATE THOSE CERTAIN EASPENDTS DESCRIBED IN NOTES 7, 12, 13, 14, 15, 20, AND 21 OF THIS PLAT. SUCH NOTES AND THE RESERVATION AND GRANT OF EASPENDTS DESCRIBED THEREIN ARE INCORPORATED HEREIN BY REFERENCE.

in witness whereof, declarant has executed this cwner's dedication as of the 24x day of 34x4x.

SMHG PHASE I LLC, A DELAWARE LIMITED LIABILITY COMPANY

BY: SMHG INVESTMENTS, LLC., A DELAWARE LIMITED LIABILITY COMPANY

ITS: SOLE METBER

BY: NAME: GREGORY VINCENT MAURO
TITLE: MANAGER

ACKNOWLEDGEMENT:

STATE OF UTAH ____

THE FOREGOING INSTRUMENT WAS ACKNOWLEDGED BEFORE ME THIS ZIST DAY OF JAMAGEN 2014 BY ELLIOTT BISNOW, MANAGER OF SINEG INVESTMENTS LLC, THE SOLE MEMBER OF SINEG PHASE I LLC.

TYPE C. ALMORAD
NOTAGY PUBLIC**

MY COMMISSION EXPIRES: 11/19/244 RESIDING IN: DGDEN HTAH



STATE OF UTAH COUNTY OF WEBER 5.5

THE FOREGOING INSTRUMENT WAS ACKNOWLEDGED BEFORE ME THIS **235** DAY OF **CAMBLES** 2014 BY GREGORY VINCENT MAURO, MANAGER OF SMHG INVESTMENTS LLC, THE SOLE MEMBER OF SMHG PHASE I LLC.

MY COMMISSION EXPIRES [1 19 204 PERIDING IN CANSA LITTAL



VICINITY MAP

N.T.S.

PROJECT LOCATION

N	V	5	
NOLTE V	ERT	CALFIV	Æ

217 SOUTH STATE STREET, SLITE 300 01.743.1300 TEL 801.743.0300 FAX

CACHE RECORDED * STATE OF UTAH, COUNTY OF CACHE.

HURRAY, UT 8410 WWW.NOLTE.CO

REQUEST OF:

ENTRY NO: __

DATE: ____ __TIME:_

BOOK: PAGE FEE \$

WEBER RECORDED #

STATE OF UTAH, COUNTY OF WEBER, RECORDED AND FILED AT THE

REQUEST OF SMHG PHILLIC

CACHE COUNTY RECORDER

WEBER COUNTY CONTISSION ACCEPTANCE

THIS IS TO CERTIFY THAT THIS SUBDIVISION PLAT, THE DEDICATION OF STREETS AND OTHER PUBLIC WAYS AND FINANCIAL GUARANTEE OF PUBLIC IMPROVEMENTS. IN ACCORDANCE WITH AN INTERLOCAL AGREEMENT BETWEEN EBER COUNTY AND CACHE COUNTY, ENTRY #2697681, RECORDED 28 MAY 2013, ASSOCIATED WITH THIS SUBDIVISION THEREON ARE HEREBY APPROVED AND ACCEPTED BY THE COMMISSIONERS OF WEBER COUNTY,

Sheet 1 of 3

DATE: 21-Jan-2014 TIME: 10:21 Am BOOK 75 PAGES 37-1034

ENTRY NO. 2672944

Ernest D Rowley

SUMMIT EDEN PHASE IB COVER SHEET, SIGNATURES, & VICINITY MAP

LOCATED IN THE SOUTH ½ OF SECTION 6, SOUTHEAST ½ OF SECTION 5 AND MORTH ½ OF SECTION 8 OF TOWNSHIP 7 NORTH, RANGE 2 EAST, SALT LAKE BASE AND MERIDIAN, WEBER COUNTY, UTAH

MEBER COUNTY ATTORNEY HAVE EXAMINED THE FINANCIAL GUARANTEE AND OTHER OCUMENTS ASSOCIATED WITH THIS SUBDIVISION PLAT AND IN MY OPINION THEY CONFORM WITH THE COUNTY ORDINANCE APPLICABLE THERETO AND NOW IN FORCE AND AFFECT.
SIGNED THIS ZZNd DAY OF TALL., 2014.

DEPERT CEPTIEY THAT THE WERER COUNTY SURVEYOR'S OFFICE HAS REVIEWED THIS PLAT FOR MATHEMATICAL CORRECTNESS, SECTION CORNER

DATA AND FOR HARMONY WITH LINES AND MONUMENTS ON RECORD IN THE COUNTY OFFICES. THE APPROVING THIS PLAT BY THE MEBER COUNTY SURVEYORS DOES NOT RELIES THE CHARGE LAND SURVEYOR WHO EXICUTED THIS PLAT FROM RESPONDENT THE AVOR LABILITIES ASSOCIATED THEREWITH. SIGNED THIS 2.37 DAY OF 2.20

WEBER COUNTY SURVEYOR

PROVEMENT STANDARDS AND DRAWINGS FOR THIS SUBDIVISION CONFORM WITH COUNTY STANDARDS AND THE AMOUNT OF THE FINANCIAL GUARANTEE IS SUFFICIENT FOR THE INSTALLATION OF THESE IMPROVEMENTS.

WEBER COUNTY ENGINEER

SIGNED THIS 21 ST DAY OF James, 20 14 .

LINECORDOFSURVEYO D 0 4961

MEBER COUNTY PLANNING CONTRIBSION APPROVAL


COMMISSION ON THE DAY OF 215 James , 20 14


DULY APPROVED BY THE WEBER COUNTY PLANNING

Planing Divector

THIS 21 DAY OF JAMUAN, 2014

THIS 21 DAY OF J

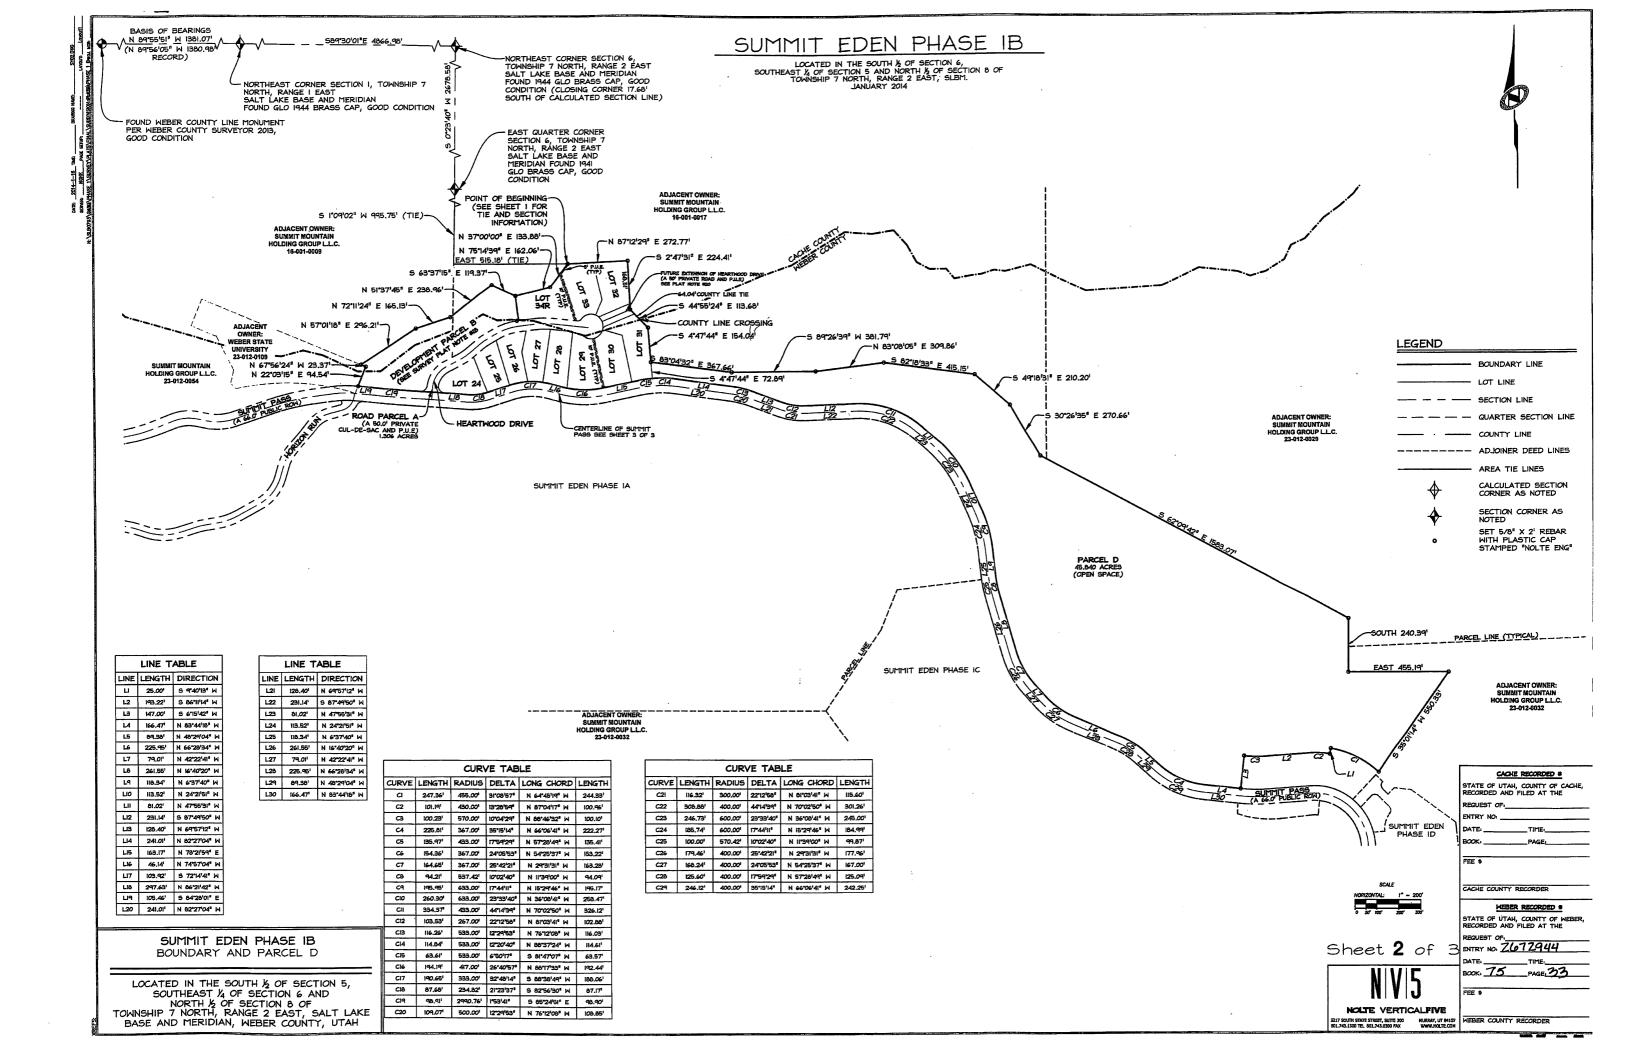

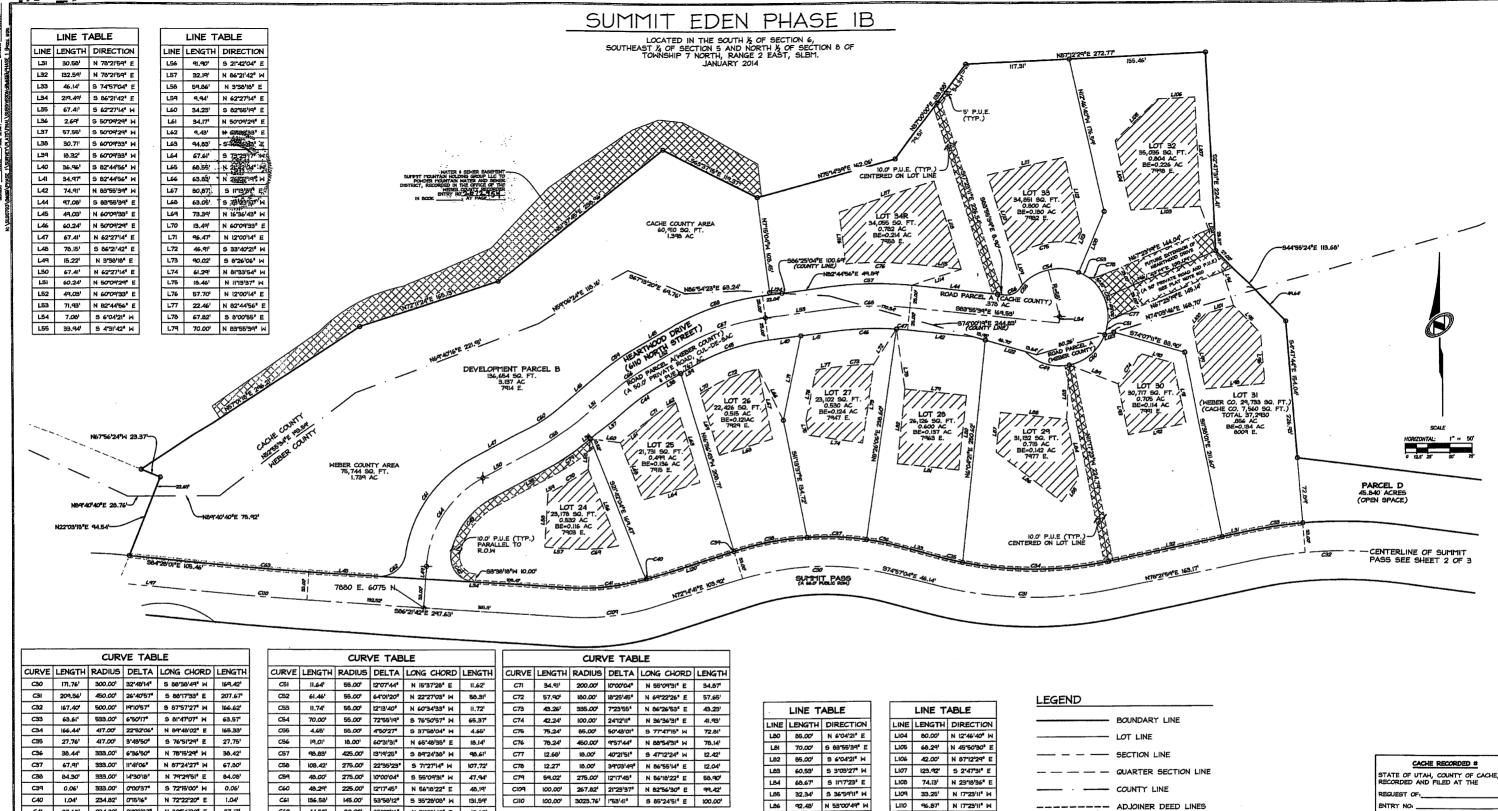

C41 87.68' 234.82' 21"23"37" N 82"56"30" E 87.17' C42 54.01 30.00 103°08'42" S 34°47'21" E 47.00 C43 75.72' 95.00' 45'40'14" S 39'37'07" W 73.74' C44 39.27' 225.00' 10'00'04" 5 55'09'31" W 39.22' C45 88.71 225.00 22*35*23° 5 71*27*14* W 88.14* C46 74.35' 375.00' ||1'21'36" \$ 88'25'44" M 74.23' C47 12.85' 375.00' 1'37'48' N 84'54'34' W 12.85'

C49 54.44' 55.00' 56'42'33" S 72'56'07" E 52.24'

CSO 54.74' 55.00' 57"01"17" N 50"11"58" E 52.51"

CURVE	LENGTH	RADIUS	DELTA	LONG CHORD	LENGTH
C51	11.641	55.00°	12*07'44"	N 15"37"28" E	11,621
C52	61.46'	55.00°	64°01'20"	N 22*27'03" W	58.31
C53	11.741	55.00°	12*13140*	N 60°34'33" W	11.72
C54	70.00¹	55.00¹	72°55'19°	S 76°50'57" W	65,37
C55	4.651	55.00 ⁴	4*50'27"	9 37"58"04" W	4.65'
C56	19.01	18.001	60"31"31"	N 65°48'35° E	18,141
C57	98,831	425.00 ¹	13"19"25"	5 89°24'38" W	98.61
C58	108.421	275.00 ⁴	22"35"23"	9 71°27'14" W	107.721
C54	48.00°	275.00°	10000104	S 55*09'31" W	47.94
C60	48,291	225.00 ¹	12°17'45"	N 56"18"22" E	48.19'
C61	136.58 ¹	145.00 ¹	53*5812"	5 35°28'08" M	131.59
C62	44.591	30.001	85'09'16"	N 51°03'40" E	40.60°
C63	98,91	2990,761	1'53'4(*	S 85"24"51" E	98.901
C64	123.181	120.001	58*48'56*	S 33"02"46" W	117.851
C65	53.65	250.00¹	12"17"45"	N 56'18'22" E	53.561
C66	43.64	250.00°	10°00'04"	S 55'09'31' W	43.58 ¹
C67	98.571	250.00¹	22"35'23"	9 71°27'14" W	97.931
C68	93.02°	400.001	13'19'25"	9 89"24"38" W	92.81
C69	51,59 ¹	189,821	15"34"22"	S 85"51'07" W	51.43'
C70	43.321	300.00¹	816'24"	N 58'19'02" E	43.261

			COK	L IAL	LE	
	CURVE	LENGTH	RADIUS	DELTA	LONG CHORD	LEN
	C71	34.911	200.00°	10°00'04"	N 55'09'31" E	34
	C72	57.90 ¹	180.001	18*25145*	N 69"22"26" E	57
	C73	43.26'	335.00 ^t	7"23'55"	N 86"26"53" E	43
	C74	42.24¹	100,001	24"2"11"	N 36"36"31" E	41.
	C75	75.24 ¹	85.00 ¹	50°43'01°	9 77°47°15° W	72
	C76	78.24¹	450.00¹	9"57"44"	N 88"54"31" W	78
П	CTI	12.68 ¹	18.00°	40"21"51"	5 47"12"24" W	12.
П	C78	12.27	18.00°	3903'49"	N 86"55"14" E	12.
П	C79	59.02°	275.00¹	12"17"45"	N 56"18"22" E	68
	C109	100.001	267.82	21°23'37°	N 82"56'30" E	99
	CIIO	100,00'	3023.761	1°53'41"	S 85"24"51" E	100
ľ						

- 1	LBI	70.00¹	9 83"55"39" E
	L82	85.00¹	9 6'04'21" W
[L83	60.531	5 3'03'27° W
	LB4	68.67	S 11171231 E
[L85	32.34 ¹	S 36'59'11" W
[L86	92.481	N 53°00'49" W
[L87	45.78 ¹	N 6'04'21" E
[L88	75.47	S 83'55'39° E
[L89	59.15	9 68'59'41" E
[L90	39.62	9 74'07'II" E
[Lei	68.961	9 11°38'01" E
[L92	66.77 ¹	9 78"21"59" W
	L93	59.341	N II'17'23' W
Π	L94	66.061	9 17'54'49" E
	L95	43.87	N 44'55'24" W
- [L96	56.221	N 4'47'44" W
- [L97	114.111	9 84°28'01" E
[L98	68.76¹	N 85°12'16" E
[L99	70.44¹	5 11"38"01" E
[LICO	20.651	9 45°04'36" W
	L101	33.72 ¹	S 74°03'46° W
	L102	52.67 ¹	N 19720113" W
	LIØS	79,38 ¹	5 87"12"29" W

LINE	LENGTH	DIRECTION
L104	80.001	N 12°46'40" W
LIOS	68.29¹	N 45°50'30° E
LI06	42.00¹	N 87°12'29° E
LI07	123.92 ¹	5 2'47'31" E
LICB	74.131	N 23"18"36" E
LIO9	33.251	N 17*23'11" W
LIIO	96.871	N 17"23"11" W
LIII	89.49	N 77"13"20" E
LII2	85.061	S 12°46'40° E
LII3	15.11	9 2318136" W
LI14	59.081	N 71'02'16" E
LIIS	53.531	S 83"55"39" E
LII6	58.07¹	N 7"15"04" W
LII7	113.00°	N 72°36'49° E
LIIB	103.24	5 17'23'11' E
LI20	103.921	N 72"14"41" E
LI22	46.70	S 74'00'19" E
L123	10.561	N 74°03'46" E
LI24	13.971	S 86"25'04" E

	BOUNDARY LINE		
	LOT LINE		
	SECTION LINE		_
	QUARTER SECTION LINE		STA
	COUNTY LINE		REG
	ADJOINER DEED LINES		ENT
800000000	NO ACCESS LINE		DAT
	AREA TIE LINES		FEE
\(\phi \)	CALCULATED SECTION CORNER AS NOTED	61963	
♦	SECTION CORNER AS NOTED		CAC
+	STREET MONUMNET		STA
•	SET 5/8" X 2' REBAR WITH PLASTIC CAP STAMPED "NOLTE ENG"	Sheet 3 of 3	REG ENT

BUILDING ENVELOPE

P.U.E AND FUTURE EXTENSION OF HEARTWOOD DRIVE

CHE COUNTY DECORDED WEBER RECORDED # Sheet 3 of 104,00 NOLTE VERTICALFIVE 5217 SOUTH STATE STREET, SUITE 300 MURRAY, UT 94107 501.743.1300 TEL 801.743.0300 FAX WWW.NOLTE.COH


ATE OF UTAH, COUNTY OF WEBER CORDED AND FILED AT THE QUEST OF SMHG THILL 3 DATE: 21 20 2011 TIME: 10:21 AM PAGE: 34


ERNEST D ROWLEY


SUMMIT EDEN PHASE IB DEVELOPMENT PARCEL B, ROAD PARCEL A AND LOTS 24 TO 34


LOCATED IN THE SOUTH & OF SECTION 5, SOUTHEAST & OF SECTION 6 AND NORTH & OF SECTION 8 OF TOWNSHIP 7 NORTH, RANGE 2 EAST, SALT LAKE BASE AND MERIDIAN, WEBER COUNTY, UTAH


	AREA	A PER COUNT	Υ	
LOT #	WEBER COUNTY ACRES	CACHE COUNTY ACRES	WEBER COUNTY SQ.FT.	CACHE COUNTY SQ.FT
ROAD PARCEL "A"	0.767	0.378	33,397	16,446
DEVELOPMENT PARCEL "B"	1.739	1.398	75,744	60,910
31	0.682	0.174	29,733	7,560

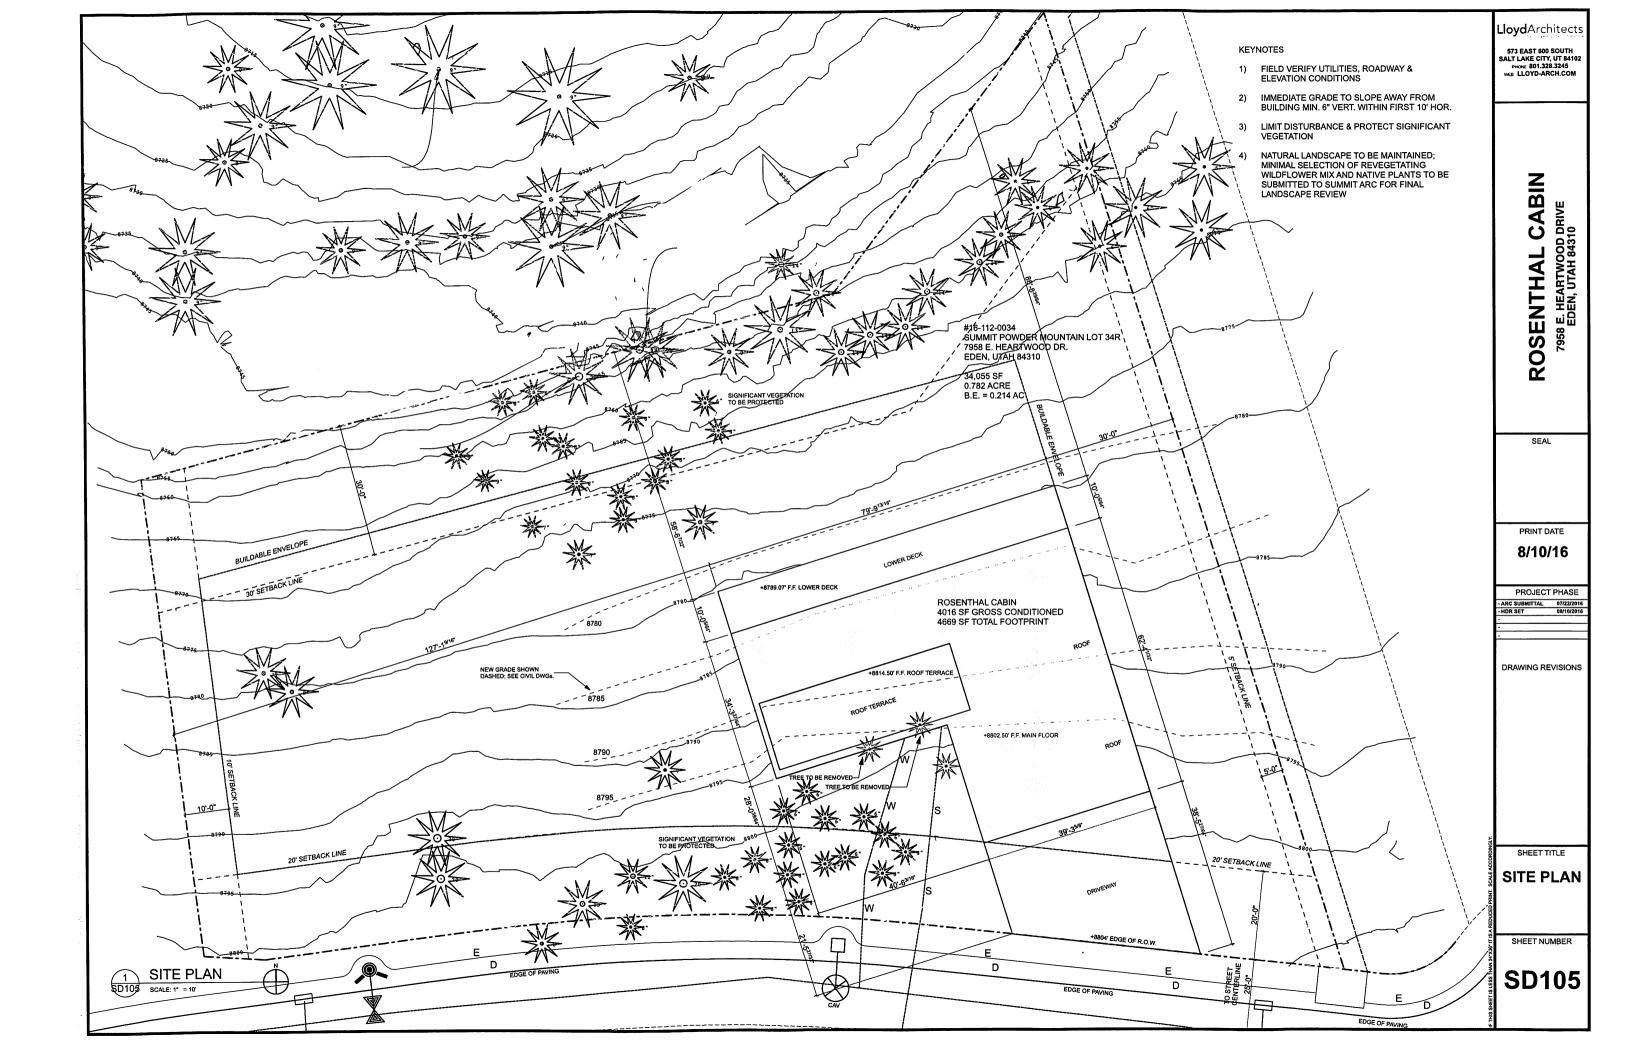


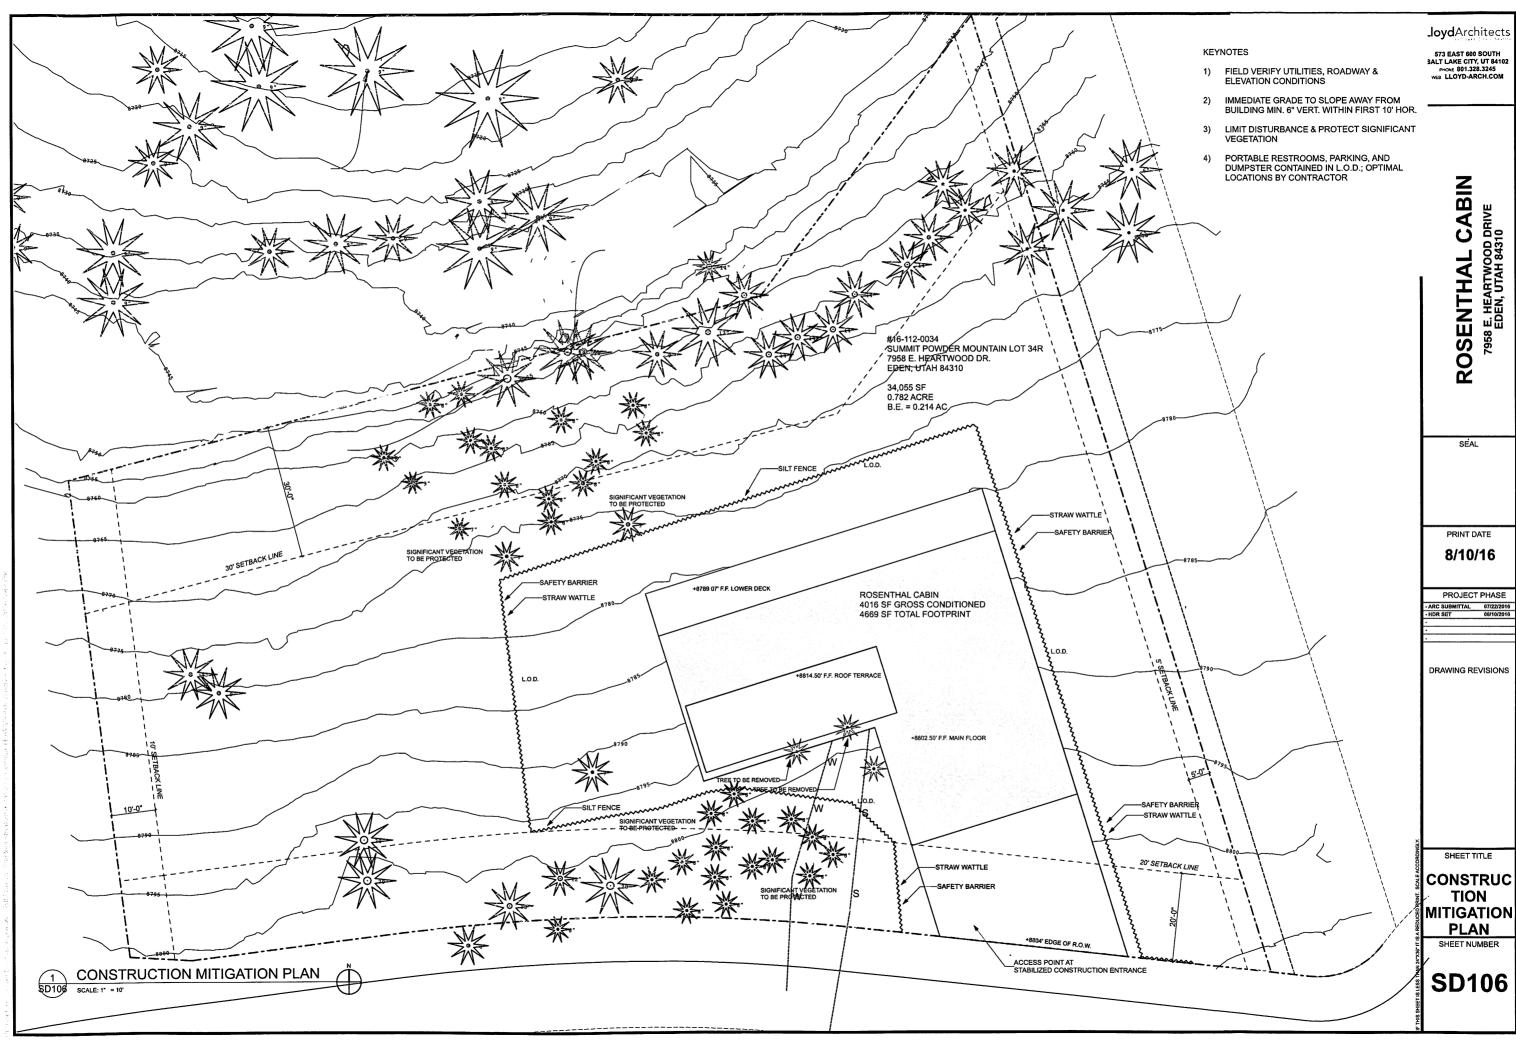


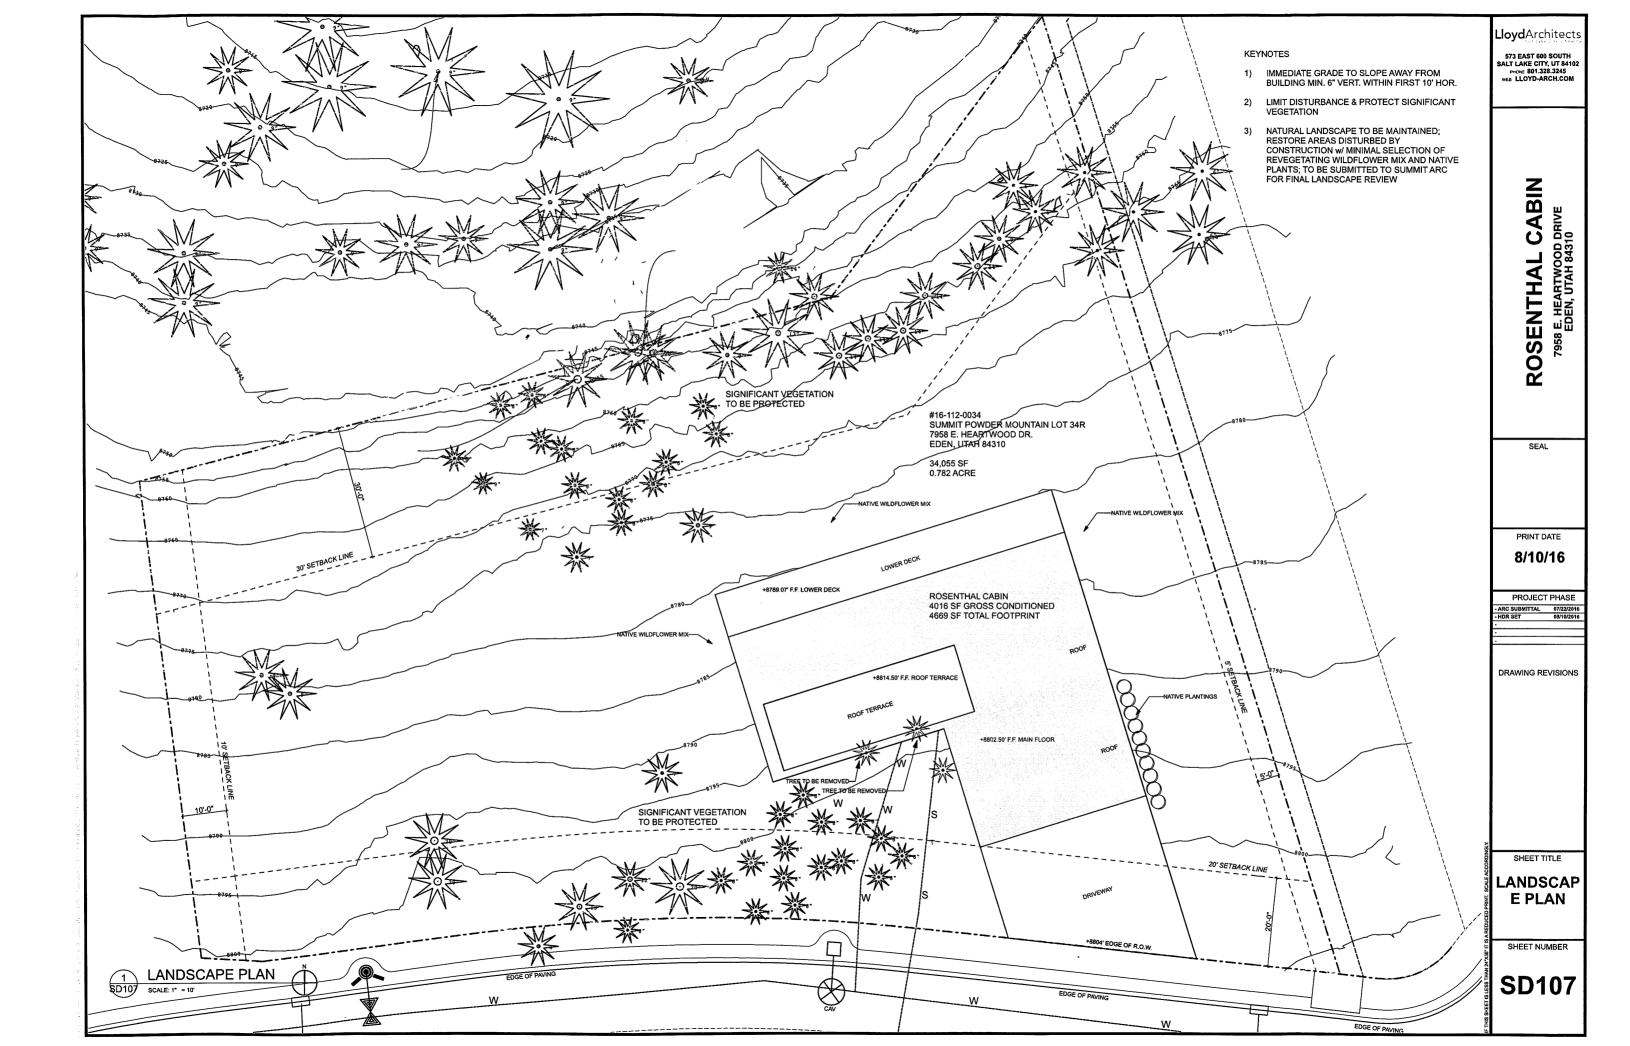

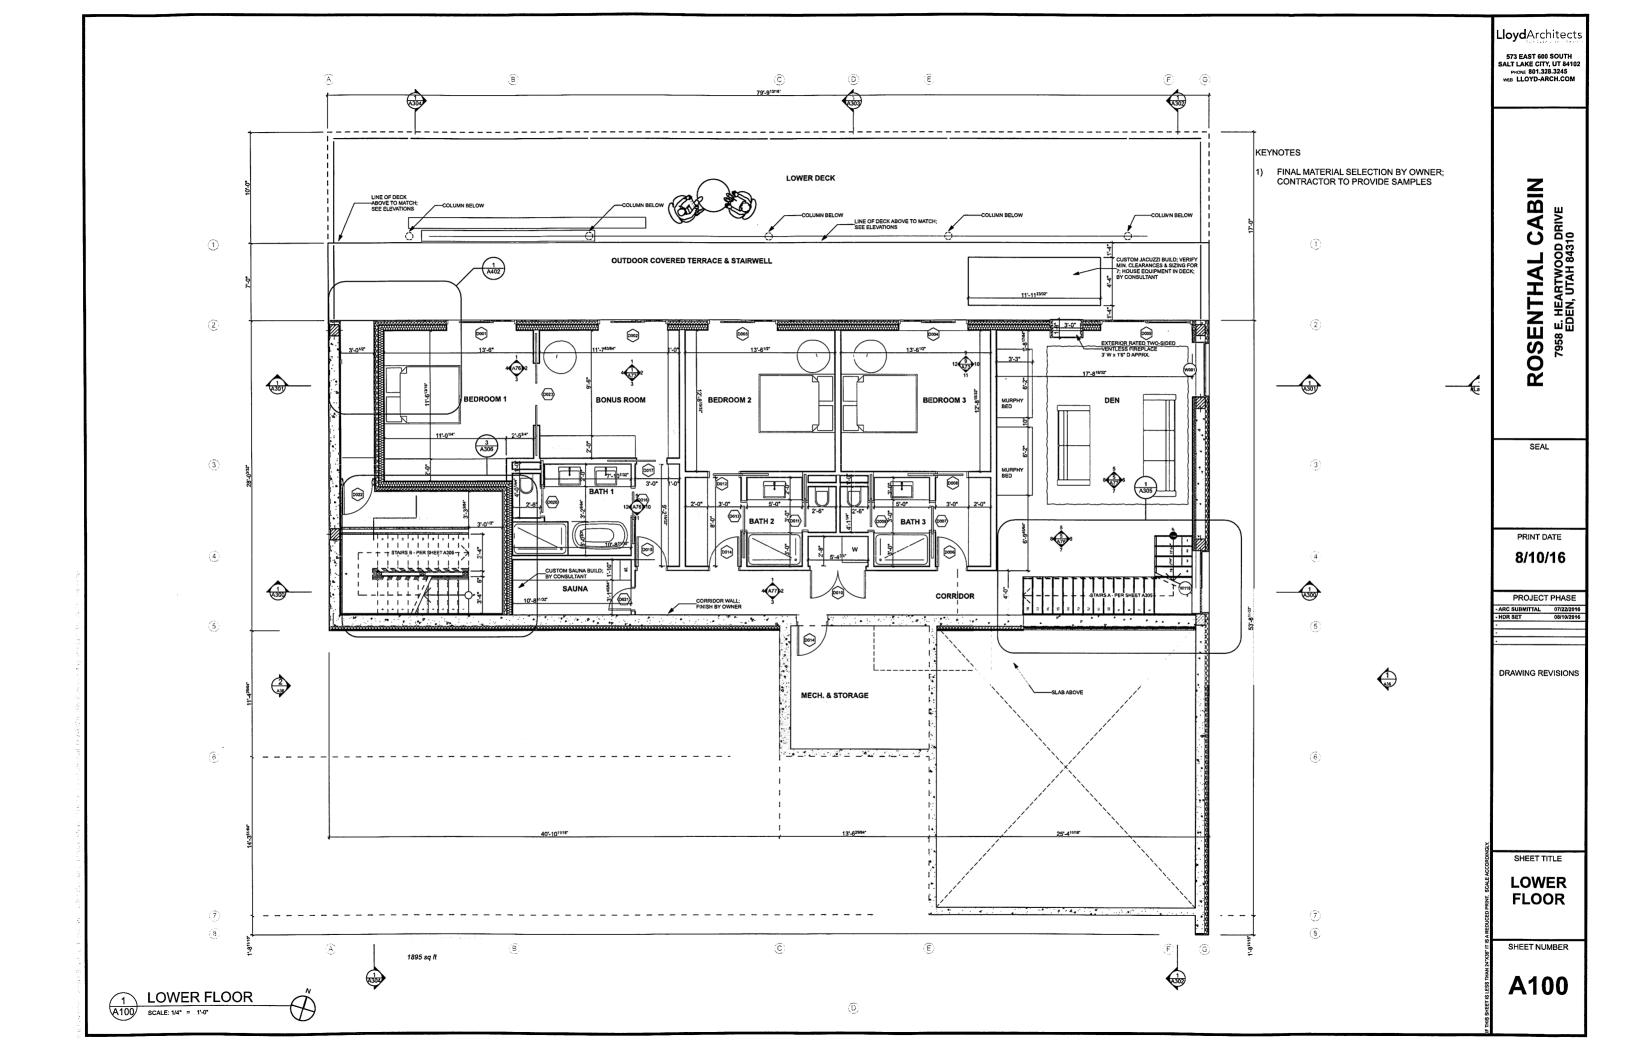

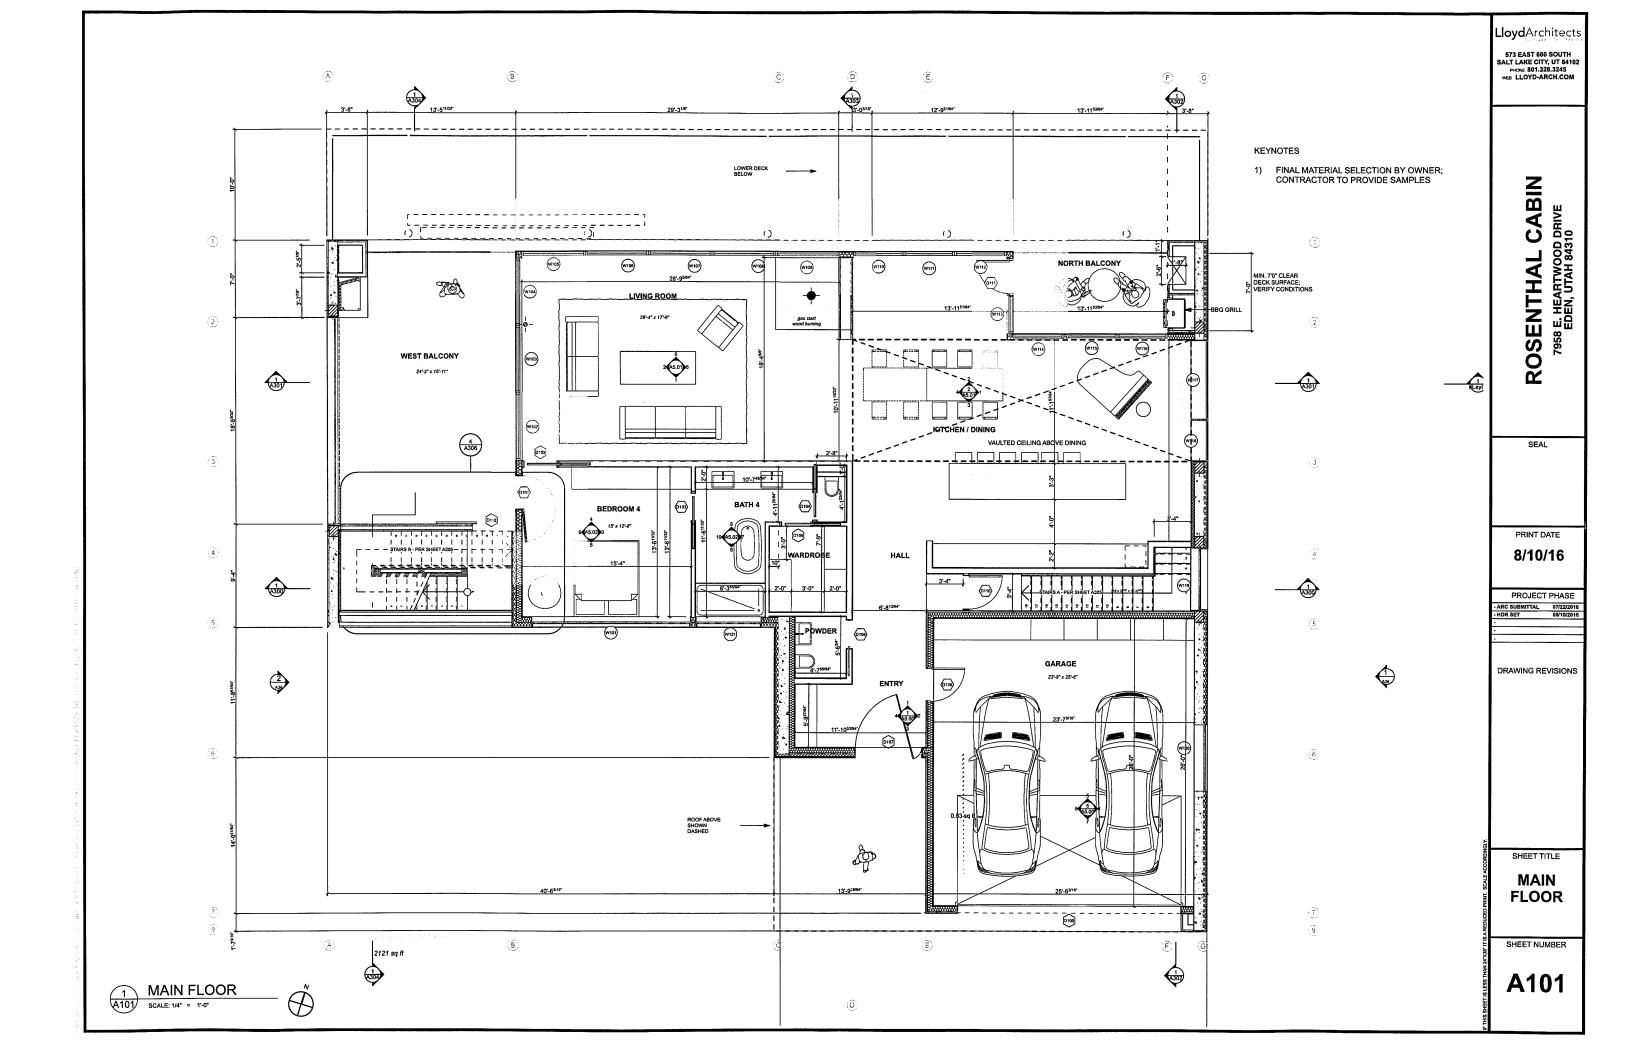

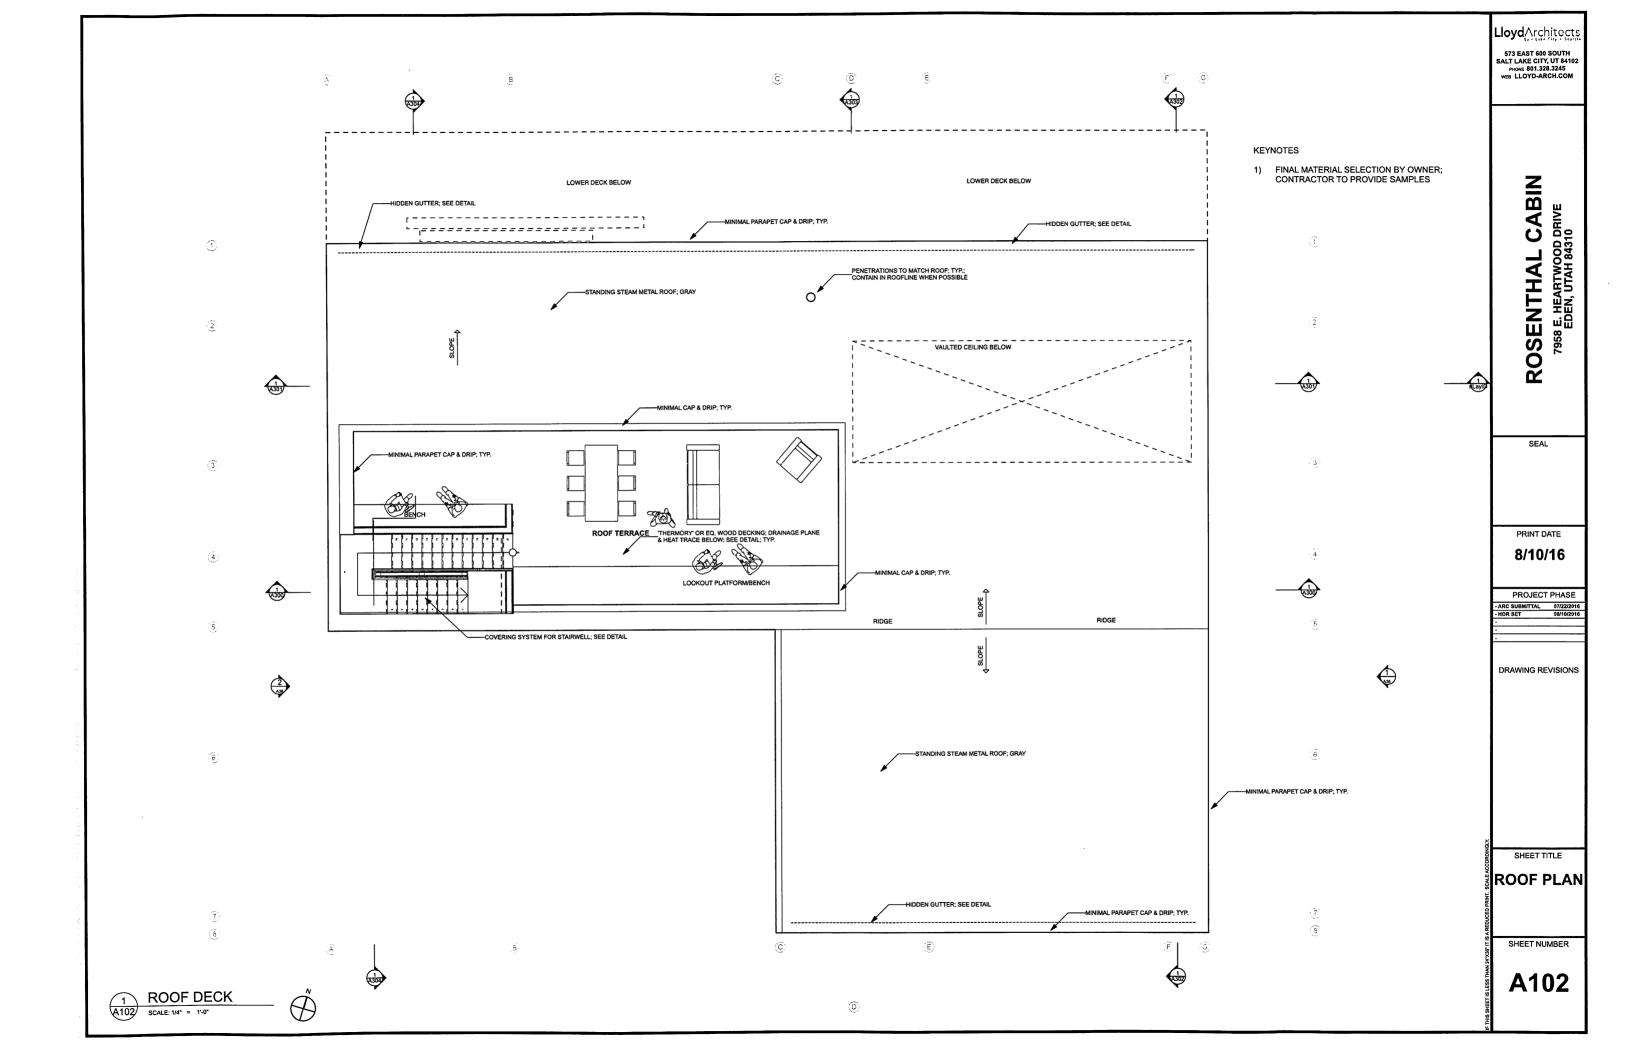

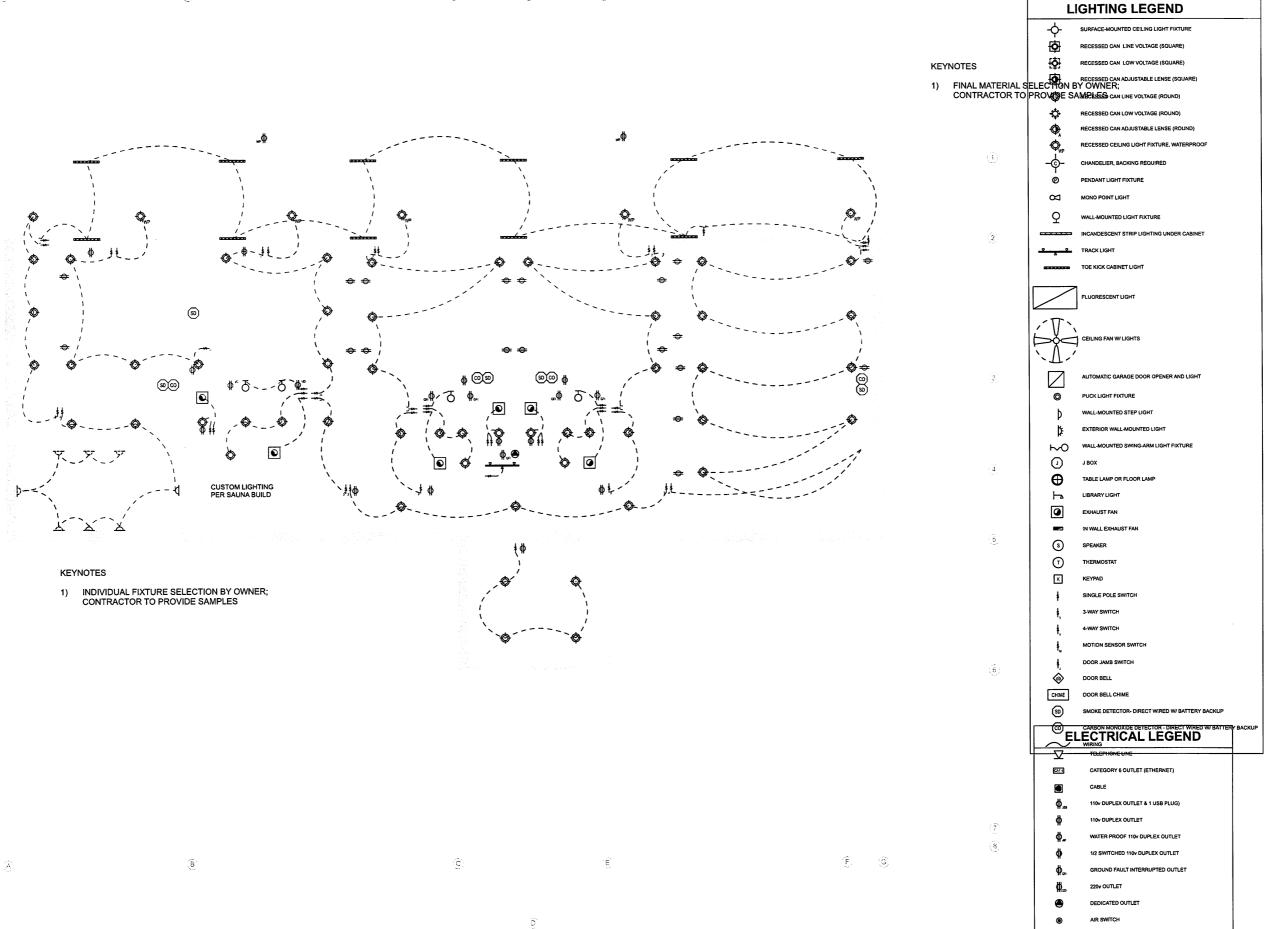

573 EAST 600 SOUTH SALT LAKE CITY, UT 84102 PHONE 801.328.3245 WEB LLOYD-ARCH.COM

ROSENTHAL CABIN
7958 E. HEARTWOOD DRIVE EDEN, UTAH 84310

SEAL

PRINT DATE **8/10/16**

PROJECT PHASE

-ARC SUBMITTAL 07/22/2016

-HDR SET 08/10/2016

DRAWING REVISIONS

SHEET TITLE


LOWER FLOOR ELEC. & RCP.


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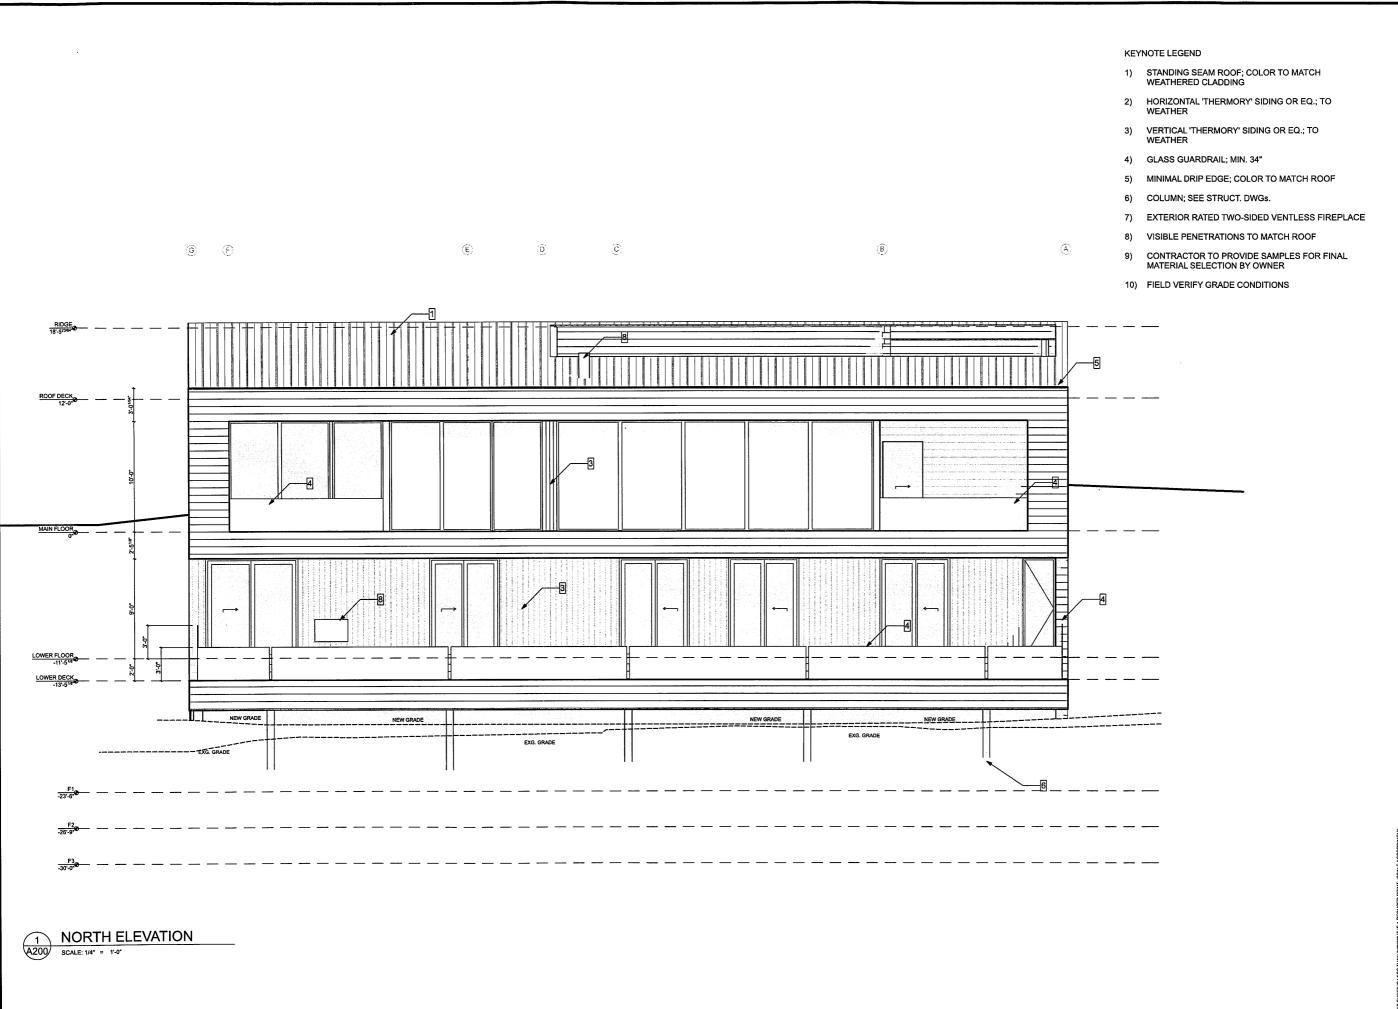
A103

1 LOWER FLOOR ELEC. & RCP.

A103 SCALE: 1/4" = 1'-0"



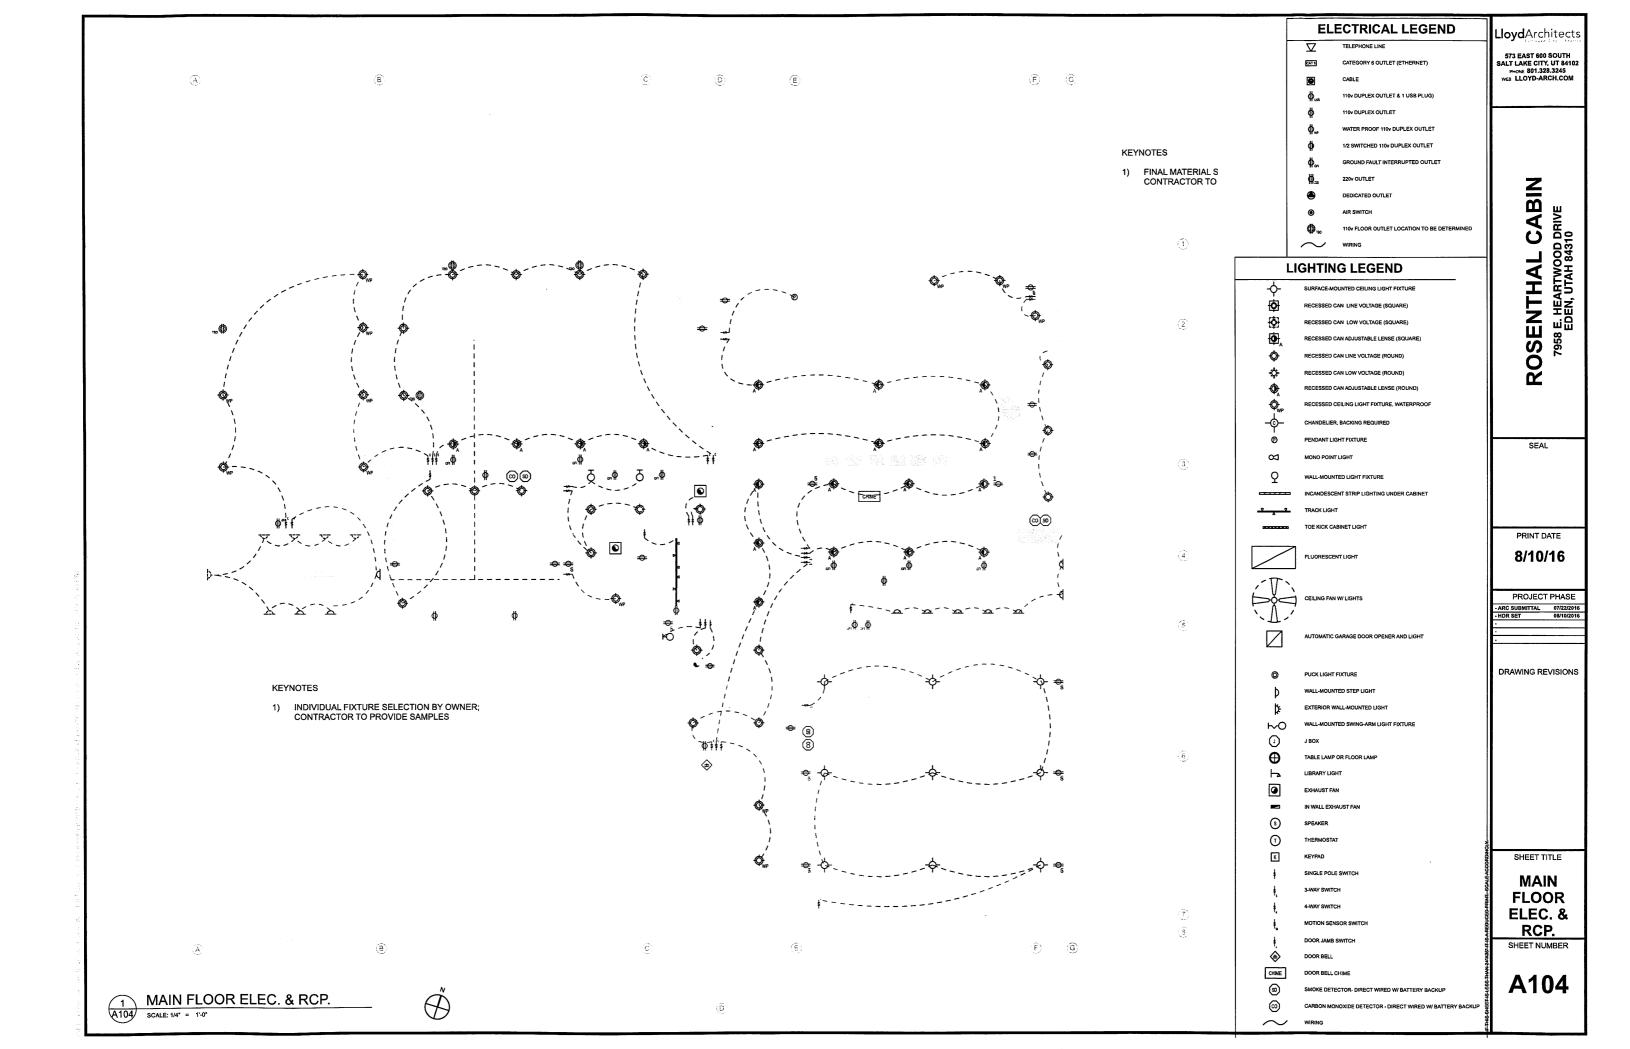

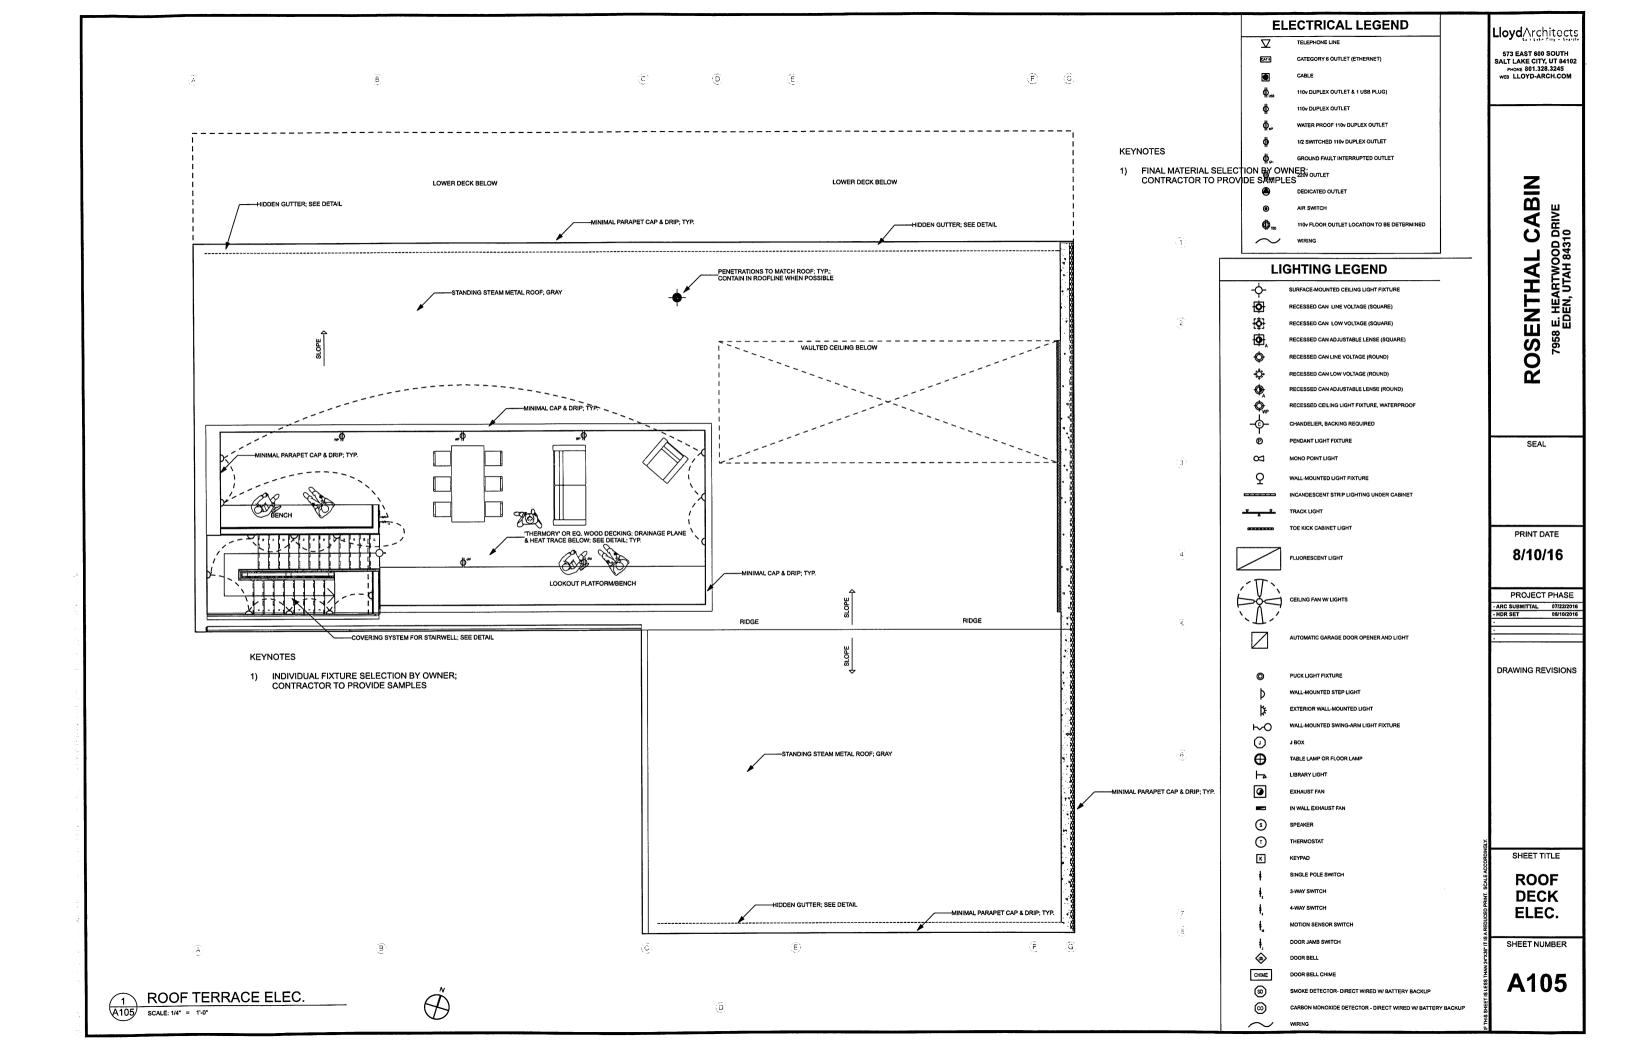

573 EAST 600 SOUTH SALT LAKE CITY, UT 84102 PHONE 801.328.3245 WEB LLOYD-ARCH.COM

ROSENTHAL CABIN
7958 E. HEARTWOOD DRIVE EDEN, UTAH 84310

SEAL

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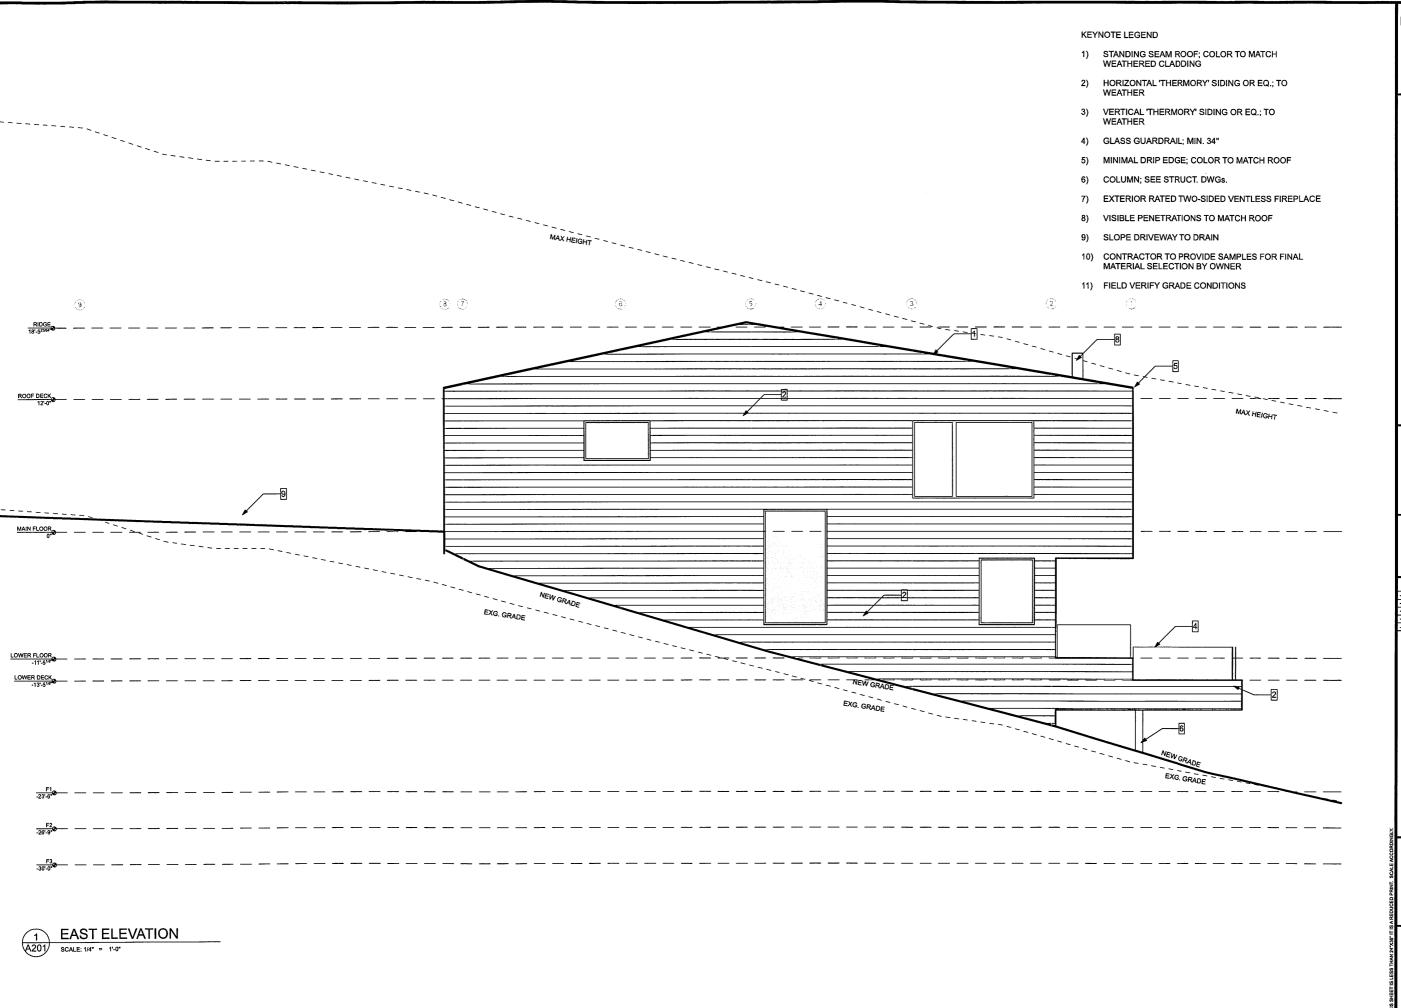
PROJECT PHASE

DRAWING REVISIONS

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ELEVATION S

SHEET NUMBER



573 EAST 600 SOUTH SALT LAKE CITY, UT 84102 PHONE 801.328.3245 WEB LLOYD-ARCH.COM

ROSENTHAL CABIN 7958 E. HEARTWOOD DRIVE EDEN, UTAH 84310

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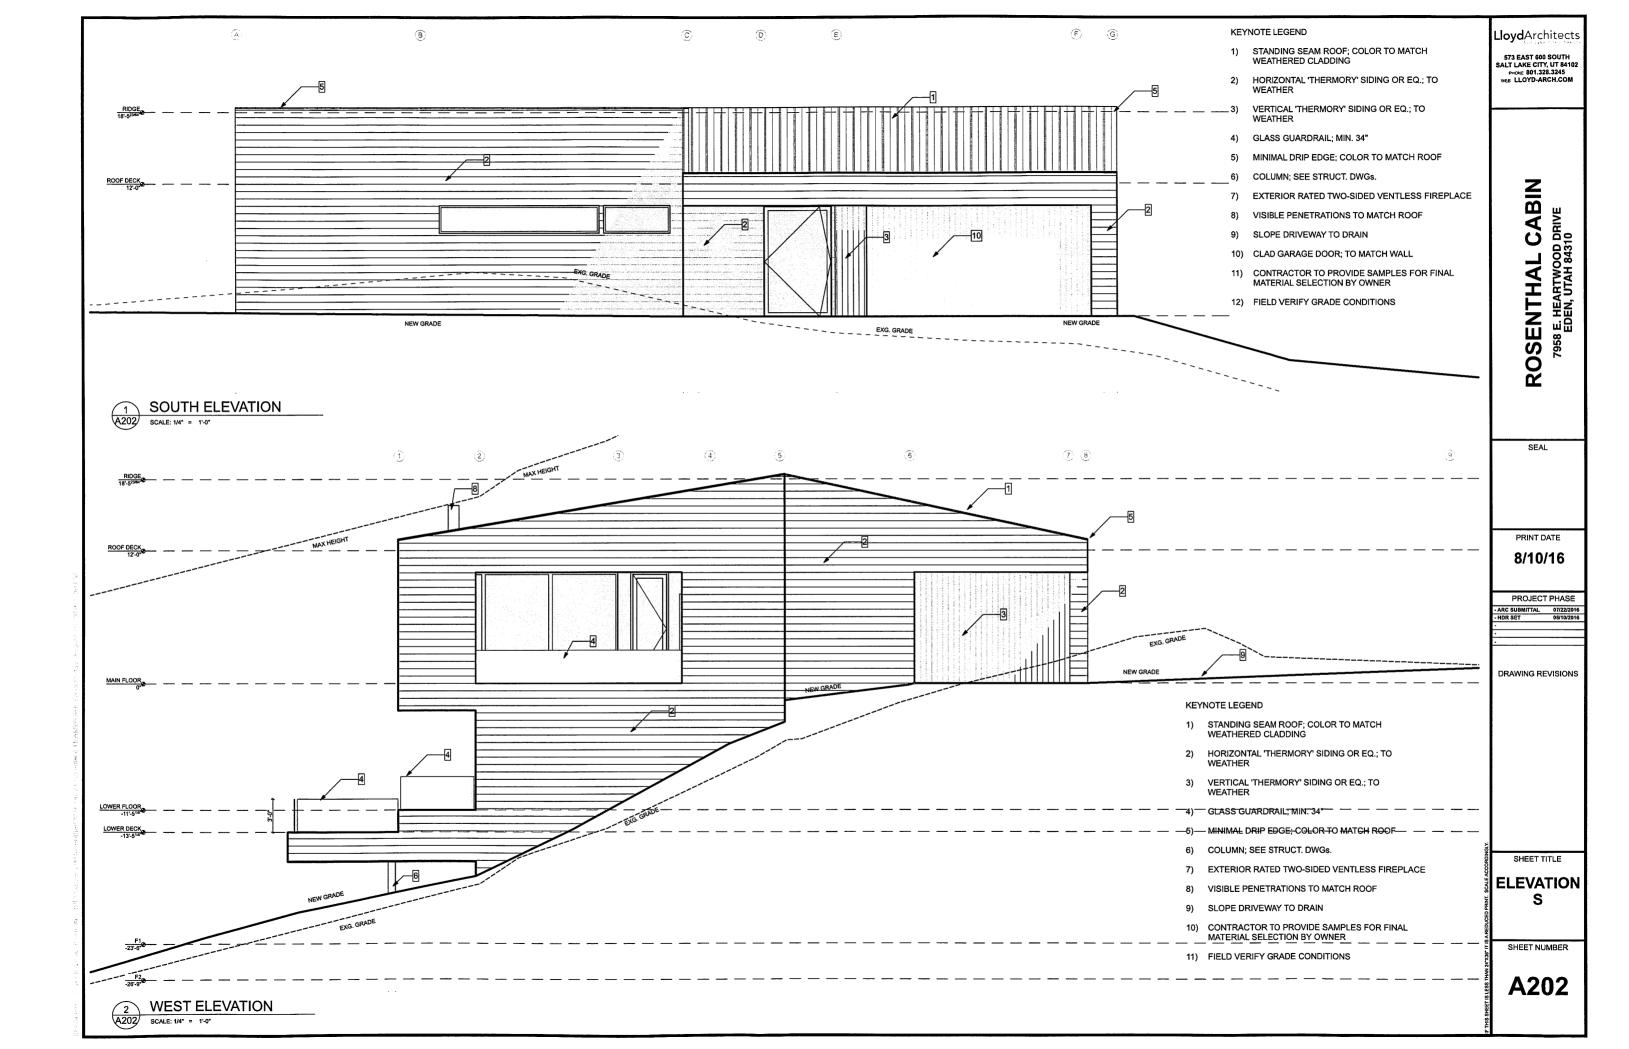
PROJECT PHASE


DRAWING REVISIONS

SHEET TITLE

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SHEET NUMBER



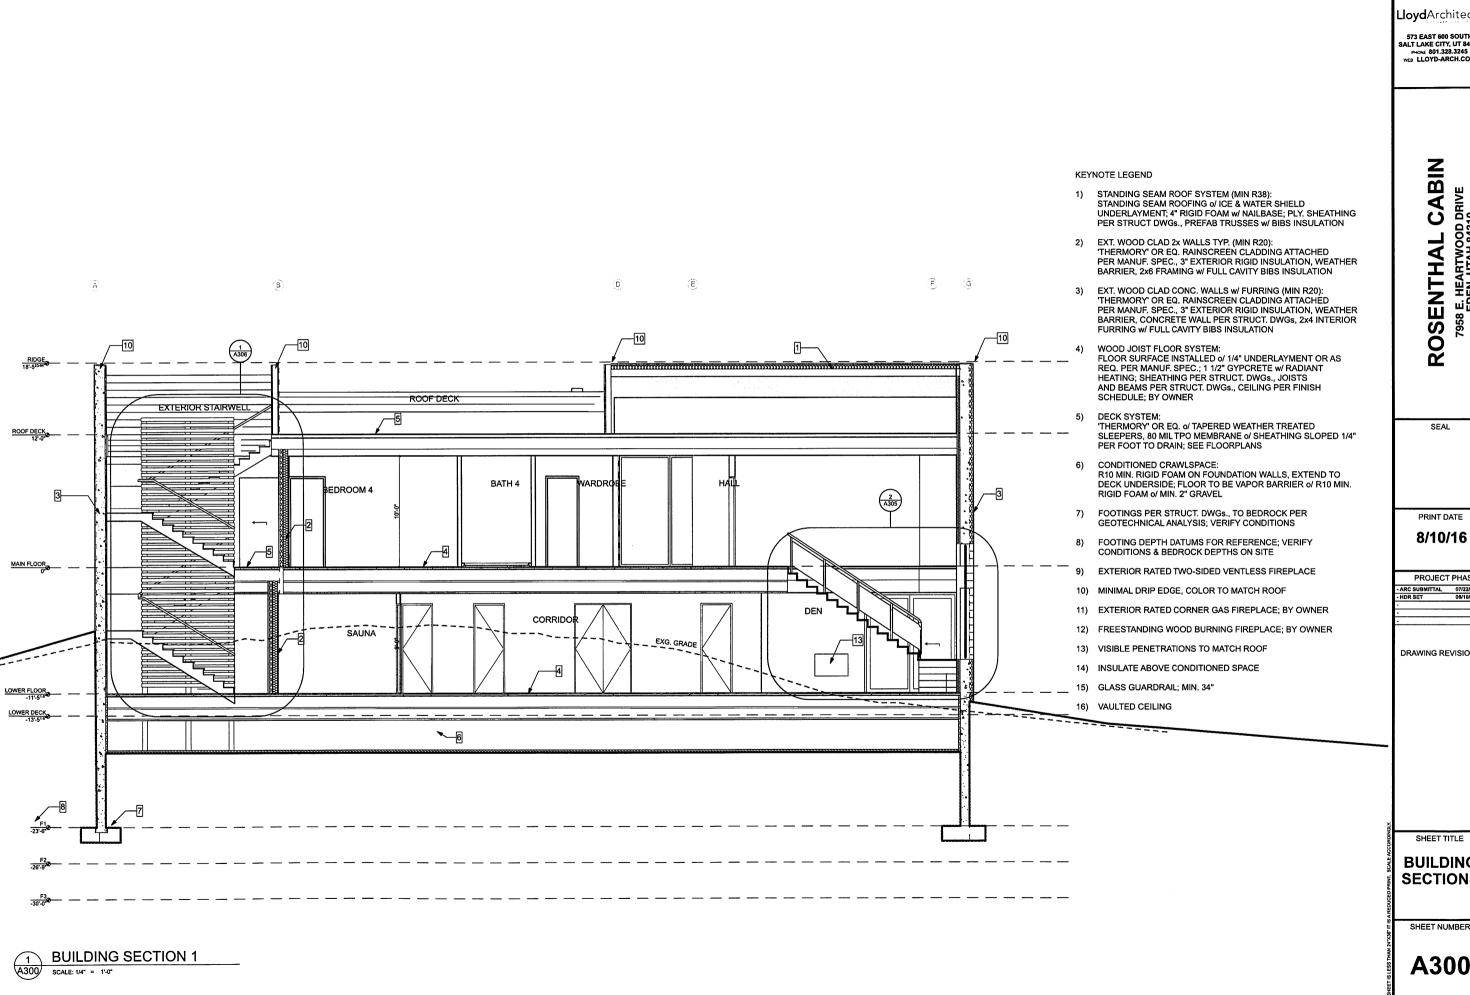

573 EAST 600 SOUTH SALT LAKE CITY, UT 84102 PHONE 801.328.3245 WEB LLOYD-ARCH.COM

OSENTHAL CABIN 7958 E. HEARTWOOD DRIVE EDEN, UTAH 84310 ROSENTHAL

PRINT DATE


PROJECT PHASE

DRAWING REVISIONS

SHEET TITLE

BUILDING **SECTIONS**

SHEET NUMBER

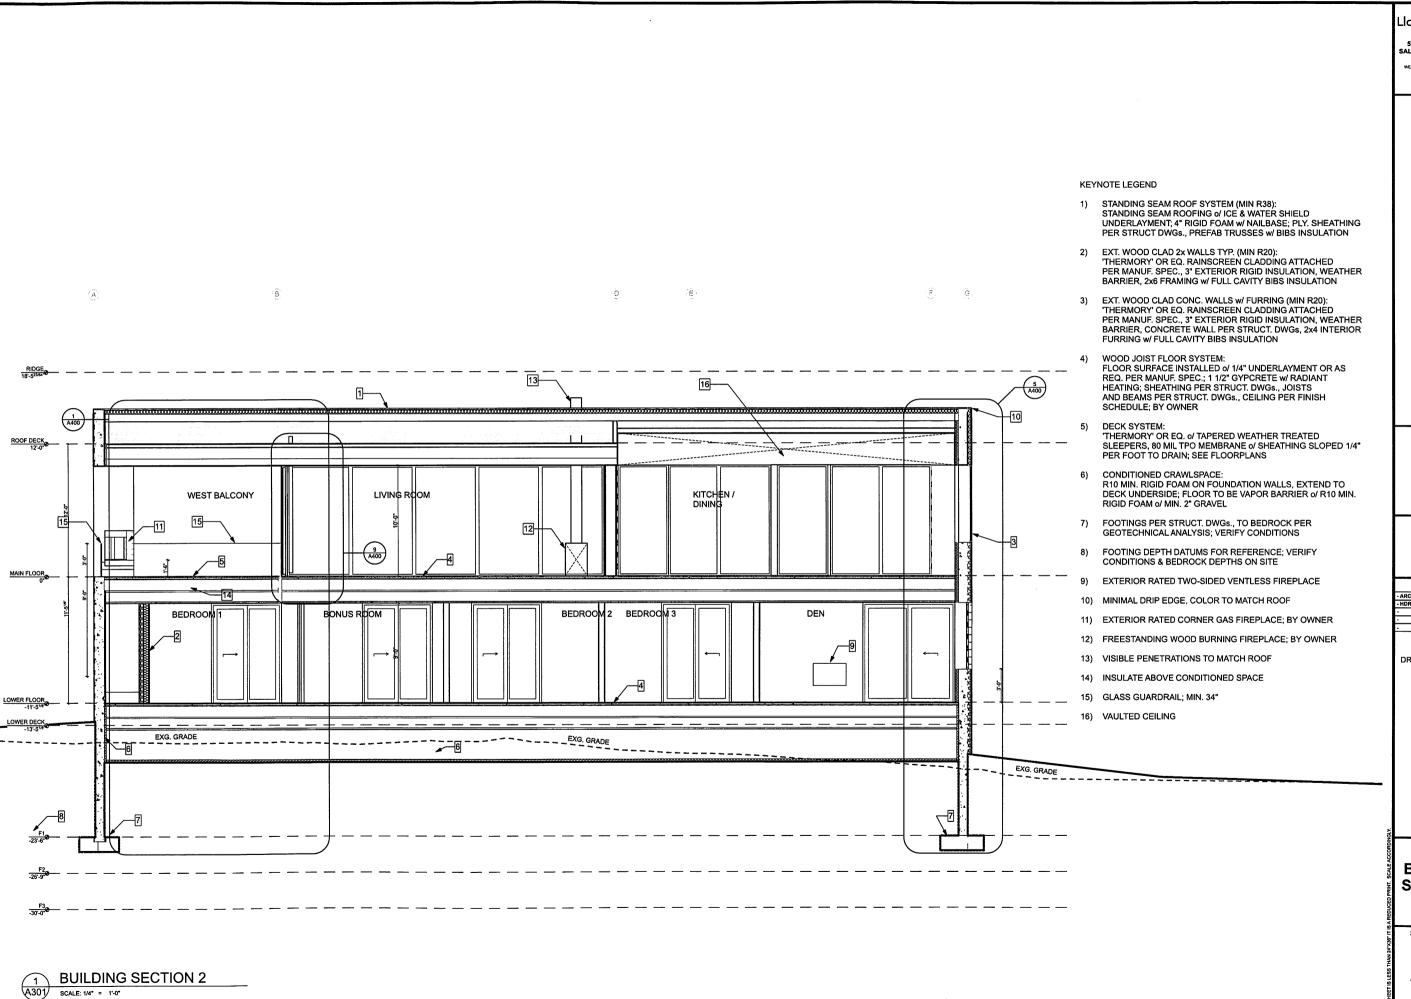

573 EAST 600 SOUTH
SALT LAKE CITY, UT 84102
PHONE 801.328.3245
WEB LLOYD-ARCH.COM

ROSENTHAL CABIN
7958 E. HEARTWOOD DRIVE
EDEN, UTAH 84310

SEAL

PRINT DATE **8/10/16**


PROJECT PHASE

DRAWING REVISIONS

SHEET TITLE

BUILDING SECTIONS

SHEET NUMBER

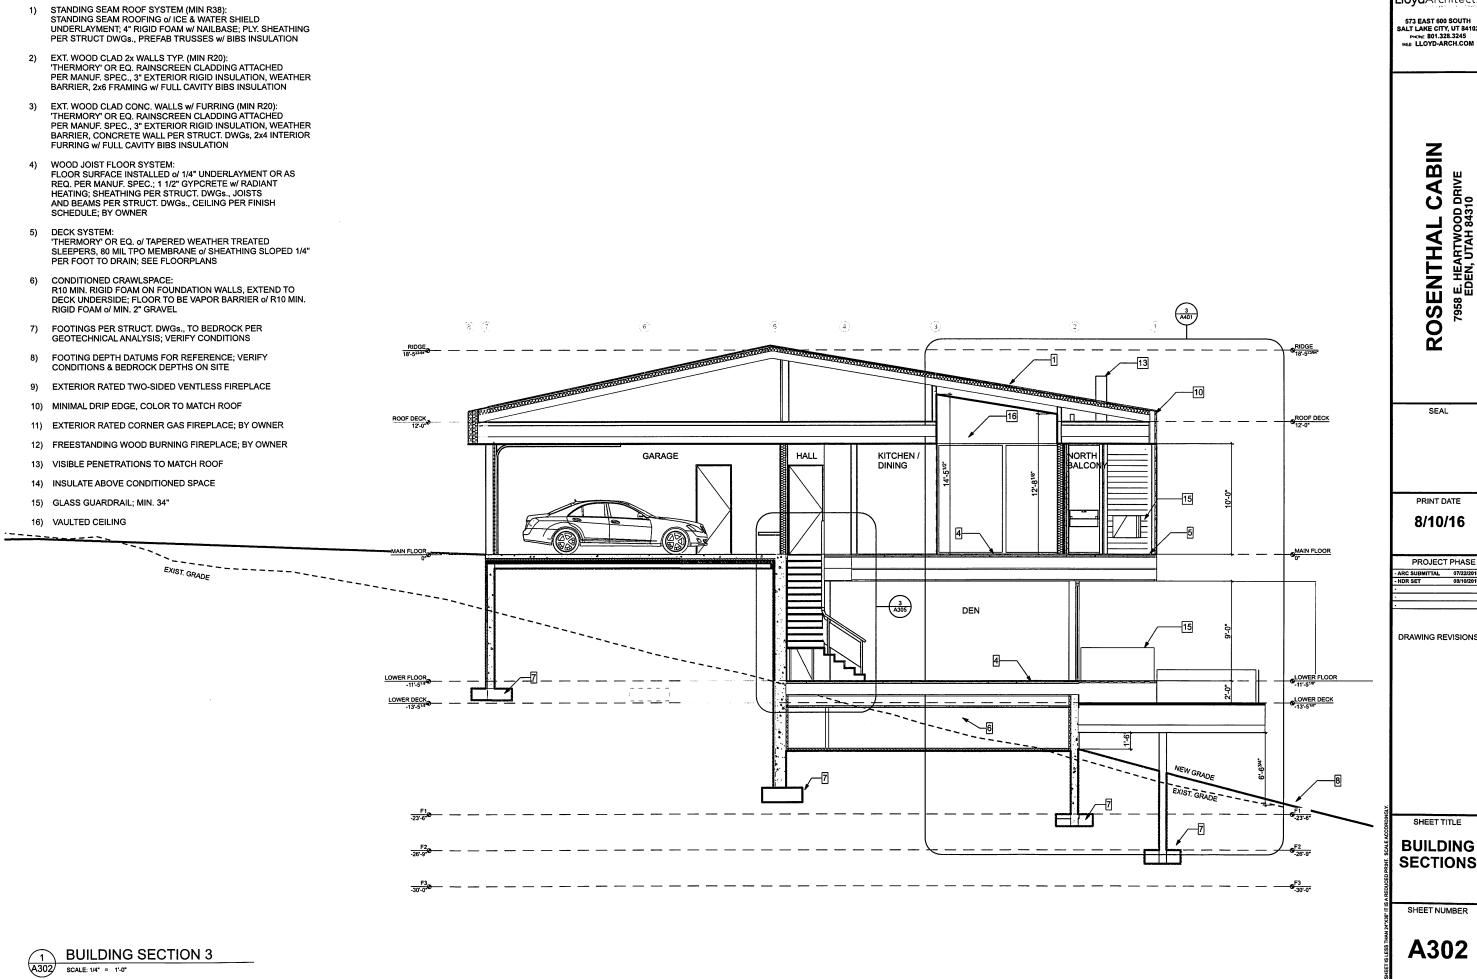

KEYNOTE LEGEND


LloydArchitects

573 EAST 600 SOUTH SALT LAKE CITY, UT 84102 PHONE 801.328.3245 WEB LLOYD-ARCH.COM

E. HEARTWOOD DRIVE EDEN, UTAH 84310

DRAWING REVISIONS

BUILDING SECTIONS

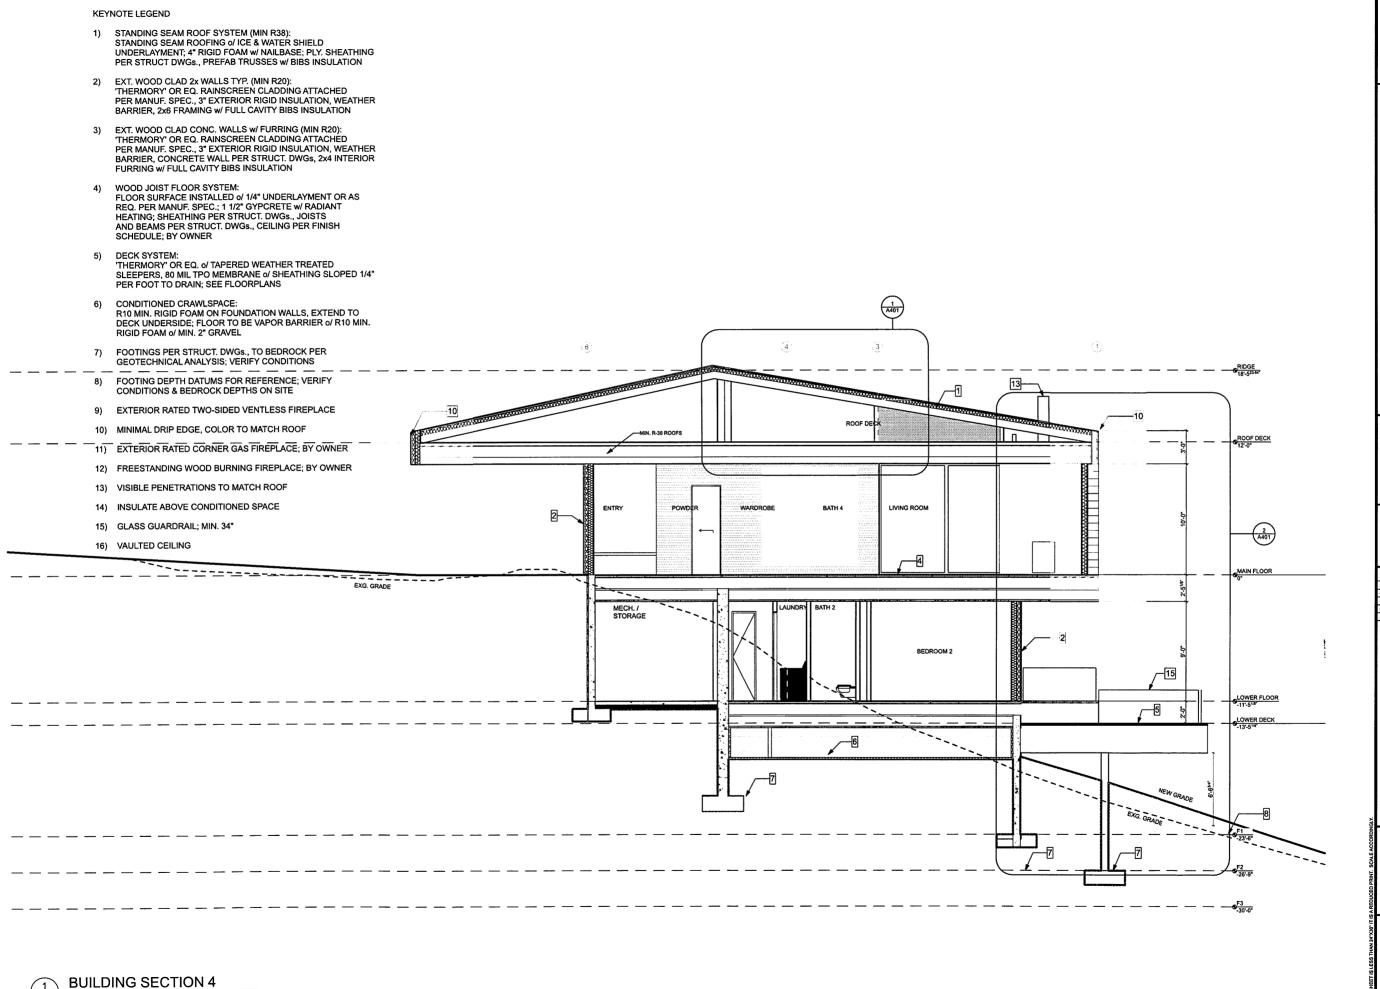

SCALE: 1/4" = 1'-0"

LloydArchitects

573 EAST 600 SOUTH SALT LAKE CITY, UT 84102 PHONE 801.328.3245 WEB LLOYD-ARCH.COM

IAL CABIN

ROSENTHAL C
7958 E. HEARTWOOD DI
EDEN, UTAH 84310

SEAL

PRINT DATE 8/10/16

PROJECT PHASE

ARC SUBMITTAL 07/22/2016
HDR SET 08/10/2016

DRAWING REVISIONS

SHEET TITLE

BUILDING SECTIONS

SHEET NUMBER

CABIN

E. HEARTWOOD DRIVE EDEN, UTAH 84310 ROSENTHAL

SEAL

PRINT DATE 8/10/16

PROJECT PHASE ARC SUBMITTAL 07/22/20 HDR SET 08/10/20

DRAWING REVISIONS

SHEET TITLE


BUILDING SECTIONS

SHEET NUMBER

A304

KEYNOTE LEGEND

- STANDING SEAM ROOF SYSTEM (MIN R38): STANDING SEAM ROOFING O/ ICE & WATER SHIELD UNDERLAYMENT; 4" RIGID FOAM w/ NAILBASE; PLY. SHEATHING PER STRUCT DWGs., PREFAB TRUSSES w/ BIBS INSULATION
- 2) EXT. WOOD CLAD 2x WALLS TYP. (MIN R20):
 "THERMORY" OR EQ. RAINSCREEN CLADDING ATTACHED
 PER MANUF. SPEC., 3" EXTERIOR RIGID INSULATION, WEATHER
 BARRIER, 2x6 FRAMING w/ FULL CAVITY BIBS INSULATION
- 3) EXT. WOOD CLAD CONC. WALLS w/ FURRING (MIN R20): 'THERMORY' OR EQ. RAINSCREEN CLADDING ATTACHED PER MANUF. SPEC., 3" EXTERIOR RIGID INSULATION, WEATHER BARRIER, CONCRETE WALL PER STRUCT. DWGs, 2x4 INTERIOR FURRING W/ FULL CAVITY BIBS INSULATION
- WOOD JOIST FLOOR SYSTEM: FLOOR SURFACE INSTALLED o/ 1/4" UNDERLAYMENT OR AS REQ. PER MANUF. SPEC.; 1 1/2" GYPCRETE W/ RADIANT HEATING; SHEATHING PER STRUCT. DWGs., JOISTS AND BEAMS PER STRUCT. DWGs., CEILING PER FINISH SCHEDULE; BY OWNER
- 5) DECK SYSTEM:
 THERMORY OR EQ. of TAPERED WEATHER TREATED
 SLEEPERS, 80 MIL TPO MEMBRANE of SHEATHING SLOPED 1/4" PER FOOT TO DRAIN; SEE FLOORPLANS
- CONDITIONED CRAWLSPACE: R10 MIN. RIGID FOAM ON FOUNDATION WALLS, EXTEND TO DECK UNDERSIDE; FLOOR TO BE VAPOR BARRIER o/ R10 MIN. RIGID FOAM o/ MIN. 2" GRAVEL
- 7) FOOTINGS PER STRUCT. DWGs., TO BEDROCK PER GEOTECHNICAL ANALYSIS; VERIFY CONDITIONS
- FOOTING DEPTH DATUMS FOR REFERENCE; VERIFY CONDITIONS & BEDROCK DEPTHS ON SITE
- 9) EXTERIOR RATED TWO-SIDED VENTLESS FIREPLACE
- 10) MINIMAL DRIP EDGE, COLOR TO MATCH ROOF
- 11) EXTERIOR RATED CORNER GAS FIREPLACE; BY OWNER
- 12) FREESTANDING WOOD BURNING FIREPLACE; BY OWNER
- 13) VISIBLE PENETRATIONS TO MATCH ROOF
- 14) INSULATE ABOVE CONDITIONED SPACE
- 15) GLASS GUARDRAIL; MIN. 34"
- 16) VAULTED CEILING

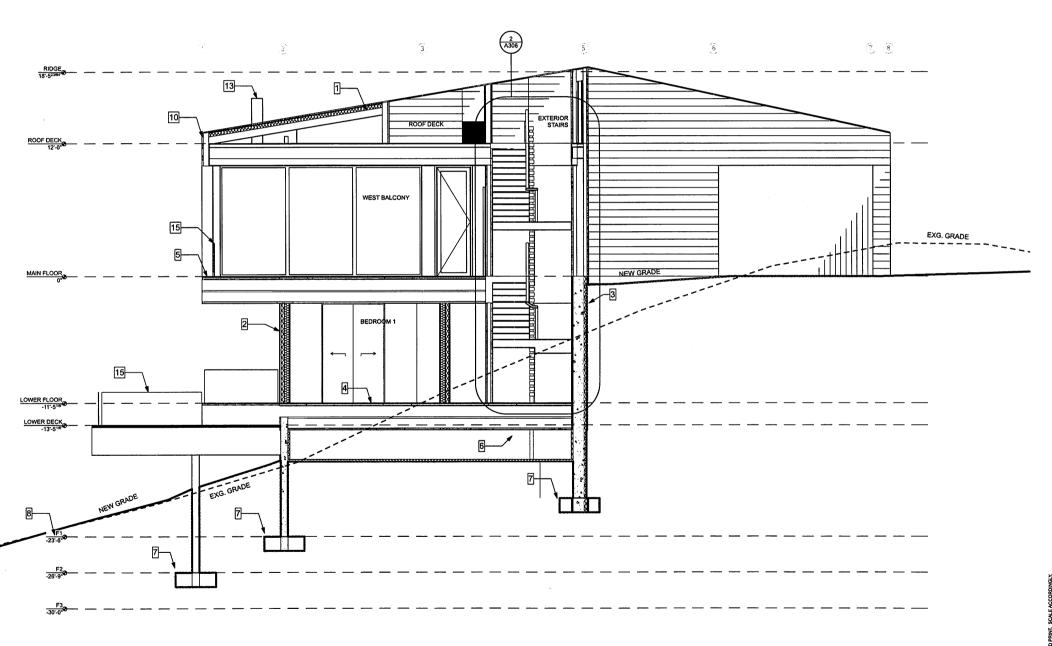

BUILDING SECTION 5

A304 SCALE: 1/4" = 1'-0"

KEYNOTES

- COORDINATE FINAL DETAILING & DESIGN OF STAIR w/ FABRICATOR
- MATERIAL & FINISH SELECTIONS BY OWNER; CONTRACTOR TO PROVIDE SAMPLES

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ROSENTHAL CABIN 7958 E. HEARTWOOD DRIVE EDEN, UTAH 84310

SEAL

PRINT DATE 8/10/16

PROJECT PHASE


DRAWING REVISIONS


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STAIR **SECTION & PLANS**


SHEET NUMBER

A305



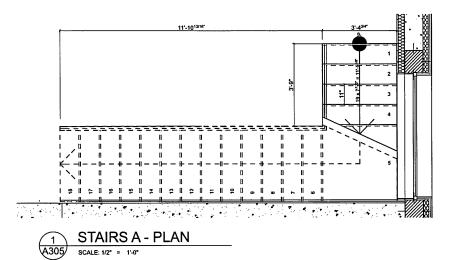

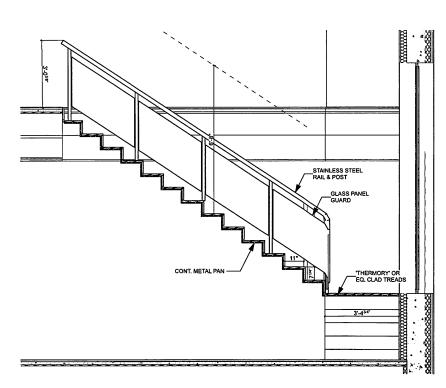

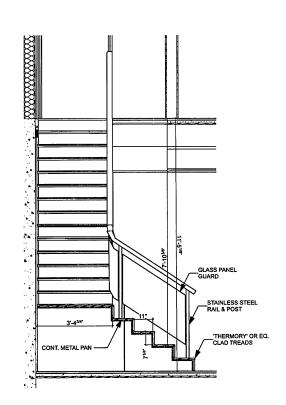

3 STAIRS A - SECTION 2 SCALE: 1/2" = 1'-0"

GUARDRAIL: -DESIGN DETAILING & MATERIAL SELECTION BY OWNER

- COORDINATE FINAL DETAILING & DESIGN OF STAIR W/ FABRICATOR
- 2) MATERIAL & FINISH SELECTIONS BY OWNER; CONTRACTOR TO PROVIDE SAMPLES

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SHEET TITLE

STAIR SECTION & PLANS

SHEET NUMBER

