

The Chalets at Ski Lake Phase 8

A Cluster Subdivision

a part of the of Northeast 1/4 of Section 23, T6N, R1E, SLB&M., U.S. Survey
Weber County, Utah
May 2015


LEGEND

- Set 5/8" Rebar (24" long) & Cap w/Fencepost
- ⊕ Monument (to be set)
- ◆ Found Section corner
- (Rad.) Radial Line/Bearing
- (NR) Non-Radial Line/Bearing



North 1/4 corner of Section 23, T6N, R1E, SLB&M., U.S. Survey, (Found Bureau of Land Management, Brass Cap, Good Condition, 0.4' above natural ground dated 1967)
N 89°36'44" W W.C.S. (N 89°38'27" W)

Northeast corner of Section 23, T6N, R1E, SLB&M., U.S. Survey, (Found Weber County 3 1/2" Brass Cap Monument, Good Condition, 15" below ground dated 2006)

North 1/4 corner of Section 24, T6N, R1E, SLB&M., U.S. Survey, (Found Weber County 3-1/2" Brass Cap Monument, Good Condition, 0.1' below asphalt dated 1991)

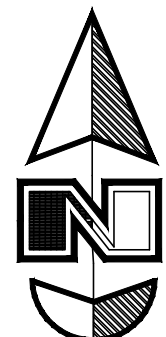

Scale: 1" = 100'

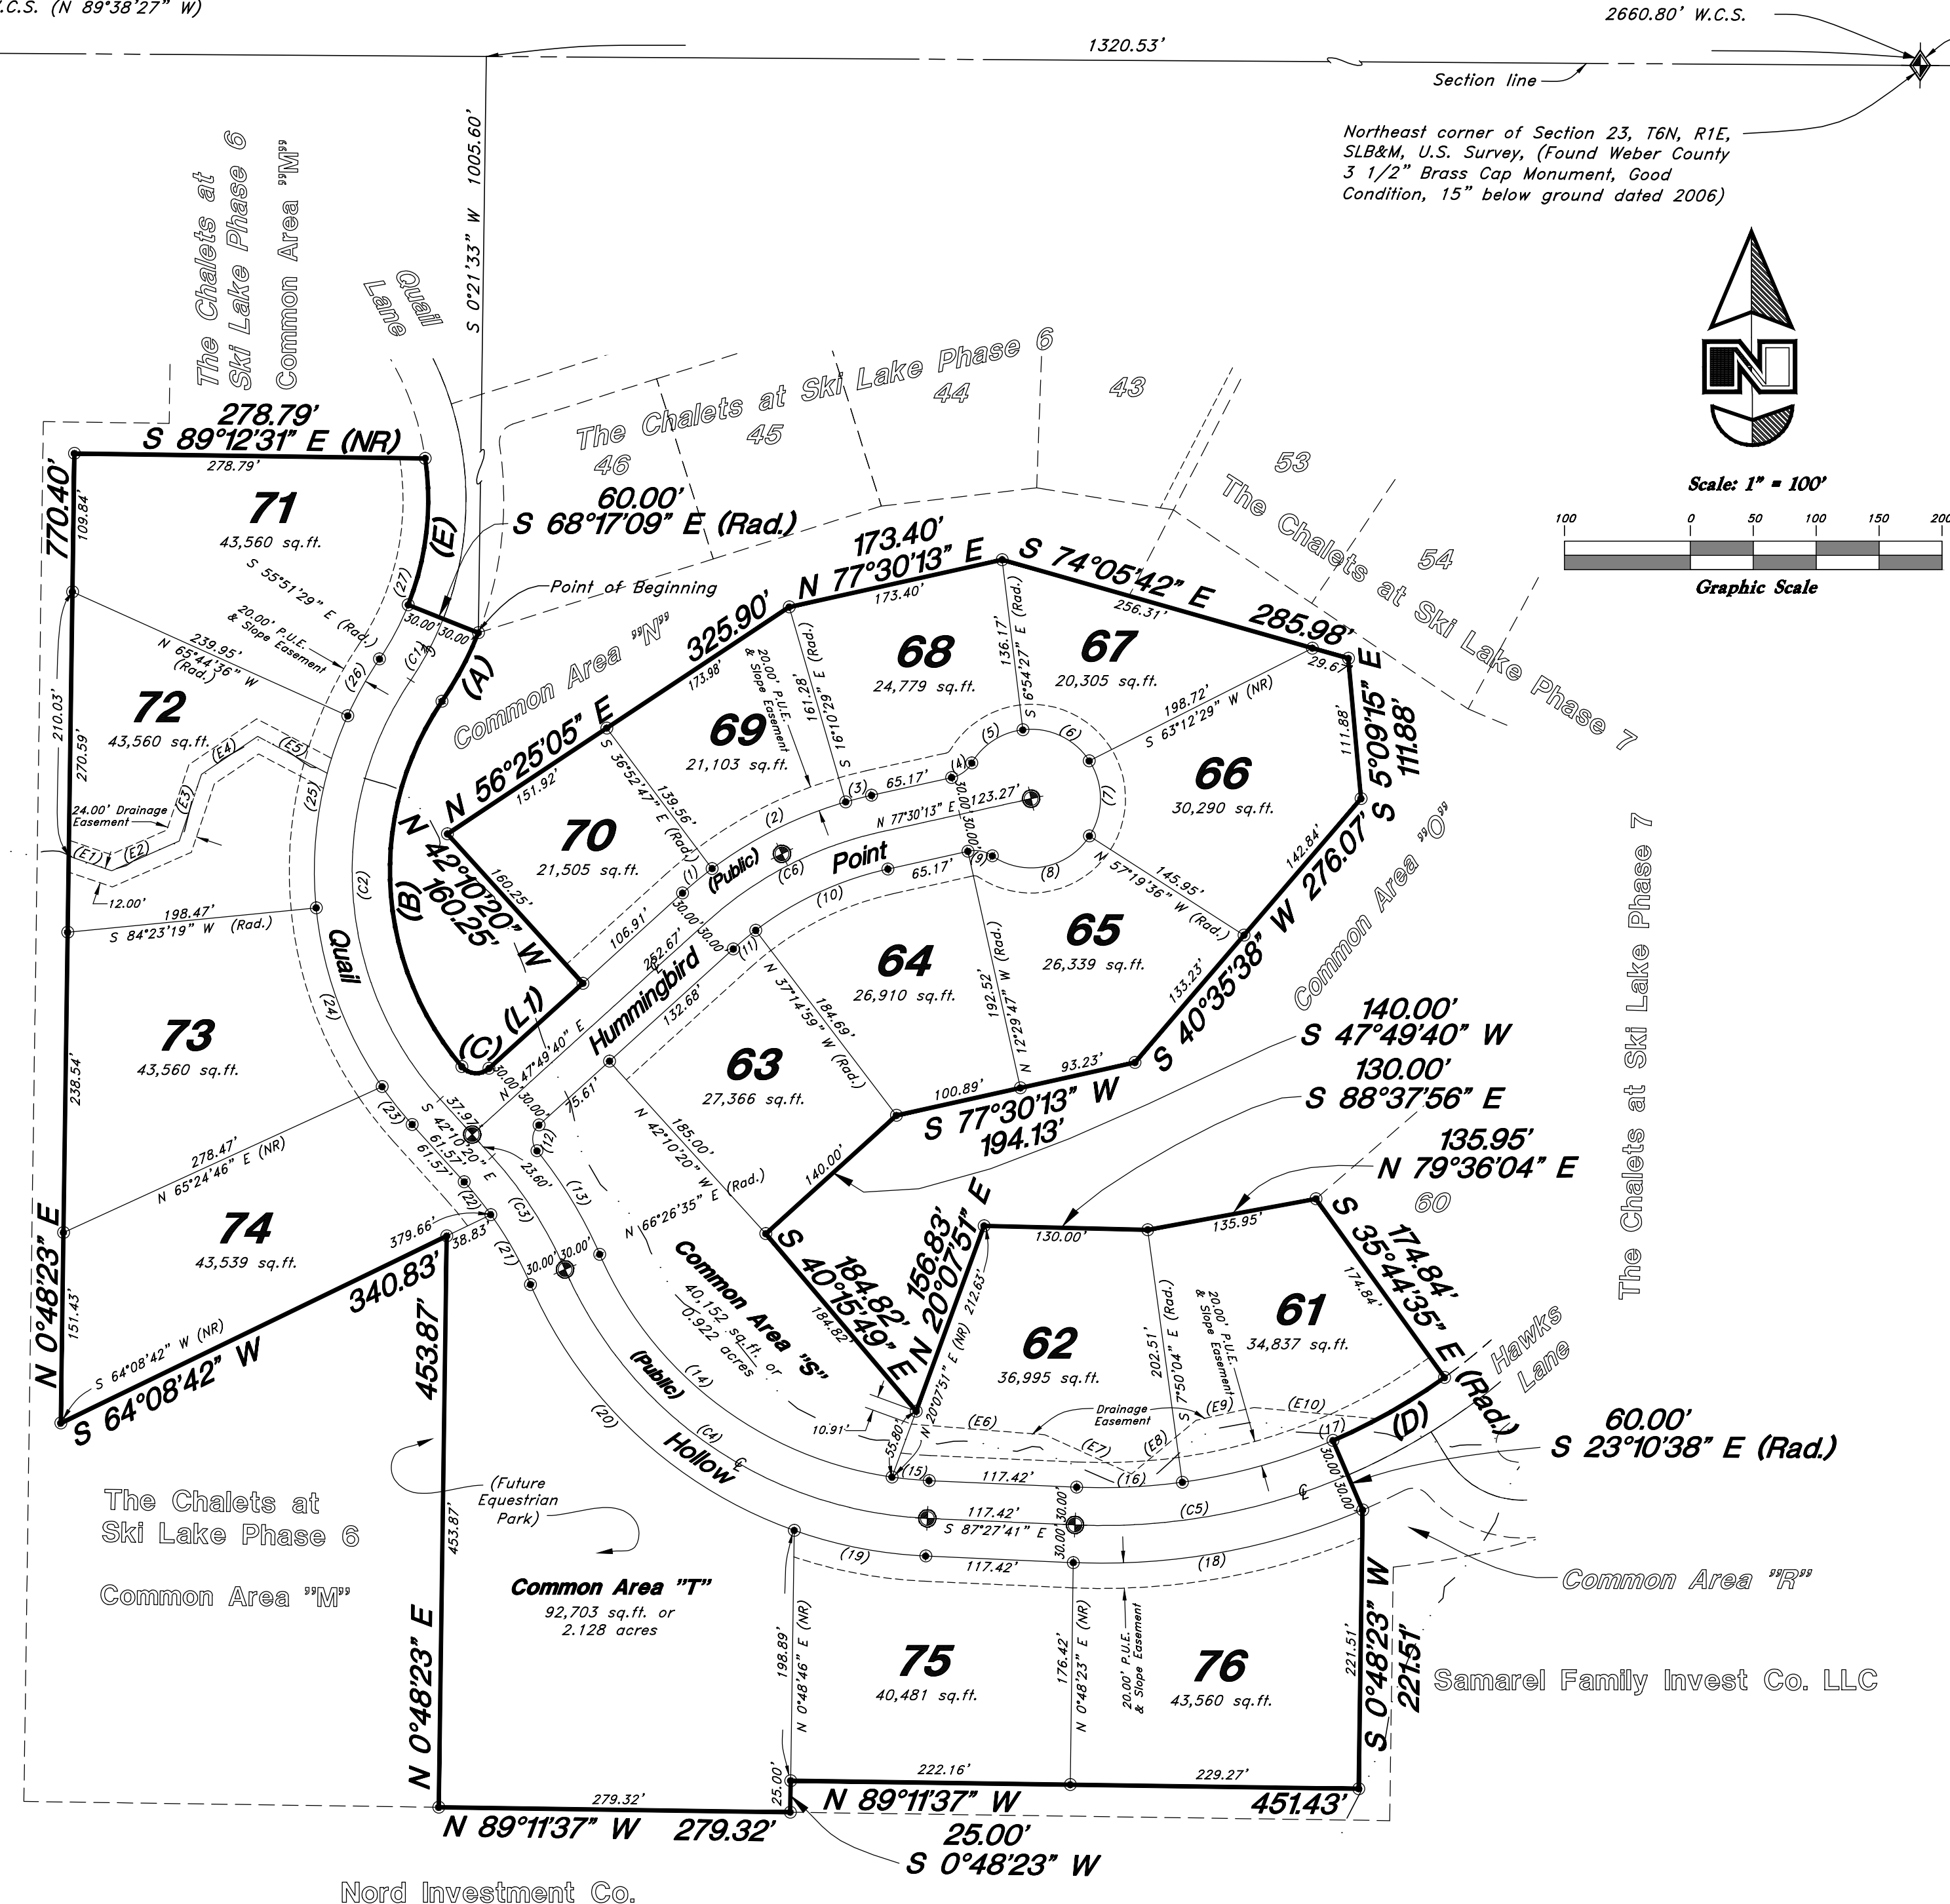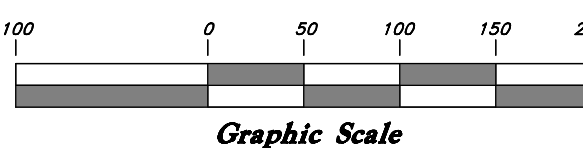

BOUNDARY CURVE DATA

(A)	(B)	(C)	(D)	(E)
Δ = 12°25'40"	Δ = 74°31'28"	Δ = 91°47'22"	Δ = 12°33'57"	Δ = 30°11'12"
R = 285.00'	R = 240.00'	R = 150.00'	R = 465.00'	R = 225.00'
L = 61.82'	L = 512.17'	L = 24.03'	L = 101.98'	L = 118.54'
LC = 61.70'	LC = 290.62'	LC = 21.54'	LC = 101.78'	LC = 117.18'
S 27°55'41" W	S 3°07'13" E	S 86°16'39" E	S 60°32'23" W	S 6°37'15" W
T = 31.03'	T = 182.58'	T = 15.48'	T = 51.20'	T = 60.68'

BOUNDARY LINE DATA

(L1) N 47°49'40" E 100.66'

EASEMENT LINE DATA

(E1) S 71°12'54" E 36.07' (E6) N 85°27'41" W 106.20'
 (E2) N 66°19'17" E 58.58' (E7) N 65°39'54" W 75.80'
 (E3) N 18°51'08" E 55.91' (E8) S 50°12'50" W 66.72'
 (E4) N 55°58'49" E 53.89' (E9) S 7°52'18" W 47.21'
 (E5) N 62°09'03" W 62.49' (E10) N 84°44'11" W 38.91'

PROPERTY LINE CURVE DATA

(1)	(2)	(3)	(4)	(5)
Δ = 51°17'33"	Δ = 30°42'17"	Δ = 34°04'42"	Δ = 46°34'03"	Δ = 52°09'23"
R = 330.00'	R = 330.00'	R = 330.00'	R = 25.00'	R = 25.00'
L = 119.25'	L = 21.19'	L = 20.32'	L = 50.07'	L = 50.07'
LC = 30.47'	LC = 118.60'	LC = 21.18'	LC = 19.76'	LC = 48.36'
S 50°28'22" W	S 63°28'22" W	S 79°58'52" W	S 57°05'52" W	S 57°05'52" W
T = 15.25'	T = 60.28'	T = 10.60'	T = 10.76'	T = 26.92'

(6) Δ = 63°53'22" R = 350.00' L = 91.33' LC = 58.20' S 64°08'42" W T = 34.29'

(7) Δ = 65°41'29" R = 350.00' L = 91.33' LC = 58.20' S 64°08'42" W T = 34.29'

(8) Δ = 91°23'51" R = 350.00' L = 91.33' LC = 58.20' S 64°08'42" W T = 34.29'

(9) Δ = 46°34'03" R = 350.00' L = 91.33' LC = 58.20' S 64°08'42" W T = 34.29'

(10) Δ = 24°45'12" R = 350.00' L = 91.33' LC = 58.20' S 64°08'42" W T = 34.29'

(11) Δ = 4°55'21" R = 270.00' L = 23.20' LC = 23.19' S 23°10'38" E T = 11.61'

(12) Δ = 86°43'43" R = 150.00' L = 15.00' LC = 15.00' S 88°37'56" E T = 14.17'

(13) Δ = 15°20'37" R = 360.00' L = 36.00' LC = 36.00' S 23°10'38" E T = 14.17'

(14) Δ = 58°15'03" R = 300.00' L = 30.00' LC = 30.00' S 79°36'04" E T = 14.81'

(15) Δ = 58°15'03" R = 300.00' L = 30.00' LC = 30.00' S 79°36'04" E T = 14.81'

(16) Δ = 10°22'23" R = 465.00' L = 84.19' LC = 84.07' S 89°11'37" W T = 42.21'

(17) Δ = 27°54'32" R = 465.00' L = 84.19' LC = 84.07' S 89°11'37" W T = 42.21'

(18) Δ = 25°42'57" R = 325.00' L = 235.63' LC = 106.86' S 0°48'23" E T = 119.84'

(19) Δ = 17°02'24" R = 360.00' L = 36.00' LC = 36.00' S 0°48'23" E T = 53.82'

(20) Δ = 42°53'51" R = 360.00' L = 36.00' LC = 36.00' S 0°48'23" E T = 156.15'

(21) Δ = 12°12'34" R = 300.00' L = 30.00' LC = 30.00' S 0°48'23" E T = 16.78'

(22) Δ = 6°24'21" R = 300.00' L = 30.00' LC = 30.00' S 0°48'23" E T = 16.78'

(23) Δ = 7°19'49" R = 300.00' L = 30.00' LC = 30.00' S 0°48'23" E T = 16.78'

(24) Δ = 29°13'50" R = 300.00' L = 30.00' LC = 30.00' S 0°48'23" E T = 16.78'

(25) Δ = 29°52'05" R = 300.00' L = 30.00' LC = 30.00' S 0°48'23" E T = 16.78'

(26) Δ = 9°53'07" R = 300.00' L = 30.00' LC = 30.00' S 0°48'23" E T = 16.78'

(27) Δ = 42°36'52" R = 300.00' L = 30.00' LC = 30.00' S 0°48'23" E T = 16.78'

(28) Δ = 18°36'55" R = 300.00' L = 30.00' LC = 30.00' S 0°48'23" E T = 16.78'

(29) Δ = 18°36'55" R = 300.00' L = 30.00' LC = 30.00' S 0°48'23" E T = 16.78'

(30) Δ = 18°36'55" R = 300.00' L = 30.00' LC = 30.00' S 0°48'23" E T = 16.78'

CENTERLINE CURVE DATA

(C1)	(C2)	(C3)	(C4)	(C5)
Δ = 12°25'40"	Δ = 18°36'55"	Δ = 18°36'55"	Δ = 63°54'15"	Δ = 25°42'57"
R = 255.00'	R = 270.00'	R = 330.00'	R = 330.00'	R = 495.00'
L = 55.31'	L = 59.62'	L = 107.22'	L = 368.06'	L = 222.17'
LC = 55.20'	LC = 333.62'	LC = 106.74'	LC = 349.28'	LC = 220.31'
S 27°55'41" W	S 4°00'55" E	S 32°51'53" E	S 55°30'33" E	N 79°40'51" E
T = 27.76'	T = 212.14'	T = 54.08'	T = 205.82'	T = 112.99'

(C6) Δ = 29°40'33" R = 300.00' L = 156.36' LC = 156.36' S 62°39'56" E T = 79.48'

SURVEYOR'S CERTIFICATE
I, Mark E. Babbitt, do hereby certify that I am a Registered Professional Land Surveyor in the State of Utah, and that I hold Certificate No. 166484 in accordance with Title 58 Chapter 22, Professional Engineers and Land Surveyors Licensing Act. I also do hereby certify that The Chalets at Ski Lake Phase 8, A Cluster Subdivision in Weber County, Utah has been correctly drawn to the designated scale and is a true and correct representation of the following description of lands included in said subdivision, based on data compiled from records in the Weber County Recorder's Office, and of a survey made on the ground in accordance with Section 17-23-17, Monumented Lot corners have been set as shown on this drawing.
I also certify that all the lots within The Chalets at Ski Lake Phase 8, A Cluster Subdivision meet the frontage and area requirements of the Weber County Zoning Ordinance.
Signed this _____ day of _____, 2015.

166484
License No. Mark E. Babbitt

OWNER'S DEDICATION
I, the undersigned owner of the herein described tract of land, do hereby set apart and subdivide the same into lots and streets as shown on the plat and name this tract The Chalets at Ski Lake Phase 8, A Cluster Subdivision and do hereby dedicate to public use all those parts or portions of said tract of land designated as streets, the same to be used as public thoroughfares, also grant and convey to the subdivision lot (unit) Owners Association, all those parts or portions of said tract of land designated as Common Areas to be used for recreational and open space purposes for the benefit of each lot (unit) Owners Association member in common with all others in the subdivision and grant and dedicate to Weber County a perpetual Open Space Right and Easement on and over the Common Areas to guarantee to Weber County that the Common Areas remain open and undeveloped except for approved recreational, parking and open space purposes, and also grant and dedicate a perpetual right and easement over, upon and under the lands designated hereof as public and private utility, storm water detention ponds drainage easements, and slope easements, the same to be used for the installation, maintenance and operation of public and private utility service lines, storm drainage facilities, or for the perpetual preservation of water channels in their natural state whichever is applicable as may be authorized by governing authority with no buildings or structures being erected within such easements.
Dedicate, grant and convey to Weber County, Utah, or its designee, all those parts or portions of said tract of land designated as parks the same to be used as public open space.
Signed this _____ day of _____, 2015.

Valley Enterprise Investment Company, LLC.

Roy Bowden — President
5393 East 6850 North
Eden, UT, 84310

State of _____ } ss
County of _____ }
On the _____ day of _____, 2015, personally appeared before me, Roy Bowden who being by me duly sworn did say that he is President of Valley Enterprise Investment Company, LLC. and that said instrument was signed in behalf of said Corporation by a resolution of its Board of Directors and Roy Bowden acknowledged to me that said Corporation executed the same.
Residing at: _____ A Notary Public commissioned in Utah
Commission Expires: _____ Print Name _____

BOUNDARY DESCRIPTION
A part of the Northeast Quarter of Section 23, Township 6 North, Range 1 East, Salt Lake Base and Meridian, U.S. Survey:
Beginning at a Point on the East Right of Way Line of Quail Hollow and the South Boundary line of The Chalets at Ski Lake Phase 6 a Cluster Subdivision in Weber County, Utah, said point is 1320.53 feet North 89°38'27" West along the Section Line, and 1005.60 feet South 0°21'33" West from the Northeast Corner of said Section 23; and running thence along the boundary lines of The Chalets at Ski Lake Phase 6 and 7 in the following twenty-two (22) courses: (1) Southwesterly along the arc of a 285.00 foot radius curve to the right a distance of 61.82 feet (Central Angle is 12°25'40" and Long Chord bears South 27°55'41" West 61.70 feet), (2) Southerly along the arc of a 240.00 foot radius curve to the left a distance of 312.17 feet (Central Angle is 74°31'28" and Long Chord bears South 3°07'13" East 290.62 feet), (3) Easterly along the arc of a 15.00 foot radius curve to the left a distance of 24.03 feet (Central Angle is 91°47'22" and Long Chord bears South 86°16'39" East 21.54 feet), (4) North 47°49'40" East 100.66 feet, (5) North 42°10'20" West 160.25 feet, (6) North 56°25'05" East 325.90 feet, (7) North 77°30'13" East 173.40 feet, (8) South 74°05'42" East 285.98 feet, (9) South 5°09'15" East 111.88 feet, (10) South 40°35'38" West 276.07 feet, (11) South 77°30'13" West 194.13 feet, (12) South 47°49'40" West 140.00 feet, (13) South 40°15'49" East 184.82 feet, (14) North 20°07'51" East 156.83 feet, (15) South 88°37'56" East 130.00 feet, (16) North 79°36'04" East 135.95 feet, (17) South 35°44'35" East 174.84 feet, (18) Southwesterly along the arc of a 465.00 foot radius curve to the right a distance of 101.98 feet (Central Angle is 12°33'57" and Long Chord bears South 60°32'23" West 101.78 feet), (19) South 23°10'38" East 60.00 feet, (20) South 0°48'23" West 221.51 feet, (21) North 89°11'37" West 451.43 feet, and (22) South 0°48'23" West 250.00 feet; thence North 89°11'37" West 279.32 feet to the Easterly line of said Phase 6; thence along said boundary of Phase 6 as follows: North 0°48'23" East 453.87 feet, South 64°08'42" West 340.83 feet, North 0°48'23" East 770.40 feet, South 89°12'31" East 278.79 feet, Southerly along the arc of a 225.00 foot radius curve to the right a distance of 118.54 feet (Central Angle is 30°11'12" and Long Chord bears South 6°37'15" West 117.18 feet), and South 68°17'09" East 60.00 feet to the point of beginning.

Contains 17.806 acres.

Narrative:
At the request of Roy Bowden, owner and developer, we have prepared this subdivision plat.
The basis of bearing for this plat is S 89°36'57" E between the Brass Caps found at the Northwest corner and the North 1/4 corner of Section 24, Township 6 North, Range 1 East, Salt Lake Base & Meridian, U.S. Survey.

- NOTE:**
- 10.00' wide PUE and Slope Easements each side of Property line as indicated by dashed lines.
 - Centerline monuments to be set upon completion of improvements, as shown.
 - Common areas may be used as Public Utility Easements.
 - Due to the topography and the location of this subdivision all owners will accept responsibility for any storm water runoff from Quail Hollow, and Hummingbird Point.

WEBER COUNTY ATTORNEY
I have examined the financial guarantee and other documents associated with this subdivision plat and in my opinion they conform with the County Ordinance applicable thereto and now in force and effect.
Signed this _____ day of _____, 2015.

WEBER COUNTY ENGINEER
I hereby certify that the required public improvement standards and drawings for this subdivision conform with County standards and the amount of the financial guarantee is sufficient for the installation of these improvements.
Signed this _____ day of _____, 2015.

OGDEN VALLEY TOWNSHIP PLANNING COMMISSION
This is to certify that this subdivision plat was duly approved by the Ogden Valley Township Planning Commission on the _____ day of _____, 2015.

WEBER COUNTY COMMISSION ACCEPTANCE
This is to certify that this subdivision plat, the dedication of streets and other public ways and financial guarantee of public improvements associated with this subdivision, thereon are hereby approved and accepted by the Commissioners of Weber County, Utah this _____ day of _____, 2015.



WEBER COUNTY SURVEYOR
I hereby certify that the Weber County Surveyor's Office has reviewed this plat for mathematical correctness, section corner data, and for harmony with the lines and monuments on record in the County offices. The approval of this plat by the Weber County Surveyor does not relieve the Licensed Land Surveyor who executed this plat from the responsibilities and/or liabilities associated therewith.
Signed this _____ day of _____, 2015.

WEBER COUNTY RECORDER
ENTRY NO. _____ FILED FOR RECORD _____
RECORDED _____ IN BOOK _____ OF OFFICIAL RECORDS, PAGE _____, RECORL FOR _____
WEBER COUNTY RECORDER
BY: _____ DEPUTY

GREAT BASIN ENGINEERING Z
5746 SOUTH 1475 EAST OGDEN, UTAH 84403
MAIN (801)394-4515 S.L.C (801)521-0222 FAX (801)392-7544
WWW.GREATBASINENGINEERING.COM

Note: Unless specified as part of Phase 6, improvements in Phase 6 are existing and installed

Note: Unless specified as part of Phase 6, improvements in Phase 7 are existing and installed

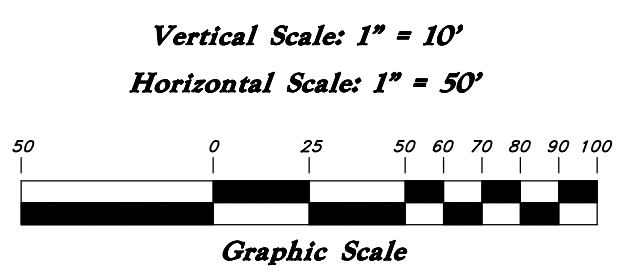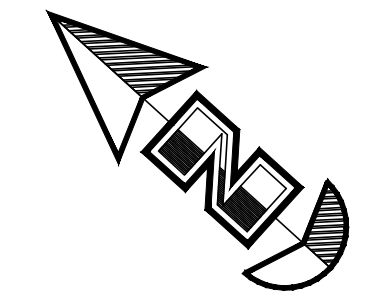



Legend

- (Note: All items may not appear on drawing)
- San. Sewer Manhole
 - Water Manhole
 - Storm Drain Manhole
 - Electrical Manhole
 - Catch Basins
 - Exist. Fire Hydrant
 - Exist. Water Valve
 - Water Valve
 - Sanitary Sewer
 - Culinary Water
 - Gas Line
 - Irrigation Line
 - Storm Drain
 - Telephone Line
 - Secondary Waterline
 - Power Line
 - Fire Line
 - Land Drain
 - Power pole w/guy
 - Light Pole
 - Fence
 - Flowline of ditch
 - Overhead Power line
 - Corrugated Metal Pipe
 - Concrete Pipe
 - Reinforced Concrete Pipe
 - Ductile Iron
 - Polyvinyl Chloride
 - Top of Asphalt
 - Edge of Asphalt
 - Centerline
 - Flowline
 - Finish Floor
 - Top of Curb
 - Top of Wall
 - Top of Walk
 - Finish Contour
 - Natural Ground
 - Exist. Contour
 - Finish Grade
 - Exist. Grade
 - Ridge Line
 - Direction of Flow
 - Existing Asphalt
 - New Asphalt
 - Heavy Duty Asphalt
 - Concrete
 - Open Face
 - Curb & Gutter

PRIVATE ENGINEER'S NOTICE TO CONTRACTORS

The Contractor agrees that he shall assume sole and complete responsibility for job site conditions during the course of construction of this project, including safety of all persons and property; that this requirement shall apply continuously and not be limited to normal working hours; and that the contractor shall defend, indemnify, and hold the owner and the engineer harmless from any and all liability, real or alleged, in connection with the performance of work on this project, excepting for liability arising from the sole negligence of the owner or the engineer.

ALL CONSTRUCTION TO CONFORM TO COUNTY STANDARDS AND SPECIFICATIONS IN RIGHT OF WAY

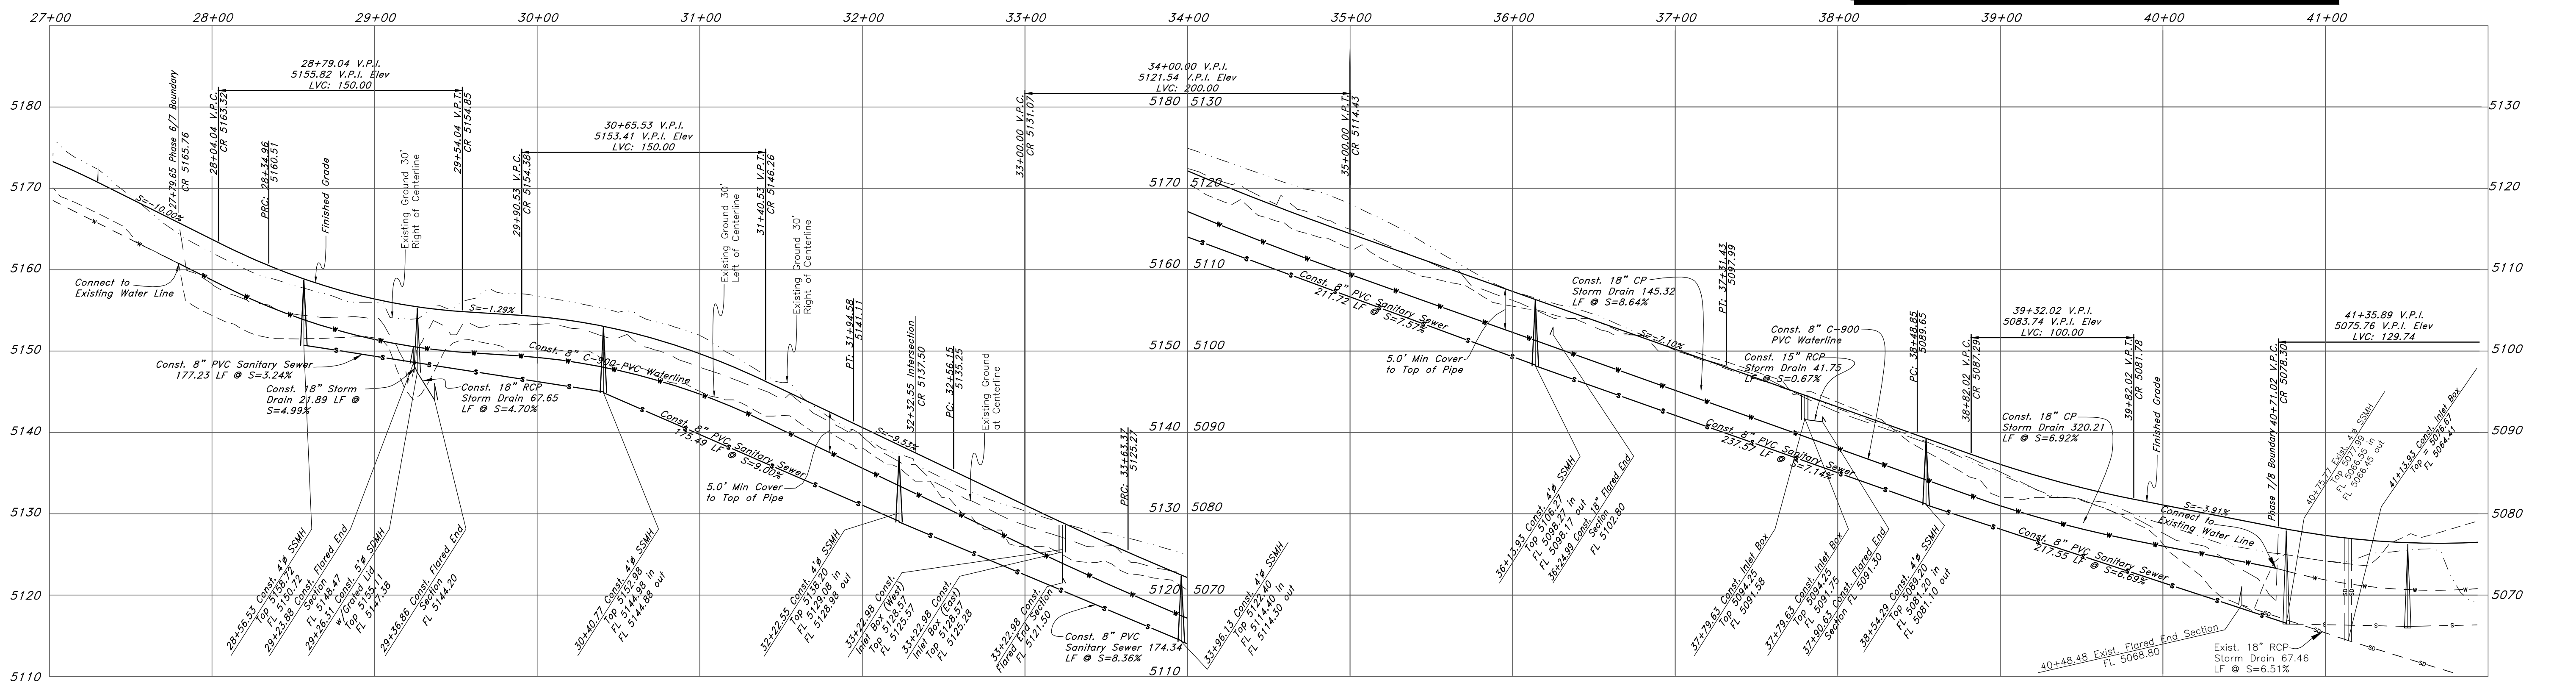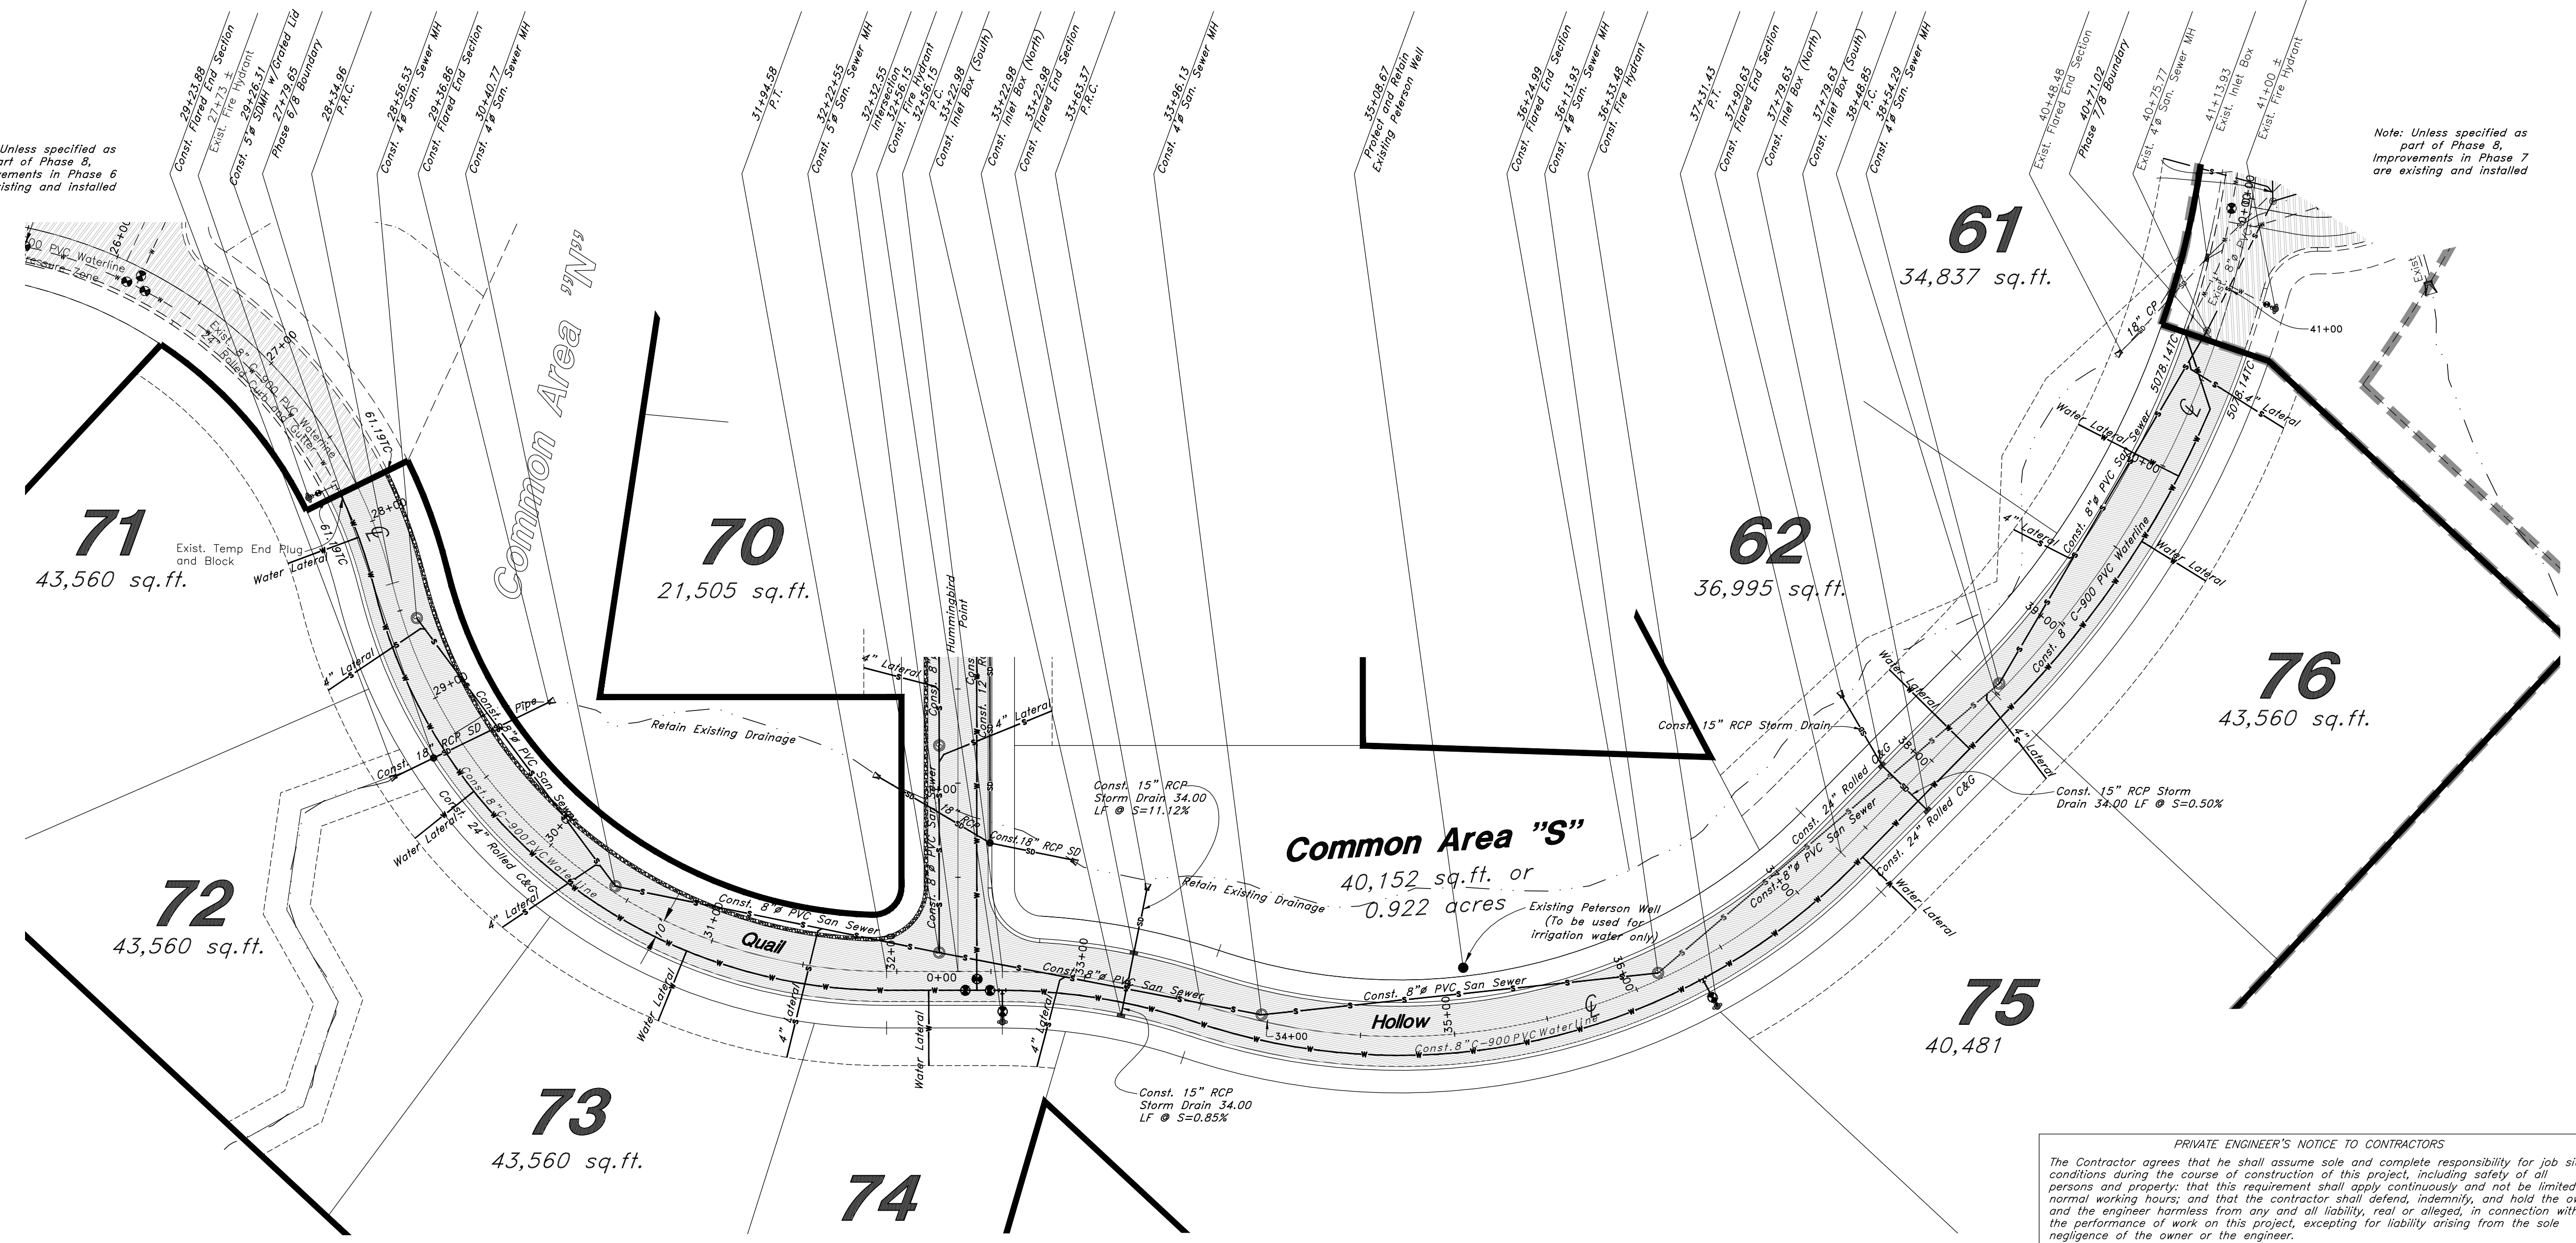


REV	DATE	DESCRIPTION

Plan / Profile (Utility)

The Chalets at Ski Lake No. 8



A part of the Southwest 1/4 of Section 13, a part of the Northwest 1/4 of Section 24, 1/4 of Section 23, and a part of the Northwest 1/4 of Section 24, 1/4 of Section 23, and a part of the Northwest 1/4 of Section 24, U.S. Survey

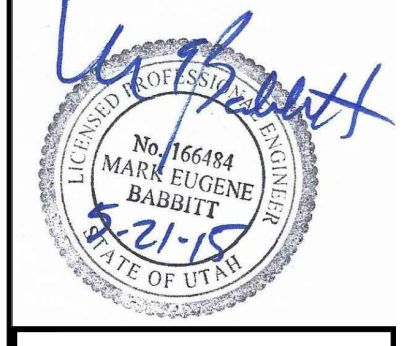



Mar, 2015

SHEET NO. **1**



96N120 Waterline

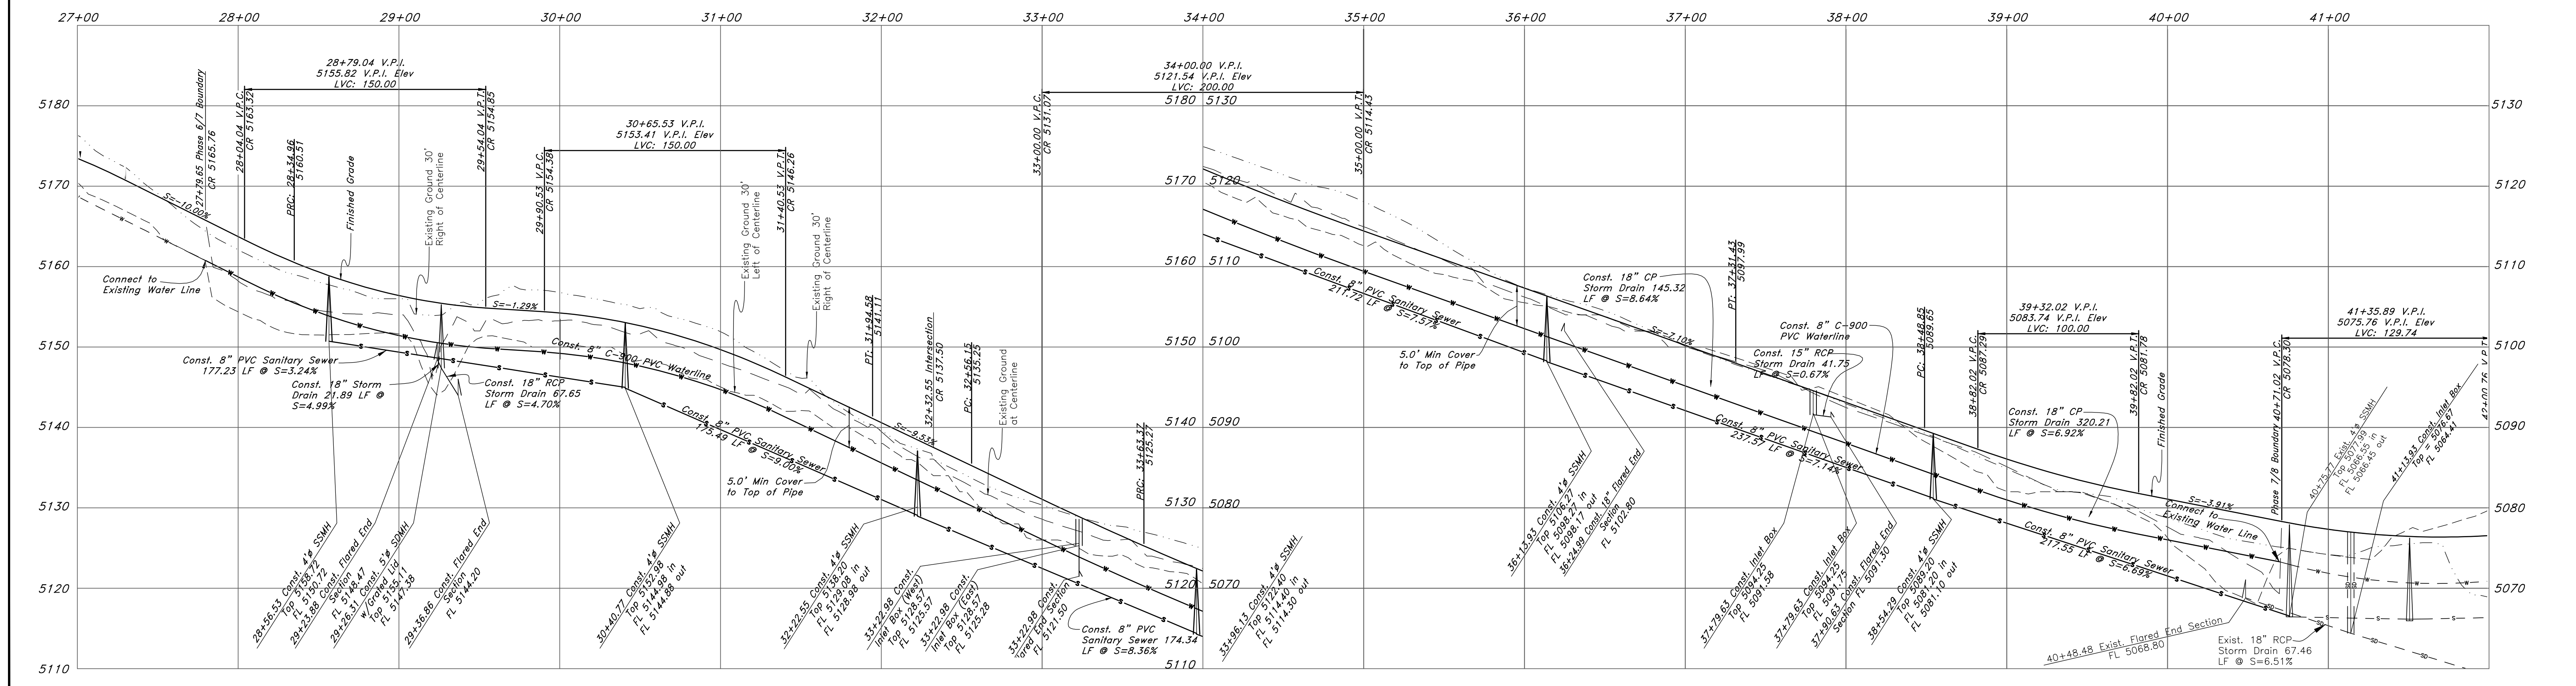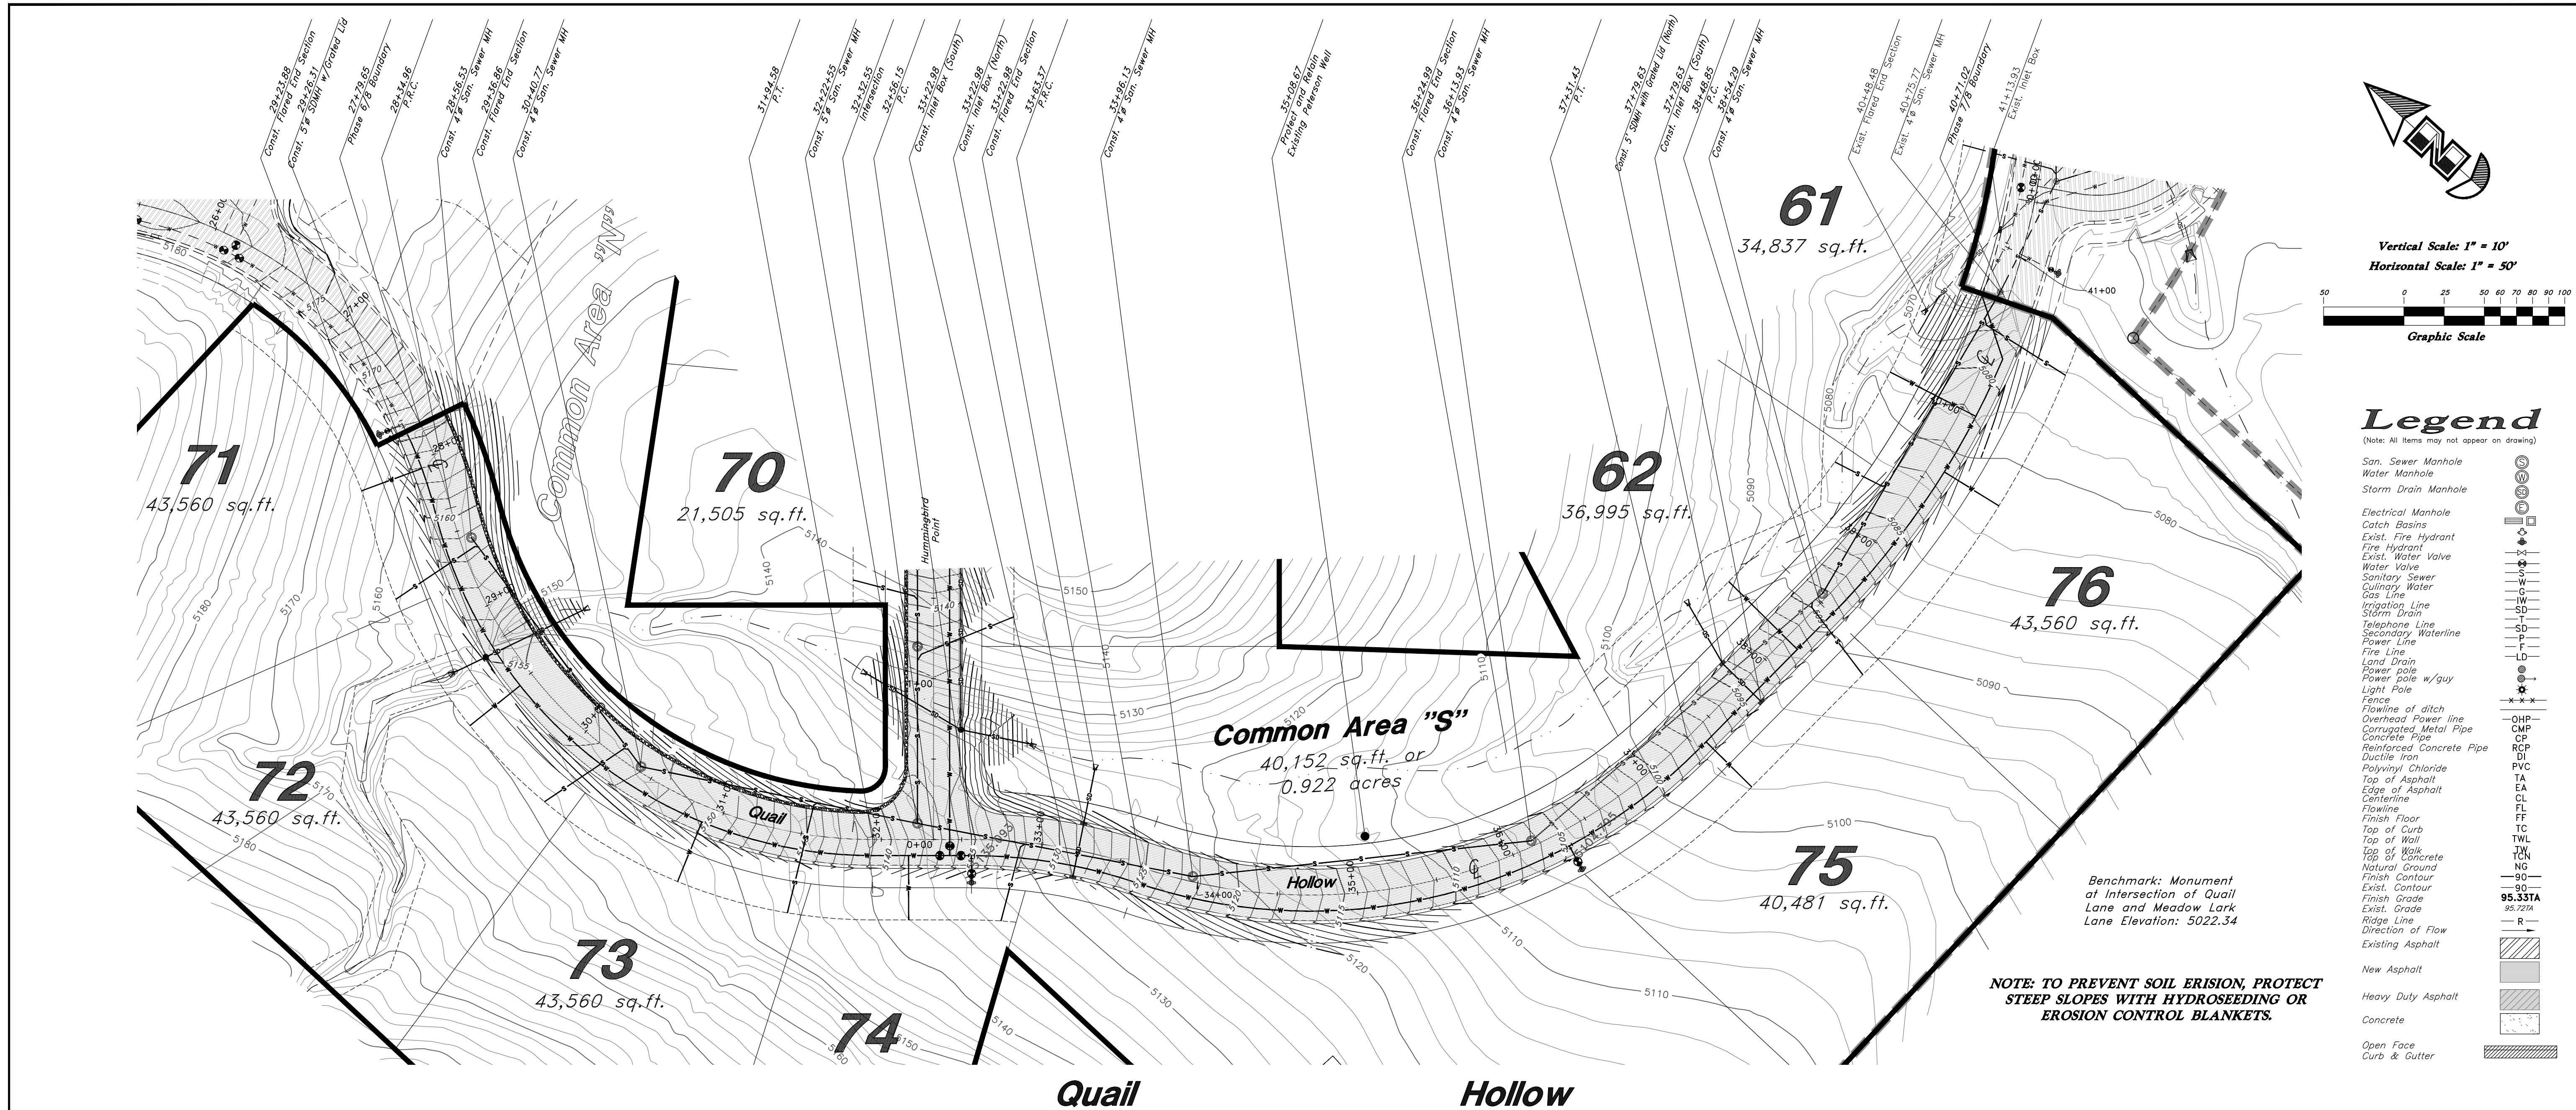

REV	DATE	DESCRIPTION

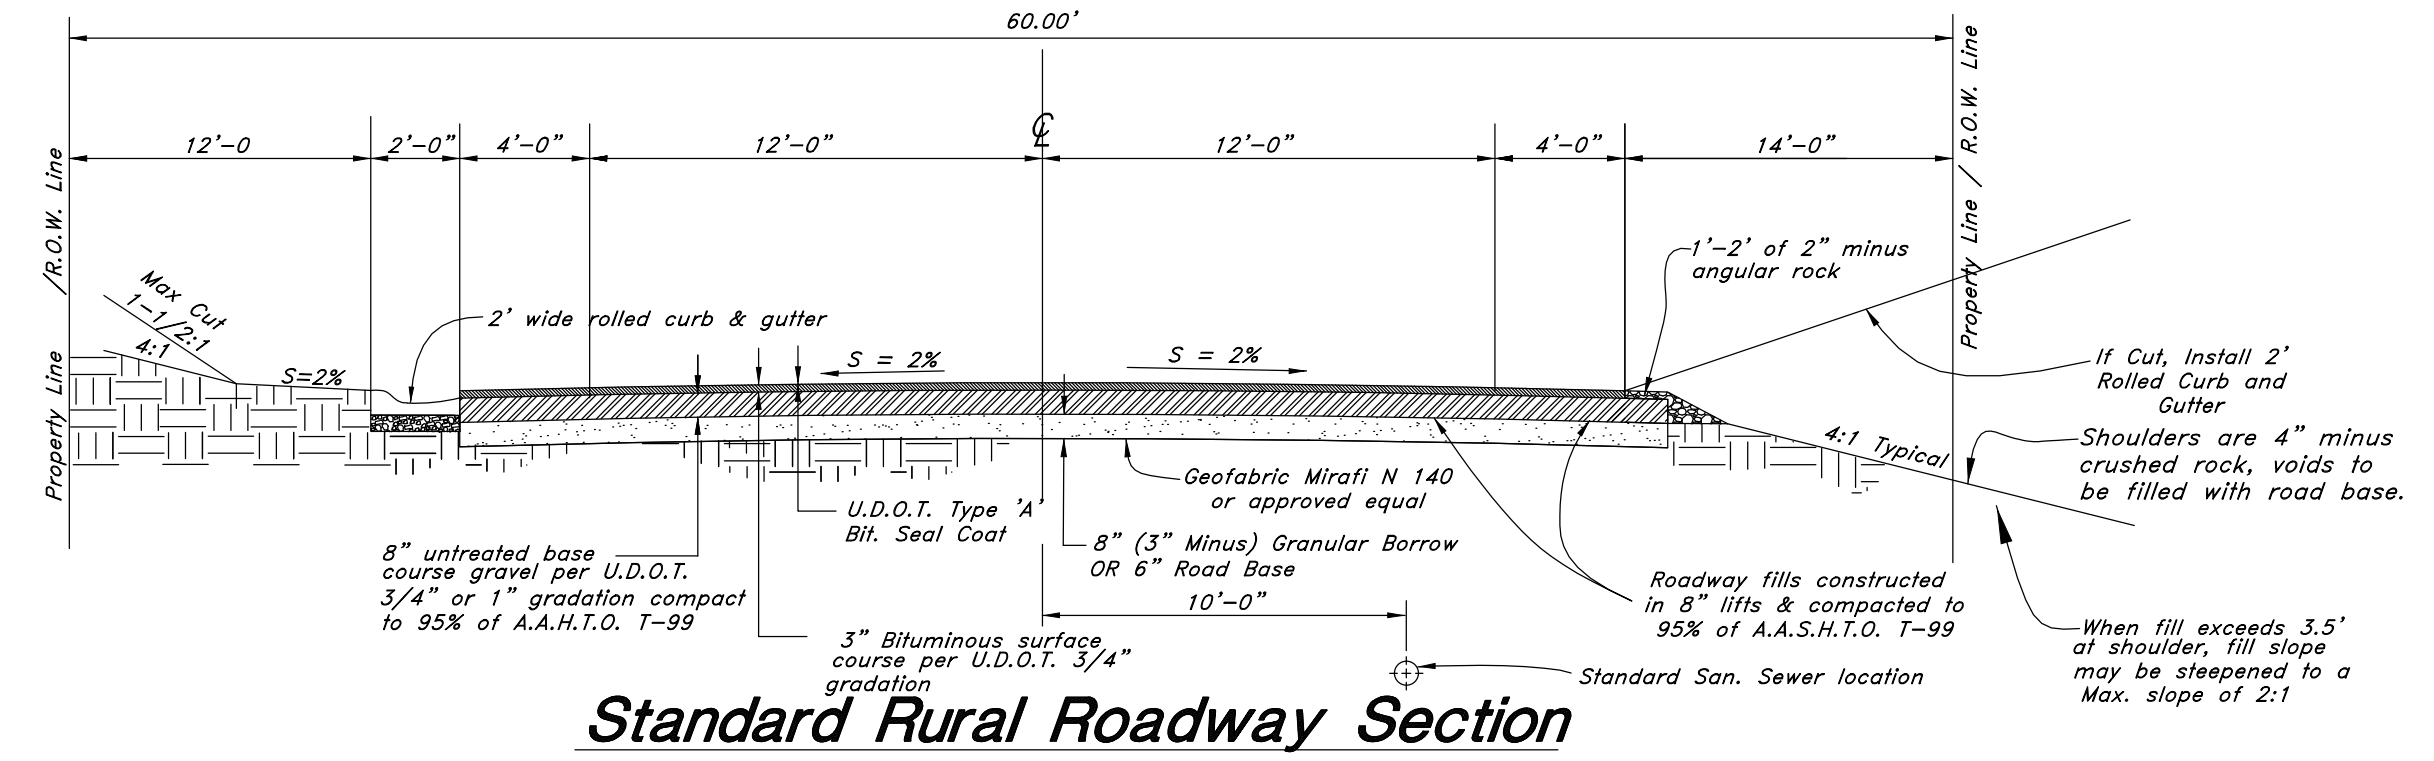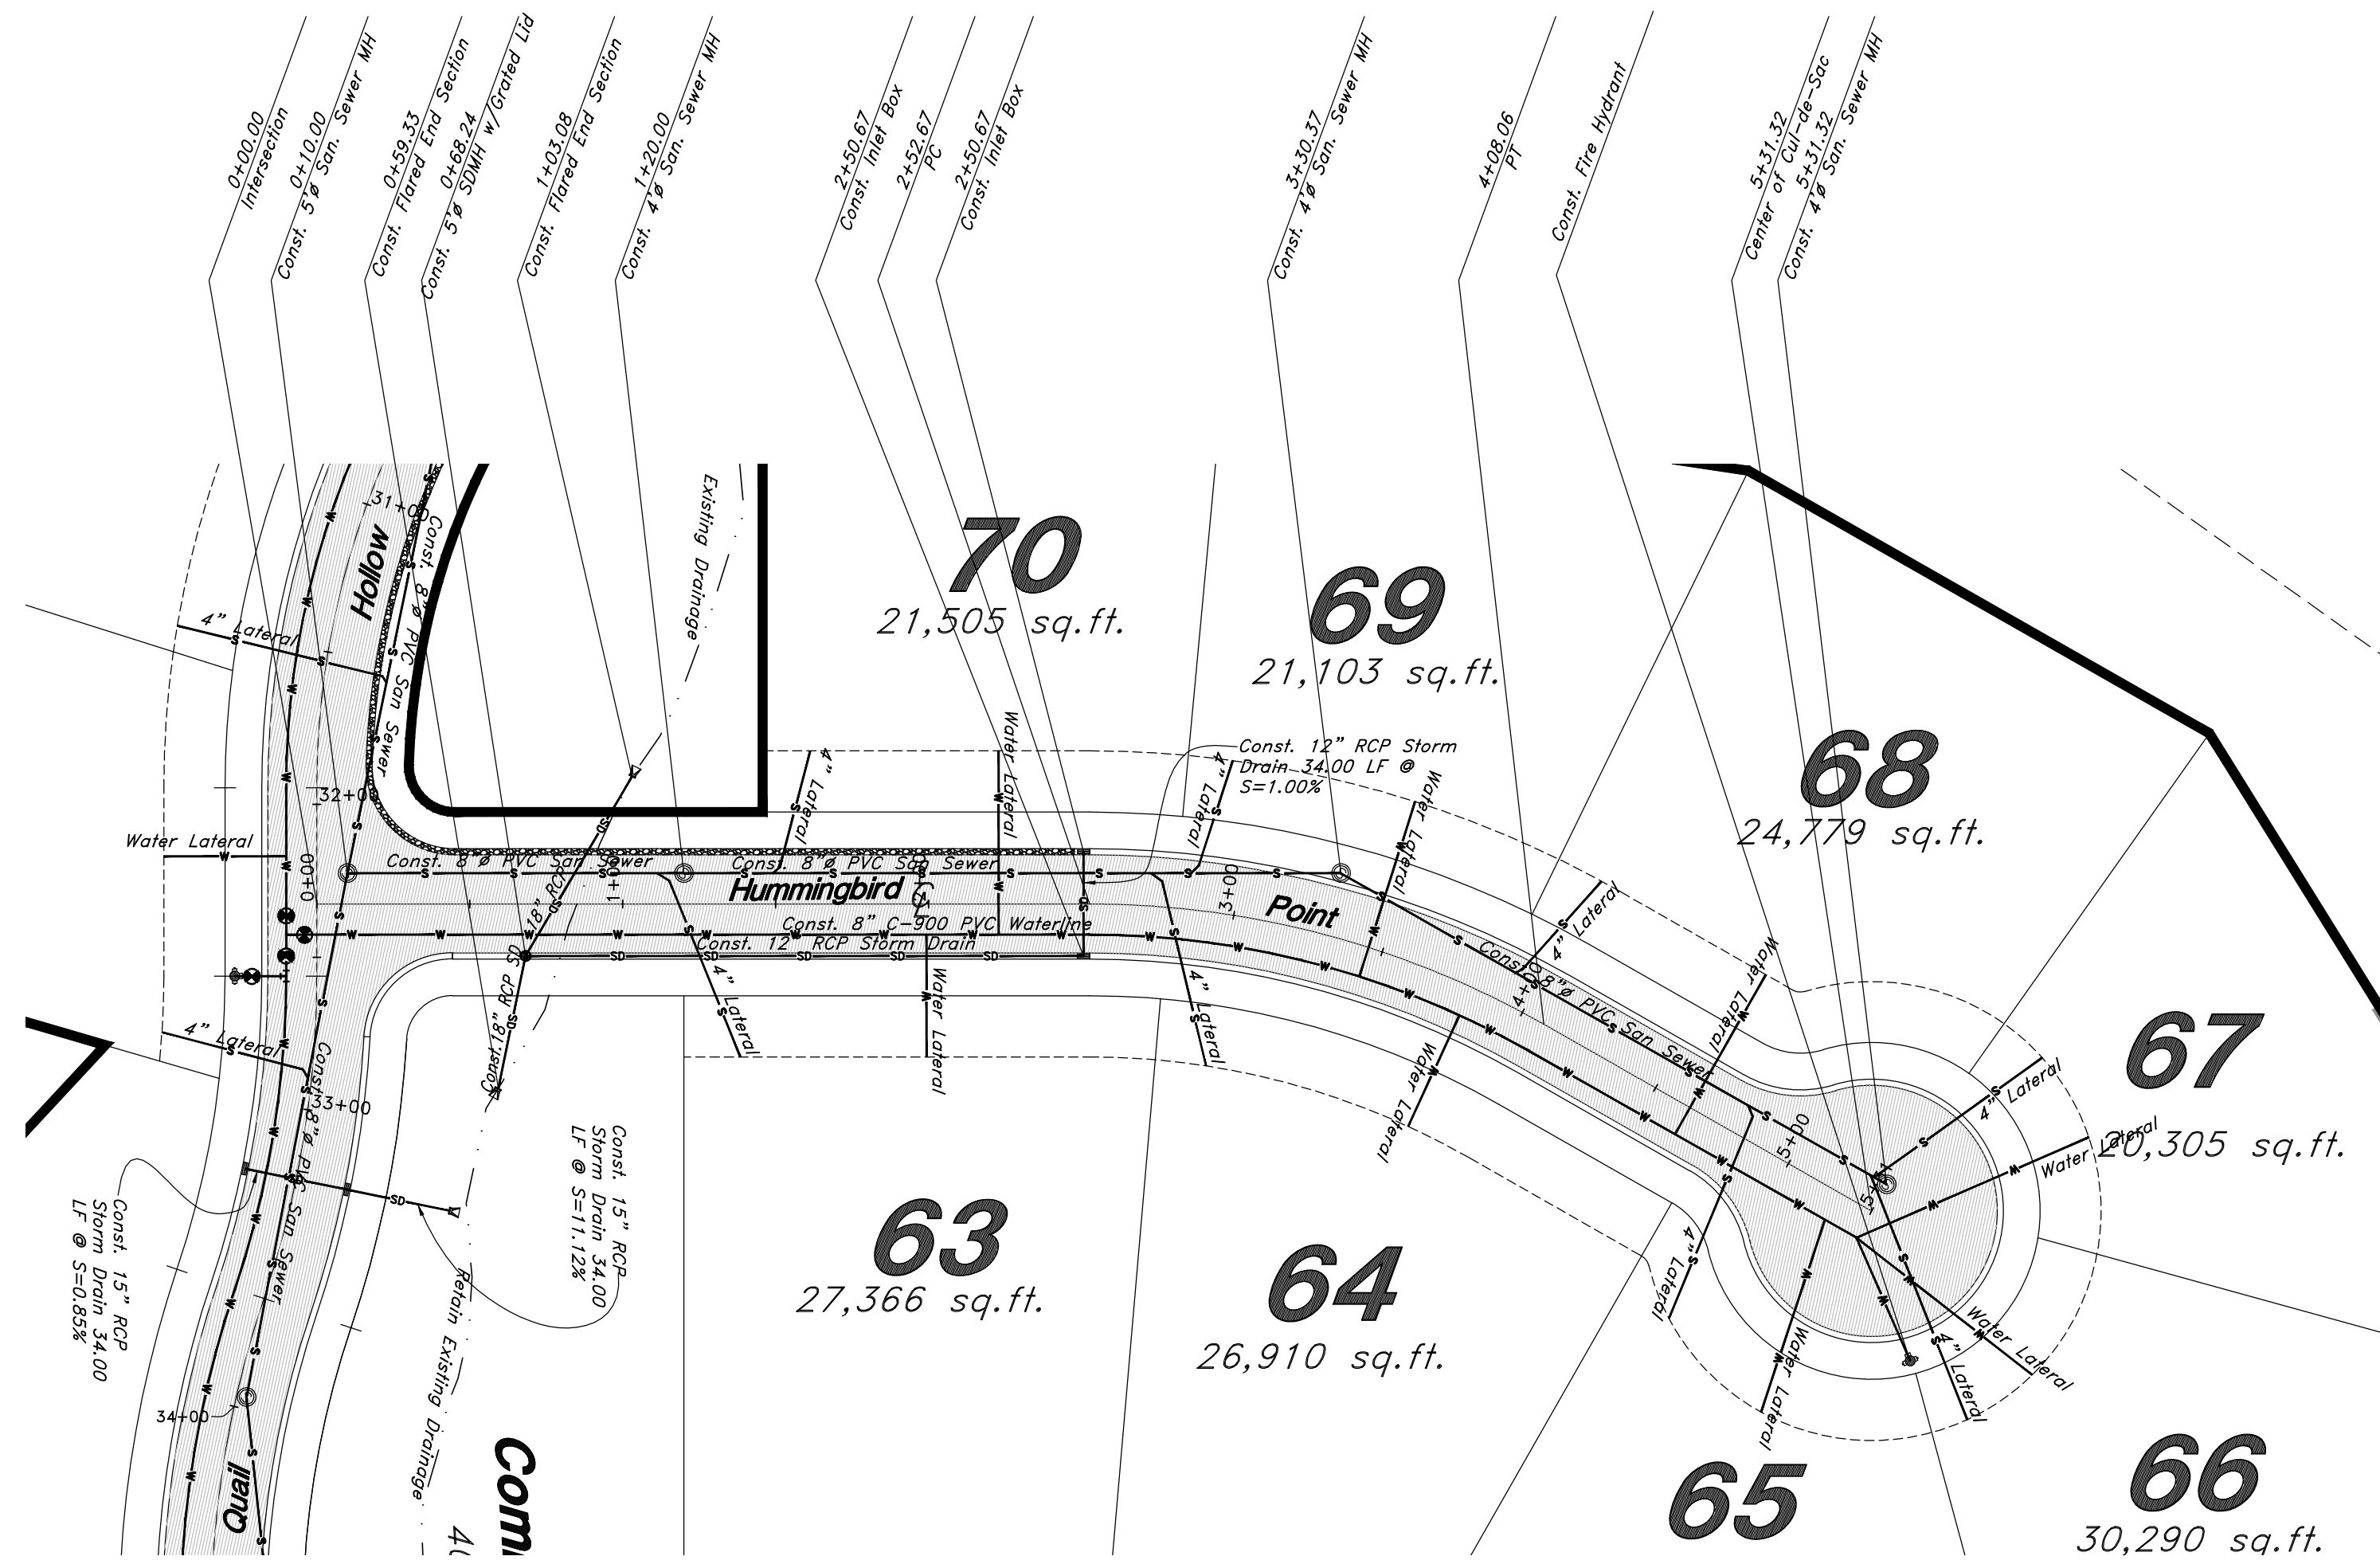

NOTE: ALL IMPROVEMENTS WITHIN STREET RIGHT OF WAY SHALL CONFORM TO WEBER COUNTY STANDARDS.

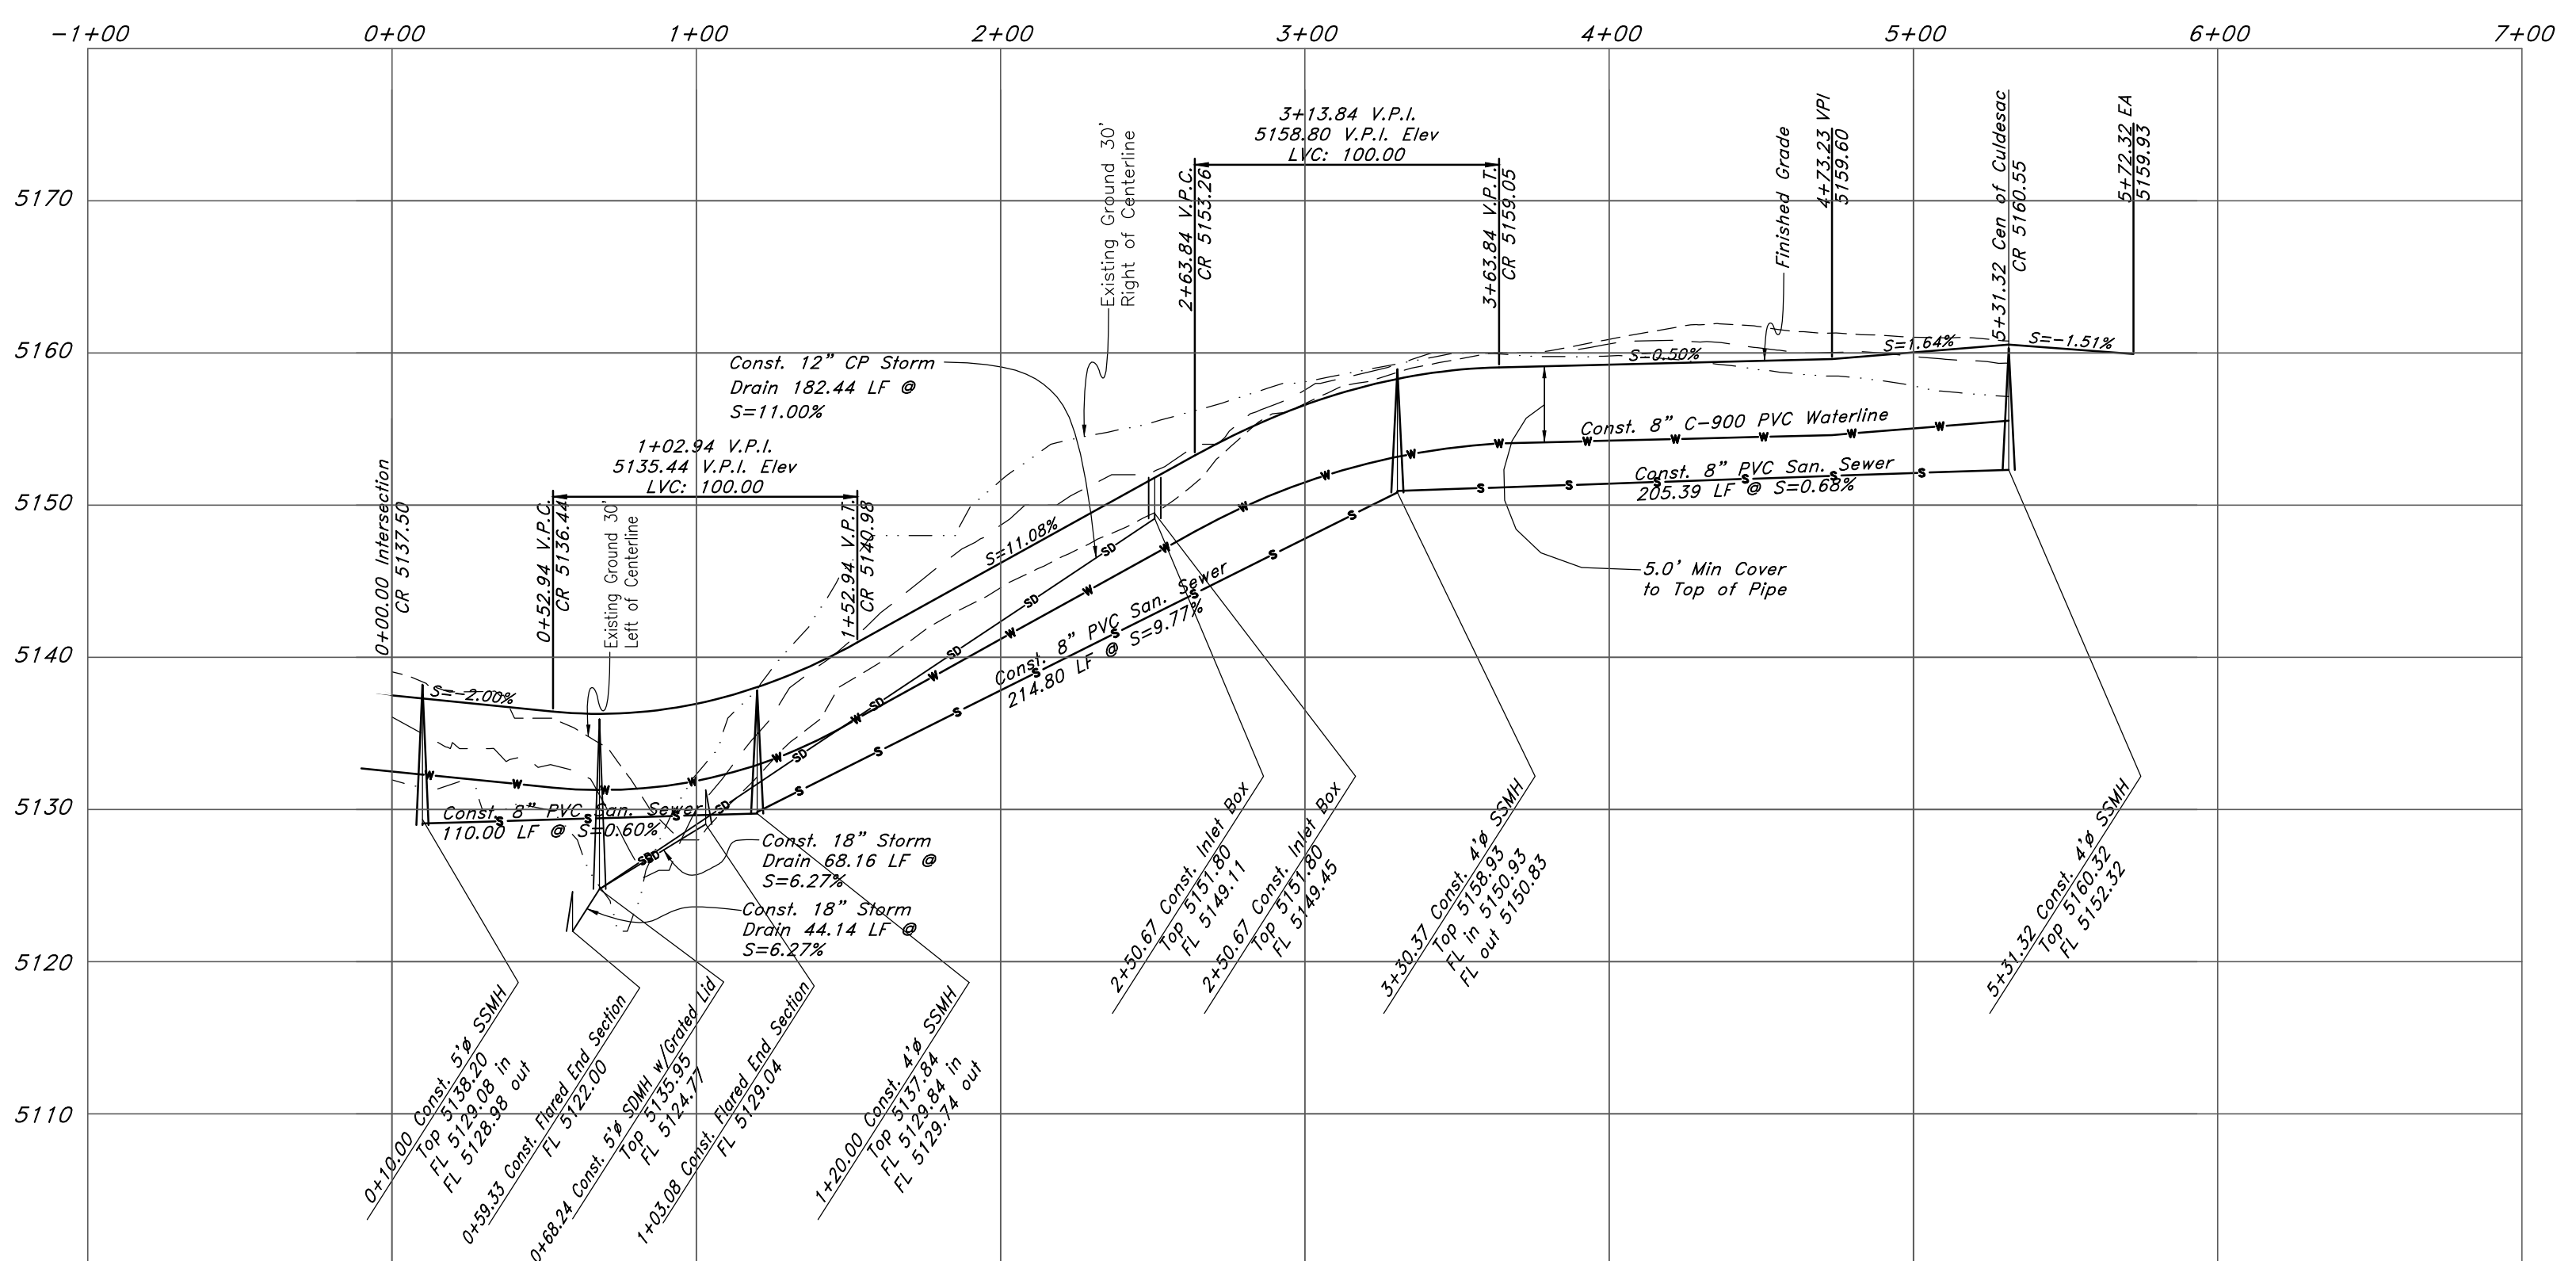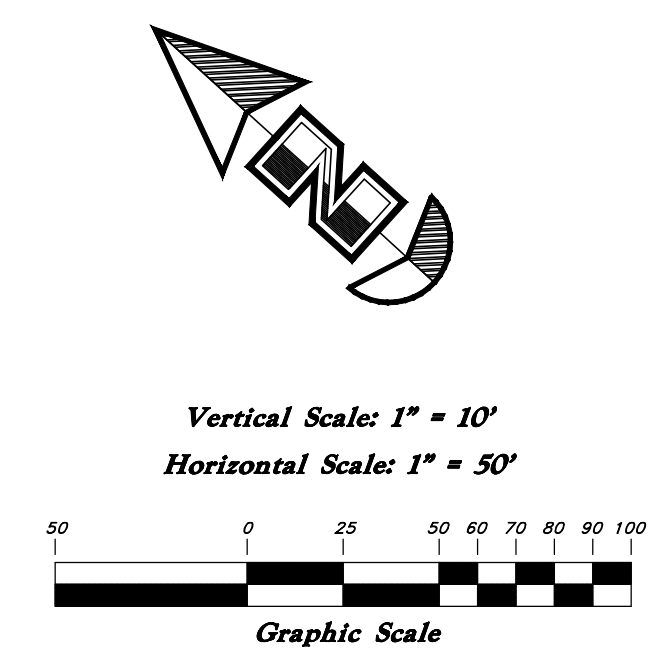

- Legend**
(Note: All items may not appear on drawing)
- San. Sewer Manhole
 - Water Manhole
 - Storm Drain Manhole
 - Electrical Manhole
 - Catch Basins
 - Exist. Fire Hydrant
 - Exist. Water Valve
 - Water Valve
 - Sanitary Sewer
 - Sanitary Sewer
 - Gas Line
 - Irrigation Line
 - Storm Drain
 - Telephone Line
 - Secondary Waterline
 - Power Line
 - Fire Line
 - Land Drain
 - Power pole
 - Power pole w/guy
 - Light Pole
 - Fence
 - Flowline of ditch
 - Overhead Power line
 - Corrugated Metal Pipe
 - Concrete Pipe
 - Reinforced Concrete Pipe
 - Ductile Iron
 - Polyvinyl Chloride
 - Top of Asphalt
 - Edge of Asphalt
 - Centerline
 - Flowline
 - Finish Floor
 - Top of Curb
 - Top of Wall
 - Top of Concrete
 - Natural Ground
 - Finish Contour
 - Exist. Contour
 - Finish Grade
 - Exist. Grade
 - Ridge Line
 - Direction of Flow
 - Existing Asphalt
 - New Asphalt
 - Heavy Duty Asphalt
 - Concrete
 - Open Face Curb & Gutter

Plan / Profile (Utility)



The Chalets at Ski Lake No. 8

A part of the Southwest 1/4 of Section 13, a part of the Northeast 1/4 of Section 23, and a part of the Northwest 1/4 of Section 24, T6N, R1E, S18&M, U.S. Survey

Mar, 2015

SHEET NO. 2

96N120 Waterline

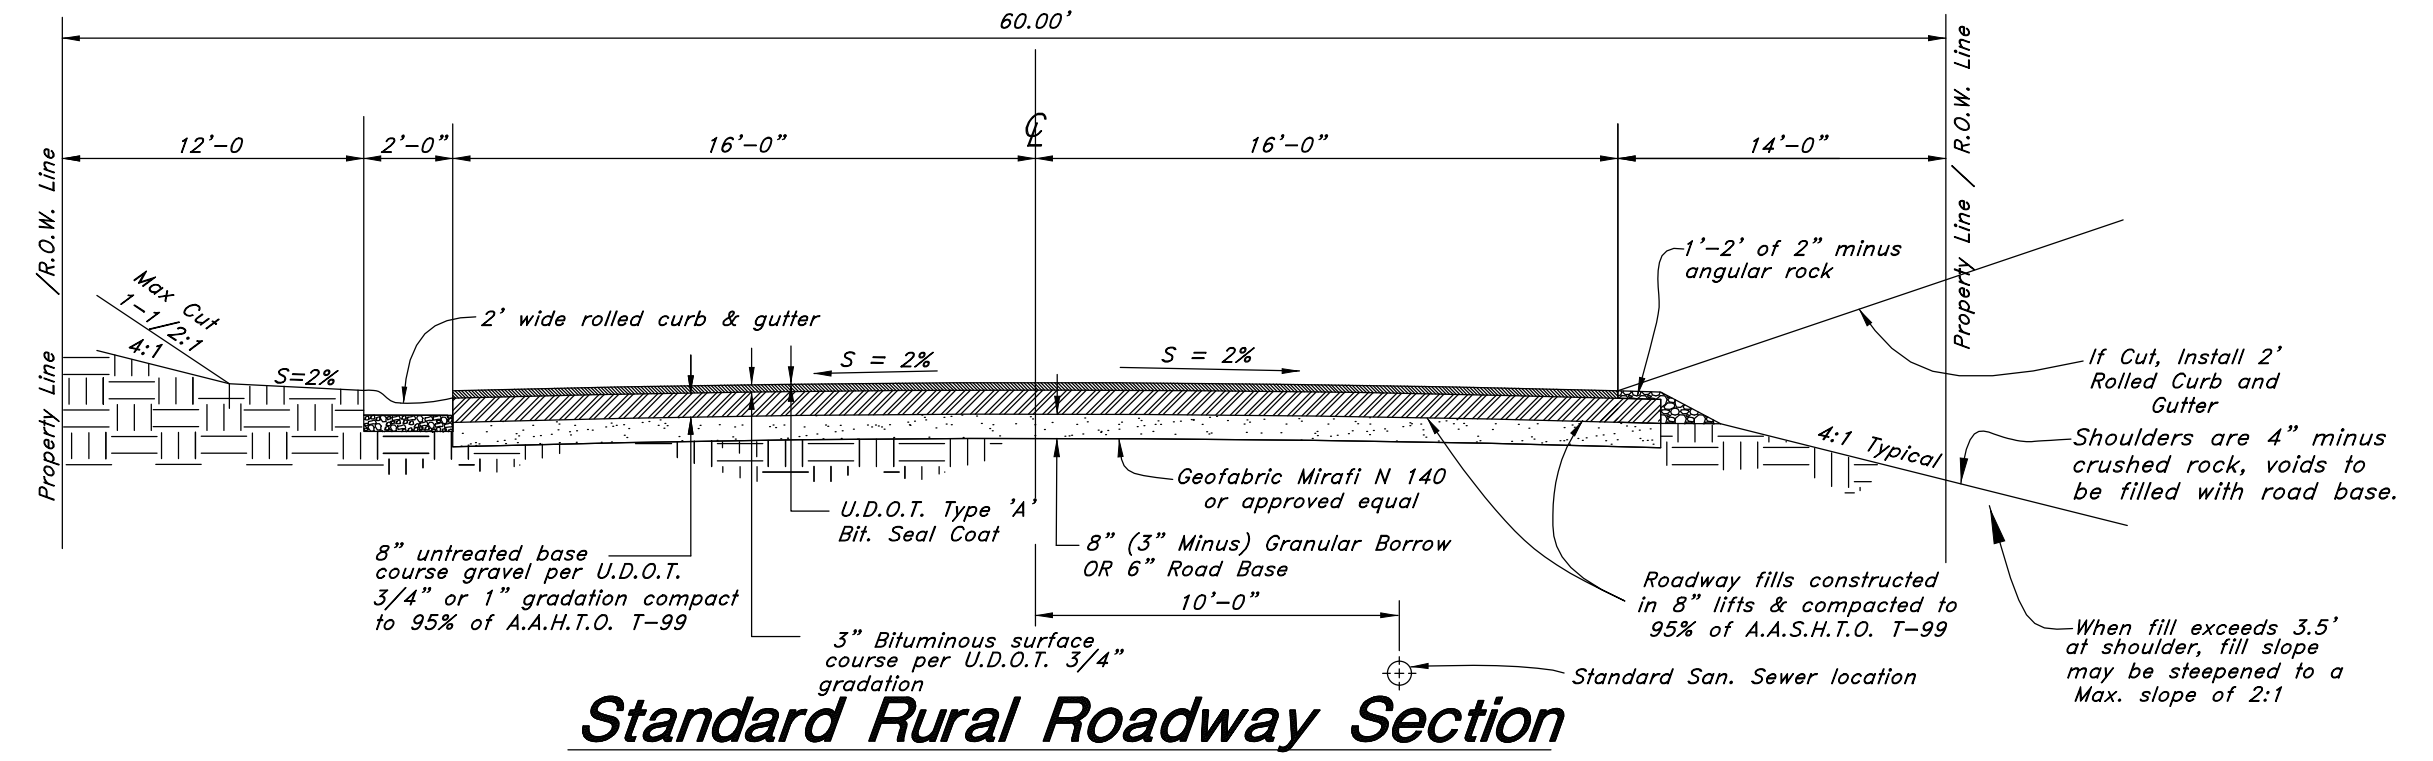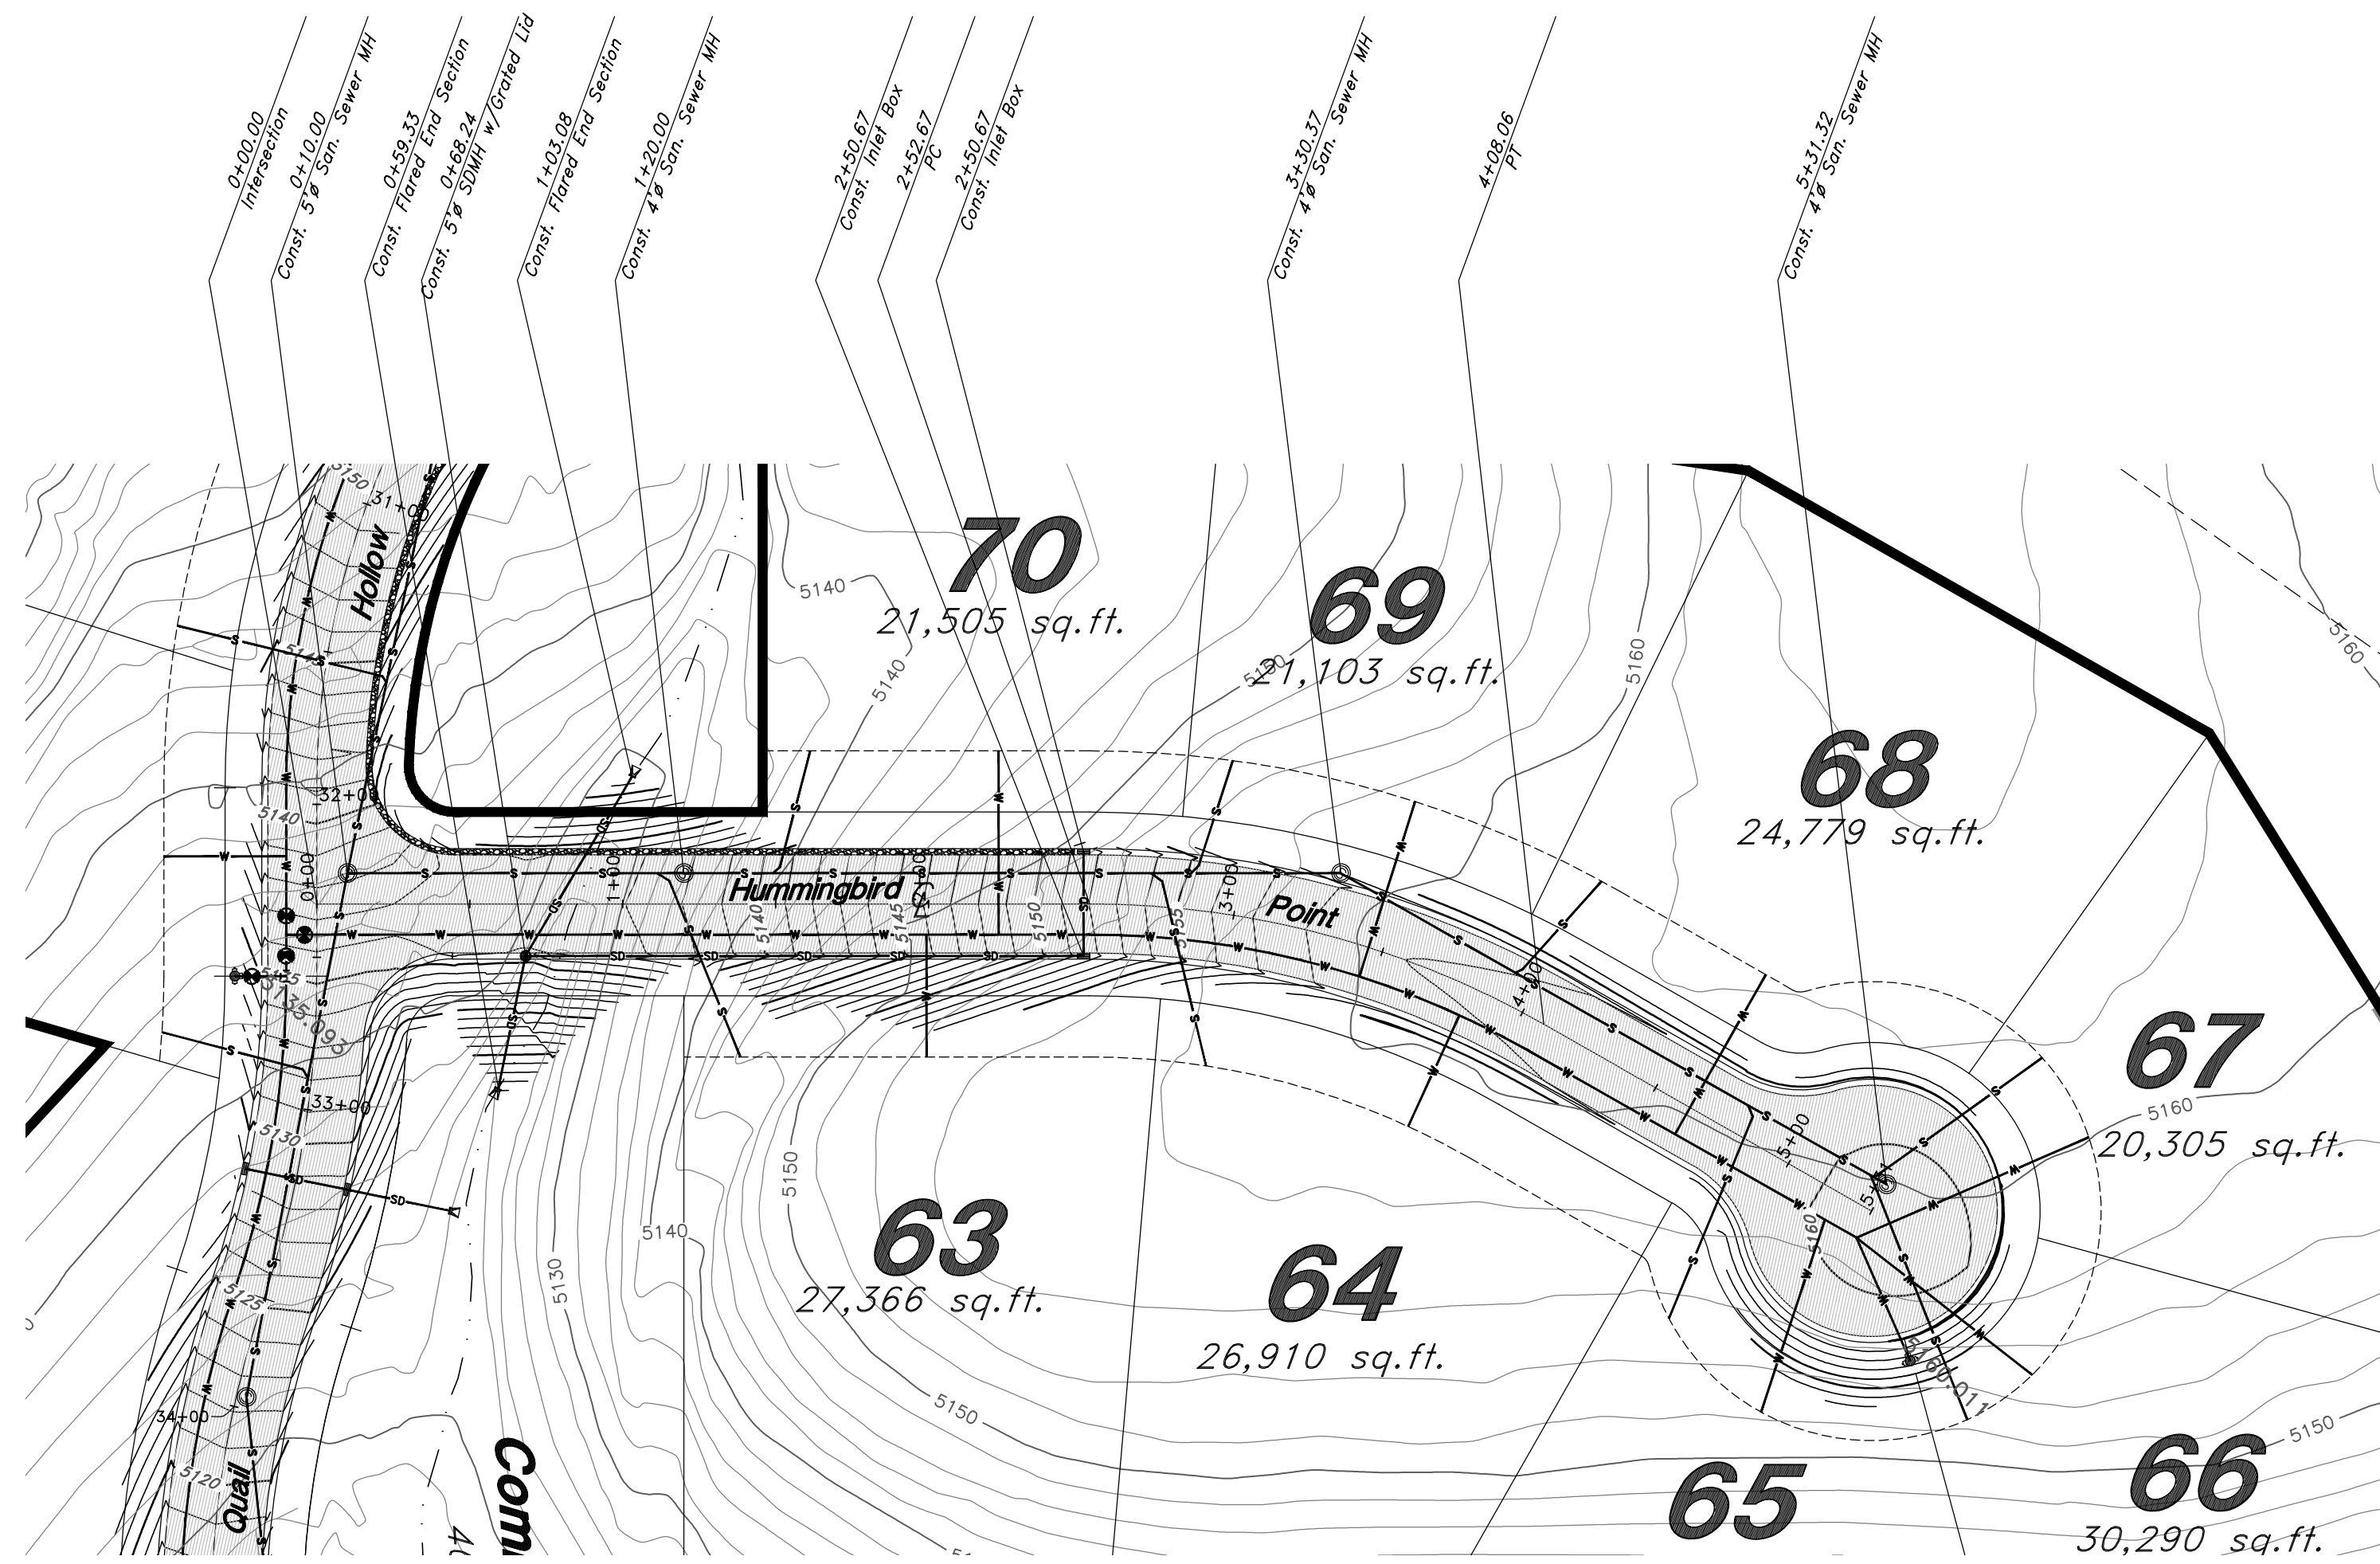


Benchmark: Monument at Intersection of Quail Lane and Meadow Lark Lane Elevation: 5022.34

NOTE: TO PREVENT SOIL EROSION, PROTECT STEEP SLOPES WITH HYDROSEEDING OR EROSION CONTROL BLANKETS.

- GENERAL GRADING NOTES:**
- All work shall be in accordance with the County Public Works Standard.
 - Cut slopes shall be no steeper than 2 horizontal to 1 vertical unless otherwise noted.
 - Fill slopes shall be no steeper than 2 horizontal to 1 vertical unless otherwise noted.
 - Fills shall be compacted per the recommendations of the geotechnical report prepared for the project and shall be certified by the geotechnical engineer.
 - Areas to receive fill shall be properly prepared and approved by the County inspector and geotechnical Engineer prior to placing fill.
 - Fills shall be benched into competent material as per specifications and geotechnical report.
 - All trench backfill shall be tested and certified by the site geotechnical engineer per the grading code.
 - A geotechnical engineer shall perform periodic inspections and submit a complete report and map upon completion of the rough grading.
 - The final compaction report and certification from the geotechnical engineer shall contain the type of field testing performed. Each test shall be identified with the method of obtaining the in-place density, whether sand cone or drive ring and shall be so noted for each test. Sufficient maximum density determinations shall be performed to verify the accuracy of the maximum density curves used by the field technician.
 - Dust shall be controlled by watering.
 - The location and protection of all utilities is the responsibility of the permittee.
 - Approved protective measures and temporary drainage provisions must be used to protect adjoining properties during the grading project.
 - All public roadways must be cleared daily of all dirt, mud and debris deposited on them as a result of the grading operation. Cleaning is to be done to the satisfaction of the county engineer.
 - The site shall be cleared and grubbed of all vegetation and deleterious matter prior to grading.
 - The contractor shall provide shoring in accordance with OSHA requirements for trench walls.
 - Aggregate base shall be compacted per the geotechnical report prepared for the project.
 - Elevations shown on this plan are finish grades. Rough grades are the subgrades of the improvements shown hereon.
 - The recommendations in the following Geotechnical Engineering Report by xxxx are included in the requirements of grading and site preparation. The report is titled "GEOTECHNICAL INVESTIGATION PROPOSED CHALETS AT SKI LAKE SUBDIVISION PHASES 7 AND 8".
 - As part of the construction documents, owner has provided contractor with a topographic survey performed by manual or aerial means. Such survey was prepared for project design purposes and is provided to the contractor as a courtesy. It is expressly understood that such survey may not accurately reflect existing topographic conditions.
 - Erosion Control: Protect all inlet boxes, catch basins, etc. with straw bales or other approved method to strain the storm water during construction. Protect surrounding properties and streets from site runoff with sandbags and earth berms.

- CURB AND GUTTER CONSTRUCTION NOTES:**
- It is the responsibility of the surveyor to adjust top of curb grades at the time construction staking.
 - Refer to the typical details for curb and gutter for dimensions.

ALL CONSTRUCTION TO CONFORM TO CITY STANDARDS AND SPECIFICATIONS IN RIGHT OF WAY

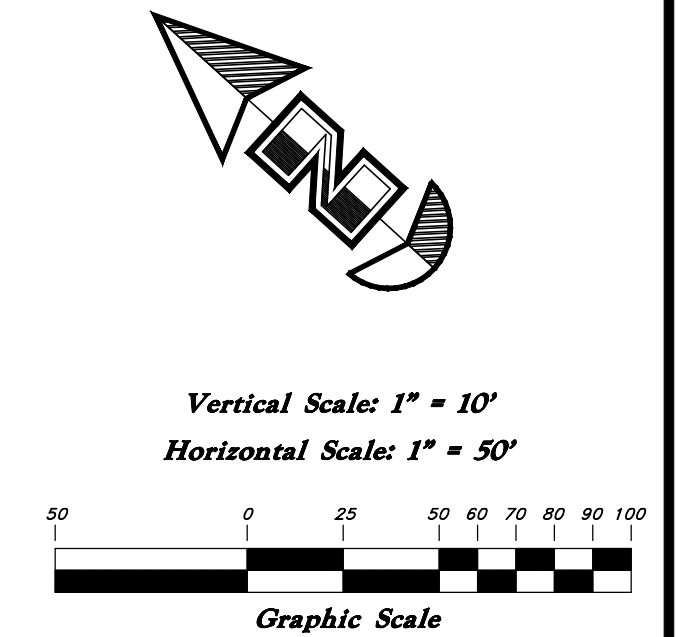

Legend


(Note: All items may not appear on drawing)

- San. Sewer Manhole
- Water Manhole
- Storm Drain Manhole
- Electrical Manhole
- Catch Basins
- Exist. Fire Hydrant
- Exist. Water Valve
- Water Valve
- Sanitary Sewer
- Sanitary Sewer
- Gas Line
- Irrigation Line
- Storm Drain
- Telephone Line
- Secondary Waterline
- Power Line
- Fire Line
- Land Drain
- Power pole
- Power pole w/guy
- Light Pole
- Fence
- Flowline of ditch
- Overhead Power line
- Corrugated Metal Pipe
- Concrete Pipe
- Reinforced Concrete Pipe
- Ductile Iron
- Polyvinyl Chloride
- Top of Asphalt
- Edge of Asphalt
- Centerline
- Flowline
- Finish Floor
- Top of Curb
- Top of Wall
- Top of Walk
- Top of Concrete
- Natural Ground
- Finish Contour
- Exist. Contour
- Finish Grade
- Exist. Grade
- Ridge Line
- Direction of Flow
- Existing Asphalt
- New Asphalt
- Heavy Duty Asphalt
- Concrete
- Open Face Curb & Gutter

Plan / Profile (Utility)

The Chalets at Ski Lake No. 8











A part of the Southwest 1/4 of Section 13, a part of the Northeast 1/4 of Section 23, and a part of the Northwest 1/4 of Section 24, T6N, R1E, S16&M, U.S. Survey

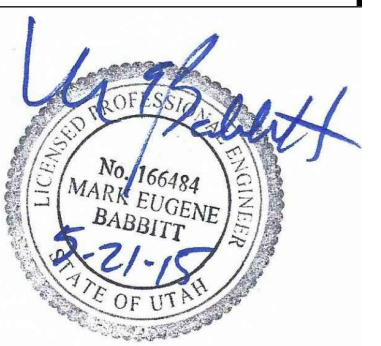

Mar, 2015

SHEET NO. **2a**


96N120 Waterline

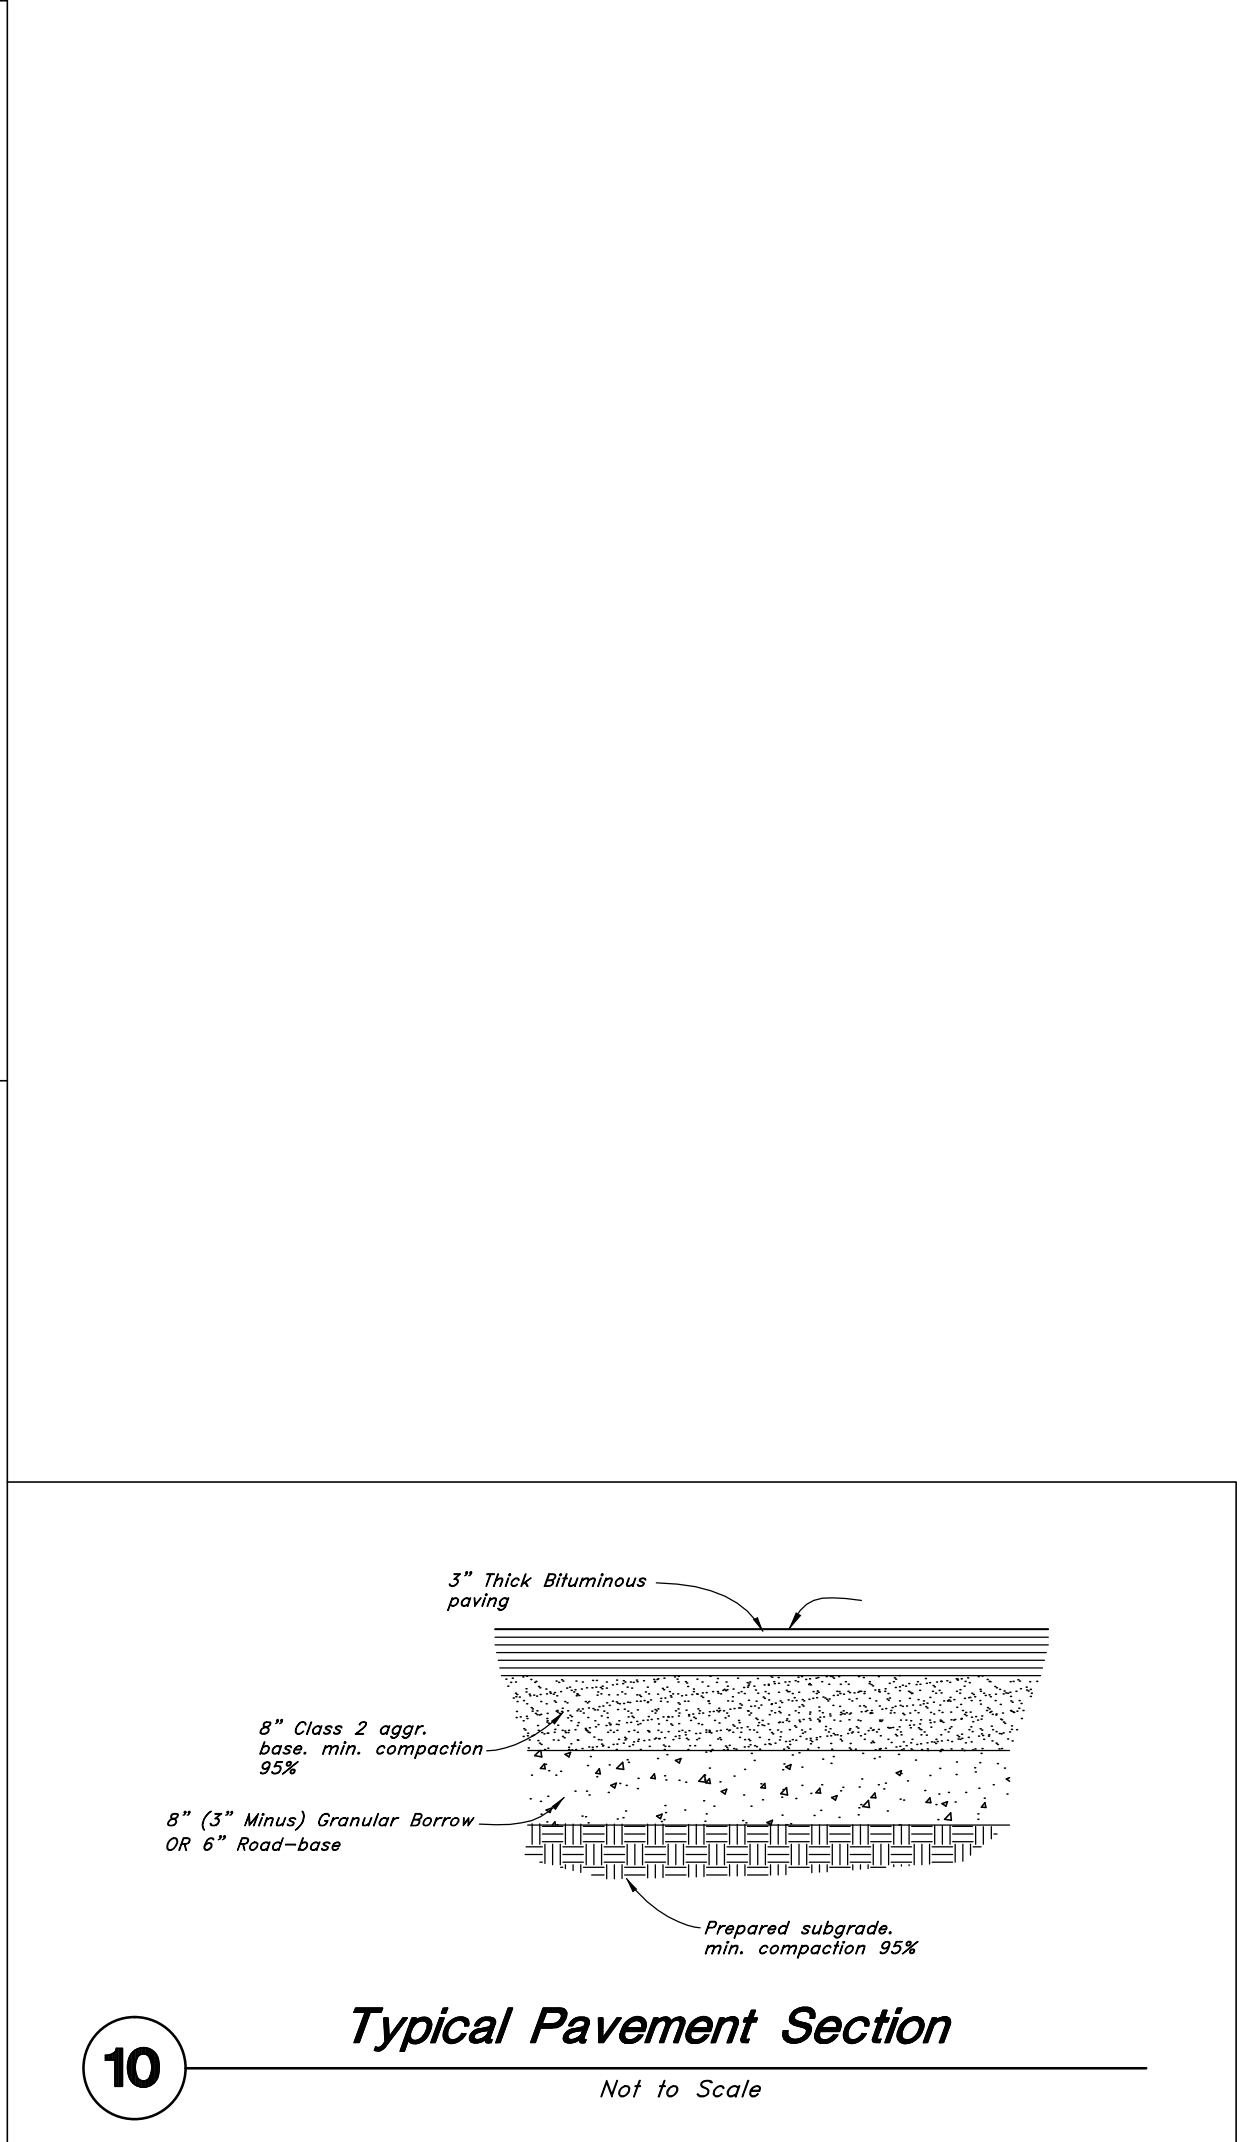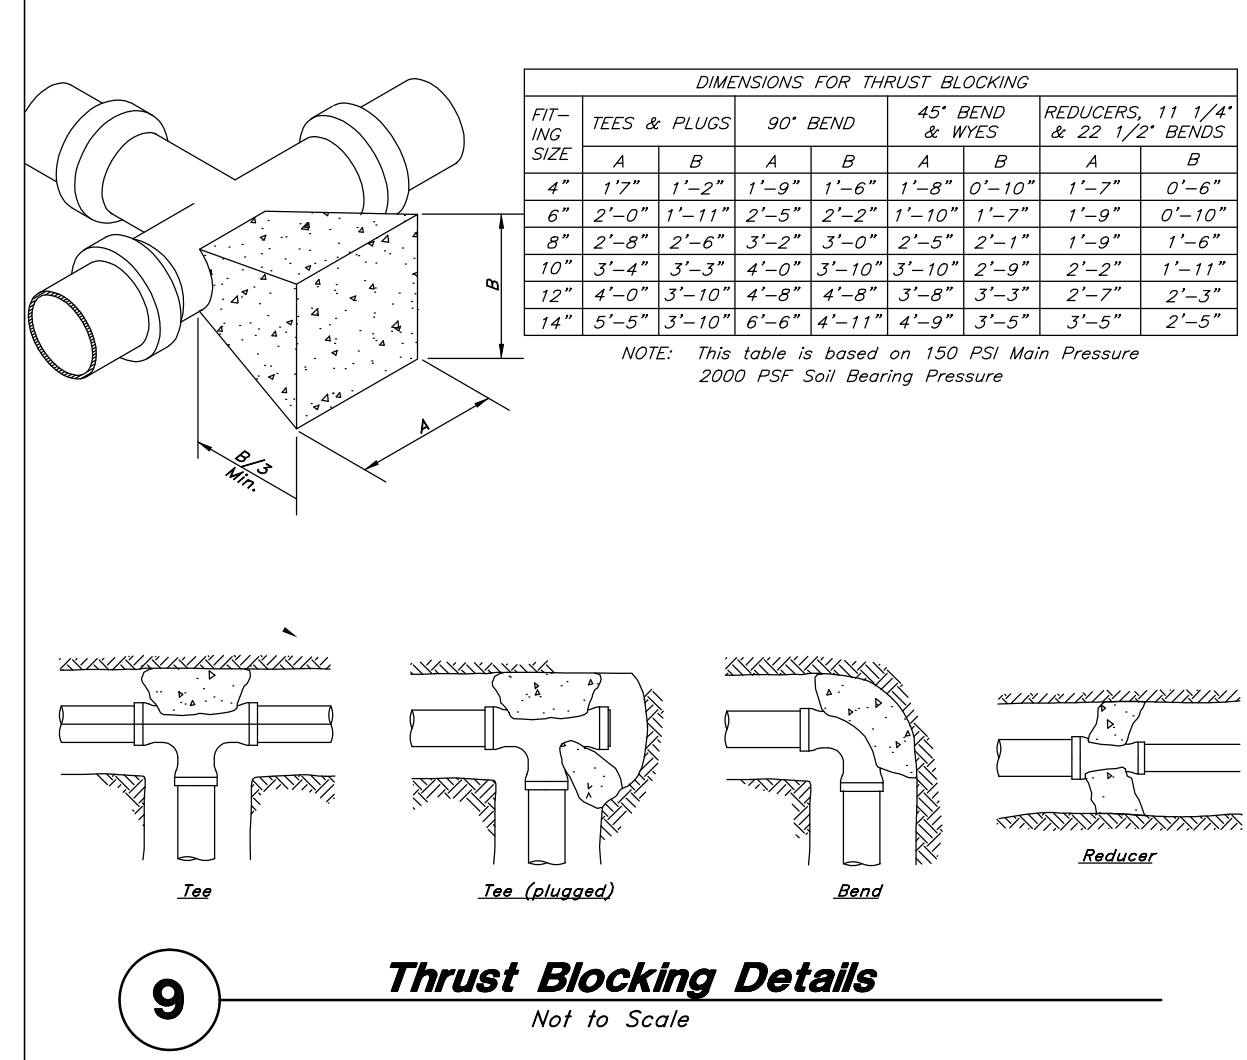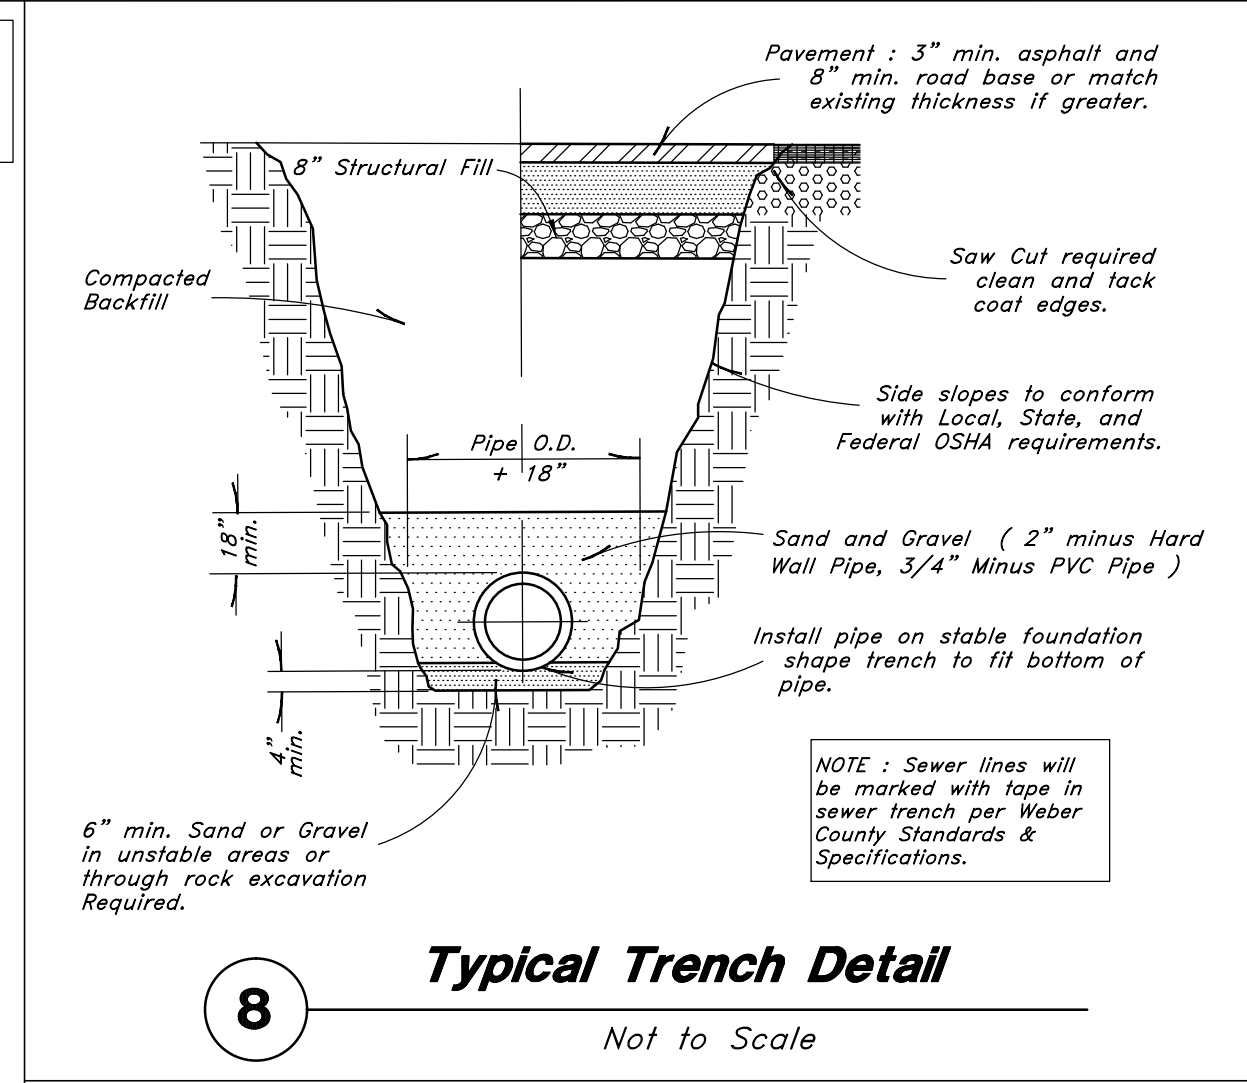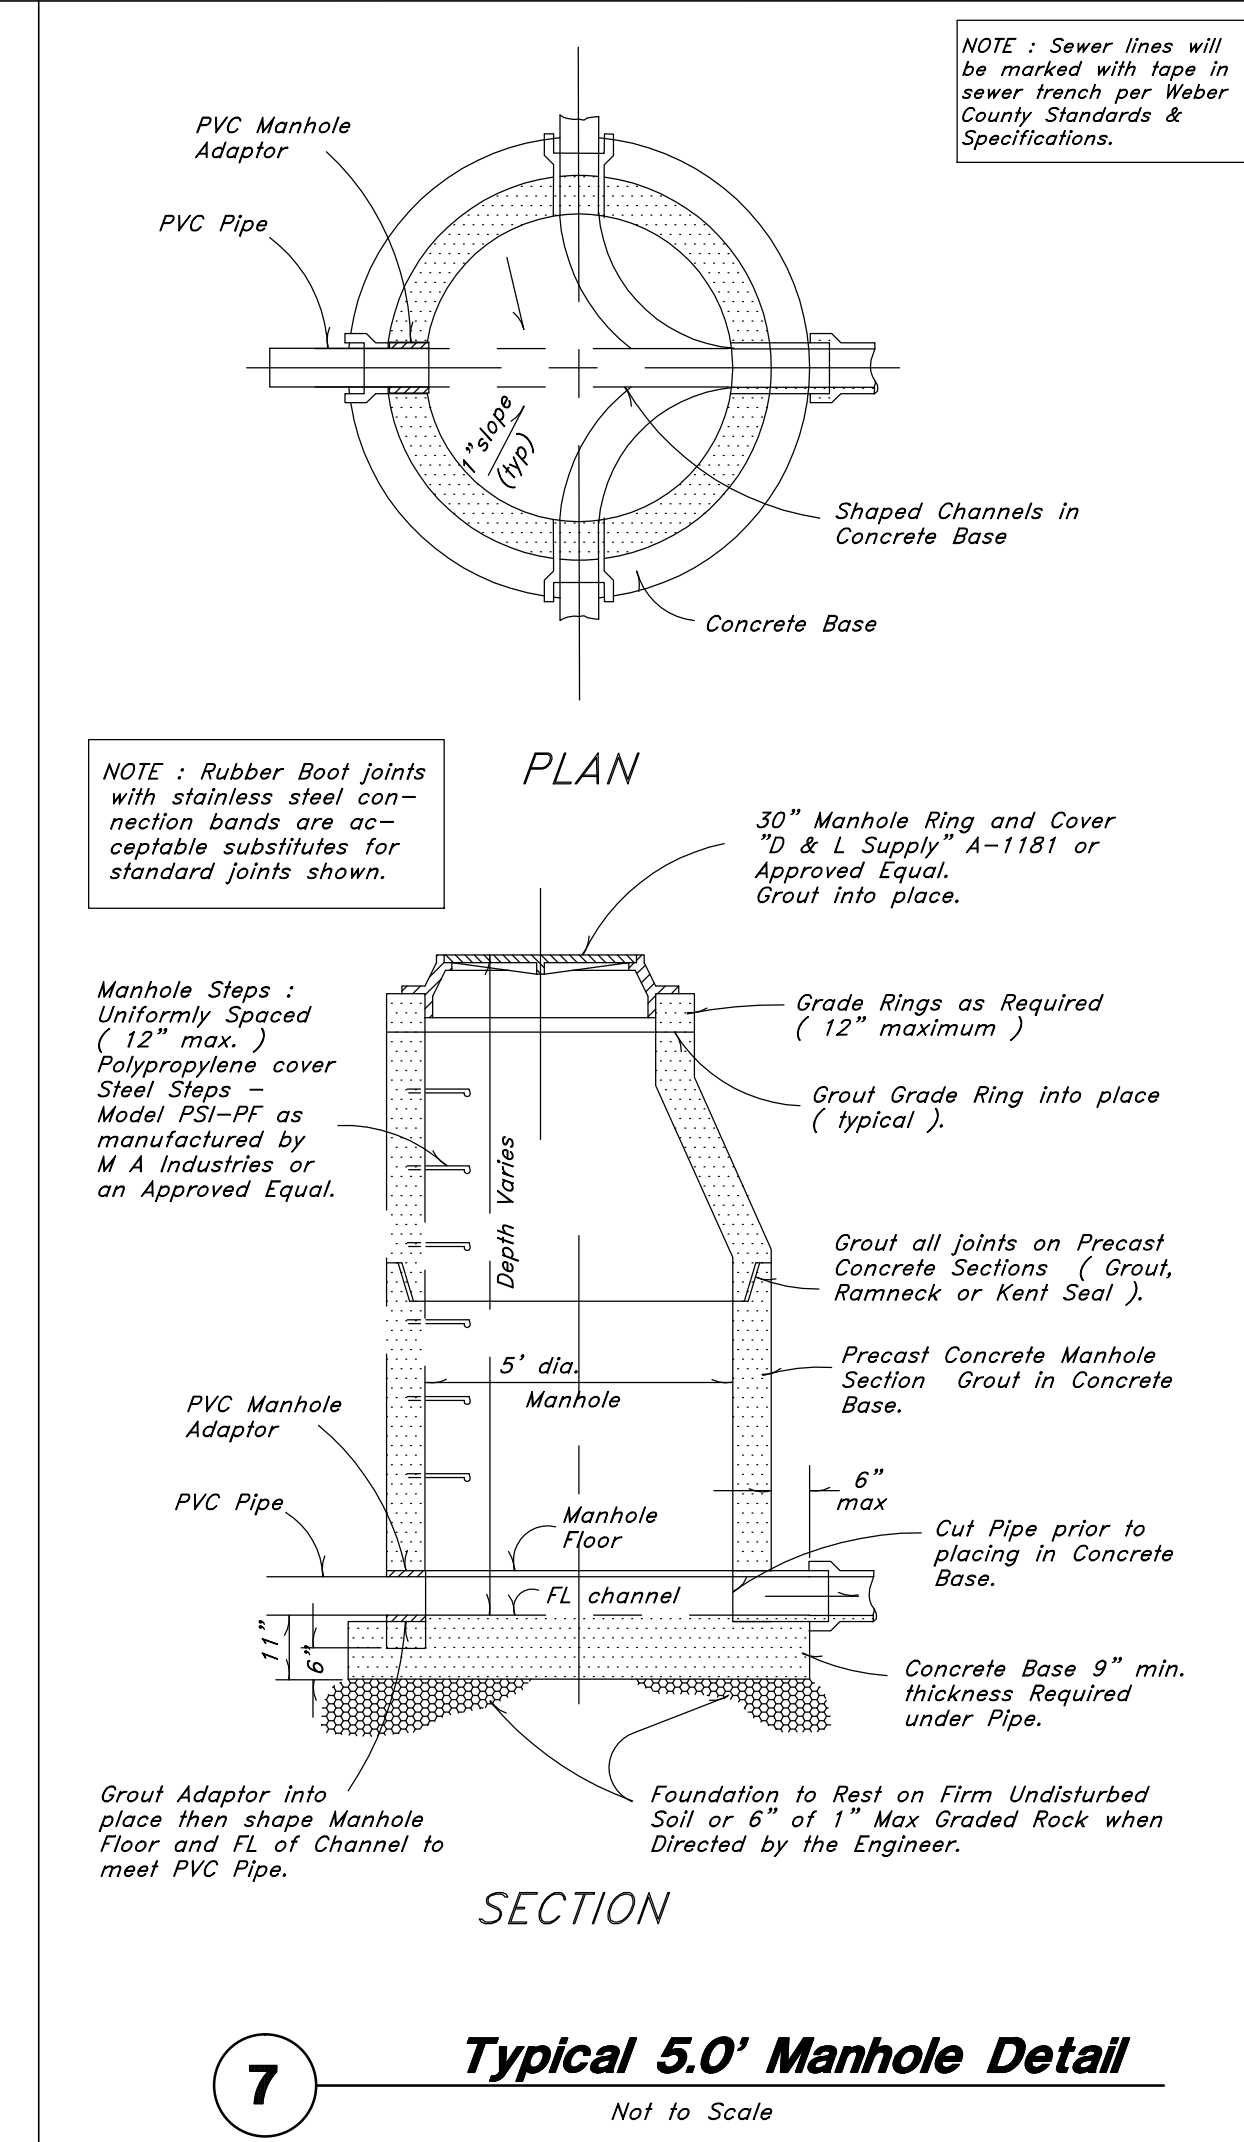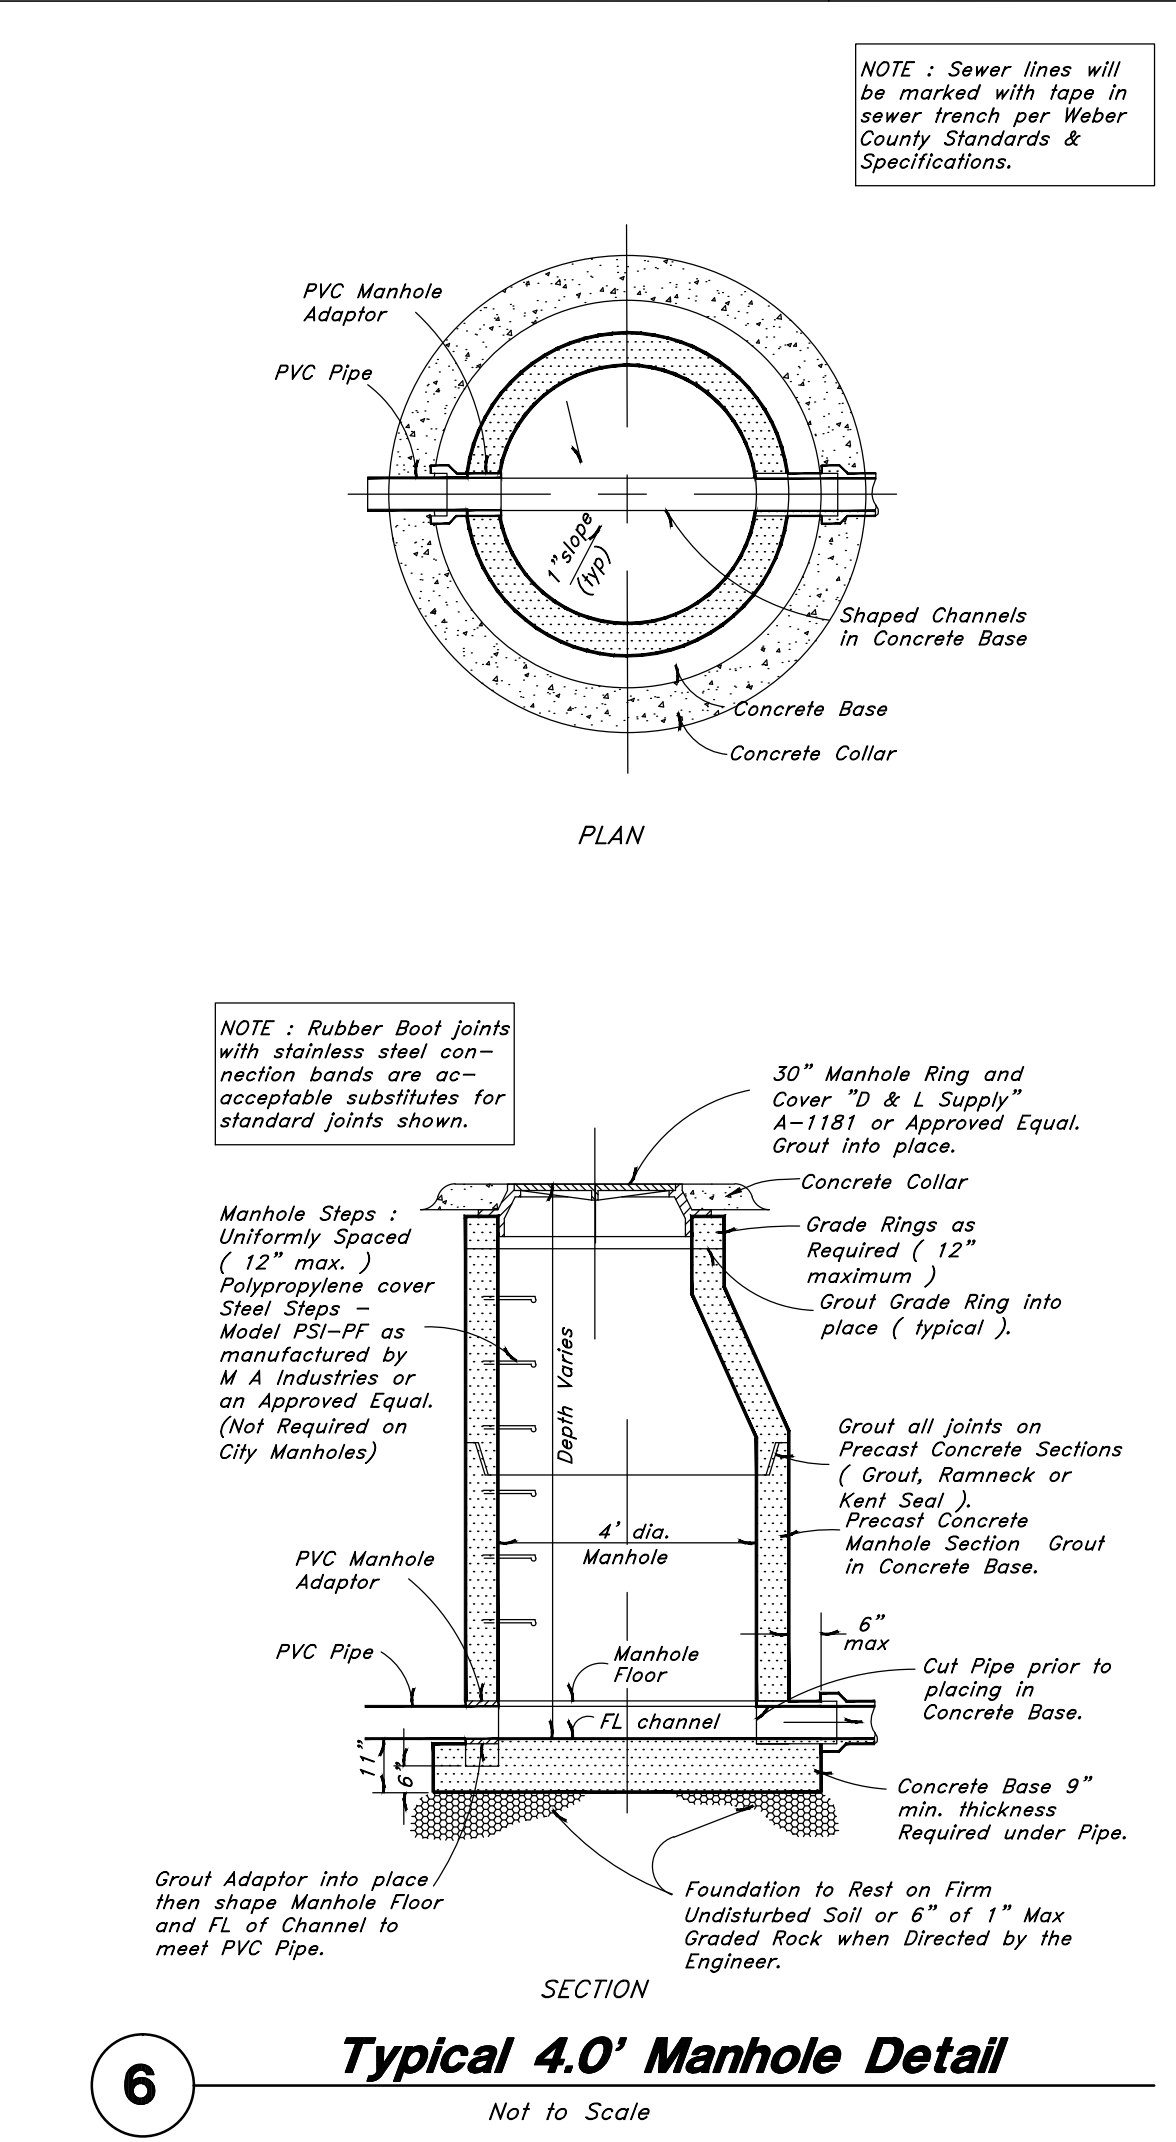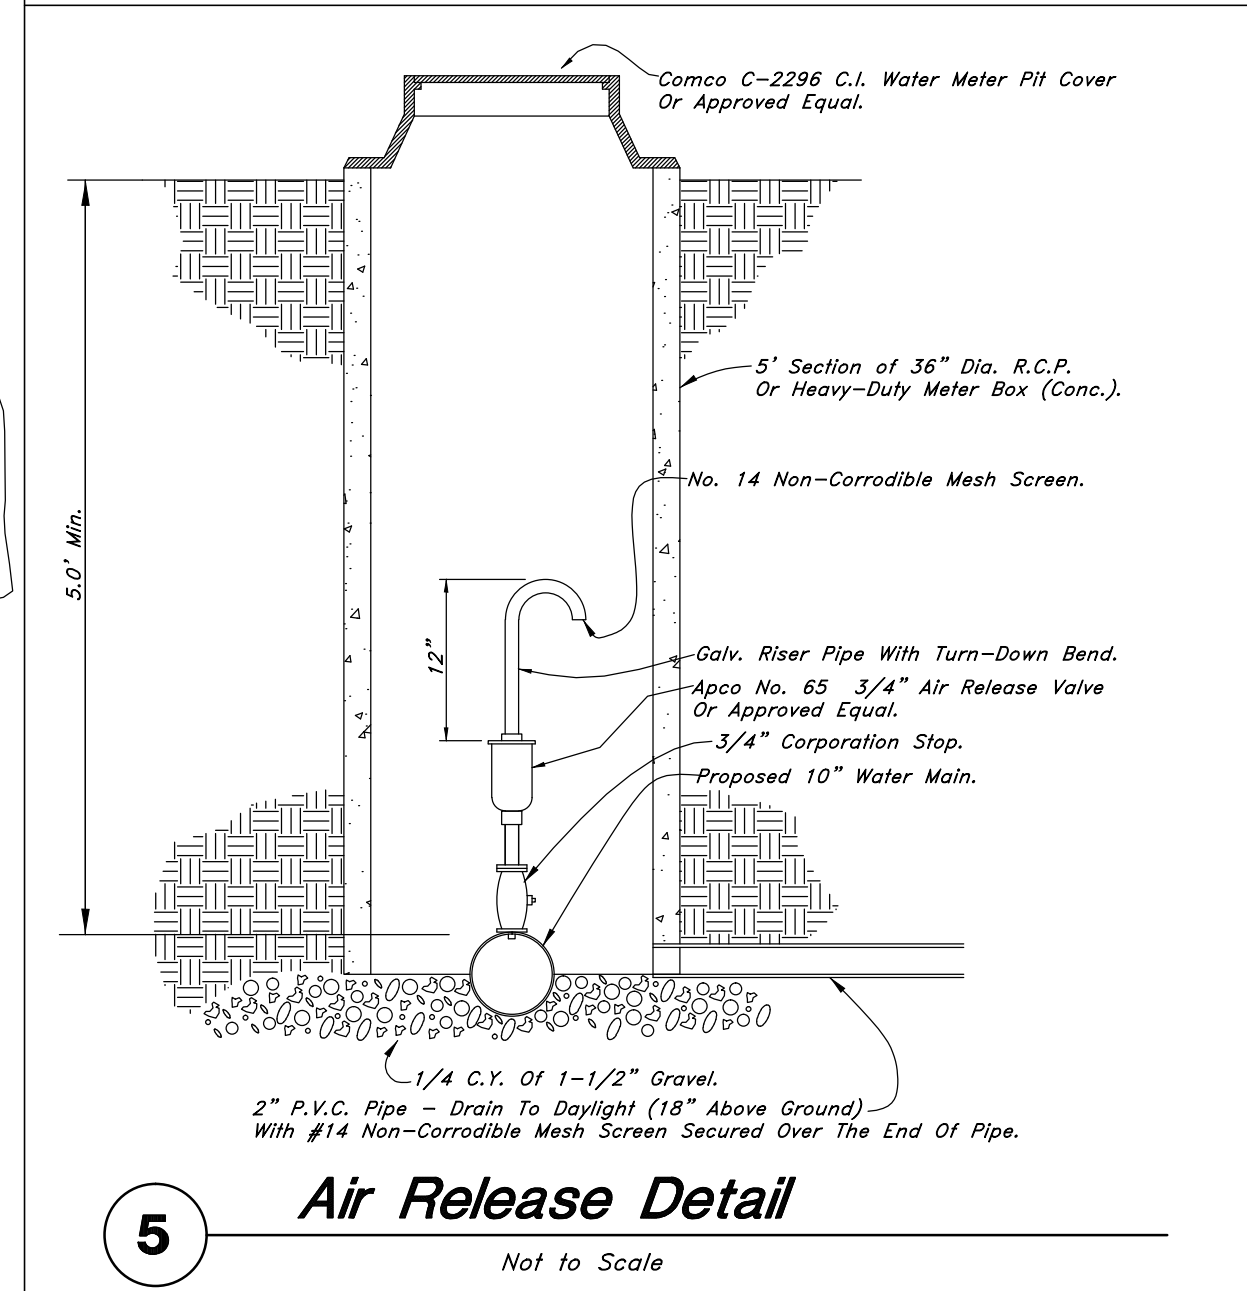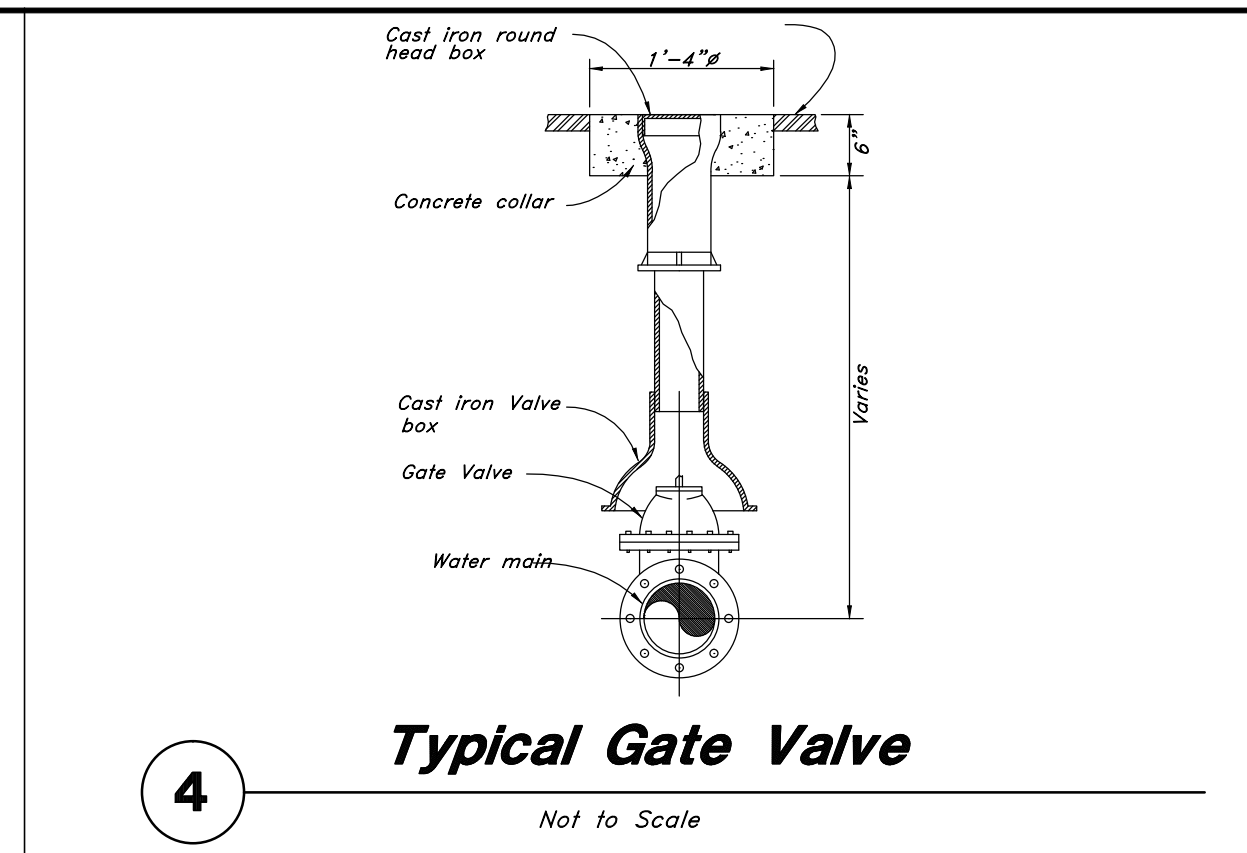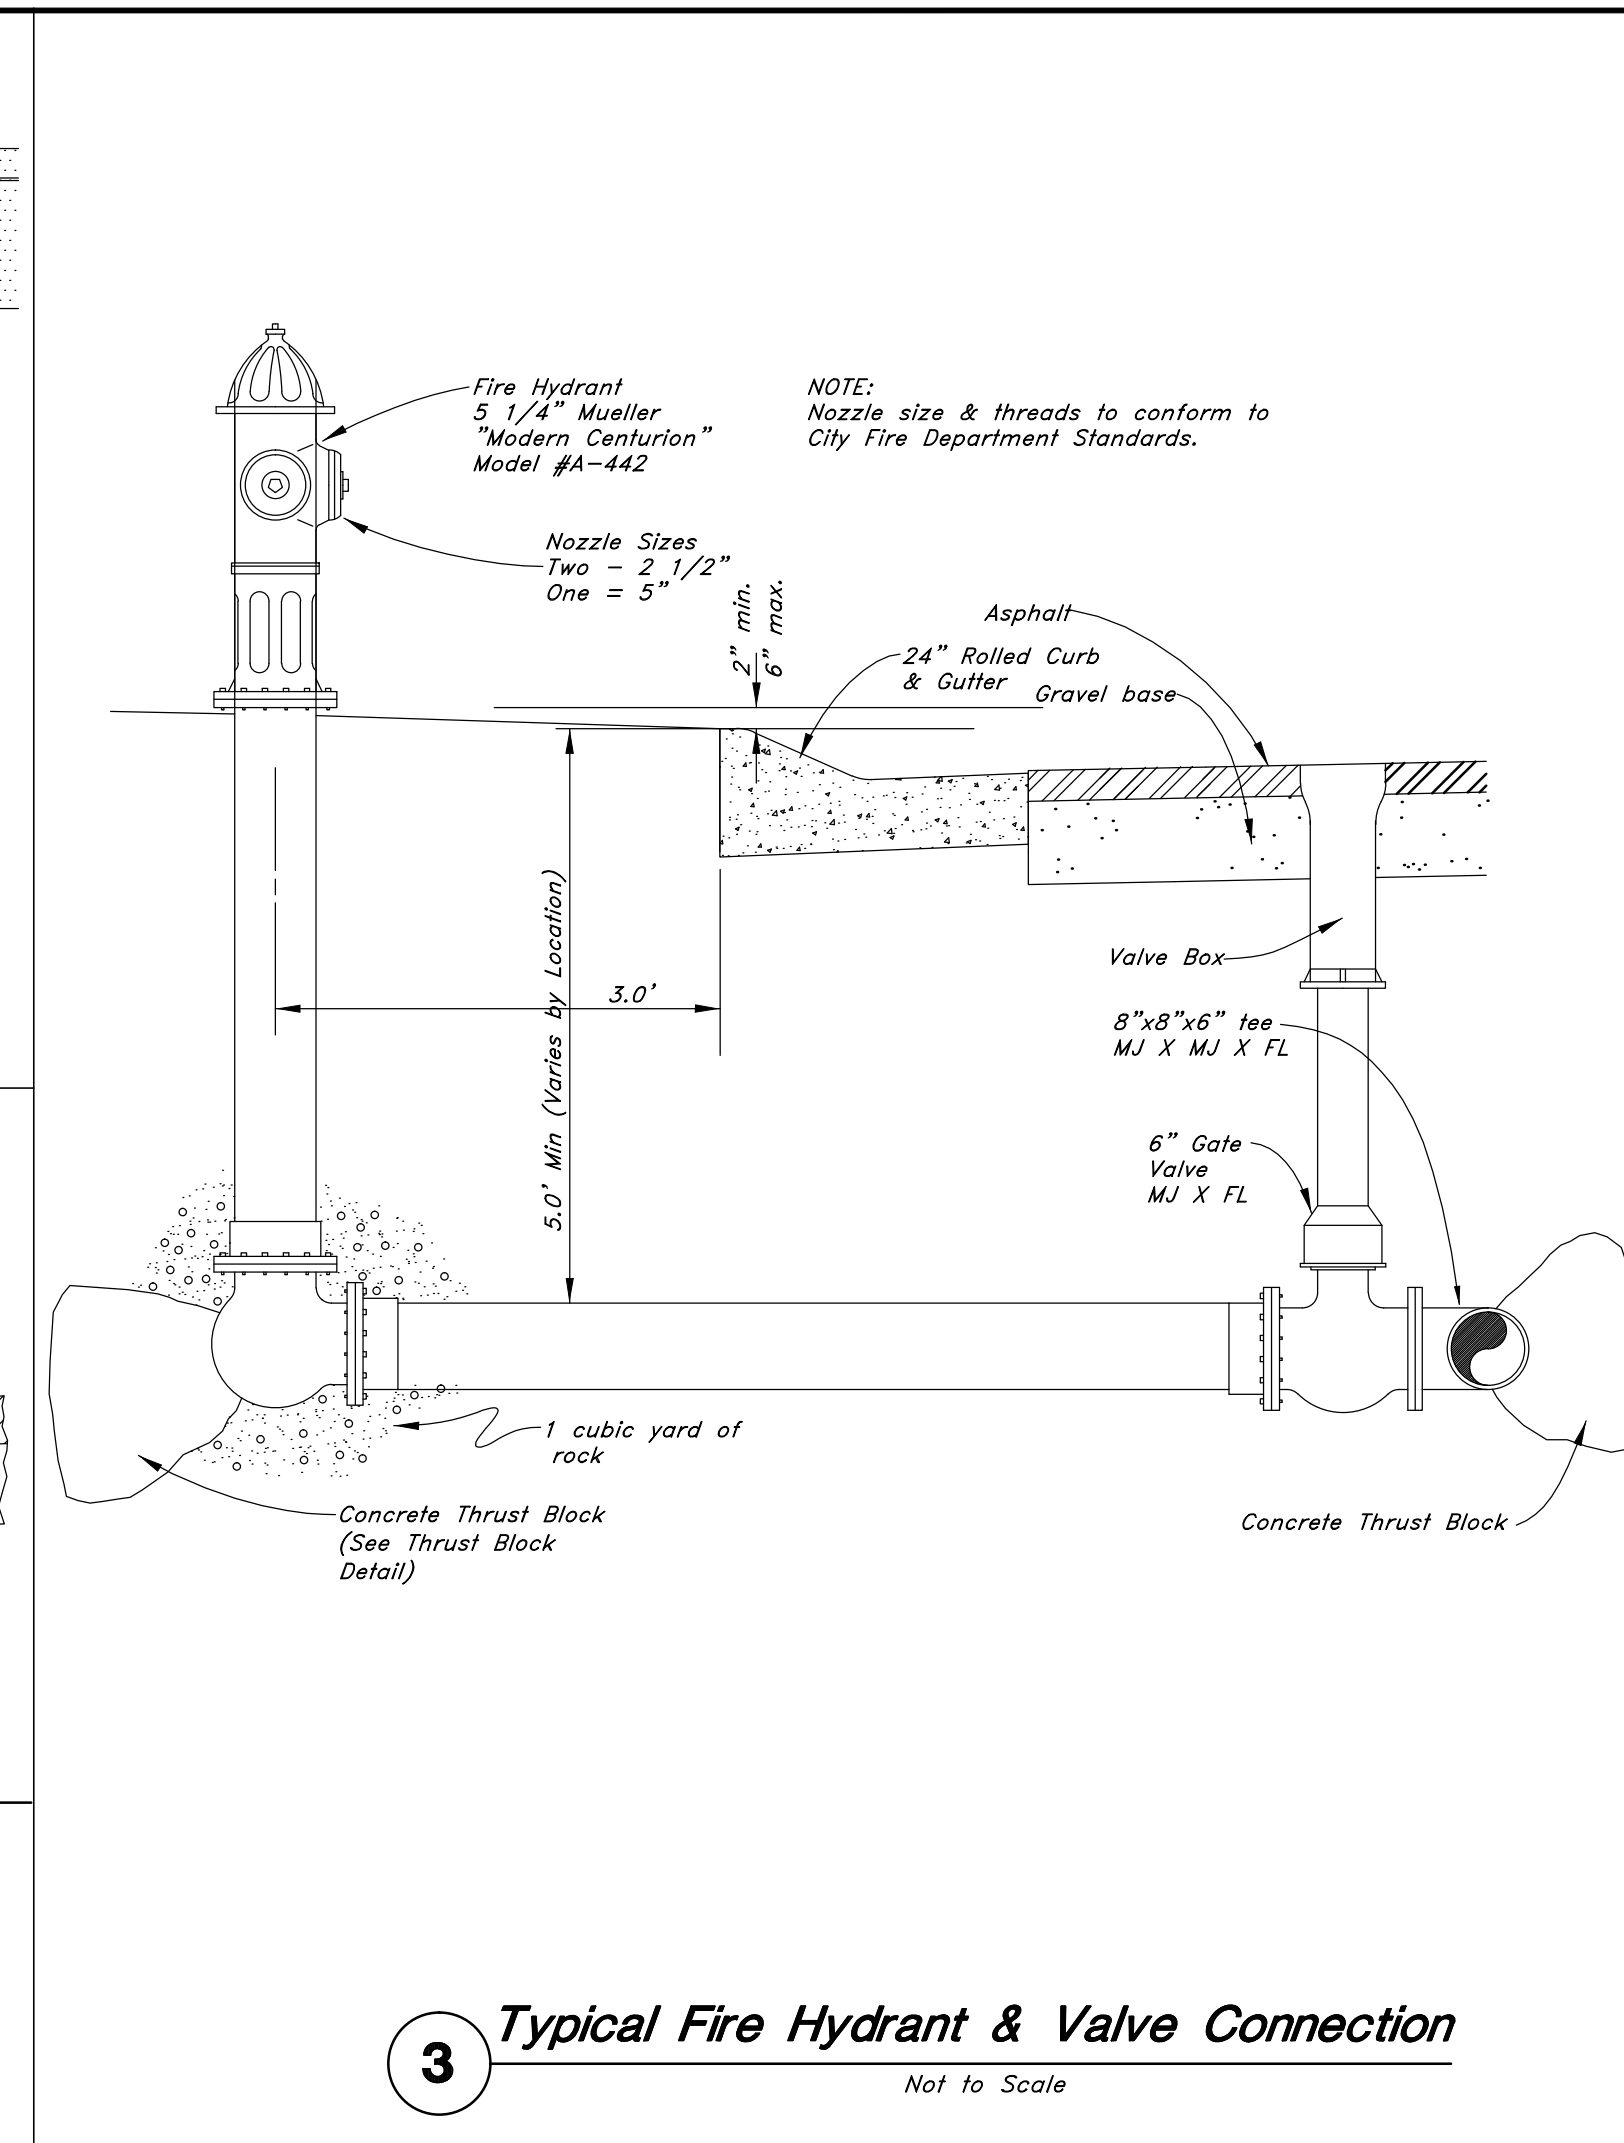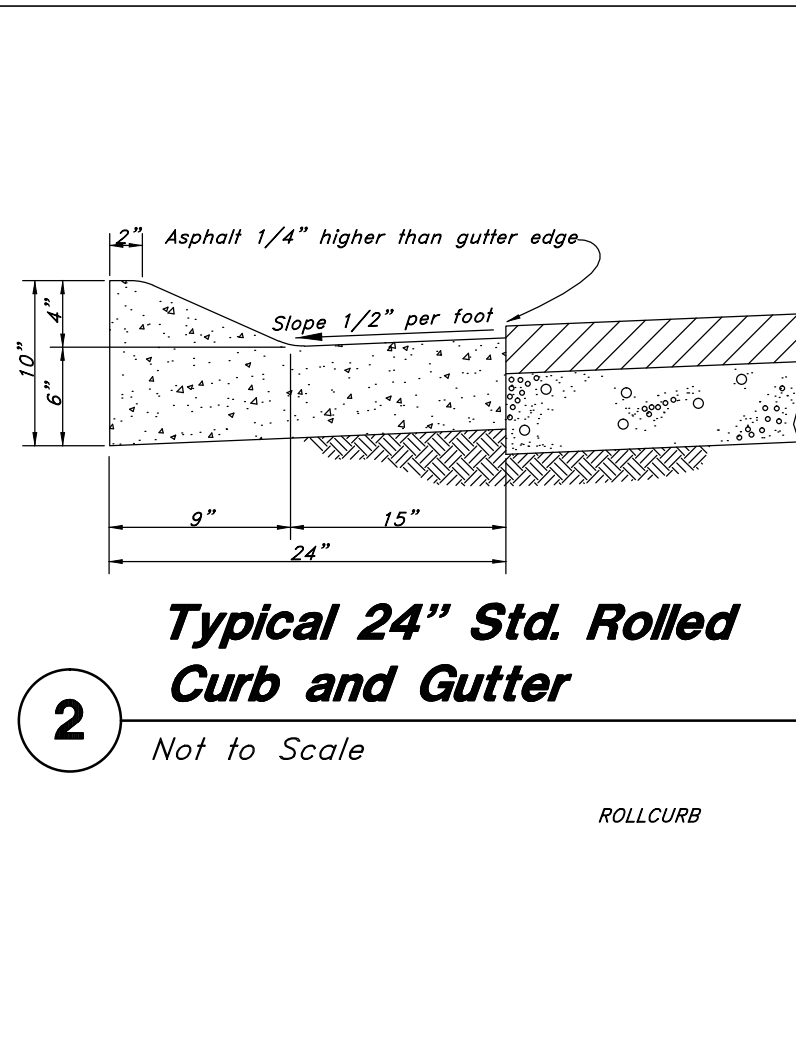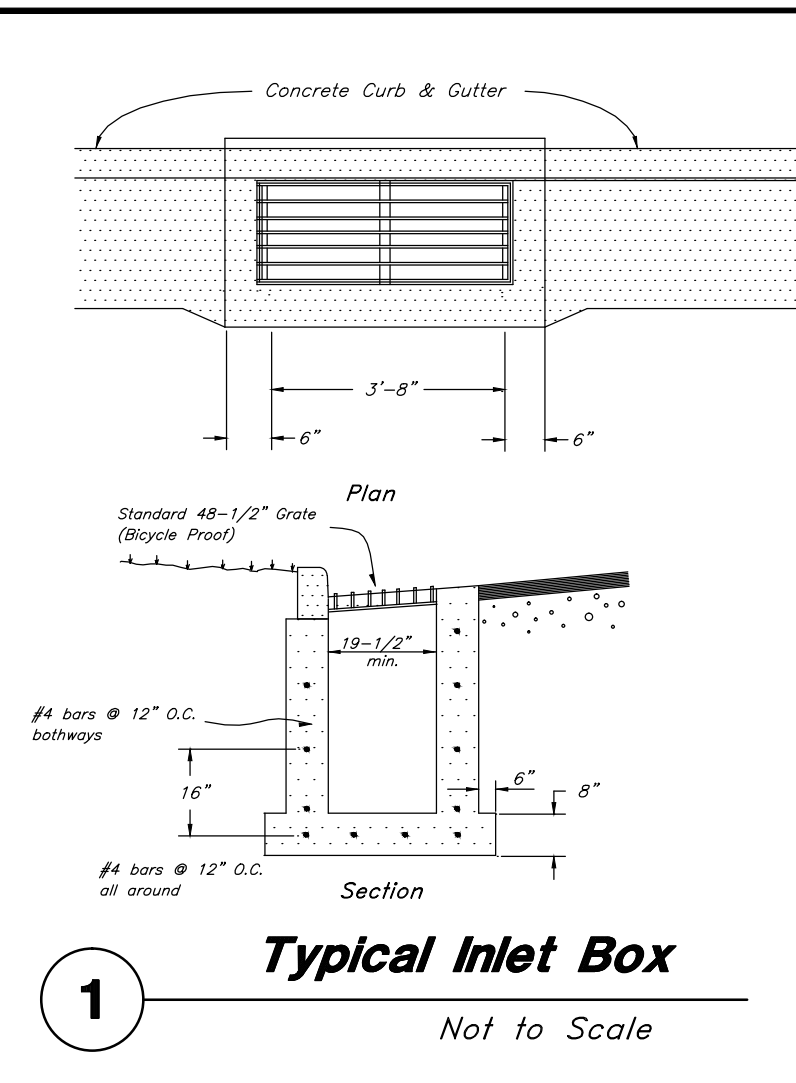


REV	DATE	DESCRIPTION

REV	DATE	DESCRIPTION


Details
The Chalets at Ski Lake No. 8
A part of the Southwest 1/4 of Section 13, a part of the Northeast 1/4 of Section 23, and a part of the Northwest 1/4 of Section 24, T6N, R1E, S18&M, U.S. Survey

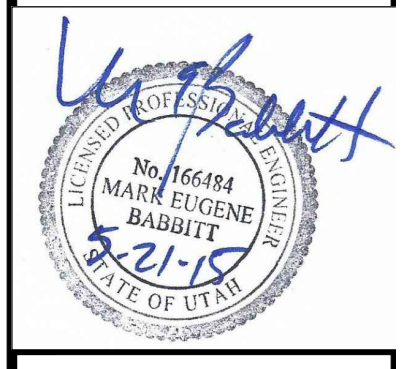

Mar, 2015
SHEET NO. **3**
96N120 Waterline

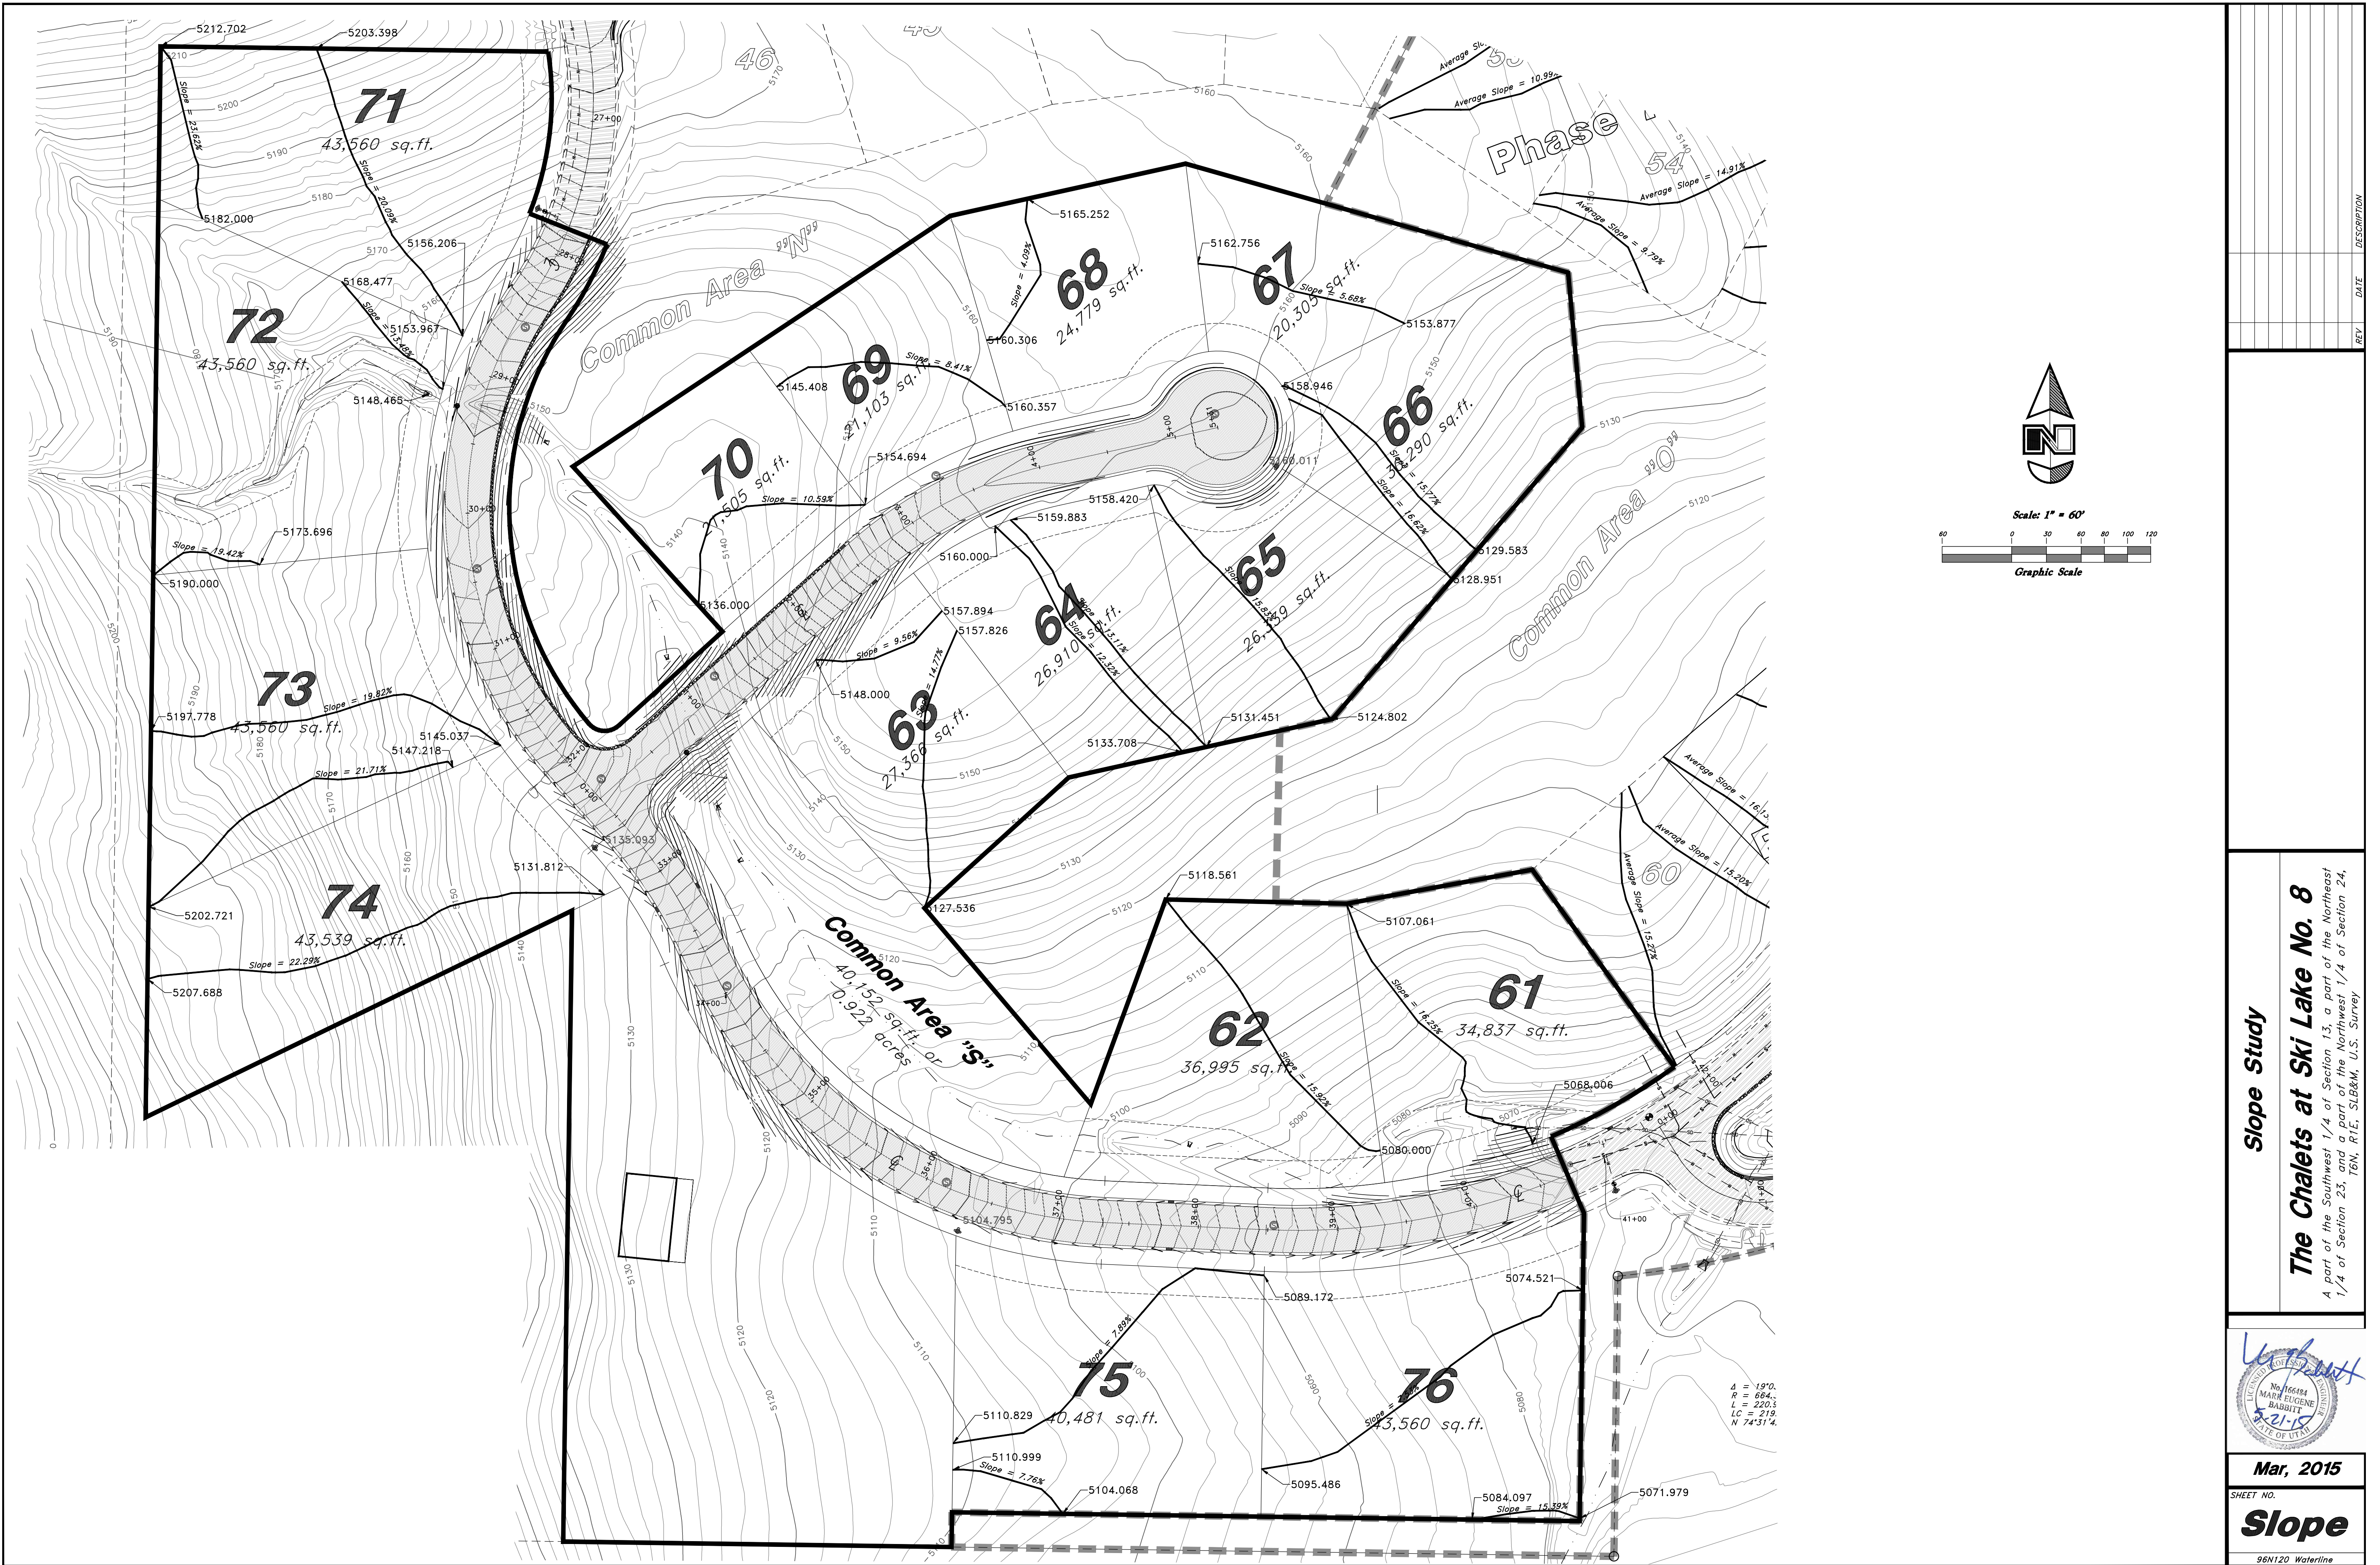

Slope Study
The Chalets at Ski Lake No. 8
 A part of the Southwest 1/4 of Section 13, a part of the Northeast 1/4 of Section 23, and a part of the Northwest 1/4 of Section 24, T6N, R1E, S16&M, U.S. Survey

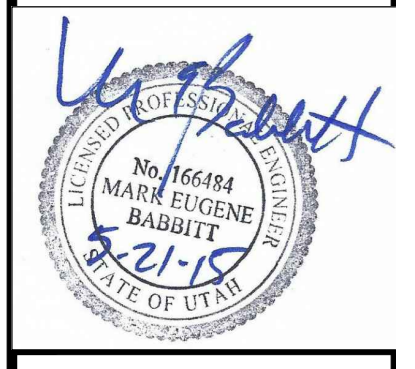

Mar, 2015
 SHEET NO.
Slope
 96N120 Waterline