CROWN CASTLE USA INC.

SITE NAME

BU NUMBER:

TOWER OWNER:

SITE ADDRESS:

LAT/LONG TYPE:

CURRENT ZONING:

IAP/PARCEL#:

GROUND ELEVATION:

AREA OF CONSTRUCTION:

TYPE OF CONSTRUCTION:

A.D.A. COMPLIANCE:

PROPERTY OWNER

URISDICTION:

ELECTRIC PROVIDER

TELCO PROVIDER:

OCCUPANCY CLASSIFICATION: U

COUNTY:

LATITUDE:

CARRIER/APPLICANT:

The Mobile

T-MOBILE SITE NUMBER: SL01312A

CROWN: WWEBER BAUGH (823835) T-MOBILE SITE NAME:

SHEET#

T-1

T-2

C-1.1

C-1.2

C-1.3

C-2

C-3

C-4

C-5.1

C-5.2

C-5.3

E-1

E-2

G-1

G-2

G-3

TITLE SHEET

GENERAL NOTES

COMPOUND PLAN

EXISTING EQUIPMENT PLAN

FINAL EQUIPMENT SCHEDULE

FINAL EQUIPMENT PLAN

TOWER ELEVATIONS

ELECTRICAL DETAILS

GROUNDING DETAILS

GROUNDING DETAILS

ANTENNA PLANS

T-MOBILE PROJECT: **ANCHOR**

SITE INFORMATION

WWEBER_BAUGH

CROWN CASTLE

2000 CORPORATE DRIVE

1200 CONCORD AVENUE SUITE 500

FACILITY IS UNMANNED AND

FANTASTIC FINDS LLC 2345 HITCHING POST DR

GREEN RIVER, WY 82935

ROCKY MOUNT POWER

WEBER COUNTY

OGDEN, UT 84401

(252) 972-1250

TBD

NOT FOR HUMAN HABITATION

2380 WASHINGTON BLVD., SUITE 240

CANONSBURG, PA 1531

CONCORD, CA 94520

OGDEN, UT 84401

1224 S 4700 W

41° 14' 39.50" N

112° 05' 16.10" W

WEBER

NAD83

4227' ± SE

EXISTING

RAN TEMPLATE: 67D5D3998E INDOOR **BUSINESS UNIT #:** 829171

1224 S 4700 W **SITE ADDRESS:**

OGDEN, UT 84401

WEBER **COUNTY:**

MONOPOLE SITE TYPE:

TOWER HEIGHT: 119'-0"

PROJECT DESCRIPTION

THE PURPOSE OF THIS PROJECT IS TO ENHANCE BROADBAND CONNECTIVITY AND CAPACITY TO THE EXISTING ELIGIBLE


TOWER SCOPE OF WORK:

- REMOVE (3) ERICSSON AIR21_KRC118046/1_B2P_B4A ANTENNAS • REMOVE (3) ERICSSON - AIR21_KRC118023/1_B2A_B4P ANTENNAS
- REMOVE (12) COAX CABLES
- RELOCATE (3) 4449
- INSTALL (3) ERICSSON AIR 6419 B41 ANTENNAS
- INSTALL (3) ERICSSON 4460 B25+B66 RRUS
- INSTALL (1) SITEPRO1 PRK-1245L KICKER KIT
- INSTALL (1) SITEPRO1 PRK-SFS-L STABILIZER KIT

GROUND SCOPE OF WORK:

- REMOVE (2) NORTEL CABINETS • REMOVE (1) RBS3206 CABINET
- REMOVE (1) PBC6500 CABINET
- REMOVE (1) CSR 7210 SAS-MXP
- REMOVE (1) XMU
- REMOVE (1) ERICSSON 9x18 HCS CABLE • REMOVE (6) ERICSSON - TRX RRUS
- REMOVE (1) 200 AMP PPC
- REMOVE (1) SUB-PANEL
- INSTALL (1) POWER 6230_V2 CABINET
- INSTALL (1) 200A DISCONNECT
- INSTALL (1) CSR IXR V2 (GEN2)
- INSTALL (1) 24 POSITION 200 AMP PPC
- INSTALL (2) HYBRID FIBER CABLES (1-5/8")

LOCATION MAP

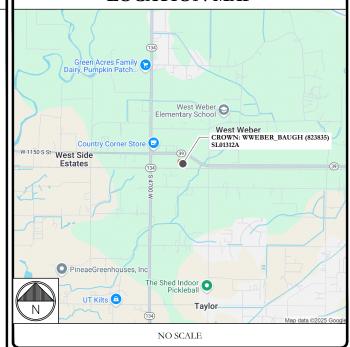

APPLICABLE CODES & REFERENCE DOCUMENTS

ALL WORK SHALL BE PERFORMED AND MATERIALS INSTALLED IN ACCORDANCE WITH THE CURRENT EDITIONS OF THE FOLLOWING CODES AS ADOPTED BY THE LOCAL GOVERNING AUTHORITIES. NOTHING IN THESE PLANS IS TO BE CONSTRUED TO PERMIT WORK NOT CONFORMING TO THESE CODES:

CODE TYPE

BUILDING MECHANICAL ELECTRICAL.

UTAH STATE CONSTRUCTION CODE/2021 IBC LITAH STATE CONSTRUCTION CODE /2021 IMC UTAH STATE CONSTRUCTION CODE/2020 NEC

REFERENCE DOCUMENTS:

STRUCTURAL ANALYSIS: BY OTHERS

DATED:

MOUNT ANALYSIS: POD GROUP (25-177299)

DATED: 1/9/2025 RFDS REVISION: 4

DATED: 12/03/2024

ORDER ID: 685407 REVISION: 0

PROJECT TEAM

A&E FIRM:

KIMLEY-HORN & ASSOCIATES, INC. 3875 EMBASSY PKWY, SUITE 280 AKRON, OH 44333

MICHAEL.KRIEG@KIMLEY-HORN.COM

CROWN CASTLE

2000 CORPORATE DRIVE CANONSBURG, PA 15317

PRIOR TO ACCESSING/ENTERING THE SITE YOU MUST CONTACT THE

CROWN NOC AT (800) 788-7011 & CROWN CONSTRUCTION MANAGER

OLEG GAPONOV - AES CONTACTS:

OLEG.GAPONOV @CROWN CASTLE.COM

CALL UTAH ONE CALL (800) 662-4111 CALL 3 WORKING DAYS

ALL DRAWINGS CONTAINED HEREIN ARE FORMATTED FOR 22X34. CONTRACTOR SHALL VERIFY ALL PLANS AND EXISTING DIMENSIONS AND CONDITIONS ON THE JOB SITE AND SHALL IMMEDIATELY NOTIFY THE ENGINEER IN WRITING OF ANY DISCREPANCIES BEFORE PROCEEDING WITH THE WORK OR BE RESPONSIBLE FOR SAME

DRAWING INDEX

GROUND EQUIPMENT DETAILS & SPECIFICATIONS

GROUND EQUIPMENT DETAILS & SPECIFICATIONS

TOWER EQUIPMENT DETAILS & SPECIFICATIONS

PANEL SCHEDULES & ONE-LINE DIAGRAM

TYPICAL GROUNDING SCHEMATIC

SHEET DESCRIPTION



BEFORE YOU DIG!

ISSUED FOR: DATE DRWN DESCRIPTION AS CONSTRUCTION 03/18/25 DMW CONSTRUCTION 04/30/25 DMW CONSTRUCTION

Kimley » Horn

421 FAYETTEVILLE ST SHITE 600

T-MOBILE SITE NUMBER:

SL01312A

BU #: 829171

CROWN CASTLE SITE NAME:

WWEBER BAUGH

1224 S 4700 W

OGDEN, UT 84401

EXISTING 119'-0"

MONOPOLE

RALEIGH NC 2760

No. 13527908-2202 GREGORY I GREGORY J. VAMMAAREN Ion !

05/01/25

Exp. 03/31/27

IT IS A VIOLATION OF LAW FOR ANY PERSON, UNLESS THEY ARE ACTING UNDER THE DIRECTION OF A LICENSED PROFESSIONAL ENGINEER, TO ALTER THIS DOCUMENT

SHEET NUMBER:

"LOOK UP" — CROWN CASTLE USA INC. SAFETY CLIMB REQUIREMENT:
THE INTEGRITY OF THE SAFETY CLIMB AND ALL COMPONENTS OF THE CLIMBING FACILITY SHALL BE
CONSIDERED DURING ALL STAGES OF DESIGN, INSTALLATION, AND INSPECTION. TOWER MODIFICATION, MOUNT REINFORCEMENTS, AND/OR EQUIPMENT INSTALLATIONS SHALL NOT COMPROMISE THE INTEGRITY OR REINFORCEMENTS, AND/OF EQUIPMENT INSTALLATIONS SHALL NOT COMPROMISE THE INTEGRITT OF FUNCTIONAL USE OF THE SAFETY CLIMB OR ANY COMPONENTS OF THE CLIMBING FACILITY ON THE STRUCTURE. THIS SHALL INCLUDE, BUT NOT BE LIMITED TO: PINCHING OF THE WIRE ROPE, BENDING OF THE WIRE ROPE FROM ITS SUPPORTS, DIRECT CONTACT OR CLOSE PROXIMITY TO THE WIRE ROPE WHICH MAY CAUSE FRICTIONAL WEAR, IMPACT TO THE ANCHORAGE POINTS IN ANY WAY, OR TO IMPEDE/BLOCK ITS INTENDED USE. ANY COMPROMISED SAFETY CLIMB, INCLUDING EXISTING CONDITIONS MUST BE TAGGED OUT AND REPORTED TO YOUR CROWN CASTLE USA INC. POC OR CALL THE NOC TO GENERATE A SAFETY CLIMB MAINTENANCE AND CONTRACTOR NOTICE TICKET.

PRIOR TO THE START OF CONSTRUCTION, ALL REQUIRED JURISDICTIONAL PERMITS SHALL BE OBTAINED. THIS INCLUDES, BUT IS NOT LIMITED TO, BUILDING, ELECTRICAL, MECHANICAL, FIRE, FLOOD ZONE, ENVIRONMENTAL, AND ZONING. AFTER ONSITE ACTIVITIES AND CONSTRUCTION ARE COMPLETED, ALL REQUIRED PERMITS SHALL BE SATISFIED AND CLOSED OUT ACCORDING TO LOCAL JURISDICTIONAL

ALL CONSTRUCTION MEANS AND METHODS; INCLUDING BUT NOT LIMITED TO, ERECTION PLANS, RIGGING PLANS, CLIMBING PLANS, AND RESCUE PLANS SHALL BE THE RESPONSIBILITY OF THE GENERAL CONTRACTOR RESPONSIBLE FOR THE EXECUTION OF THE WORK CONTAINED HEREIN, AND SHALL MEET ANSI/ASSE A10.48 (LATEST EDITION); FEDERAL, STATE, AND LOCAL REGULATIONS; AND ANY APPLICABLE INDUSTRY CONSENSUS STANDARDS RELATED TO THE CONSTRUCTION ACTIVITIES BEING PERFORMED. ALL RIGGING PLANS SHALL ADHERE TO ANSI/ASSE A10.48 (LATEST EDITION) AND CROWN CASTLE USA INC. STANDARD CED—STD—10253, INCLUDING THE REQUIRED INVOLVEMENT OF A QUALIFIED ENGINEER FOR CLASS IV CONSTRUCTION. TO CERTIFY THE SUPPORTING STRUCTURE(S) IN ACCORDANCE WITH ANSI/TIA-322

ALL SITE WORK TO COMPLY WITH DAS-STD-10068 "INSTALLATION STANDARDS FOR CONSTRUCTION ACTIVITIES ON CROWN CASTLE USA INC. TOWER SITE," CED-STD-10294 "STANDARD FOR INSTALLATION OF MOUNTS AND APPURTENANCES," AND LATEST VERSION OF ANSI/TIA-1019-A-2012 "STANDARD FOR

INSTALLATION, ALTERATION, AND MAINTENANCE OF ANTENNA SUPPORTING STRUCTURES AND ANTENNAS."

IF THE SPECIFIED EQUIPMENT CAN NOT BE INSTALLED AS SHOWN ON THESE DRAWINGS, THE CONTRACTOR SHALL PROPOSE AN ALTERNATIVE INSTALLATION FOR APPROVAL BY CROWN CASTLE USA INC. PRIOR TO PROCEEDING WITH ANY SUCH CHANGE OF INSTALLATION.

PROCEEDING WITH ANY SUCH CHANGE OF INSTALLATION.
ALL MATERIALS FURNISHED AND INSTALLED SHALL BE IN STRICT ACCORDANCE WITH ALL APPLICABLE
CODES, REGULATIONS AND ORDINANCES. CONTRACTOR SHALL ISSUE ALL APPROPRIATE NOTICES AND
COMPLY WITH ALL LAWS, ORDINANCES, RULES, REGULATIONS AND LAWFUL ORDERS OF ANY PUBLIC
AUTHORITY REGARDING THE PERFORMANCE OF THE WORK. ALL WORK CARRIED OUT SHALL COMPLY WIT
ALL APPLICABLE MUNICIPAL AND UTILITY COMPANY SPECIFICATIONS AND LOCAL JURISDICTIONAL CODES, ORDINANCES AND APPLICABLE REGULATIONS.

THE CONTRACTOR SHALL INSTALL ALL EQUIPMENT AND MATERIALS IN ACCORDANCE WITH MANUFACTURER'S RECOMMENDATIONS UNLESS SPECIFICALLY STATED OTHERWISE.

THE CONTRACTOR SHALL CONTACT UTILITY LOCATING SERVICES PRIOR TO THE START OF CONSTRUCTION.

ALL EXISTING ACTIVE SEWER, WATER, GAS, ELECTRIC AND OTHER UTILITIES WHERE ENCOUNTERED IN THE
WORK, SHALL BE PROTECTED AT ALL TIMES AND WHERE REQUIRED FOR THE PROPER EXECUTION OF THE
WORK, SHALL BE RELOCATED AS DIRECTED BY CONTRACTOR. EXTREME CAUTION SHOULD BE USED BY THE CONTRACTOR WHEN EXCAVATING OR DRILLING PIERS AROUND OR NEAR UTILITIES. CONTRACTOR SHALL PROVIDE SAFETY TRAINING FOR THE WORKING CREW. THIS WILL INCLUDE BUT NOT BE LIMITED TO A) FALL PROTECTION B) CONFINED SPACE C) ELECTRICAL SAFETY D) TRENCHING AND EXCAVATION E) CONSTRUCTION SAFETY PROCEDURES

ALL SITE WORK SHALL BE AS INDICATED ON THE STAMPED CONSTRUCTION DRAWINGS AND PROJECT SPECIFICATIONS, LATEST APPROVED REVISION.

SPECIFICATIONS, LATEST APPROVED REVISION.

12. CONTRACTOR SHALL KEEP THE SITE FREE FROM ACCUMULATING WASTE MATERIAL, DEBRIS, AND TRASH AT THE COMPLETION OF THE WORK, IF NECESSARY, RUBBISH, STUMPS, DEBRIS, STICKS, STONES AND OTHER REFUSE SHALL BE REMOVED FROM THE SITE AND DISPOSED OF LEGALLY.

13. ALL EXISTING INACTIVE SEWER, WATER, GAS, ELECTRIC AND OTHER UTILITIES, WHICH INTERFERE WITH THE

EXECUTION OF THE WORK, SHALL BE REMOVED AND/OR CAPPED, PLUGGED OR OTHERWISE DISCONTINUED AT POINTS WHICH WILL NOT INTERFERE WITH THE EXECUTION OF THE WORK, SUBJECT TO THE APPROVAL OF CONTRACTOR, TOWER OWNER, CROWN CASTLE USA INC., AND/OR LOCAL UTILITIES.

THE CONTRACTOR SHALL PROVIDE SITE SIGNAGE IN ACCORDANCE WITH THE TECHNICAL SPECIFICATION FOR SITE SIGNAGE REQUIRED BY LOCAL JURISDICTION AND SIGNAGE REQUIRED ON INDIVIDUAL PIECES OF EQUIPMENT, ROOMS, AND SHELTERS.

THE SITE SHALL BE GRADED TO CAUSE SURFACE WATER TO FLOW AWAY FROM THE CARRIER'S EQUIPMENT

THE SUB GRADE SHALL BE COMPACTED AND BROUGHT TO A SMOOTH UNIFORM GRADE PRIOR TO FINISHED SURFACE APPLICATION.

THE AREAS OF THE OWNERS PROPERTY DISTURBED BY THE WORK AND NOT COVERED BY THE TOWER, EQUIPMENT OR DRIVEWAY, SHALL BE GRADED TO A UNIFORM SLOPE, AND STABILIZED TO PREVENT EROSION AS SPECIFIED ON THE CONSTRUCTION DRAWINGS AND/OR PROJECT SPECIFICATIONS.

CONTRACTOR SHALL MINIMIZE DISTURBANCE TO EXISTING SITE DURING CONSTRUCTION, EROSION CONTROL MEASURES, IF REQUIRED DURING CONSTRUCTION, SHALL BE IN CONFORMANCE WITH THE LOCAL GUIDELINES FOR EROSION AND SEDIMENT CONTROL.

THE CONTRACTOR SHALL MINIMIZE DISTORBANCE TO EXISTING IMPROVEMENTS, PAVEMENTS, CURBS, LANDSCAPING AND

STRUCTURES. ANY DAMAGED PART SHALL BE REPAIRED AT CONTRACTOR'S EXPENSE TO THE SATISFACTION

OF OWNER.

20. CONTRACTOR SHALL LEGALLY AND PROPERLY DISPOSE OF ALL SCRAP MATERIALS SUCH AS COAXIAL CABLES AND OTHER ITEMS REMOVED FROM THE EXISTING FACILITY. ANTENNAS REMOVED SHALL BE RETURNED TO THE OWNER'S DESIGNATED LOCATION.

CONTRACTOR SHALL LEAVE PREMISES IN CLEAN CONDITION. TRASH AND DEBRIS SHOULD BE REMOVED.

FROM SITE ON A DAILY BASIS.

22. NO FILL OR EMBANKMENT MATERIAL SHALL BE PLACED ON FROZEN GROUND. FROZEN MATERIALS, SNOW OR ICE SHALL NOT BE PLACED IN ANY FILL OR EMBANKMENT.

GENERAL NOTES:

FOR THE PURPOSE OF CONSTRUCTION DRAWING, THE FOLLOWING DEFINITIONS SHALL APPLY: CONTRACTOR: GENERAL CONTRACTOR RESPONSIBLE FOR CONSTRUCTION CARRIER: 1—MOBILE TOWER OWNER: CROWN CASTLE USA INC.

IOWEK OWNER: CROWN CASTLE USA INC.
THESE DRAWINGS HAVE BEEN PREPARED USING STANDARDS OF PROFESSIONAL CARE AND COMPLETENESS NORMALLY EXERCISED UNDER SIMILAR CIRCUMSTANCES BY REPUTABLE ENGINEERS IN THIS OR SIMILAR LOCALITIES. IT IS ASSUMED THAT THE WORK DEPICTED WILL BE PERFORMED BY AN EXPERIENCED CONTRACTOR AND/OR WORKPEOPLE WHO HAVE A WORKING KNOWLEDGE OF THE APPLICABLE CODE STANDARDS AND REQUIREMENTS AND OF INDUSTRY ACCEPTED STANDARD GOOD PRACTICE. AS NOT EVERY CONDITION OR ELEMENT IS (OR CAN BE) EXPLICITLY SHOWN ON THESE DRAWINGS, THE CONTRACTOR SHALL USE INDUSTRY ACCEPTED STANDARD GOOD PRACTICE FOR MISCELLANEOUS WORK NOT EXPLICITLY SHOWN.

MISCELLANGOUS WORK NOT EXPLICITLY SHOWN.

MISCELLANGOUS WORK NOT EXPLICITLY SHOWN.

THESE DRAWINGS REPRESENT THE FINISHED STRUCTURE. THEY DO NOT INDICATE THE MEANS OR METHODS OF CONSTRUCTION. THE CONTRACTOR SHALL BE SOLELY RESPONSIBLE FOR THE CONSTRUCTION MEANS, METHODS, TECHNIQUES, SEQUENCES, AND PROCEDURES. THE CONTRACTOR SHALL PROVIDE ALL MEASURES NECESSARY FOR PROTECTION OF LIFE AND PROPERTY DURING CONSTRUCTION. SUCH MEASURES SHALL INCLUDE, BUT NOT BE LIMITED TO, BRACING, FORMWORK, SHORING, ETC. SITE VISITS BY THE ENGINEER OR HIS REPRESENTATIVE WILL NOT INCLUDE INSPECTION OF THEESE TEMS AND IS FOR STRUCTURAL OBSERVATION OF THE FINISHED STRUCTURE ONLY. NOTES AND DETAILS IN THE CONSTRUCTION DRAWINGS SHALL TAKE PRECEDENCE OVER GENERAL NOTES AND TYPICAL DETAILS. WHERE NO DETAILS ARE SHOWN, CONSTRUCTION SHALL CONFORM TO SIMILAR WORK ON THE PROJECT, AND/OR AS PROVIDED FOR IN THE CONTRACT DOCUMENTS. WHERE DISOREPANOIES OCCUR BETWEEN PLANS, DETAILS, GENERAL NOTES, AND SPECIFICATIONS, THE GREATER, MORE STRICT REQUIREMENTS, SHALL GOVERN. IF FURTHER CLARIFICATION IS REQUIRED CONTACT THE ENGINEER OF RECORD.

SUBSTANTIAL EFFORT HAS BEEN MADE TO PROVIDE ACCURATE DIMENSIONS AND MEASUREMENTS ON THE DRAWINGS TO ASSIST UN THE FABRICATION AND REPORTED TO PROVIDE ACCURATE DIMENSIONS AND MEASUREMENTS ON THE DRAWINGS TO ASSIST UN THE FABRICATION AND OR PLACEMENT OF CONSTRUCTION FLEMENTS BILL IT IS THE FORE PROPONSIBILITY.

ASSIST IN THE FABRICATION AND/OR PLACEMENT OF CONSTRUCTION ELEMENTS BUT IT IS THE SOLE RESPONSIBILITY OF THE CONTRACTOR TO FIELD VERIFY THE DIMENSIONS, MEASUREMENTS, AND/OR CLEARANCES SHOWN IN THE CONSTRUCTION DRAWINGS PRIOR TO FABRICATION OR CUTTING OF ANY NEW OR EXISTING CONSTRUCTION ELEMENTS.

CONSTRUCTION DRAWINGS PRIOR TO FABRICATION OR CUTTING OF ANY NEW OR EXISTING CONSTRUCTION ELEMENTS. IF IT IS DETERMINED THAT THERE ARE DISCREPANCIES AND/OR CONFLICTS WITH THE CONSTRUCTION DRAWINGS THE ENGINEER OF RECORD IS TO BE NOTIFIED AS SOON AS POSSIBLE.

PRIOR TO THE SUBMISSION OF BIDS, THE BIDDING CONTRACTOR SHALL VISIT THE CELL SITE TO FAMILIARIZE WITH THE EXISTING CONDITIONS AND TO CONFIRM THAT THE WORK CAN BE ACCOMPLISHED AS SHOWN ON THE CONSTRUCTION DRAWINGS. ANY DISCREPANCY FOUND SHALL BE BROUGHT TO THE ATTENTION OF CROWN CASTLE.

ALL MATERIALS FURNISHED AND INSTALLED SHALL BE IN STRICT ACCORDANCE WITH ALL APPLICABLE CODES, REGULATIONS AND ORDINANCES. CONTRACTOR SHALL ISSUE ALL APPROPRIATE NOTICES AND COMPLY WITH ALL LAWS, ORDINANCES, RULES, REGULATIONS AND LONG AND APPLICABLE MUNICIPAL AND UTILITY COMPANY SPECIFICATIONS AND LONG AND LONG AND LONG AND APPLICABLE REGULATIONS.

UNLESS NOTED OTHERWISE, THE WORK SHALL INCLUDE FURNISHING MATERIALS, EQUIPMENT, APPURTENANCES AND THE PROMINGS.

THE CONTRACTOR SHALL INSTALLALL EQUIPMENT AND MATERIALS IN ACCORDANCE WITH MANUFACTURER'S

THE CONTRACTOR SHALL INSTALLAL EQUIPMENT AND MATERIALS IN A ACCORDANCE WITH MANUFACTURER'S RECOMMENDATIONS UNLESS SPECIFICALLY STATED OTHERWISE. IF THE SPECIFIED EQUIPMENT CAN NOT BE INSTALLED AS SHOWN ON THESE DRAWINGS, THE CONTRACTOR SHALL PROPOSE AN ALTERNATIVE INSTALLATION. FOR APPROVAL BY THE CARRIER AND CROWN CASTLE PRIOR TO PROCEEDING WITH ANY SUCH CHANGE OF INSTALLATION.

CONTRACTOR IS TO PERFORM A SITE INVESTIGATION AND IS TO DETERMINE THE BEST ROUTING OF ALL CONDUITS FOR POWER, AND TELCO AND FOR GROUNDING CABLES AS SHOWN IN THE POWER, TELCO, AND GROUNDING PLAN DRAWINGS.

THE CONTRACTOR SHALL PROTECT EXISTING IMPROVEMENTS, PAVEMENTS, CURBS, LANDSCAPING AND STRUCTURES, ANY DAMAGED PART SHALL BE REPAIRED AT CONTRACTOR'S EXPENSE TO THE SATISFACTION OF CROWN CASTLE USA INC. CONTRACTOR SHALL LEGALLY AND PROPERLY DISPOSE OF ALL SCRAP MATERIALS SUCH AS COAXIAL CABLES AND OTHER ITEMS REMOVED FROM THE EXISTING FACILITY. ANTENNAS REMOVED SHALL BE RETURNED TO THE OWNER'S

DESIGNATED LOCATION CONTRACTOR SHALL LEAVE PREMISES IN CLEAN CONDITION. TRASH AND DEBRIS SHOULD BE REMOVED FROM SITE ON

CONCRETE, FOUNDATIONS, AND REINFORCING STEEL:

ALL CONCRETE WORK SHALL BE IN ACCORDANCE WITH THE ACI 301, ACI 318, ACI 336, ASTM A184, ASTM A185 AND THE DESIGN AND CONSTRUCTION SPECIFICATION FOR CAST—IN—PLACE CONCRETE.

UNLESS NOTED OTHERWISE, SOIL BEARING PRESSURE USED FOR DESIGN OF SLABS AND FOUNDATIONS IS ASSUMED

ALL CONCRETE SHALL HAVE A MINIMUM COMPRESSIVE STRENGTH (f'c) OF 3000 psi AT 28 DAYS, UNLESS NOTED OTHERWISE. NO MORE THAN 90 MINUTES SHALL ELAPSE FROM BATCH TIME TO TIME OF PLACEMENT UNLESS APPROVED BY THE ENGINEER OF RECORD, TEMPERATURE OF CONCRETE SHALL NOT EXCEED 90'F AT TIME OF PLACEMENT. CONCRETE EXPOSED TO FREEZE—THAW CYCLES SHALL CONTAIN AIR ENTRAINING ADMIXTURES. AMOUNT OF AIR

ENTRAINMENT TO BE BASED ON SIZE OF AGGREGATE AND F3 CLASS EXPOSURE (VERY SEVERE). CEMENT USED TO BE TYPE II PORTLAND CEMENT WITH A MAXIMUM WATER-TO-CEMENT RATIO (W/C) OF 0.45.

ALL STEEL REINFORCING SHALL CONFORM TO ASTM A615. ALL WELDED WIRE FABRIC (WWF) SHALL CONFORM TO ASTM A185. ALL SPLICES SHALL BE CLASS "B" TENSION SPLICES, UNLESS NOTED OTHERWISE. ALL HOOKS SHALL BE STANDARD 90 DEGREE HOOKS, UNLESS NOTED OTHERWISE. YIELD STRENGTH (Fy) OF STANDARD DEFORMED BARS ARE AS FOLLOWS:

CONCRETE CAST AGAINST AND PERMANENTLY EXPOSED TO EARTH...

CONCRETE EXPOSED TO EARTH OR WEATHER:

#6 BARS AND LARGER...... #5 BARS AND SMALLER. ..1-1/2" CONCRETE NOT EXPOSED TO EARTH OR WEATHER:

BEAMS AND COLUMNS. A TOOLED EDGE OR A 3/4" CHAMFER SHALL BE PROVIDED AT ALL EXPOSED EDGES OF CONCRETE, UNLESS NOTED OTHERWISE, IN ACCORDANCE WITH ACI 301 SECTION 4.2.4.

GREENFIELD GROUNDING NOTES:

ALL GROUND ELECTRODE SYSTEMS (INCLUDING TELECOMMUNICATION, RADIO, LIGHTNING PROTECTION AND AC POWER GES'S) SHALL BE BONDED TOGETHER AT OR BELOW GRADE, BY TWO OR MORE COPPER BONDING CONDUCTORS IN ACCORDANCE WITH THE NEC.

ACCURDANCE WITH THE NEC.

THE CONTRACTOR SHALL PERFORM IEEE FALL—OF—POTENTAL RESISTANCE TO EARTH TESTING (PER IEEE 1100 AND 81) FOR GROUND ELECTRODE SYSTEMS, THE CONTRACTOR SHALL FURNISH AND INSTALL SUPPLEMENTAL GROUND ELECTRODES AS NEEDED TO ACHIEVE A TEST RESULT OF 5 OHMS OR LESS.

THE CONTRACTOR IS RESPONSIBLE FOR PROPERLY SEQUENCING GROUNDING AND UNDERGROUND CONDUIT INSTALLATION AS TO PREVENT ANY LOSS OF CONTINUITY IN THE GROUNDING SYSTEM OR DAMAGE TO THE CONDUIT AND PROVIDE

#4 RARS AND SMALLER

METAL CONDUIT AND TRAY SHALL BE GROUNDED AND MADE ELECTRICALLY CONTINUOUS WITH LISTED BONDING FITTINGS OR BY BONDING ACROSS THE DISCONTINUITY WITH #6 COPPER WIRE UL APPROVED GROUNDING TYPE CONDUIT

WETAL RACEWAY SHALL NOT BE USED AS THE NEC REQUIRED EQUIPMENT GROUND CONDUCTOR. STRANDED COPPER CONDUCTORS WITH GREEN INSULATION, SIZED IN ACCORDANCE WITH THE NEC, SHALL BE FURNISHED AND INSTALLED WITH THE POWER CIRCUITS TO BTS EQUIPMENT.

EACH CABINET FRAME SHALL BE DIRECTLY CONNECTED TO THE MASTER GROUND BAR WITH GREEN INSULATED SUPPLEMENTAL EQUIPMENT GROUND WIRES, #6 STRANDED COPPER OR LARGER FOR INDOOR BTS; #2 BARE SOLID TINNED COPPER FOR OUTDOOR BTS. CONNECTIONS TO THE GROUND BUS SHALL NOT BE DOUBLED UP OR STACKED BACK TO BACK CONNECTIONS ON OPPOSITE SIDE OF THE GROUND BUS ARE PERMITTED

ALL EXTERIOR GROUND CONDUCTORS BETWEEN EQUIPMENT/GROUND BASS AND THE GROUND RING SHALL BE #2 SOLID TINNED COPPER UNLESS OTHERWISE INDICATED.

ALL EXTERIOR GROUND CONDUCTORS BETWEEN EQUIPMENT/GROUND BASS AND THE GROUND RING SHALL BE #2 SOLID TINNED COPPER UNLESS OTHERWISE INDICATED.

ALUMINUM CONDUCTOR OR COPPER CLAD STEEL CONDUCTOR SHALL NOT BE USED FOR GROUNDING CONNECTIONS.

USE OF 90° BENDS IN THE PROTECTION GROUNDING CONDUCTORS SHALL BE AVOIDED WHEN 45° BENDS CAN BE ADEQUATELY SUPPORTED.

EXCITERMIC WELDS SHALL BE USED FOR ALL GROUNDING CONNECTIONS BELOW GRADE.

ALL GROUND CONNECTIONS ABOVE GRADE (INTERIOR AND EXTERIOR) SHALL BE FORMED USING HIGH PRESS CRIMPS.

COMPRESSION GROUND CONNECTIONS MAY BE REPLACED BY EXOTHERMIC WELD CONNECTIONS.

ICE BRIDGE BONDING CONDUCTORS SHALL BE EXOTHERMICALLY BONDED OR BOLTED TO THE BRIDGE AND THE TOWER GROUND BAR.

APPROVED ANTIOXIDANT COATINGS (i.e. CONDUCTIVE GEL OR PASTE) SHALL BE USED ON ALL COMPRESSION AND BOLTED GROUND CONNECTIONS. ALL EXTERIOR GROUND CONNECTIONS SHALL BE COATED WITH A CORROSION RESISTANT MATERIAL.

ALL EXTENSOR REQUOND CONNECTIONS SHALL BE COALED WITH A CORPOSION RESISTANT MATERIAL.

MISCELLANEOUS ELECTRICAL AND NON-ELECTRICAL METAL BOXES, FRAMES AND SUPPORTS SHALL BE BONDED TO THE GROUND RING, IN ACCORDANCE WITH THE NEC.

BOND ALL METALLIC OBJECTS WITHIN 6 ft OF MAIN GROUND RING WITH (1) #2 BARE SOLID TINNED COPPER GROUND CONDUCTOR.

GROUND CONDUCTORS USED FOR THE FACILITY GROUNDING AND LIGHTNING PROTECTION SYSTEMS SHALL NOT BE ROUTED THROUGH METALLIC OBJECTS THAT FORM A RING AROUND THE CONDUCTOR, SUCH AS METALLIC CONDUITS, METAL SUPPORT CLIPS OR SLEEVES THROUGH WALLS OR FLOORS. WHEN IT IS REQUIRED TO BE HOUSED IN CONDUIT TO MEET CODE REQUIREMENTS OR LOCAL CONDITIONS, NON-METALLIC MATERIAL SUCH AS PYC CONDUIT SHALL BE

USED. WHERE USE OF METAL CONDUIT IS UNAVOIDABLE (i.e., NONMETALLIC CONDUIT PROHIBITED BY LOCAL CODE) THE GROUND CONDUCTOR SHALL BE BONDED TO EACH END OF THE METAL CONDUIT.

ALL GROUNDS THAT TRANSITION FROM BELOW GRADE TO ABOVE GRADE MUST BE #2 BARE SOLID TINNED COPPER IN 3/4" NON-METALLIC, FLEXIBLE CONDUIT FROM 24" BELOW GRADE TO WITHIN 3" TO 6" OF CAD-WELD TERMINATION

POINT. THE EXPOSED END OF THE CONDUIT MUST BE SEALED WITH SILICONE CAULK. (ADD TRANSITIONING GROUND STANDARD DETAIL AS WELL).
BUILDINGS WHERE THE MAIN GROUNDING CONDUCTORS ARE REQUIRED TO BE ROUTED TO GRADE, THE CONTRACTOR SHALL ROUTE TWO GROUNDING CONDUCTORS FROM THE ROOFTOP, TOWERS, AND WATER TOWERS GROUNDING RING, TO
THE EXISTING GROUNDING SYSTEM, THE GROUNDING CONDUCTORS SHALL NOT BE SMALLER THAN 2/O COPPER ROOFTOP GROUNDING RING SHALL BE BONDED TO THE EXISTING GROUNDING SYSTEM, THE BUILDING STEEL COLUMNS, LIGHTNING PROTECTION SYSTEM, AND BUILDING MAIN WATER LINE (FERROUS OR NONFERROUS METAL PIPING ONLY).

ELECTRICAL INSTALLATION NOTES:

ALL ELECTRICAL WORK SHALL BE PERFORMED IN ACCORDANCE WITH THE PROJECT SPECIFICATIONS, NEC AND ALL APPLICABLE

FEDERAL, STATE, AND LOCAL CODES/ORDINANCES.
CONDUIT ROUTINGS ARE SCHEMATIC. CONTRACTOR SHALL INSTALL CONDUITS SO THAT ACCESS TO EQUIPMENT IS NOT BLOCKED. AND TRIP HAZARDS ARE FLIMINATED

WIRING RACEWAY AND SUPPORT METHODS AND MATERIALS SHALL COMPLY WITH THE REQUIREMENTS OF THE NEC.

WIRING, RACEWAY AND SUPPORT METHODS AND MATERIALS SHALL COMPLY WITH THE REQUIREMENTS OF THE NEC.

ALL CIRCUITS SHALL BE SEGREGATED AND MAINTAIN MINIMUM CABLE SEPARATION AS REQUIRED BY THE NEC.

ALL EQUIPMENT SHALL BEAR THE UNDERWRITERS LABORATORIES LABEL OF APPROVAL, AND SHALL CONFORM TO REQUIREMENT OF THE NATIONAL ELECTRICAL CODE.

ALL OVERCURRENT DEVICES SHALL HAVE AN INTERRUPTING CURRENT RATING THAT SHALL BE GREATER THAN THE SHORT CIRCUIT CURRENT TO WHICH THEY ARE SUBJECTED, 22,000 AIC MINIMUM. VERYIFY AVAILABLE SHORT CIRCUIT CURRENT DOES NOT EXCEED THE RATING OF ELECTRICAL EQUIPMENT IN ACCORDANCE WITH ARTICLE 110.24 NEC OR THE MOST CURRENT

ADOPTED CODE PRE THE GOVERNING JURISDICTION.
EACH END OF EVERY POWER PHASE CONDUCTOR, GROUNDING CONDUCTOR, AND TELCO CONDUCTOR OR CABLE SHALL BE EACH END OF EVERY POWER PHASE CONDUCTOR, GROUNDING CONDUCTOR, AND TELCO CONDUCTOR OR CABLE SHALL BE LABELED WITH COLOR—CODED INSULATION OR ELECTRICAL TAPE WITH UV PROTECTION, OR EQUAL). THE IDENTIFICATION METHOD SHALL CONFORM WITH NEC AND OSHA. ALL ELECTRICAL COMPONENTS SHALL BE CLEARLY LABELED WITH LAMICOID TAGS SHOWING THEIR RATED VOLTAGE, PHASE

CIRCUIT ID'S).

PANEL BOARDS (ID NUMBERS) SHALL BE CLEARLY LABELED WITH PLASTIC LABELS.
ALL TIE WRAPS SHALL BE CUT FLUSH WITH APPROVED CUTTING TOOL TO REMOVE SHARP EDGES.
ALL POWER AND EQUIPMENT GROUND WIRING IN TUBING OR CONDUIT SHALL BE SINGLE COPPER CONDUCTOR (#14 OR LARGER)
WITH TYPE THHW, THWN, THWN, Z, XHHW, XHHW-Z, THW, THW-Z, RHW, OR RHW-2 INSULATION UNLESS OTHERWISE SPECIFIED.

SUPPLEMENTAL EQUIPMENT GROUND WIRING LOCATED INDOORS SHALL BE SINGLE COPPER CONDUCTOR (#6 OR LARGER) WITH TYPE THHW, THWN, THWN-2, XHHW, XHHW-2, THW, THW-2, RHW, OR RHW-2 INSULATION UNLESS OTHERWISE SPECIFIED. POWER AND CONTROL WIRING IN FLEXIBLE CORD SHALL BE MULTI-CONDUCTOR, TYPE SOOW CORD (#14 OR LARGER) UNLESS

OTHERWISE SPECIFIED.

POWER AND CONTROL WIRING FOR USE IN CABLE TRAY SHALL BE MULTI-CONDUCTOR, TYPE TC CABLE (#14 OR LARGER), WITH TYPE THHW, THWN, THWN-2, XHHW, XHHW-2, THW, THW-2, RHW, OR RHW-2 INSULATION UNLESS OTHERWISE SPECIFIED. ALL POWER AND GROUNDING CONNECTIONS SHALL BE CRIMP-STYLE, COMPRESSION WIRE LUGS AND WIRE NUTS BY THOMAS ANI BETTS (OR EQUAL). LUGS AND WIRE NUTS SHALL BE RATED FOR OPERATION NOT LESS THAN 75' C (90' C IF AVAILABLE). RACEWAY AND CABLE TRAY SHALL BE LISTED OR LABELED FOR ELECTRICAL USE IN ACCORDANCE WITH NEMA, UL, ANSI/IEEE

15. ELECTRICAL METALLIC TUBING (EMT), INTERMEDIATE METAL CONDUIT (IMC), OR RIGID METAL CONDUIT (RMC) SHALL BE USED FOR EXPOSED INDOOR LOCATIONS

ELECTRICAL METALLIC TUBING (EMT) OR METAL-CLAD CABLE (MC) SHALL BE USED FOR CONCEALED INDOOR LOCATIONS.

UNDERGROUND CONDUIT SHALL BE SCHEDULE 40 PVC ON STRAIGHTS AND SCHEDULE 80 PVC UNDER ALL TRAFFIC EASEME
AND ALL ELBOWS/90s. ABOVE GRADE CONDUIT TO BE SCH 80 PVC OR IMC/RMC CONDUIT. EMT IS ALLOWED AT STUB UP LOCATIONS AND INDOORS ONLY.

LIQUID—TIGHT FLEXIBLE METALLIC CONDUIT (LIQUID—TITE FLEX) SHALL BE USED INDOORS AND OUTDOORS, WHERE VIBRATION OCCURS OR FLEXIBILITY IS NEEDED.
CONDUIT AND TUBING FITTINGS SHALL BE THREADED OR COMPRESSION—TYPE AND APPROVED FOR THE LOCATION USED. SET SCREW FITTINGS ARE NOT ACCEPTABLE.

20. CABINETS, BOXES AND WIRE WAYS SHALL BE LABELED FOR ELECTRICAL USE IN ACCORDANCE WITH NEMA, UL, ANSI/IEEE AND

WIREWAYS SHALL BE METAL WITH AN ENAMEL FINISH AND INCLUDE A HINGED COVER, DESIGNED TO SWING OPEN DOWNWARDS

(WIREMOLD SPECMATE WIREWAY).

22. SLOTTED WIRING DUCT SHALL BE PVC AND INCLUDE COVER (PANDUIT TYPE E OR EQUAL).

SLOTTED WIRING DUCT SHALL BE PVC AND INCLUDE COVER (PANDUIT TYPE E OR EQUAL).

CONDUITS SHALL BE FASTENED SECURELY IN PLACE WITH APPROVED NON-PERFORATED STRAPS AND HANGERS. EXPLOSIVE

DEVICES (i.e. POWDER-ACTUATED) FOR ATTACHING HANGERS TO STRUCTURE WILL NOT BE PERMITTED. CLOSELY FOLLOW THE

LINES OF THE STRUCTURE, MAINTAIN CLOSE PROXIMITY TO THE STRUCTURE AND KEEP CONDUITS IN TIGHT ENVELOPES. CHANGES
IN DIRECTION TO ROUTE AROUND OBSTACLES SHALL BE MADE WITH CONDUIT OUTLET BODIES. CONDUIT SHALL BE INSTALLED IN

A NEAT AND WORKMANLIKE MANNER. PARALLEL AND PERPENDICULAR TO STRUCTURE WALL AND CEILING LINES. ALL CONDUIT A NEAT AND WORKMANLIKE MANNER. PARALLEL AND PERPENDICULAR TO STRUCTURE WALL AND CEILING LINES. ALL CONDUIT SHALL BE FISHED TO CLEAR OBSTRUCTIONS. ENDS OF CONDUITS SHALL BE TEMPORARILY CAPPED FLUSH TO FINISH GRADE TO PREVENT CONCRETE, PLASTER OR DIRT FROM ENTERING. CONDUITS SHALL BE RIGIDLY CLAMPED TO BOXES BY GALVANIZED MALLEABLE IRON LOCKNUT ON OUTSIDE AND INSIDE. EQUIPMENT CABINETS, TERMINAL BOXES, JUNCTION BOXES AND PULL BOXES SHALL BE GALVANIZED OR EPOXY—COATED SHEET STEEL. SHALL MEET OR EXCEED UL 50 AND BE RATED NEMA 1 (OR BETTER) FOR INTERIOR LOCATIONS AND NEMA 3R (OR

BETTER) FOR EXTERIOR LOCATIONS.

METAL RECEPTACLE, SWITCH AND DEVICE BOXES SHALL BE GALVANIZED, EPOXY—COATED OR NON—CORRODING; SHALL MEET OR EXCEED UL 514A AND NEMA OS 1 AND BE RATED NEMA 1 (OR BETTER) FOR INTERIOR LOCATIONS AND WEATHER PROTECTED (WP OR BETTER) FOR EXTERIOR LOCATIONS

NONMETALLIC RECEPTACLE, SWITCH AND DEVICE BOXES SHALL MEET OR EXCEED NEMA OS 2 (NEWEST REVISION) AND BE RATED NEMA 1 (OR BETTER) FOR INTERIOR LOCATIONS AND WEATHER PROTECTED (WP OR BETTER) FOR EXTERIOR LOCATIONS.

THE CONTRACTOR SHALL NOTIFY AND OBTAIN NECESSARY AUTHORIZATION FROM THE CARRIER AND/OR CROWN CASTLE USA INC.
BEFORE COMMENCING WORK ON THE AC POWER DISTRIBUTION PANELS.
THE CONTRACTOR SHALL PROVIDE NECESSARY TAGGING ON THE BREAKERS, CABLES AND DISTRIBUTION PANELS IN ACCORDANCE
WITH THE APPLICABLE CODES AND STANDARDS TO SAFEGUARD LIFE AND PROPERTY.

APWA UNIFORM COLOR CODE:

TEMPORARY SURVEY MARKINGS

ELECTRIC POWER LINES, CABLES, CONDUIT, AND LIGHTING CABLES

COMMUNICATION, ALARM OR SIGNAL LINES, CABLES, OR CONDUIT AND TRAFFIC LOOPS

RECLAIMED WATER, IRRIGATION, AND

YELLOW GAS, OIL, STEAM, PETROLEUM, OR GASEOUS MATERIALS

SEWERS AND DRAIN LINES

POTABLE WATER

SLURRY LINES

WHITE PROPOSED EXCAVATION

29. INSTALL LAMICOID LABEL ON THE METER CENTER TO SHOW "T-MOBILE". ALL EMPTY/SPARE CONDUITS THAT ARE INSTALLED ARE TO HAVE A METERED MULE TAPE PULL CORD INSTALLED.

CONDUCTOR COLOR CODE							
SYSTEM	CONDUCTOR	COLOR					
	A PHASE	BLACK					
120/240V, 1Ø	B PHASE	RED					
120/2400, 10	NEUTRAL	WHITE					
	GROUND	GREEN					
	A PHASE	BLACK					
	B PHASE	RED					
120/208V, 3Ø	C PHASE	BLUE					
	NEUTRAL	WHITE					
	GROUND	GREEN					
	A PHASE	BROWN					
	B PHASE	ORANGE OR PURPLE					
277/480V, 3Ø	C PHASE	YELLOW					
	NEUTRAL	GREY					
	GROUND	GREEN					
DC VOLTAGE	POS (+)	RED**					
DC VOLIAGE	NEG (-)	BLACK**					

* SEE NEC 210.5(C)(1) AND (2)
** POLARITY MARKED AT TERMINATION

ABBREVIATIONS:

EXISTING FACILITY INTERFACE FRAME GENERATOR GLOBAL POSITIONING SYSTEM GLOBAL SYSTEM FOR MOBILE LONG TERM EVOLUTION MASTER GROUND BAR MICROWAVE (N) NEC NATIONAL ELECTRIC CODE PROPOSED POWER PLANT RECTIFIER RADIO BASE STATION RADIO BASE STATION
REMOTE ELECTRIC TILT
RADIO FREQUENCY DATA SHEET
REMOTE RADIO HEAD
REMOTE RADIO UNIT
SMART INTEGRATED DEVICE
TOWER MOUNTED AMPLIFIER
TYPICAL RFDS RRH RRU SIAD TMA TYP

UNIVERSAL MOBILE TELECOMMUNICATIONS SYSTEM





421 FAYETTEVILLE ST SHITE 600 RALEIGH NC 27601

T-MOBILE SITE NUMBER: SL01312A

BU #: 829171 CROWN CASTLE SITE NAME: WWEBER BAUGH

> 1224 S 4700 W OGDEN, UT 84401

EXISTING 119'-0" MONOPOLE

ĺ		ISSUI	ED FOR:	
REV	DATE	DRWN	DESCRIPTION	DES./Q
0	02/17/25	AS	CONSTRUCTION	MCK
1	03/18/25	DMW	CONSTRUCTION	MCK
2	04/30/25	DMW	CONSTRUCTION	MTH
-				



05/01/25

Exp. 03/31/27

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SHEET NUMBER:

TO BE RELOCATED/REMOVE

CROWN CASTLE



421 FAYETTEVILLE ST, SUITE 600 RALEIGH, NC 27601


T-MOBILE SITE NUMBER: SL01312A

BU #: **829171** CROWN CASTLE SITE NAME: WWEBER_BAUGH

> 1224 S 4700 W OGDEN, UT 84401

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Exp. 03/31/27


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REVISION:

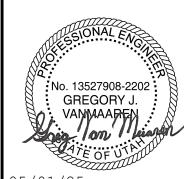COMPOUND PLAN SCALE: 2' 1' 0 2' 3/16"=1'-0" (FULL SIZE)





CROWN CASTLE

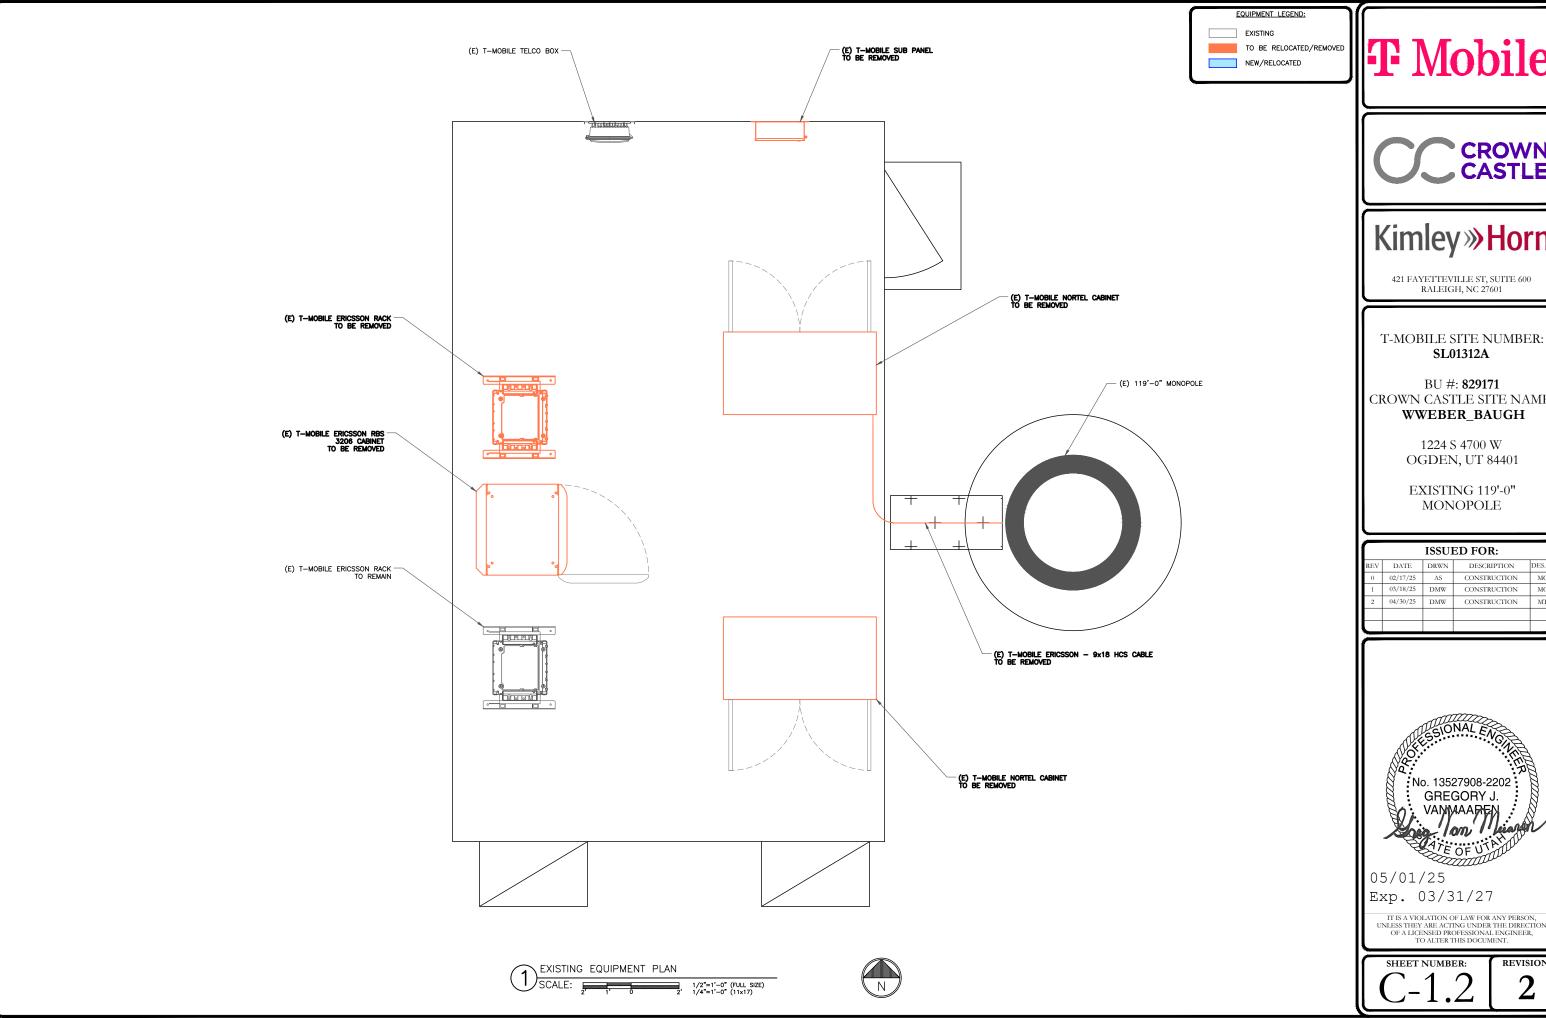

CROWN CASTLE SITE NAME: WWEBER_BAUGH


OGDEN, UT 84401

MONOPOLE

	ISSUED FOR:											
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EXISTING TO BE RELOCATED/REMOVED

EQUIPMENT LEGEND:

T Mobile

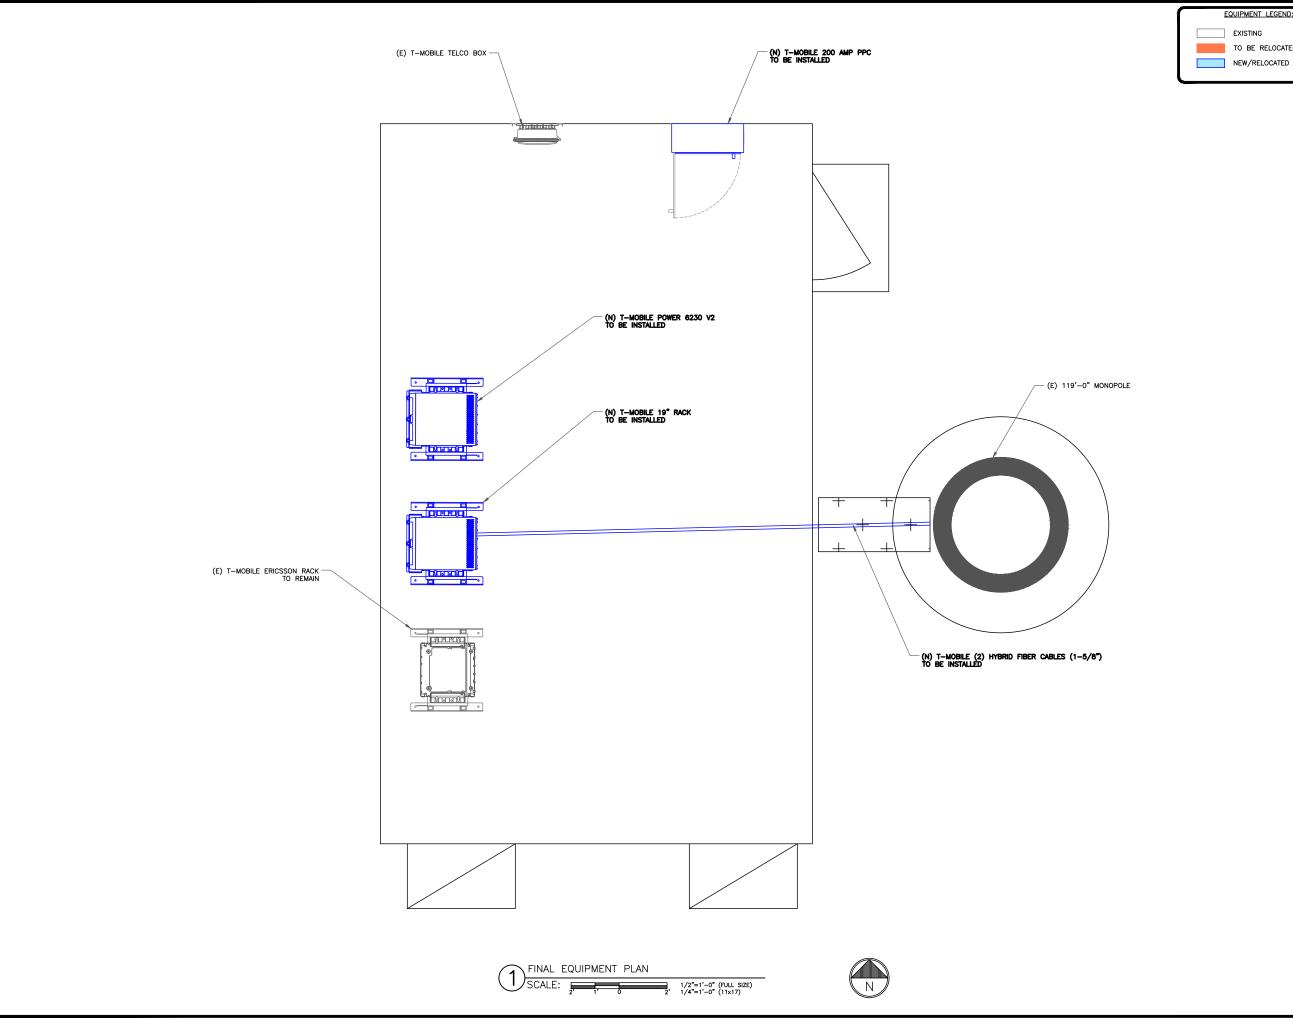CROWN CASTLE



421 FAYETTEVILLE ST, SUITE 600 RALEIGH, NC 27601

T-MOBILE SITE NUMBER: SL01312A

BU #: **829171** CROWN CASTLE SITE NAME: WWEBER_BAUGH

> 1224 S 4700 W OGDEN, UT 84401

EXISTING 119'-0" MONOPOLE


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CROWN CASTLE

Kimley»Horn

421 FAYETTEVILLE ST, SUITE 600 RALEIGH, NC 27601

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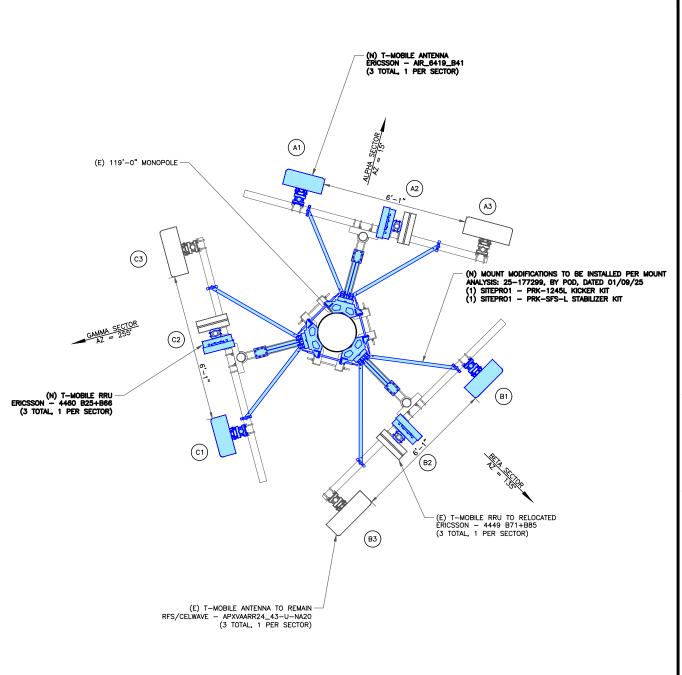
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(E) T-MOBILE RRU TO BE RELOCATED -ERICSSON - 4449 B71+B85 (3 TOTAL, 1 PER SECTOR)

(E) T-MOBILE ANTENNA TO REMAIN -RFS/CELWAVE - APXVAARR24_43-U-NA20 (3 TOTAL, 1 PER SECTOR)

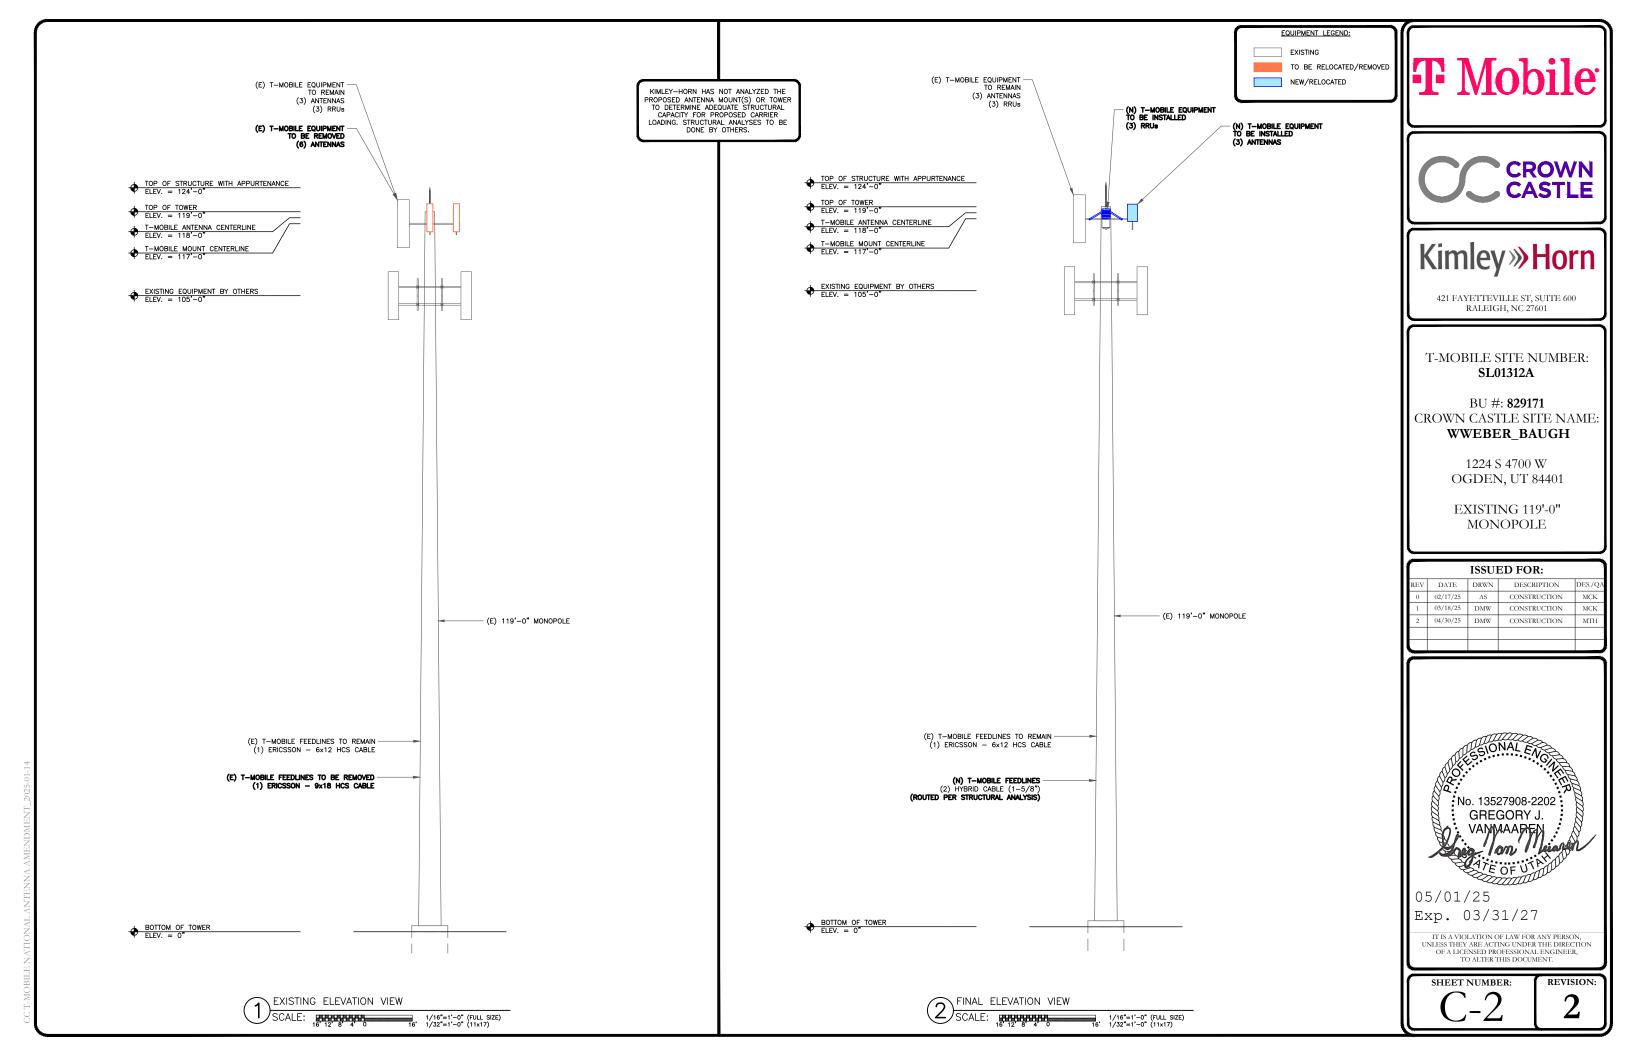(E) T-MOBILE ANTENNA TO BE REMOVED -ERICSSON - AIR21_KRC118023/1_B2A_B4P (3 TOTAL, 1 PER SECTOR)

(E) 119'-0" MONOPOLE -

(C3)



(E) T-MOBILE ANTENNA TO BE REMOVED ERICSSON - AIR21_KRC118046/1_B2P_B4A (3 TOTAL, 1 PER SECTOR)

FINAL ANTENNA PLAN @ 118'-0"

DOCUTION		ANTENNA				RADIO			DIPLEXE	ER		ТМА		SURGE PROTECTION		CABLES		
POSITION	TECH	STATUS/MANUFACTURER MODEL	AZIMUTH	RAD CENTER	QTY.	STATUS/MODEL	LOCATION	QTY.	STATUS	LOCATION	QTY.	STATUS	QTY.	STATUS/MODEL	QTY.	STATUS/TYPE	SIZE	LENGTH
A1	N2500	(N) ERICSSON - AIR_6419_B41	15*	118'-0"	-	-	-	-	-	-	_	-	-	-	-	SHARED	-	-
A2			15°	1101 08	1	(E) ERICSSON - 4449 B71+B85	TOWER	_					_			SHARED	_	_
AZ	-	-	15	118'-0"	1	(N) ERICSSON - 4460 B25+B66	TOWER			_	1	_	_	_	SHARED	_	_	
A3	G1900 L600 L700 L1900 L2100 LAWS3 N600 N1900	(E) REF/CELWAVE — APXVAARR24_43—U—NA20	15*	118'-0"	ı	-	ı	-	ı	1	_	ı	-	-	1 1	(E) ERICSSON - 6x12 (N) 6/24 HYBRID	1-3/8" 1-5/8"	170'-0" 170'-0"
B1	N2500	(N) ERICSSON — AIR_6419_B41	135 °	118'-0"	-	-	-	-	1	-	_	-	-	-	-	SHARED	-	-
B2	_	_	135*	118'-0"	1	(E) ERICSSON - 4449 B71+B85	TOWER	_		_	-	-	_	_	_	SHARED	_	_
B2		-	133	118 -0	1	(N) ERICSSON - 4460 B25+B66	TOWER			_				_	SHARED	_	_	
В3	G1900 L600 L700 L1900 L2100 LAWS3 N600 N1900	(E) REF/CELWAVE — APXVAARR24_43—U—NA20	135*	118'-0"	-	-	-	_	1	-	_	-	_	-	-	SHARED	_	-
			-															
C1	N2500	(N) ERICSSON - AIR_6419_B41	255*	118'-0"	-	-	-	_	1	-	_	-	_	-	-	SHARED	_	-
C2	_	_	255 °	118'-0"	1	(E) ERICSSON – 4449 B71+B85	TOWER	_	_	_	_	_		_	_	SHARED	_	_
			233	110-0	1	(N) ERICSSON - 4460 B25+B66	TOWER		- -			_	_	_		SHARED		_
C3	G1900 L600 L700 L1900 L2100 LAWS3 N600 N1900	(E) REF/CELWAVE — APXVAARR24_43—U—NA20	255*	118'-0"	-	-	-	_	-	-	_	-	_	-	_	SHARED	_	-





421 FAYETTEVILLE ST, SUITE 600 RALEIGH, NC 27601

T-MOBILE SITE NUMBER: **SL01312A**

BU #: **829171** Crown Castle Site Name: **wweber_baugh**

> 1224 S 4700 W OGDEN, UT 84401

EXISTING 119'-0" MONOPOLE

				_							
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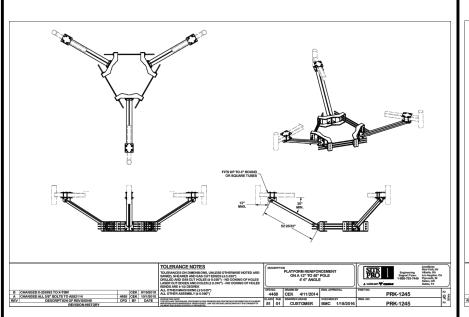



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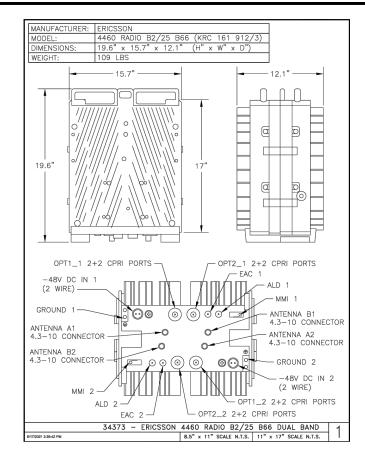
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SITEPRO1 - PRK-SFS-L SCALE: NOT TO SCALE



ERICSSON - 4460 B25+B66 RRU SCALE: NOT TO SCALE

SITEPRO1 - PRK-1245L KICKER KIT SCALE: NOT TO SCALE

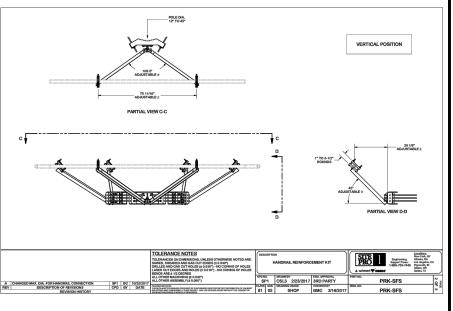


Figure 2 AIR Dimensions

AIR Unit Type	Height (H) × Width (W) × Depth (D)
AIR 6419 B40	929 × 506 × 208 mm ⁽¹⁾
AIR 6419 B41	871 × 506 × 203 mm ⁽³⁾
AIR 6419 B42	796 × 408 × 186 mm ⁽²⁾

	ions without protrusions: 717 × 468 × 149 n		
AIR 6419 B41	Vertical Beamwidth	30±3°	30±3°
	Horizontal Beamwidth	28±2"	20±2°
	Digital Downtilt	Fixed 6°	Fixed 6"
	Vertical Beam Pointing Error	≤ 1°	≤ 1°
	Horizontal Beam Pointing Direction	0±1°	0±1'
	EIRP (Typical)	2 × 68 dBm	1 × 71.5 dBm
	Vertical Side Labe Suppression	12 dB	12 dB
	Front to Back Ratio		8
	Beam Parallelity	≤-10 dB	n/a

	AIR Uni	AIR Unit Type L		Mount	ing Kit Weight	t		
				SXK 1	99 2015/1	SXK 1	09 2016/1	
	AIR 6419 B41 29		29.5 kg	4.4 kg		5.2 kg		
			29.5 kg	4.4 kg		5.2 kg		
			20.0 kg	4.4 kg		5.2 kg		
	(1) The we	ight is given	with ±5% accuracy.	-				
	Unit (DC Powered)		Output Power	Maximum Load Current at -36 V DC		t Maximum Allowed Fuse Rating(1)		
	AIR 6419	B49	320 W		49 A		59 A	
	AIR 6419	B41	320 W	48 A		58 A		
	AIR 6419	B42	320 W	48 A		58 A		
64	19 B41	Vertice	al Beamwidth		30±3°		30±3°	
		Horizo	ntal Beamwidth		65±5°	65±5°		
		Digital	Downtilt		Fixed 6°		Fixed 6"	
		Vertico	ol Beam Pointing Error		≤ 3°		s 3°	
		Horizo	ntol Beam Pointing Direc	tion	e±5°		0±5°	

AIR6419 B41 ANTENNA
SCALE: NOT TO SCALE

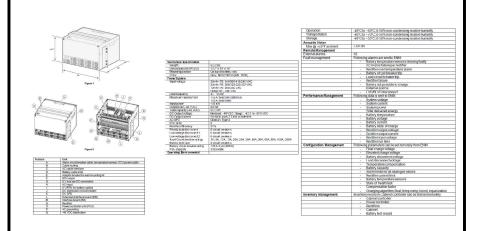

POWER 6230 V2 RACK SPECS
SCALE: NOT TO SCALE

6 DETAIL NOT USED SCALE: NOT TO SCALE

T Mobile

CROWN

Kimley » Horn

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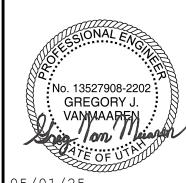
T-MOBILE SITE NUMBER: **SL01312A**

BU #: **829171** Crown Castle Site Name: **Wweber_baugh**

> 1224 S 4700 W OGDEN, UT 84401

EXISTING 119'-0" MONOPOLE


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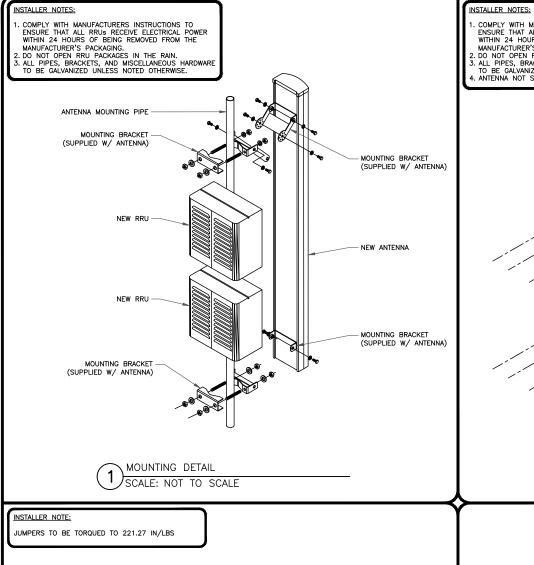



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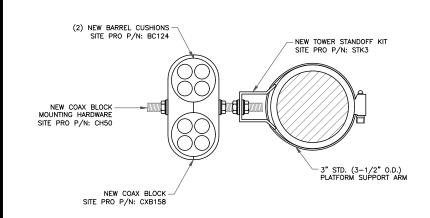
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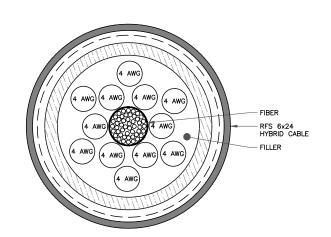






RF JUMPER DETAIL
SCALE: NOT TO SCALE

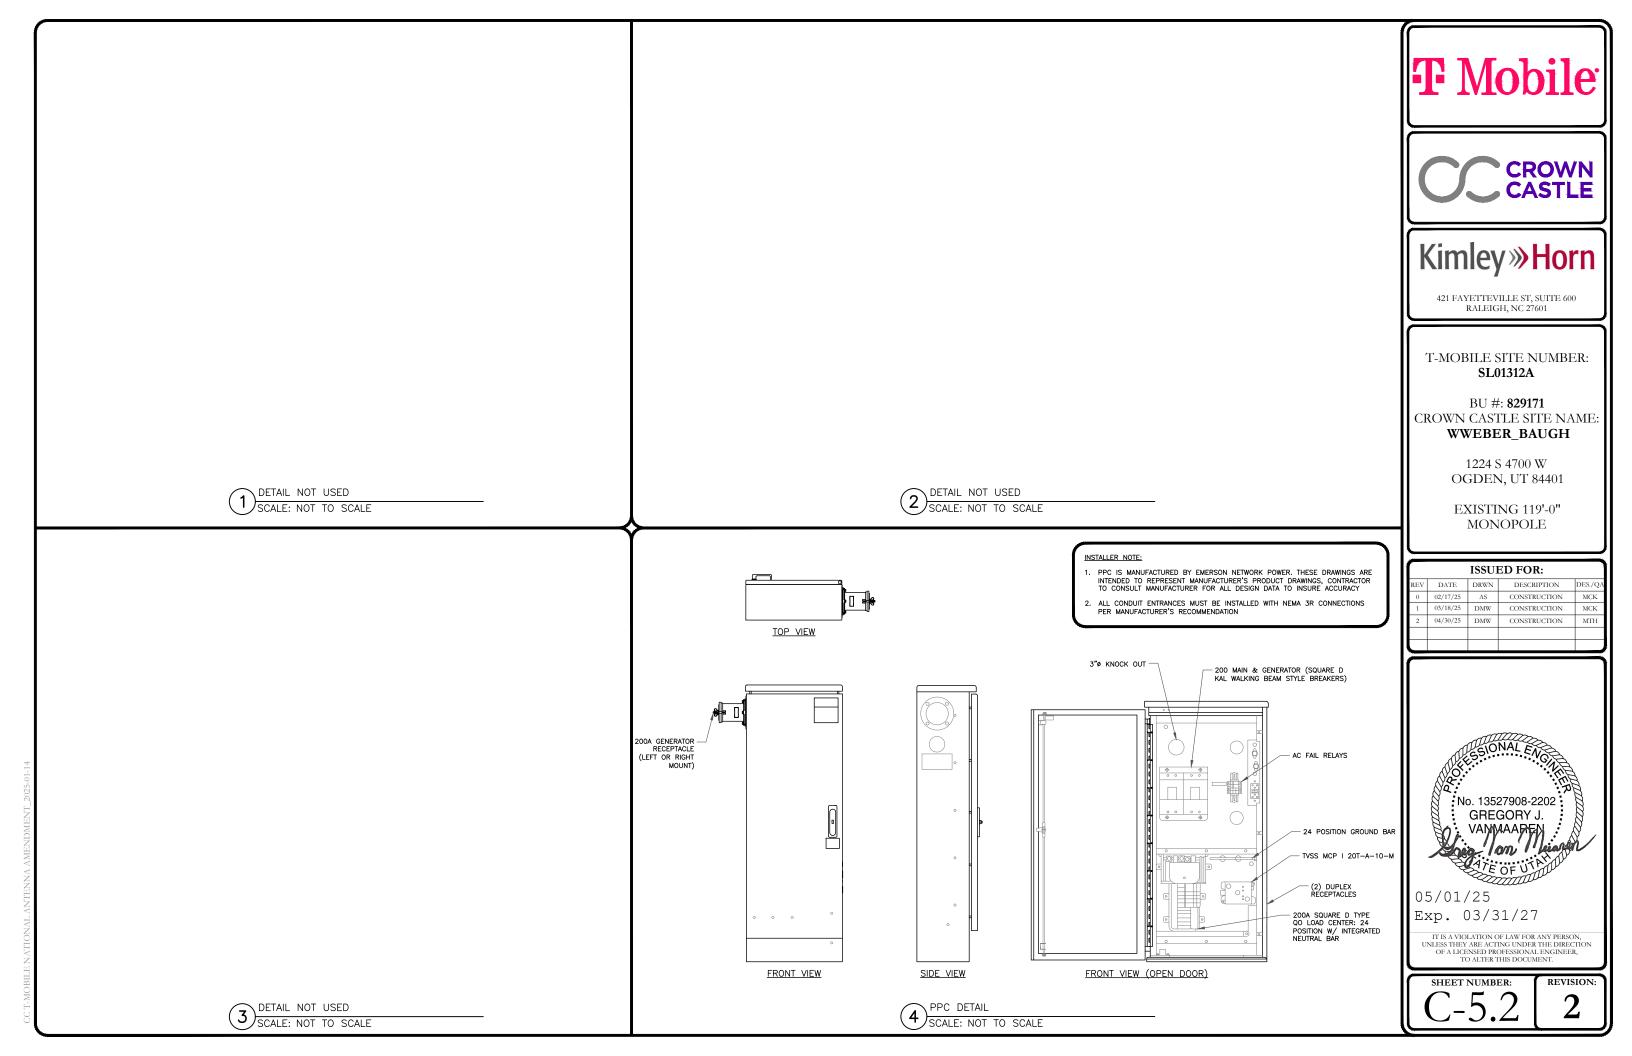PARAMETER	VALUE
NOMINAL DIAMETER (INCHES)	1.79
CROSS SECTION AREA (SQUARE INCHES)	3.13
JACKET COLOR	BLACK
WEIGHT PER LINEAR FOOT (POUNDS)	2.5

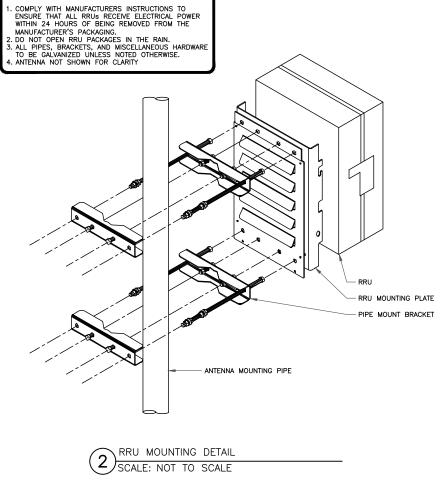

6x24 HYBRID TRUNK CROSS SECTION
SCALE: NOT TO SCALE

T Mobile



Kimley»Horn

421 FAYETTEVILLE ST, SUITE 600 RALEIGH, NC 27601

T-MOBILE SITE NUMBER: SL01312A

BU #: **829171** CROWN CASTLE SITE NAME WWEBER_BAUGH

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EXISTING 119'-0" MONOPOLE

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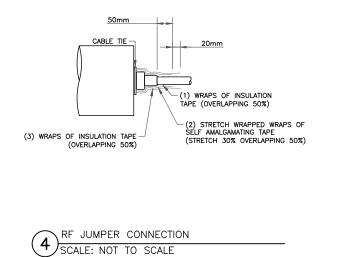


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SHEET NUMBER:

REVISION:



DETAIL NOT USED
SCALE: NOT TO SCALE

SKU#: N/A

VOLTAGE 120/240V AIC RATING 65,000 AMPS MAIN BREAKER 200 AMP **BUSS RATING** 200 AMPS MOUNT INSIDE PPC ENCLOSURE **NEUTRAL BAR ENCLOSURE TYPE** NEMA 3R GROUND BAR YES PANELSTATUS N TO GROUND BOND **EXISTING** YES

INTERNALTVSS PHASE, WIRES SINGLE, 3 BREAKER BREAKER BREAKER SERVICE USAGE PHASE A PHASE B USAGE SERVICE BREAKER BREAKER BREAKER FACTOR LOAD VA STATUS POLES СКТ CKT LOAD DESCRIPTION AMPS POLES STATUS LOADVA FACTOR VA VA AMPS LOAD DESCRIPTION **EMPTY** 1.25 ON 1.25 N/A 0 TVSS **EMPTY** ON N/A 4 30 0 1.25 1.25 0 GENERATOR EMPTY 20 ON 1000 1.25 1250 1.25 0 N/A **EMPTY EMPTY** N/A 0 1.25 1.25 N/A **EMPTY** N/A 0 1.25 1.25 0 N/A **EMPTY** 10 11 SHELTER 100 ON 18172 1.25 22715 1.25 0 N/A **EMPTY** 12 SUB PANEL 13 **EMPTY** 14 100 ON 18172 1.25 22715 1.25 0 N/A **EMPTY EMPTY** 15 0 1.25 1.25 16 N/A 0 N/A **EMPTY EMPTY** 0 1.25 1.25 0 N/A N/A **EMPTY EMPTY** 19 0 1.25 1.25 N/A 0 N/A

1.25

1.25

22715

23965

0

0

N/A

N/A

EMPTY

EMPTY

OVERALL LOAD SUMM	MARY	
TOTAL SERVICE LOAD kVA	46.68	
AMPS	10/150	

EMPTY

EMPTY

21

23

EXISTING PANEL SCHEDULE SCALE: NOT TO SCALE

0

0

N/A

N/A

1.25

1.25

R PE ESCRIPTION	200 AMP SHELTER SU NEMA 3R NEW SINGLE, 3 BREAKER AMPS	B PANEL		BUSS RATI NEUTRAL GROUND N TO GRO INTERNAL	BAR BAR		200 AMPS YES YES							
	NEMA 3R NEW SINGLE, 3 BREAKER			GROUND N TO GRO	BAR									
	NEW SINGLE, 3 BREAKER	BREAKER		N TO GRO			VEC							
	SINGLE, 3 BREAKER	BREAKER			UND BONE		ILS							
SCRIPTION	BREAKER	BREAKER		INITEDNIAL)	YES							
SCRIPTION		BREAKER		INTERNAL	TVSS		YES							
SCRIPTION	AMADS		BREAKER	SERVICE		PHASE A	PHASE B	USAGE	SERVICE	BREAKER	BREAKER	BREAKER		Π
	AIVIF	POLES	STATUS	LOAD VA	FACTOR	VA	VA	FACTOR	LOAD VA	STATUS	POLES	AMPS	LOAD DESCRIPTION	C
TVSS	30	2	ON	0	1.25	450		1.25	360	ON	2	40		L
1 7 3 3	30	2	ON	0	1.25		450	1.25	360	ON	2	40 AC		
R 6230 (NEW)	25	2	ON	600	1.25	1200		1.25	360	ON	2	40		
N 0230 (NEW)	25	2	ON	600	1.25		1200	1.25	360	ON	2	40		
R 6230 (NEW)	25	2	ON	600	1.25	1350		1.25	480	ON	1	20	LIGHT	
N 0230 (NEW)	25	2	ON	600	1.25		750	1.25	0	ON	1	20	FIBER PLUG	:
R 6230 (NEW)	25	2	ON	600	1.25	1500		1.25	600	ON	1	25	POWER 6230 (NEW)	
N 0230 (INEVV)	25	2	ON	600	1.25		1500	1.25	600	ON	1	25	POWER 0250 (NEW)	
R 6230 (NEW)	25	2	ON	600	1.25	2000		1.25	1000	ON	1	20	GENERATOR	:
N UZOU (INEW)	25	2	ON	600	1.25		750	1.25	0	N/A	1		EMPTY	
	25	2	ON	600	1.25	750		1.25	0	N/A	1		EMPTY	
POWER 6230 (NEW)	25	2	ON	600	1.25		750	1.25	0	N/A	1		EMPTY	:
		25 30 (NEW) 25	25 2 30 (NEW) 25 2	25 2 ON 30 (NEW) 25 2 ON	25 2 ON 600 30 (NEW) 25 2 ON 600	25 2 ON 600 1.25 30 (NEW) 25 2 ON 600 1.25	25 2 ON 600 1.25 30 (NEW) 25 2 ON 600 1.25 750	25 2 ON 600 1.25 750 30 (NEW) 25 2 ON 600 1.25 750 25 2 ON 600 1.25 750	30 (NEW) 25 2 ON 600 1.25 750 1.25 25 2 ON 600 1.25 750 1.25 25 2 ON 600 1.25 750 1.25	25 2 ON 600 1.25 750 1.25 0 30 (NEW) 25 2 ON 600 1.25 750 1.25 0 25 2 ON 600 1.25 750 1.25 0	25 2 ON 600 1.25 750 1.25 0 N/A	25 2 ON 600 1.25 750 1.25 0 N/A 1 30 (NEW) 25 2 ON 600 1.25 750 1.25 0 N/A 1 25 2 ON 600 1.25 750 1.25 0 N/A 1	25 2 ON 600 1.25 750 1.25 0 N/A 1 30 (NEW) 25 2 ON 600 1.25 750 1.25 0 N/A 1 25 2 ON 600 1.25 750 1.25 0 N/A 1	25 2 ON 600 1.25 750 1.25 0 N/A 1 EMPTY 30 (NEW) 25 2 ON 600 1.25 750 1.25 0 N/A 1 EMPTY 25 2 ON 600 1.25 750 1.25 0 N/A 1 EMPTY


			7250	5400
OVERALL LOAD SUM	MARY			
OTAL SERVICE LOAD kVA	12.65		<u>i</u>	نـــــ
MPS	52.71			

FINAL PANEL SCHEDULE 2) SCALE: NOT TO SCALE

NOTES:

ALL NEW CONDUCTORS TO BE INSTALLED SHALL BE COPPER. ALL CONDUCTORS SHALL BE THHW, THWN, THWN-2, XHHW, OR XHHW-2 UNLESS NOTED OTHERWISE.

CONTRACTOR IS TO FIELD VERIFY ALL EXISTING ITEMS SHOWN ON THE ELECTRICAL ONE—LINE DIAGRAM AND NOTIFY THE ENGINEER OF ANY DISCREPANCIES.

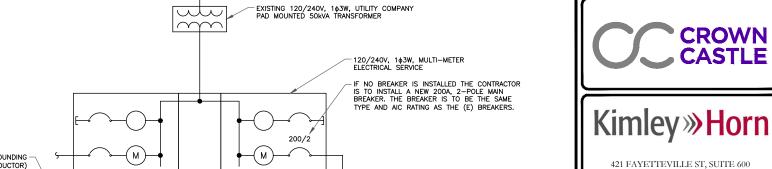

NEW POWER 6230

T-MOBILE SITE NUMBER: SL01312A

RALEIGH, NC 27601

CROWN CASTLE

BU #: **829171** CROWN CASTLE SITE NAME WWEBER_BAUGH

> 1224 S 4700 W OGDEN, UT 84401

EXISTING 119'-0" MONOPOLE

ISSUED FOR:								
REV	DATE	DRWN	DESCRIPTION	DES./QA				
0	02/17/25	AS	CONSTRUCTION	MCK				
1	03/18/25	DMW	CONSTRUCTION	MCK				
2	04/30/25	DMW	CONSTRUCTION	MTH				




05/01/25

Exp. 03/31/27

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SHEET NUMBER:


REVISION:

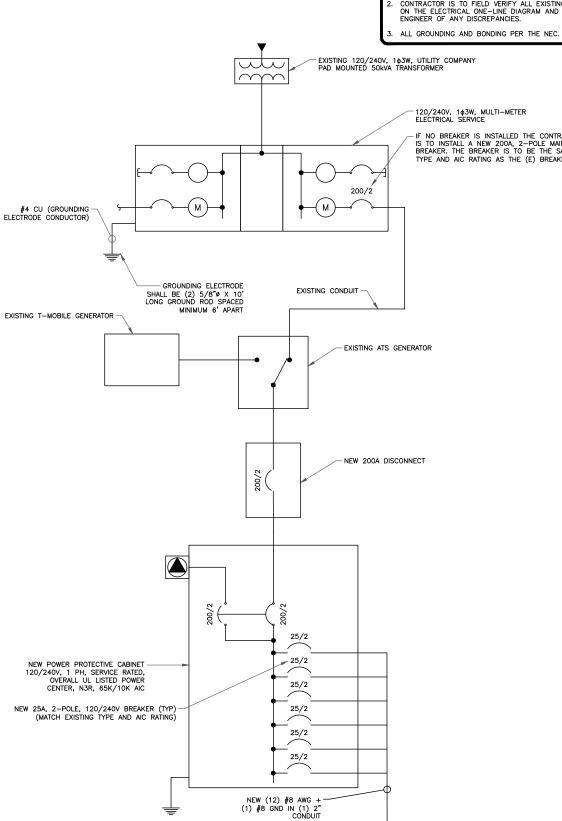



ONE-LINE DIAGRAM

SCALE: NOT TO SCALE

ALL METAL CONDUIT INSTALLED IN DIRECT CONTACT WITH THE EARTH SHALL BE CONSIDERED TO BE INSTALLED IN A SEVERELY CORROSNE ENVIRONMENT AND IS REQUIRED TO HAVE SUPPLEMENTAL PROTECTION AGAINST CORROSION (NEC ARTICLE 342.10(B) & 344.10(B)(1)). THIS PROTECTION SHALL EITHER BE AN APPROVED MANUFACTURER INSTALLED PROTECTIVE COATING ON THE CONDUIT OR SHALL BE (2) LAYERS OF 10 MIL PVC PIPE WRAP TAPE INSTALLED USING OPPOSING SPIRAL WRAPS. ON VERTICAL PIPE THE OUTSIDE LAYER OF TAPE SHALL BE WRAPPED SO AS TO PROVIDE SHEDDING OF WATER (i.e. TAPE SHOULD WRAP IN AN UPWARD DIRECTION WITH LOWER WRAP BEING BENEATH THE WRAP ABOVE). SPIRAL WRAPS SHALL HAVE A MINIMUM OF 1/4" OVERLAP WITH THE PRECEDING TAPE WRAP. ANY OTHER METHODS OF CORROSION PROTECTION SHALL REQUIRE APPROVAL BY THE ENSINEER OF RECORD PRIOR TO BEING USED.

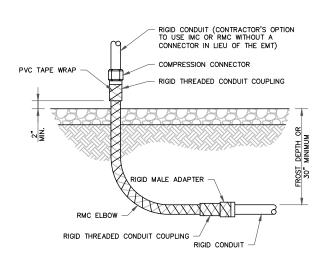

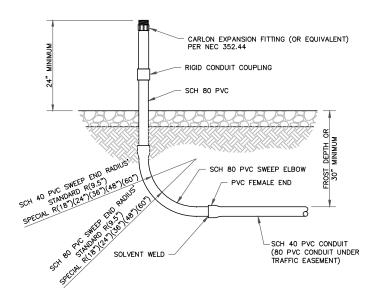

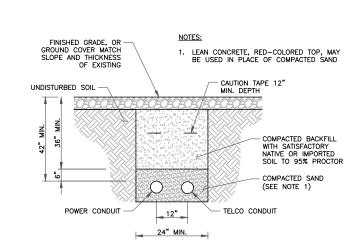



Kimley»Horn

421 FAYETTEVILLE ST, SUITE 600 RALEIGH, NC 27601

T-MOBILE SITE NUMBER: **SL01312A**

BU #: **829171** Crown Castle Site Name: **Wweber_baugh**

> 1224 S 4700 W OGDEN, UT 84401

EXISTING 119'-0" MONOPOLE

ISSUED FOR:							
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Exp. 03/31/27


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SHEET NUMBER:

REVISION:

CONDUIT STUB UP DETAILS
SCALE: NOT TO SCALE

TRENCH DETAIL
SCALE: NOT TO SCALE

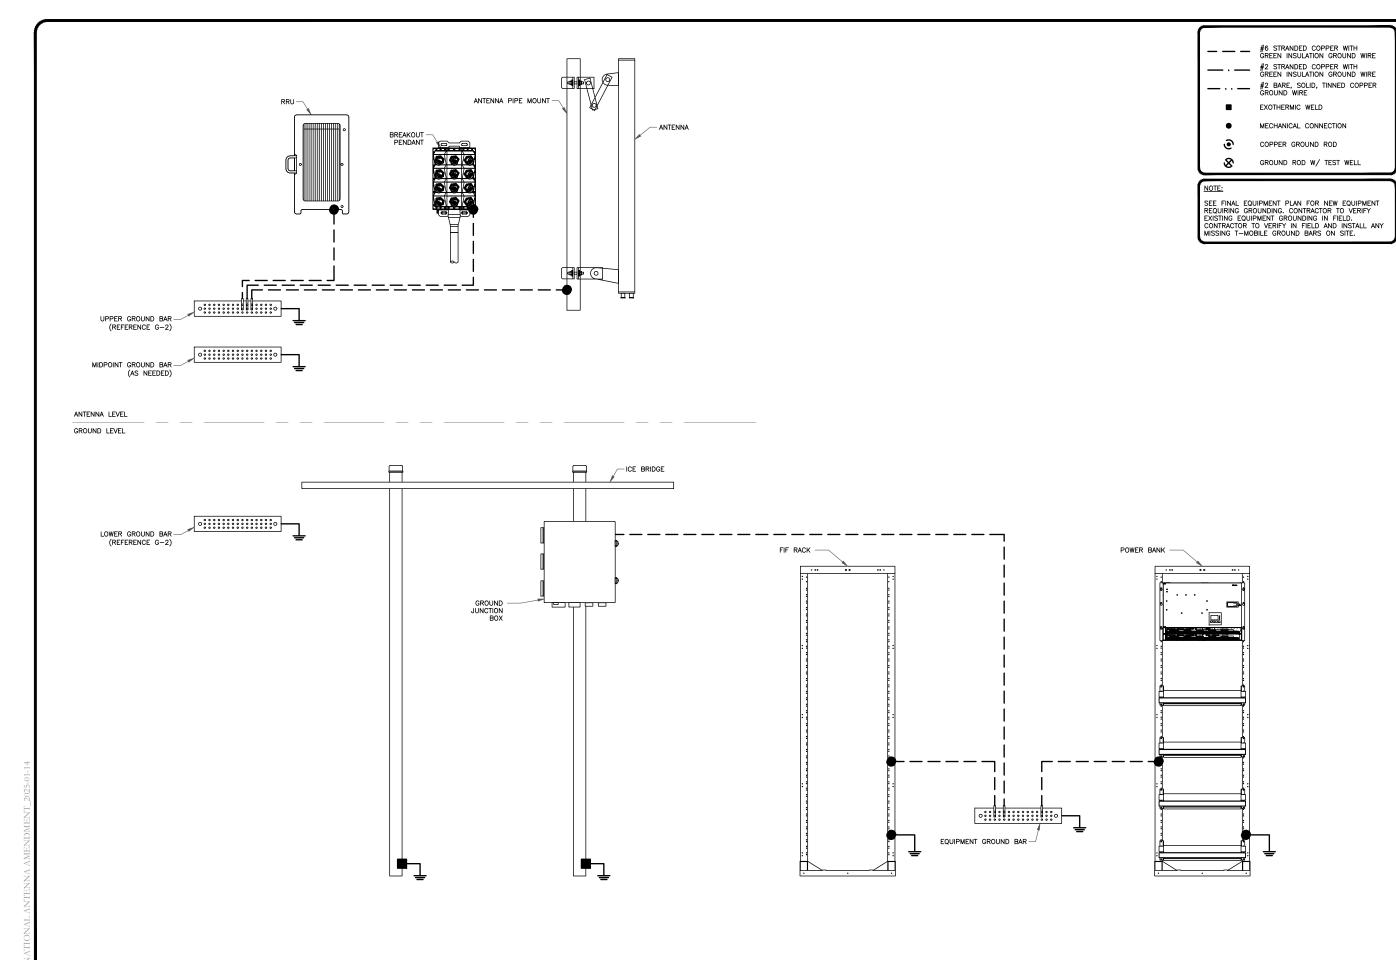

T Mobile

CROWN

Kimley » Horn

421 FAYETTEVILLE ST, SUITE 600 RALEIGH, NC 27601

T-MOBILE SITE NUMBER: **SL01312A**

BU #: **829171** CROWN CASTLE SITE NAME: **WWEBER_BAUGH**

> 1224 S 4700 W OGDEN, UT 84401

EXISTING 119'-0" MONOPOLE

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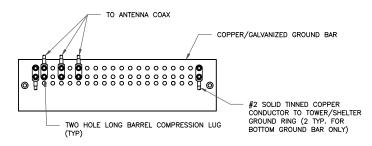
G-1

2

NOTES:

- 1. DOUBLING UP "OR STACKING" OF CONNECTIONS IS NOT PERMITTED.
- 2. EXTERIOR ANTIOXIDANT JOINT COMPOUND TO BE USED ON ALL EXTERIOR CONNECTIONS.
- 3. GROUND BAR SHALL NOT BE ISOLATED FROM TOWER. MOUNT DIRECTLY TO ANTENNA MOUNT STEEL.


ANTENNA SECTOR GROUND BAR DETAIL
SCALE: NOT TO SCALE



IOTES:


- 1. EXTERIOR ANTIOXIDANT JOINT COMPOUND TO BE USED ON ALL EXTERIOR CONNECTIONS.
- 2. GROUND BAR SHALL NOT BE ISOLATED FROM TOWER. MOUNT DIRECTLY TO TOWER STEEL (TOWER ONLY).
- 3. GROUND BAR SHALL BE ISOLATED FROM BUILDING OR SHELTER.


TOWER/SHELTER GROUND BAR DETAIL
SCALE: NOT TO SCALE

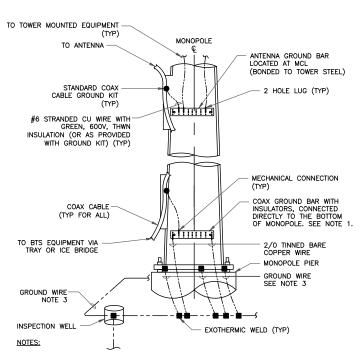

- NUMBER OF GROUNDING BARS MAY VARY DEPENDING ON THE TYPE OF TOWER, ANTENNA LOCATIONS AND CONNECTION ORIENTATION. COAXIAL CABLES EXCEEDING 200 FEET ON THE TOWER SHALL HAVE GROUND KITS AT THE MIDPOINT. PROVIDE AS REQUIRED.
- ONLY MECHANICAL CONNECTIONS ARE ALLOWED TO BE MADE TO CROWN CASTLE USA INC. TOWERS. ALL MECHANICAL CONNECTIONS SHALL BE TREATED WITH AN ANTI-OXIDANT COATING.
- 3. ALL TOWER GROUNDING SYSTEMS SHALL COMPLY WITH THE REQUIREMENTS OF THE RECOGNIZED EDITION OF ANSI/TIA 222 AND NFPA 780.


TYPICAL ANTENNA CABLE GROUNDING
SCALE: NOT TO SCALE

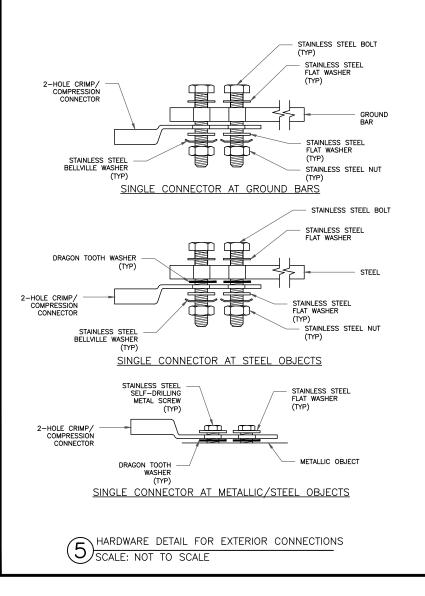

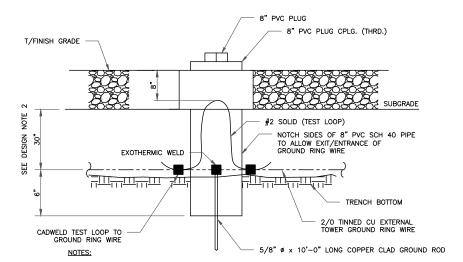

- GROUND ROD SHALL BE DRIVEN VERTICALLY, NOT TO EXCEED 45 DEGREES FROM THE VERTICAL
- GROUND WIRE SHALL BE MIN. 30" BELOW GRADE OR 6" BELOW FROST LINE (WHICH EVER IS GREATER) AS PER N.E.C. ARTICLE 250–50(D)

INSPECTION WELL DETAIL SCALE: NOT TO SCALE

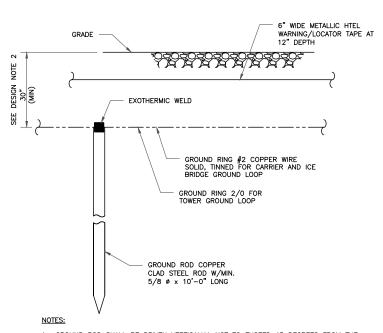

- GROUND ROD SHALL BE DRIVEN VERTICALLY, NOT TO EXCEED 45 DEGREES FROM THE VERTICAL
- GROUND WIRE SHALL BE MIN. 30" BELOW GRADE OR 6" BELOW FROST LINE. (WHICH EVER IS GREATER) AS PER N.E.C. ARTICLE 250-50(D)

GROUND ROD DETAIL
SCALE: NOT TO SCALE

T Mobile





421 FAYETTEVILLE ST, SUITE 600 RALEIGH, NC 27601

T-MOBILE SITE NUMBER: **SL01312A**

BU #: **829171** Crown Castle Site Name **Wweber_Baug**h

> 1224 S 4700 W OGDEN, UT 84401

EXISTING 119'-0" MONOPOLE

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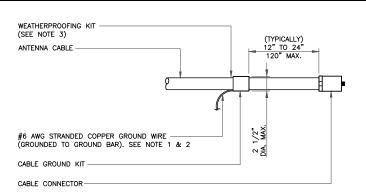
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SHEET NUMBER:

NOTE:

- ERICO EXOTHERMIC "MOLD TYPES" SHOWN HERE ARE EXAMPLES. CONSULT WITH CONSTRUCTION MANAGER FOR SPECIFIC MOLDS TO BE USED FOR THIS PROJECT.
 MOLD TYPE ONLY TO BE USED BELOW GRADE WHEN CONNECTING GROUND RING TO GROUND ROD.


CADWELD GROUNDING CONNECTIONS SCALE: NOT TO SCALE



NOTES:

- DO NOT INSTALL CABLE GROUND KIT AT A BEND AND ALWAYS DIRECT GROUND WIRE DOWN TO GROUND BAR.
- GROUNDING KIT SHALL BE TYPE AND PART NUMBER AS SUPPLIED OR RECOMMENDED BY CABLE MANUFACTURER.
- WEATHER PROOFING SHALL BE TWO-PART TAPE KIT, COLD SHRINK SHALL NOT BE USED.


CABLE GROUND KIT CONNECTION
SCALE: NOT TO SCALE

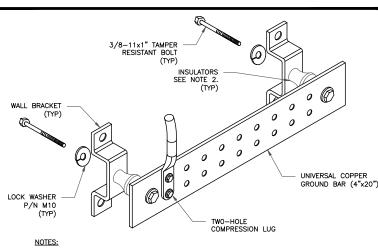

1. DOWN LEAD (HOME RUN) CONDUCTORS ARE <u>NOT</u> TO BE INSTALLED ON CROWN CASTLE USA INC. TOWER, PER THE GROUNDING DOWN CONDUCTOR POLICY QAS-STD-10091. NO MODIFICATION OR DRILLING TO TOWER STEEL IS ALLOWED IN ANY FORM OR FASHION, CAD-WELDING ON THE TOWER AND/OR IN THE AIR ARE NOT PERMITTED

2. OMIT INSULATOR WHEN MOUNTING TO TOWER STEEL OR PLATFORM STEEL USE INSULATORS WHEN ATTACHING TO BUILDING OR SHELTERS.


GROUND BAR DETAIL
SCALE: NOT TO SCALE

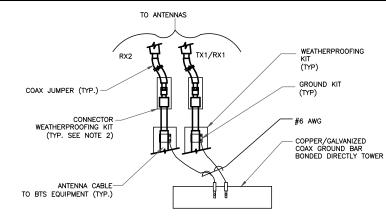


NOTES:

- DO NOT INSTALL CABLE GROUND KIT AT A BEND AND ALWAYS DIRECT GROUND WIRE DOWN TO ANTENNA GROUND BAR.
- WEATHER PROOFING SHALL BE TWO-PART TAPE KIT. COLD SHRINK SHALL NOT BE USED.

GROUND CABLE CONNECTION SCALE: NOT TO SCALE

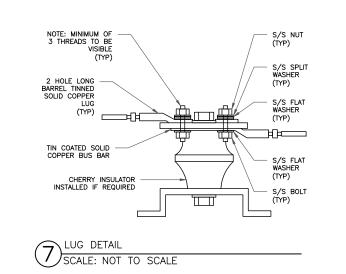


WIRE SIZE BURNDY LUG BOLT SIZE 3/8" - 16 NC S 2 BOLT #6 AWG GREEN INSULATED YA6C-2TC38 #2 AWG SOLID TINNED YA3C-2TC38 3/8" - 16 NC S 2 BOLT #2 AWG STRANDED 3/8" - 16 NC S 2 BOLT YA2C-2TC38 #2/0 AWG STRANDED 3/8" - 16 NC S 2 BOLT YA26-2TC38 #4/0 AWG STRANDED YA28-2N 1/2" - 16 NC S 2 BOLT

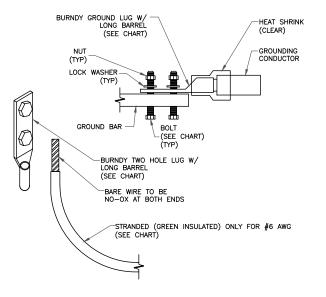


NOTES:

ALL GROUNDING LUGS ARE TO BE INSTALLED PER MANUFACTURER'S SPECIFICATIONS. ALL HARDWARE BOLTS, NUTS, LOCK WASHERS SHALL BE STAINLESS STEEL. ALL HARDWARE ARE TO BE AS FOLLOWS: BOLT, FLAT WASHER, GROUND BAR, GROUND LUG, FLAT WASHER AND NUT.

MECHANICAL LUG CONNECTION MECHANICAL LUG CON SCALE: NOT TO SCALE

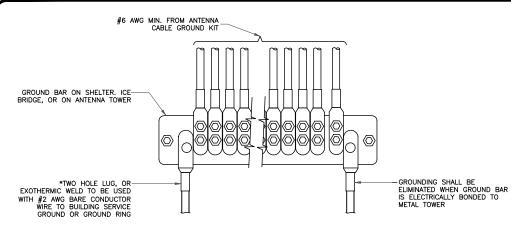

GROUNDWIRE INSTALLATION SCALE: NOT TO SCALE

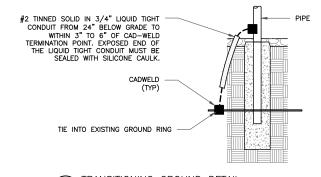

TRANSITIONING GROUND DETAIL 8 TRANSITIONING GROUN
SCALE: NOT TO SCALE





421 FAYETTEVILLE ST, SUITE 600 RALEIGH, NC 27601

T-MOBILE SITE NUMBER: SL01312A

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