
COBBLE CREEK RCMP

WATER SYSTEM IMPROVEMENTS WEBER COUNTY, UTAH

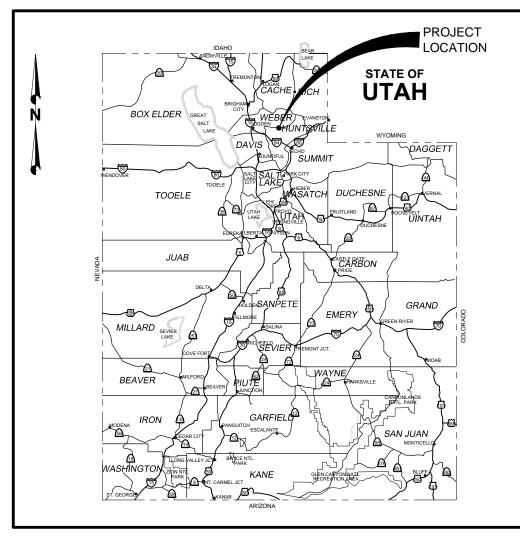

PROJECT LOCATION MAP

Project for:


THE CHURCH OF JESUS CHRIST OF LATTER-DAY SAINTS

PROPERTY NUMBER: 5176182-14-02-01-01

SHEET INDEX

NO.	TITLE
G-01	COVER SHEET
G-02	SURVEY CONTROL AND SITE KEY PLAN
G-03	ELEVATION AND HYDRAULIC PROFILE
C-01	CIVIL SYMBOLS, LEGENDS, & ABBREVIATIONS
C-02	CIVIL DETAILS
C-03	CIVIL DETAILS
C-100	SPRING AND TANK AREA PLAN
C-101	ENLARGED PLAN AND PROFILES
C-102	SPRING COLLECTION AREA DETAILS
C-103	MAIN CAMP AREA SITE PLAN
E-001	ELECTRICAL SYMBOL LEGEND
E-100	ELECTRICAL SITE PLAN
E-101	DISINFECTION BUILDING ELECTRICAL PLANS
E-201	ELECTRICAL TANK ELEVATION
E-501	ELECTRICAL DETAILS
E-601	ELECTRICAL DIAGRAMS

FA PROJECT NO. 05-14-0086 MAR. 2015

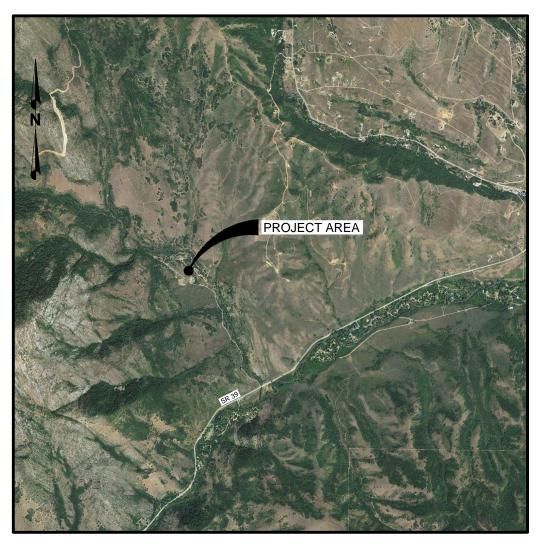


VICINITY MAP


N.T.S








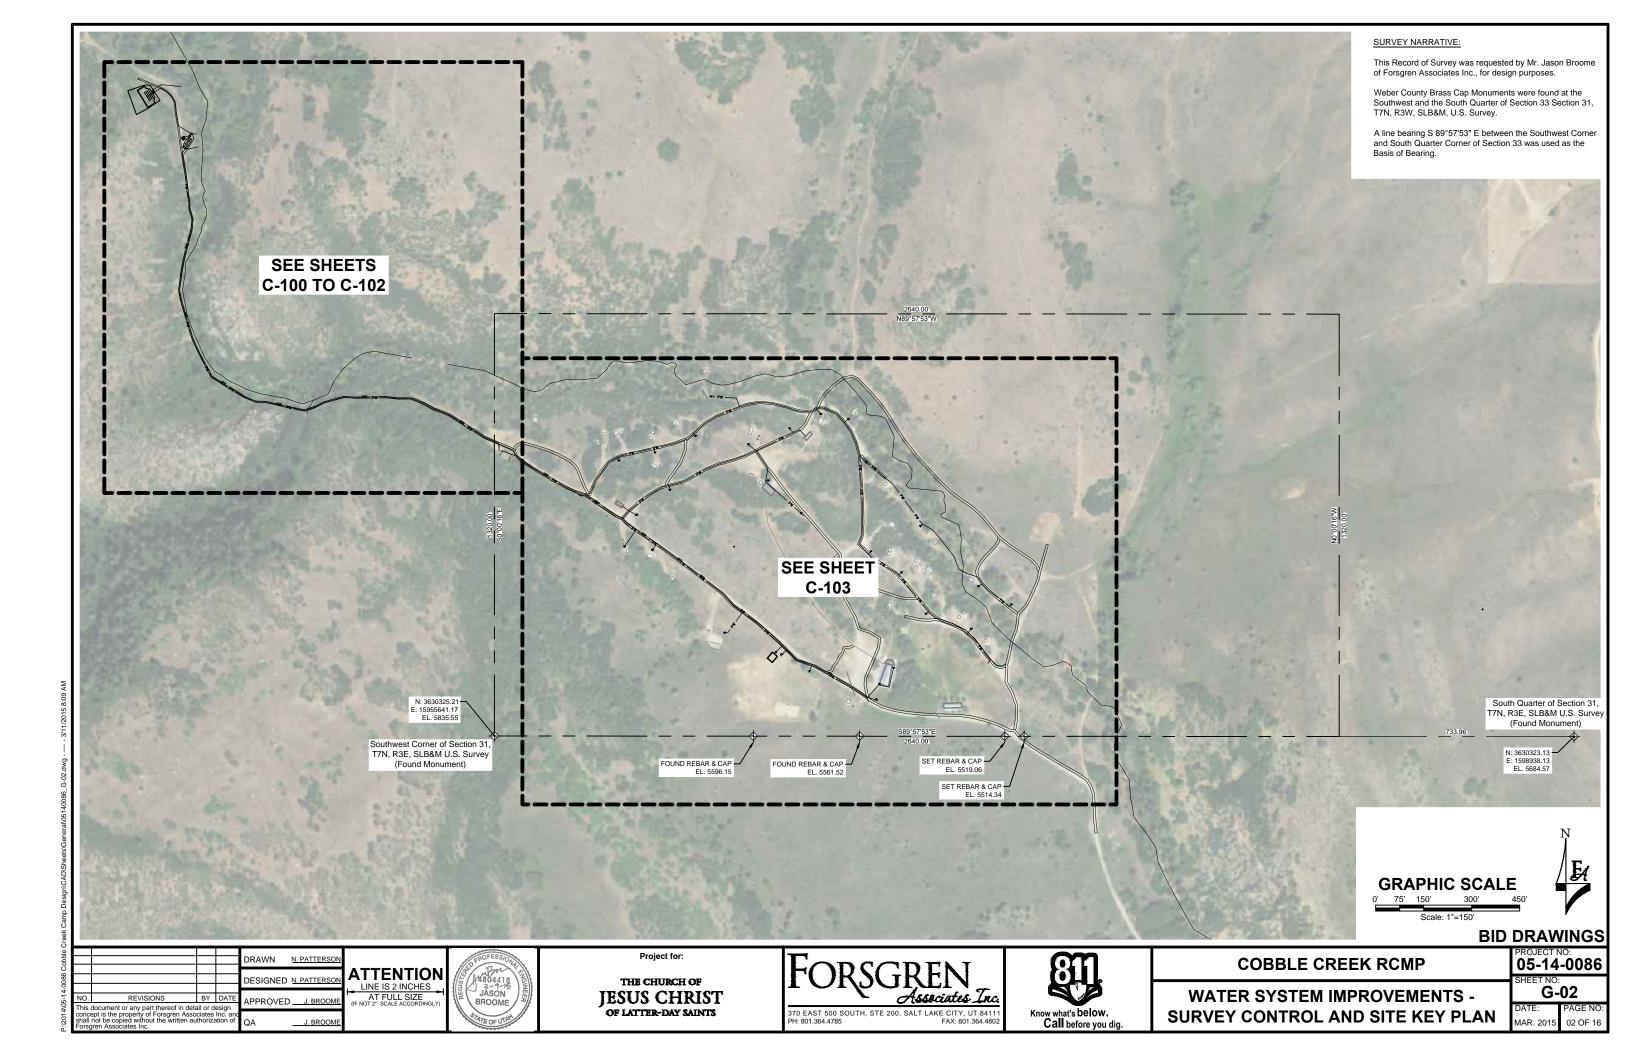


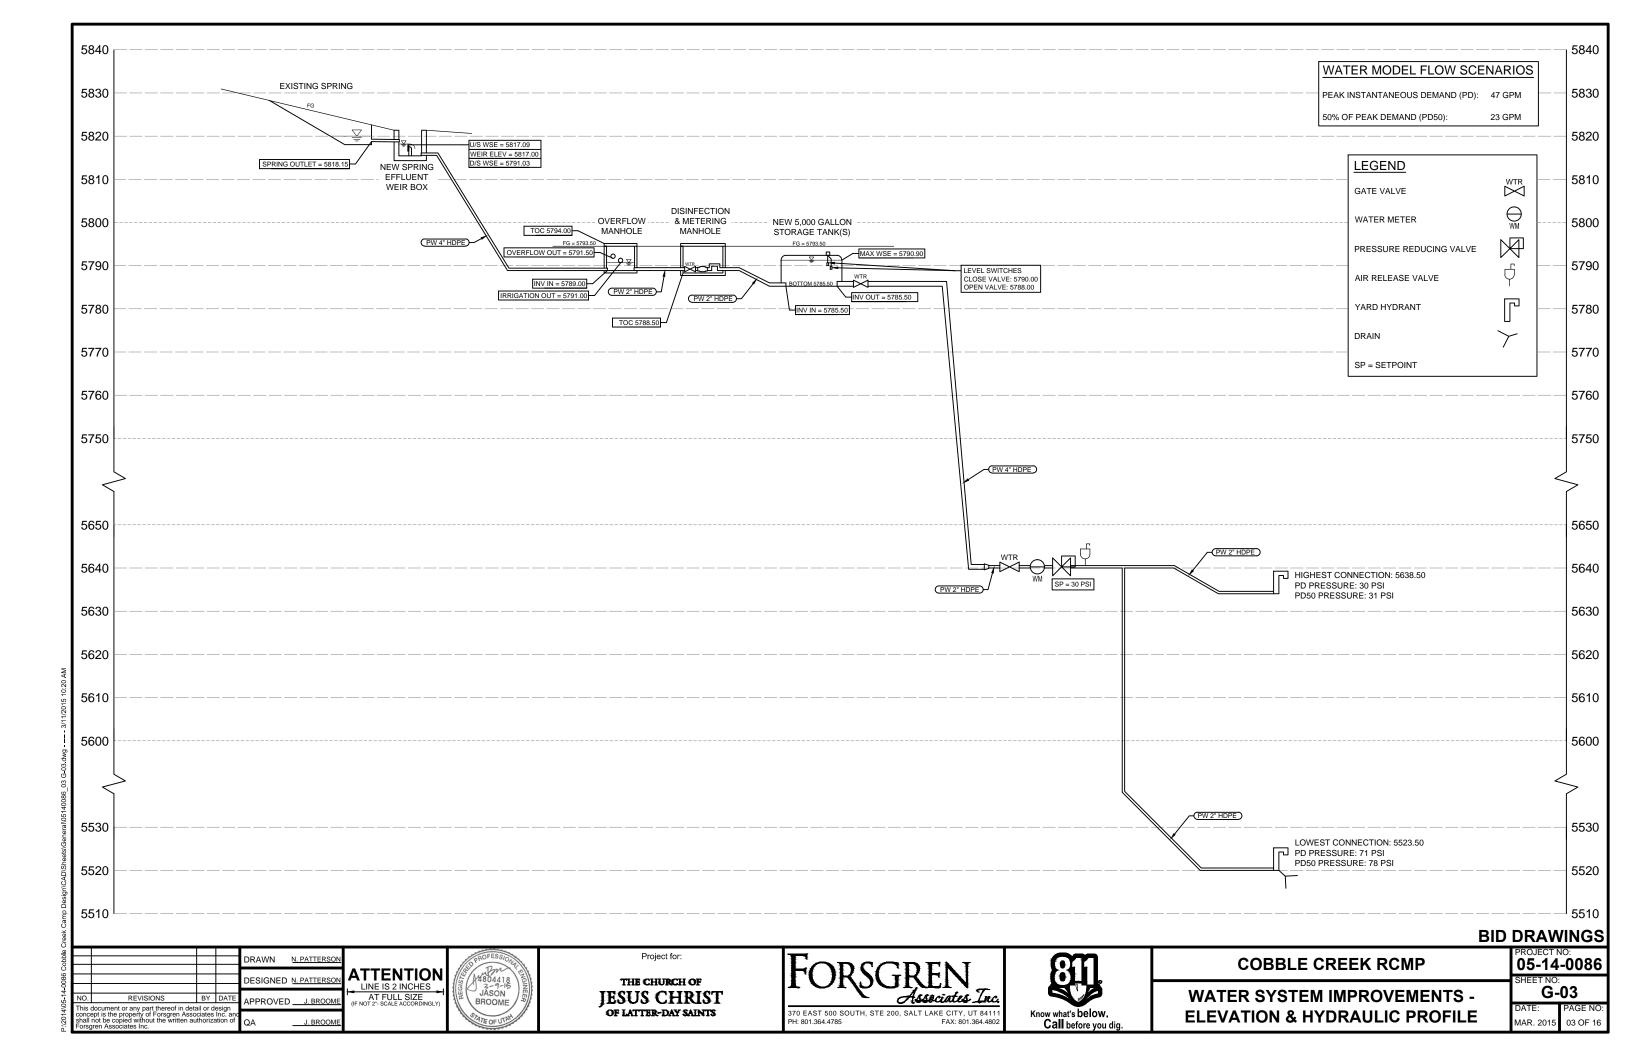


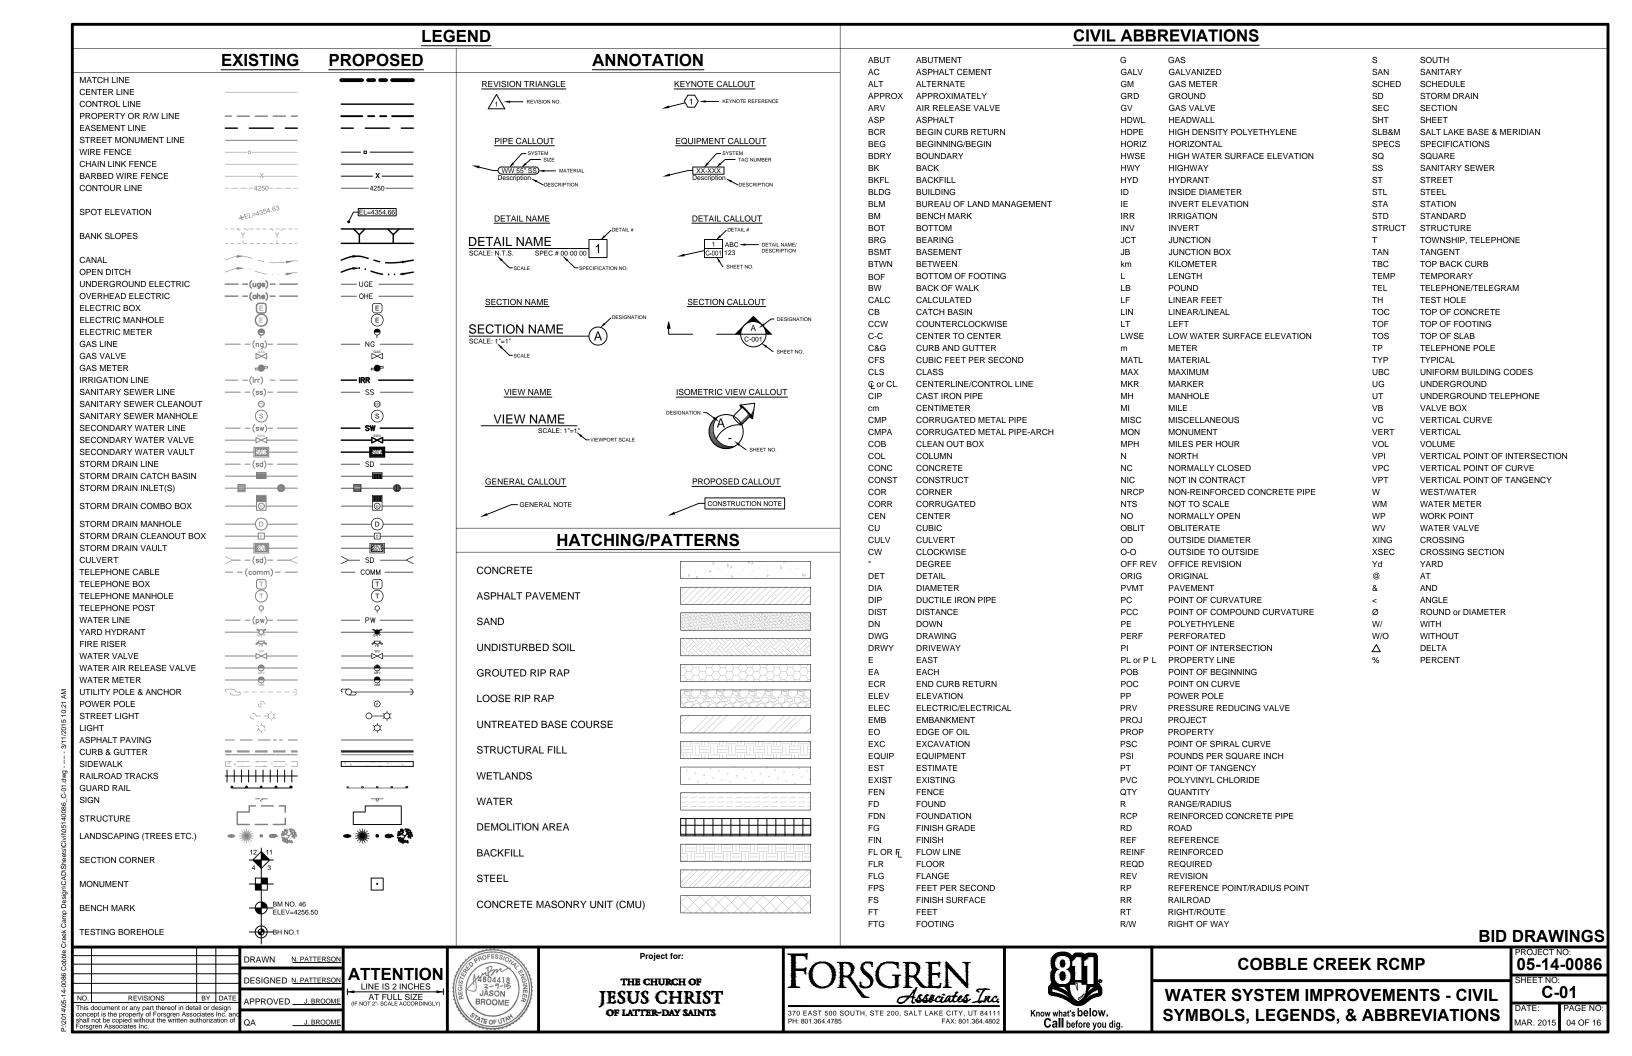



GENERAL NOTES


- ANY MODIFICATION TO THE ORIGINAL CONSTRUCTION PACKAGE SHALL BE APPROVED BY THE ENGINEER OF RECORD.
- CONTRACTOR SHALL NOTIFY BLUE STAKES OF UTAH (800-662-4111) 48 HOURS IN ADVANCE OF ANY CONSTRUCTION.
- ALL EXISTING UTILITIES ARE SHOWN IN APPROXIMATE LOCATIONS ONLY. CONTRACTOR SHALL FIELD VERIFY ALL UTILITY LOCATIONS PRIOR TO CONSTRUCTION. CONTRACTOR SHALL NOTIFY ENGINEER OF ALL UTILITY CONFLICTS UPON DISCOVERY
- CONTRACTOR SHALL LOCATE, RETAIN, AND PROTECT ALL EXISTING UTILITIES.
- CONTRACTOR SHALL BE RESPONSIBLE FOR CORRECTING ANY SETTLEMENT OF OR DAMAGE TO EXISTING UTILITIES.
- CONTRACTOR SHALL BE RESPONSIBLE FOR ANY DAMAGE TO ADJACENT SURFACE IMPROVEMENTS IMPACTED BY CONSTRUCTION.
- ALL PARTS, FITTINGS, SEALS, SOLVENTS, ETC. SHALL BE NSF APPROVED FOR USE IN DRINKING WATER APPLICATIONS.
- CONTRACTOR SHALL PROVIDE ALL FITTINGS, BOLTS, FLANGES, ETC. THAT ARE INTEGRAL TO A COMPLETE OPERATIONAL PROJECT.
- CONTRACTOR SHALL PROVIDE ALL WIRING, CONDUITS, JUNCTIONS, EQUIPMENT, ETC. THAT ARE INTEGRAL TO A COMPLETE OPERATIONAL PROJECT.

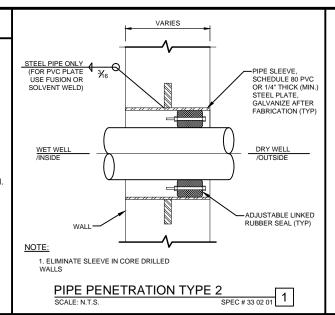


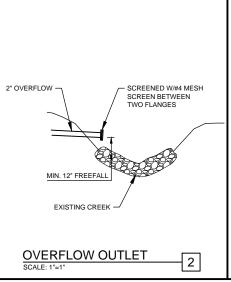

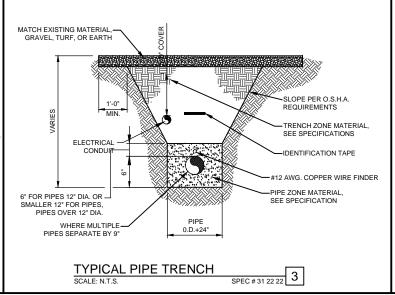

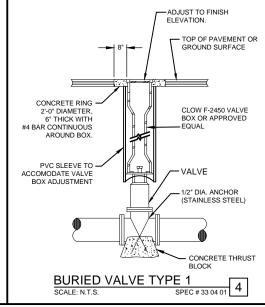

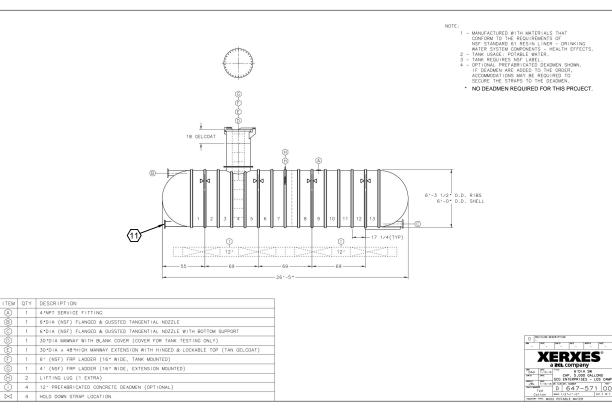

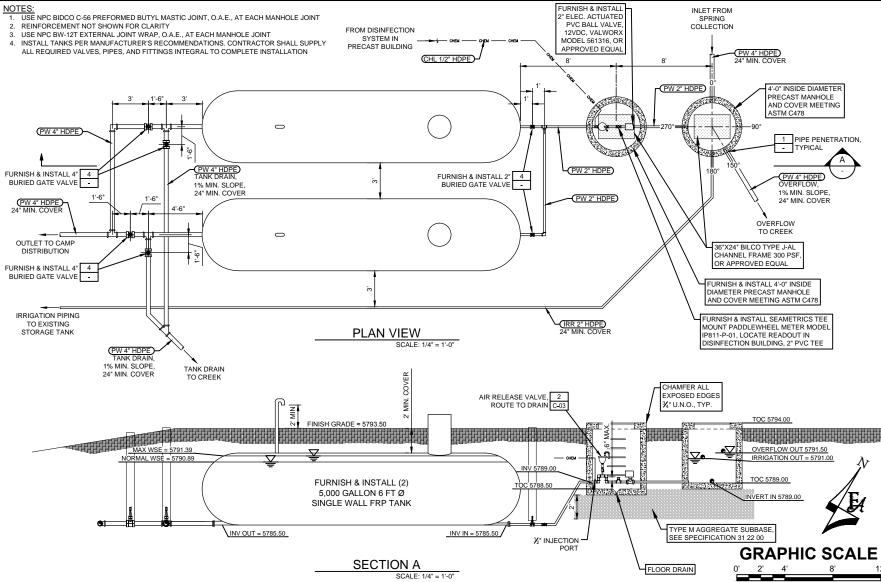

- ITEM 10 (AUXILIARY FILL) IS NOT REQUIRED FOR THIS PROJECT 2. VENT OPENING (ITEM 9) SHALL HAVE 24" CLEARANCE FROM FINAL GRADE

3. RELOCATE ITEM B TO BOTTOM OF TANK, ADD BOTTOM SUPPORT AS PER ITEM C. (11)

WATER STORAGE TANK & INFLUENT MANHOLES

BID DRAWINGS

DRAWN N. PATTERSOI DESIGNED N. PATTERSO REVISIONS APPROVED J. BROOM This document or any part thereof in detail or design concept is the property of Forsgren Associates Inc. a shall not be copied without the written authorization o forsgren Associates Inc. J. BROOM

ATTENTION LINE IS 2 INCHES AT FULL SIZE

14804418 3-9-15 BROOME

Project for:

THE CHURCH OF **IESUS CHRIST** OF LATTER-DAY SAINTS







COBBLE CREEK RCMP

05-14-0086

WATER SYSTEM IMPROVEMENTS -CIVIL NOTES & DETAILS

C-02 MAR. 2015 05 OF 16

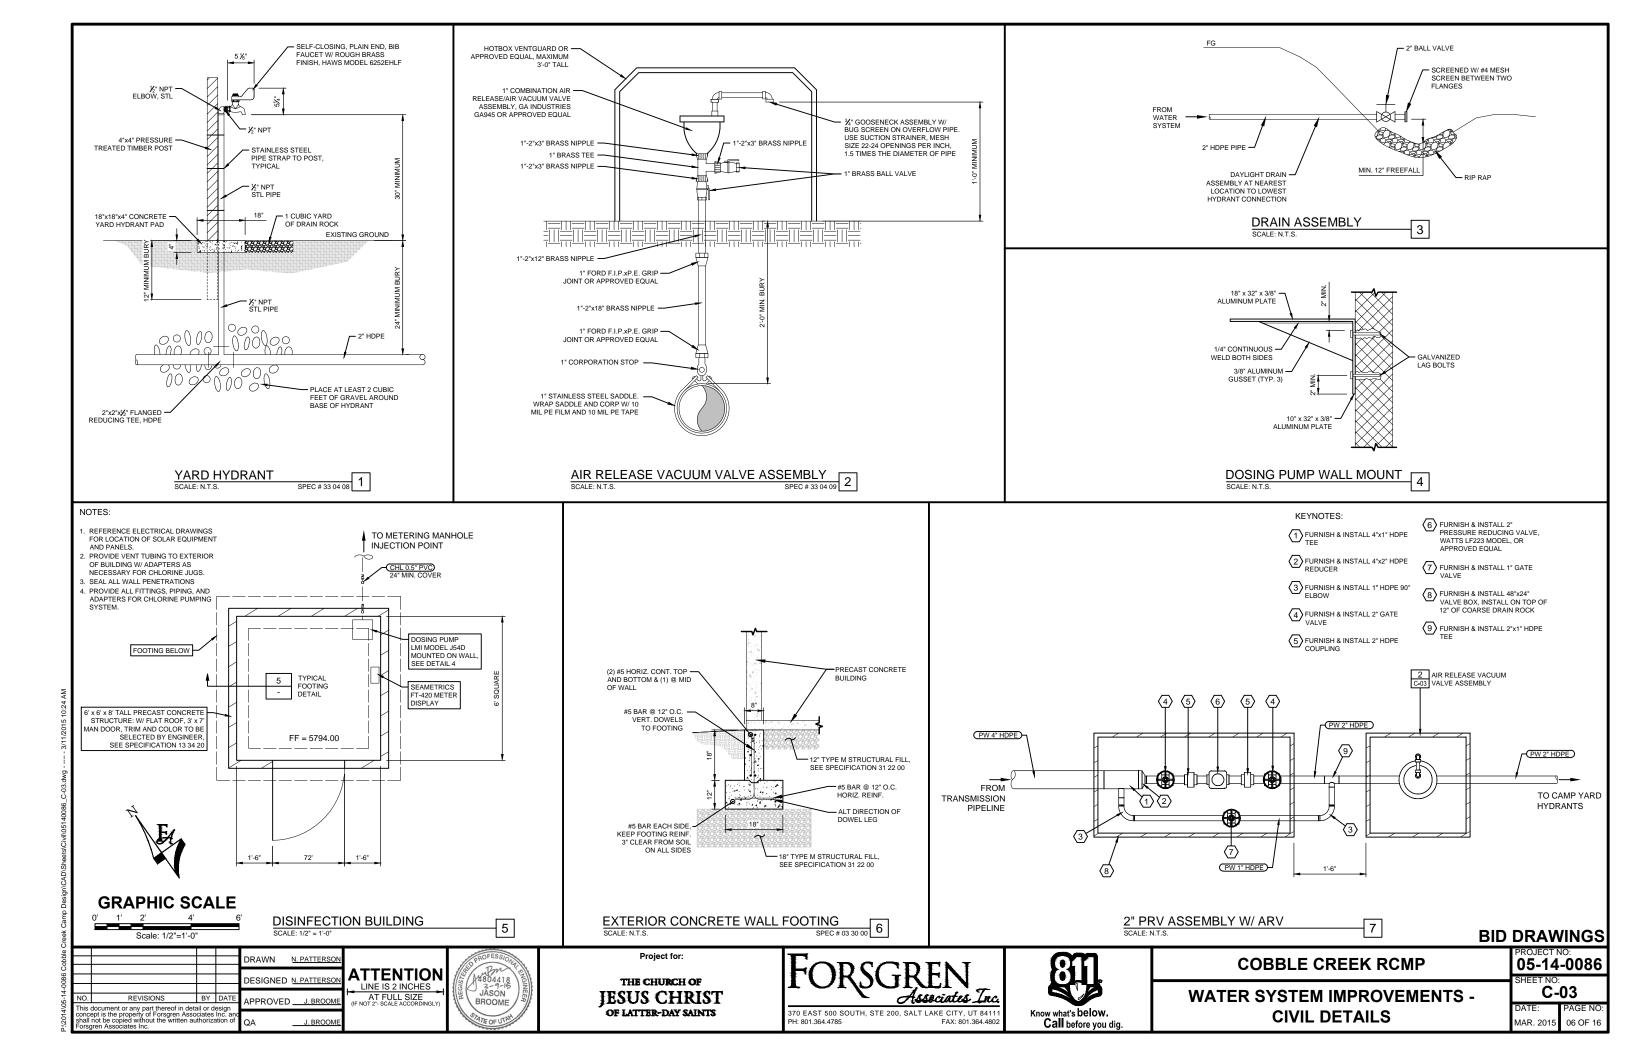

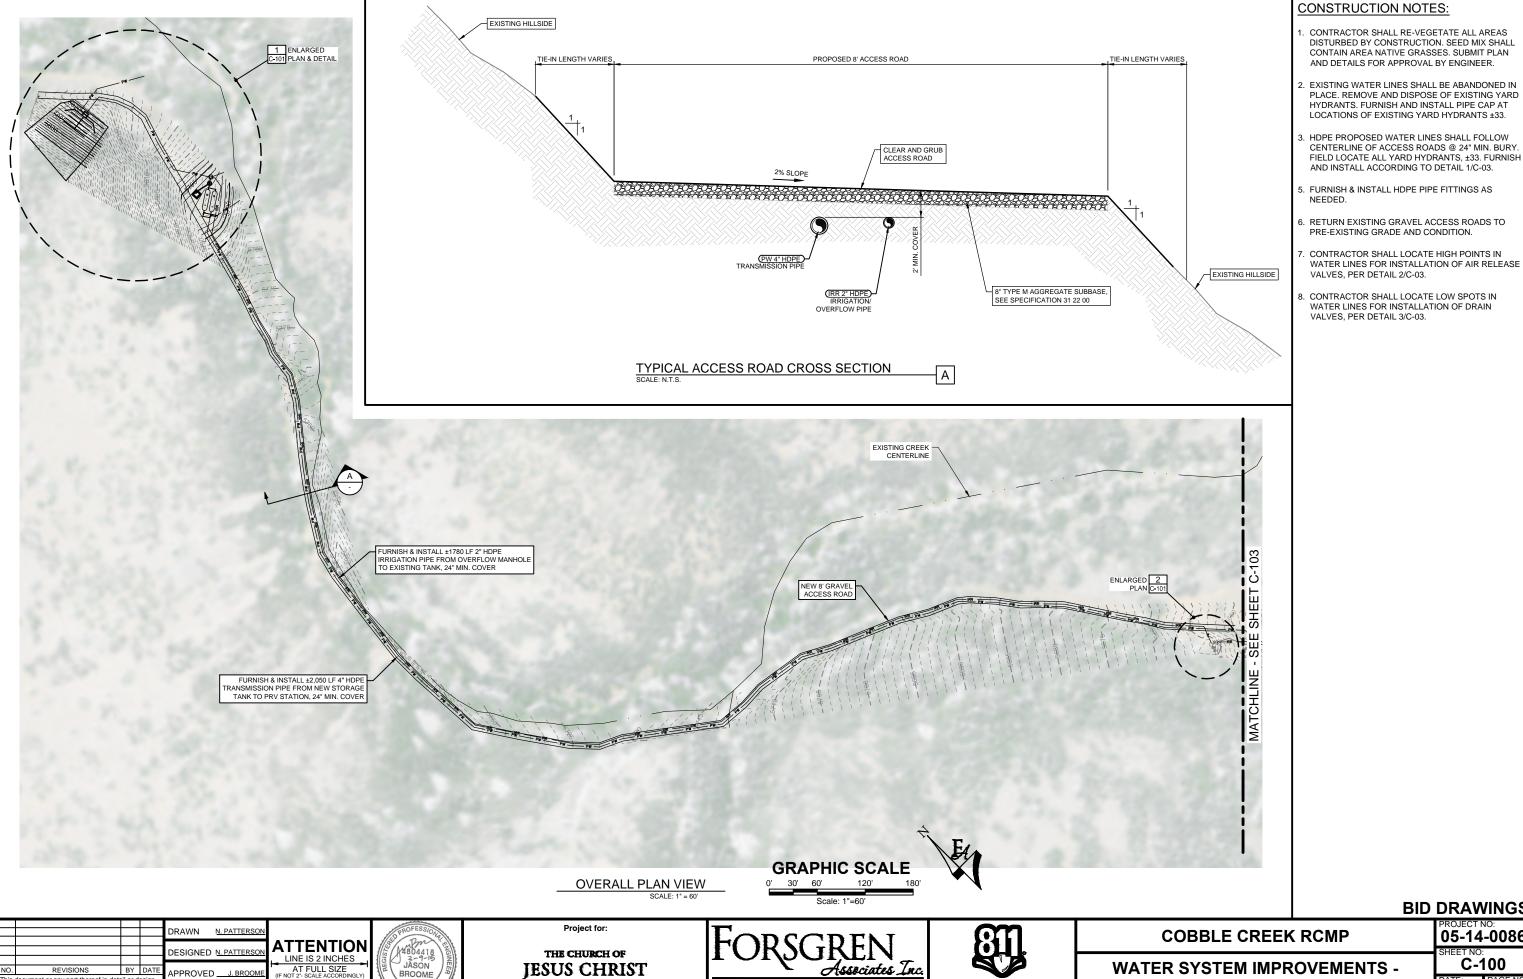

BID DRAWINGS

VALVES, PER DETAIL 2/C-03.

IESUS CHRIST OF LATTER-DAY SAINTS 370 EAST 500 SOUTH, STE 200, SALT LAKE CITY, UT 84111 PH: 801.364.4785 FAX: 801.364.4802

APPROVED _____ J. BROOM

J. BROOM

This document or any part thereof in detail or design oncept is the property of Forsgren Associates Inc. ar-shall not be copied without the written authorization of orsgren Associates Inc.

BROOME



WATER SYSTEM IMPROVEMENTS -

SPRING AND TANK AREA PLAN


05-14-0086


C-100



CONSTRUCTION NOTES:

- CONTRACTOR SHALL RE-VEGETATE ALL AREAS DISTURBED BY CONSTRUCTION. SEED MIX SHALL CONTAIN AREA NATIVE GRASSES. SUBMIT PLAN AND DETAILS FOR APPROVAL BY ENGINEER.
- EXISTING WATER LINES SHALL BE ABANDONED IN PLACE. REMOVE AND DISPOSE OF EXISTING YARD HYDRANTS. FURNISH AND INSTALL PIPE CAP AT LOCATIONS OF EXISTING YARD HYDRANTS ±33.
- 2" HDPE PROPOSED WATER LINES SHALL FOLLOW CENTERLINE OF ACCESS ROADS @ 24" MIN. BURY. FIELD LOCATE ALL YARD HYDRANTS, ±33. FURNISH AND INSTALL ACCORDING TO DETAIL 1/C-03.
- 4. RETURN EXISTING GRAVEL ACCESS ROADS TO PRE-EXISTING GRADE AND CONDITION.
- 5. FURNISH & INSTALL HDPE PIPE FITTINGS AS NEEDED.

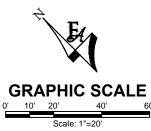

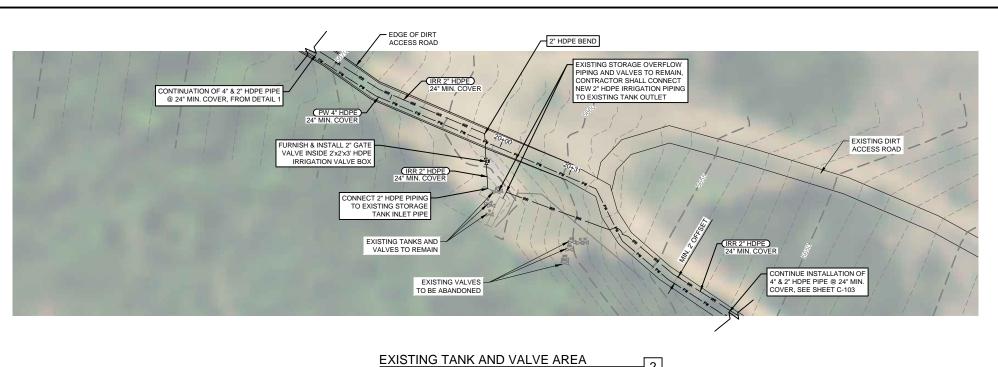

GRAPHIC SCALE

O' 10' 20' 40' 60

Scale: 1"=20'

BID DRAWINGS

NO. REVISIONS BY DATE
This document or any part thereof in detail or design concept is the property of Foregren Associates Inc. and shall not be copied without the written authorization of Forsgren Associates Inc. and Sasociates Inc. and Sasociat

ATTENTION

LINE IS 2 INCHES

AT FULL SIZE

(IF NOT 2'- SCALE ACCORDINGLY)

H SPATE OF UTAL

Project for:

THE CHURCH OF
JESUS CHRIST
OF LATTER-DAY SAINTS





COBBLE CREEK RCMP


WATER SYSTEM IMPROVEMENTS -


ENLARGED PLANS

PROJECT NO: **05-14-0086**

C-101

DATE: PAGE NO: MAR. 2015 08 OF 16

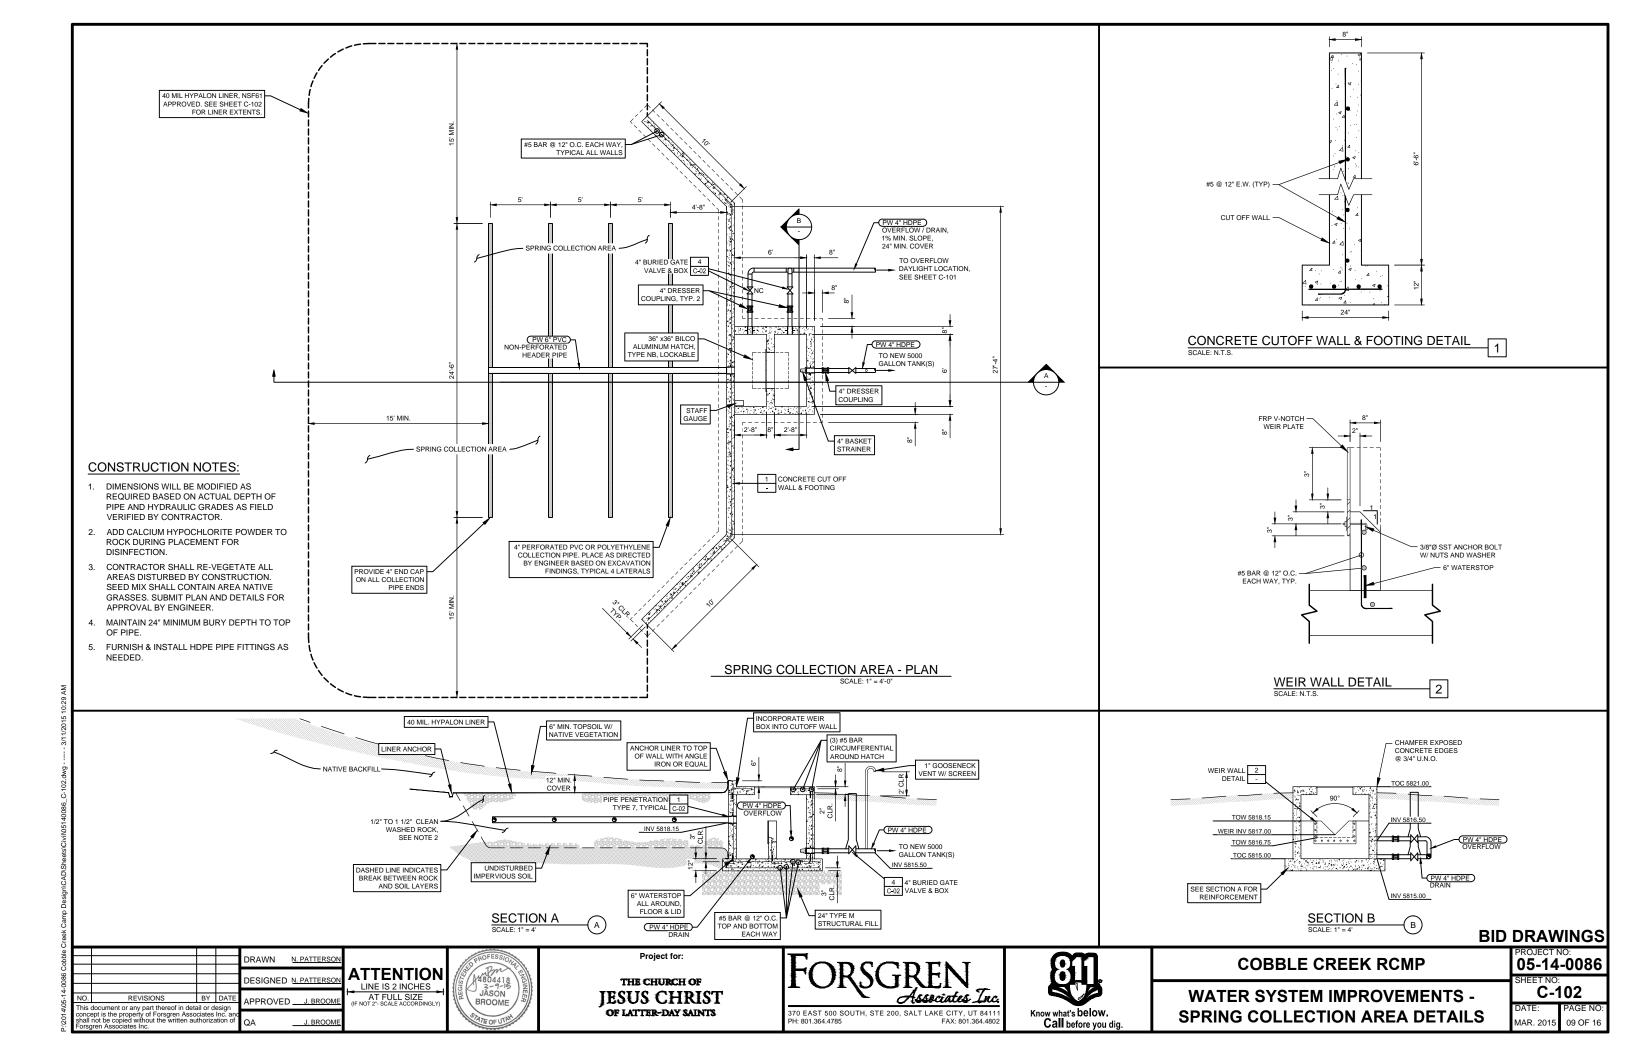

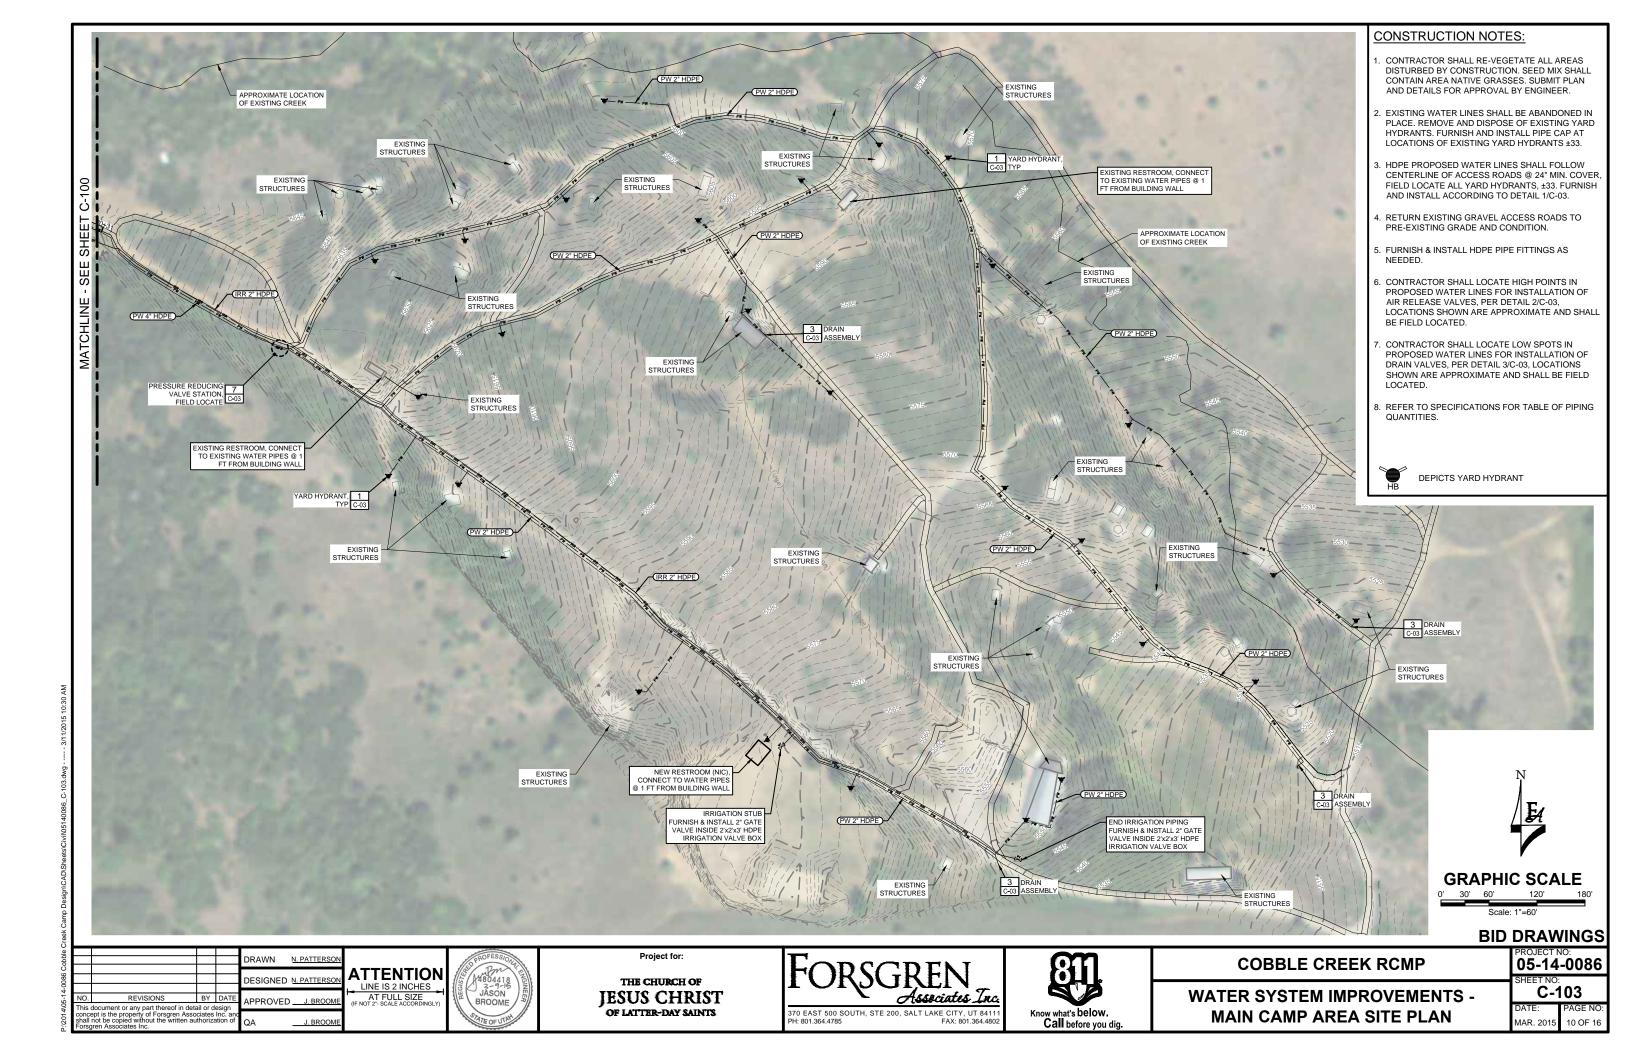

SYMBOL	DESCRIPTION	SYMBOL	DESCRIPTION	SYMBOL	DESCRIPTION	SYMBOL
₽	DUPLEX RECEPTACLE	ூ	TELEPHONE OUTLET, RECESSED CEILING MOUNTED	TE	TEMPERATURE ELEMENT	~~
1	DUPLEX RECEPTACLE, RECESSED FLOOR MOUNTED	# _¥ #	ETHERNET / TELEPHONE JACK # INDICATES NUMBER OF DATA AND VOICE JACKS RESPECTIVELY	m	TEMPERATURE INDICATING TRANSMITTER	(<u>₩</u>
(DUPLEX RECEPTACLE, RECESSED CEILING MOUNTED	0	ETHERNET / TELEPHONE JACK, RECESSED FLOOR MOUNTED	15	TEMPERATURE SWITCH	
#	QUADRAPLEX RECEPTACLE	(17)	ETHERNET / TELEPHONE JACK, RECESSED CEILING MOUNTED	П	TEMPERATURE TRANSMITTER	
#	QUADRAPLEX RECEPTACLE, RECESSED FLOOR MOUNTED		TELEPHONE TERMINAL BOARD	(25)	LIMIT OR POSITION SWITCH	
(#)	QUADRAPLEX RECEPTACLE, RECESSED CEILING MOUNTED		SECURITY CAMERA	்	EMERGENCY STOP PUSH BUTTON (MAINTAINED)	<u> </u>
₽	ISOLATED GROUND TYPE DUPLEX RECEPTACLE	(SP)	SPEAKER	مله	NORMALLY CLOSED PUSH BUTTON	
T	SPECIAL PURPOSE OR WELDING OUTLET.	\circ	ANTENNA MAST		LOCKOUT STOP PUSH BUTTON	
∯ GFCI	GROUND FAULT CIRCUIT INTERRUPTER RECEPTACLE.	Ю	CABLE TV OUTLET			····
∯ WP	WEATHERPROOF CONVENIENCE OUTLET	PS	MANUAL PULL STATION MOUNTED AT 48" A.F.F.		NORMALLY OPEN PUSH BUTTON CONTACT - TIME DELAY	
	WIREMOLD		HORN	JL	T.C. = NORMALLY OPEN WITIME DELAY CLOSING. I.C T.O. = NORMALLY OPEN WITH INSTANT CLOSING AND	<u></u>
#	FLUSH FLOOR DEVICE BOX)	HORN/STROBE W/ MINI HORN	طِهُ T.c.	TIME DELAY OPENING. T.CT.O. = NORMALLY OPEN WITIME DELAY CLOSING AND	
-	HOME RUN TO PANEL - INDICATING 2 #12, #12 GND, 3/4" CONDUIT OR AS SHOWN.	Ø	STROBE ONLY		TIME DELAY OPENING AFTER DEENERGIZATION.	<u> </u>
#	HOME RUN TO PANEL - INDICATING NUMBER OF CONDUCTORS - #12 OR AS SHOWN.	X (HORN/STROBE		CONTACT - TIME DELAY T.C. = NORMALLY CLOSED WITH TIME DELAY OPENING.	
X-1,3,5	HOME RUN TO PANEL SHOWING BRANCH CIRCUIT NUMBERS.	£	BELL	₩ _{т.o.}	T.C. = NORMALLY CLOSED WITH TIME DELAY OPENING. T.OT.C. = NORMALLY CLOSED WITH TIME DELAY OPENING AND TIME DELAY CLOSING AFTER DEPARESIZATION.	\square
X-1,0,0	HATCH MARKS IN CONDUIT RUN DENOTES NUMBER OF CONDUCTORS IN CONDUIT. LONG HATCH MARK DENOTES GROUND CONDUCTOR. SIZE OF CONDUCTORS TO BE #12 AWG CONDUCTORS IN CONDUIT	(5)	SMOKE DETECTOR		1.OT.C. = NORMALLY CLOSED WITH INSTANT OPENING AND TIME DELAY CLOSING.	•
-#-	SIZE OF CONDUCTORS TO BE #12 AWG CONDUCTORS IN CONDUIT UNLESS NOTED OTHERWISE. UNMARKED CONDUITS SHALL BE 3/4"			41-	NORMALLY OPEN CONTACT	
	WITH 3 #12.	1	HEAT DETECTOR	\f\{\psi\}	NORMALLY CLOSED CONTACT	∇
<u> </u>	CONDUIT SEALOFF	D5	DUCT SMOKE DETECTOR	∞√°	иміт эмтсн	
(E)	DENOTES EXISTING EQUIPMENT OR DEVICES	ARB	AUXILIARY RELAY	ಿಕ	PRESSURE SWITCH LOW	¥
(T)	THERMOSTAT	R	AUXILIARY RELAY CONNECT TO FAN STOP CIRCUIT/ DOOR HOLDERS/DAMPER MOTOR AS APPLICABLE.	° ব্র'	PRESSURE SWITCH HIGH	
x M	MOTOR, X = HORSE POWER	(cr	VOICE COMMUNICATION PANEL	~F°	FLOW SWITCH	
F	CEILING EXHAUST FAN	r	ELECTRIC SHUTOFF	्र	LEVEL FLOAT SWITCH	
	ROOFTOP EXHAUST FAN	8	SMOKE/PRESSURIZATION CONTROL	°	TEMPERATURE SWITCH	
J	JUNCTION BOX		CONTROL PANEL	6.	DISCONNECT SWITCH SHOWN WITH RATING AND NUMBER OF POLES.	
<u> </u>	GROUND ROD WITH TEST WELL AS INDICATED	DH	DOOR HOLD-OPEN DEVICE	AMP5 / POLES		
=	ELECTRICAL PANEL, POWER OR LIGHTING	ММ	ADDRESSABLE RELAY MONITORING MODULE	POLES	CIRCUIT BREAKER OR MOTOR CIRCUIT PROTECTOR, SHOWN WITH TRIP RATING AND NUMBER OF POLES.	
A	METER BASE	fs	SPRINKLER FLOW SWITCH	ه محمد ه	FUSEHOLDER OR FUSEBLOCK	
×	COMBINATION MOTOR STARTER, SEE SPECS	Ts	SPRINKLER TAMPER SWITCH	H,O A	3 POSITION SELECTOR SWITCH HAND - OFF - AUTO,	
1	DISCONNECT SWITCH.	FAC	COMMUNICATOR	oox oox	POSITION LEGEND: X=CLOSED O=OPEN	
	VOLTAGE RATING	FTR	TRANSPONDER OR TRANSMITTER	ON OFF		
	NEMA ENCLOSURE FUSE (NF-NO FUSE)	F5A	FIRE SYSTEM ANNUNCIATOR		2 POSITION SELECTOR SWITCH, POSITION LEGEND: X=CLOSED O=OPEN	
	POLES SIZE (AMPS)	(AE)	ANALYZER ELEMENT	° VICTO	TIMER RELAY CONTACT INSTANTANEOUS CLOSE TIME DELAY OPEN.	
	THIS NOTATION ADJACENT TO WALL OUTLET SYMBOL DENOTES	AT		V ICTO → NOTC	TIMER RELAY CONTACT NORMALLY OPEN TIME DELAY CLOSE.	
+0'-0"	MOUNTING HEIGHT ABOVE FINISHED FLOOR TO CENTER OF OUTLET DEVICE. IF NOT NOTED, THE MOUNTING HEIGHT TO CENTER SHALL BE		ANALYZING INDICATING TRANSMITTER		FULL VOLTAGE NONREVERSING (FVNR) MOTOR STARTER OR CONTACTOR NUMBER DESIGNATES NEMA SIZE.	
	AS DETAILED OR SPECIFIED.	(Œ)	CONDUCTIVITY ELEMENT	$=_{5}$	CONTACTOR NUMBER DESIGNATES NEMA SIZE. RTU, PLC, OR RIO CONTACT	
\$ _M	MANUAL MOTOR STARTER	CGD	COMBUSTIBLE GAS DETECTOR			
\$ _T	MANUAL MOTOR STARTER WITH OVERLOADS	СП	CONDUCTIVITY INDICATING TRANSMITTER		UTILITY METER BEACON ALARM LIGHT. LETTER INDICATES COLOR: R=RED,	TAG
HT	HEAT TRACING	FE	FLOW ELEMENT		A=AMBER, B=BLUE, G=GREEN PILOT LIGHT. LETTER INDICATES COLOR: R=RED, A=AMBER,	CXXX
R	RELAY	PIT	FLOW INDICATING TRANSMITTER		B=BLUE, G=GREEN	PXXX
K	KIRK KEY INTERLOCK	(FS)	FLOW SWITCH		RELAY	
DM	DAMPER MOTOR	(LE)	LEVEL ELEMENT	<u> </u>	TIME DELAY RELAY	
F#	LIGHTING FIXTURE TYPE - SEE FIXTURE SCHEDULE.	(IT)	LEVEL INDICATING TRANSMITTER		ALARM RELAY	
\$	SINGLE POLE SWITCH	(15)	LEVEL SWITCH	ETM (ETM)	ELAPSED TIME METER	
\$3	3 WAY SWITCH	LT)	LEVEL TRANSMITTER	<u> </u>	MOTOR STARTER OR CONTACTOR COIL	
\$4	4 WAY 5WITCH	ME	MOISTURE ELEMENT	EOL	ELECTRONIC OVERLOAD RELAY	
오	WALL MOUNTED MOTION SENSOR	MV	MOTOR OPERATED VALVE OR GATE		SOLID STATE REDUCED VOLTAGE STARTER	
<u>(©)</u>	CEILING MOUNTED MOTION SENSOR	05	OVER TORQUE SWITCH	VFD	VARIABLE FREQUENCY DRIVE	
PC	PHOTOCELL	PB	PUSH BUTTON	HF	HARMONIC FILTER	
#	ETHERNET OUTLET, NUMBER INDICATES NUMBER OF JACKS.	PIT	PRESSURE INDICATING TRANSMITTER			
<u> </u>	ETHERNET OUTLET, RECESSED FLOOR MOUNTED	P5	PRESSURE SWITCH		CURRENT TRANSFORMER	
(🕏)	ETHERNET OUTLET, RECESSED CEILING MOUNTED	PT		——————————————————————————————————————		
#	TELEPHONE OUTLET, NUMBER INDICATES NUMBER OF JACKS.		PRESSURE TRANSMITTER SPEED SWITCH		THERMAL OVERLOAD RELAY	
		(55)	Jane Sauloi		1	

DC SYSTEM SIZING CRITERIA						
VOLTAGE: 12 VDC						
BATTERY BACKUP TIME: 24 HOURS						
RE-CHARGE TIME: 12 HOURS WHILE RUNNING UNDER LOAD						
LOCATION: LATITUDE: 41.	297534 LONGIT	TUDE: 111.666678				
OPERATION: YEARLY MAY 3	I TO SEPTEMBER	I				
LOAD	WATTS	HOURS RUN/24 HOURS				
FLOW METER/DISPLAY	0.25	24				
VALVE ACTUATOR 25 0.5						
VALVE ACTUATOR	25	0.5				
VALVE ACTUATOR DOSING PUMP	25 19	8				

CONDUIT CALLOUT

GROUPED CONDUIT AND CIRCUIT IDENTIFICATION TAGS. REFER
TO THE ONE-LINE DIAGRAM, POWER AND CONTROL CONDUIT SCHEDULES
FOR CONDUIT SIZES AND CONTENTS:
C-CONTROL/INSTRUMENTATION P-POWER

DESCRIPTION MC CONNECTION

NODE OR CONNECTION

TRANSFORMER HEATING ELEMENT LINE REACTOR GROUND CONNECTION BOND TO METALLIC WATER PIPE BOND TO METALLIC WATER PIPE BOND TO BUILDING STEEL

EXPOSED CONDUIT UNDERGROUND CONDUIT BARE COPPER GROUND CONDUCTOR EXISTING EXPOSED CONDUIT EXISTING UNDERGROUND CONDUIT CAPPED UNDERGROUND CONDUIT OR STUBBUP

NEW ELECTRICAL EQUIPMENT

CONDUIT DROP CONDUIT RISE DEMOLITION

DETAIL VIEW, MATCHING, OR PACKAGED EQUIPMENT.

DEVICE LOCATED AT REMOTE LOCATION.

TERMINAL LUG, STRIP, OR POWER DISTRIBUTION BLOCK

SCADA NETWORK DATA DROP 4-11/16" OUTLET BOX W/ 1 GANG RING AND ONE CAT. 5e JACK. CAT. 5e PLENUM CABLE TO SCADA PATCH PANEL. TERMINATE AND TEST. RUN IN 3/4" CONDUIT.

OFFICE NETWORK DATA DROP. 4-11/16" OUTLET BOX W/ 1 GANG RING AND ONE CAT. 6 JACK. CAT. 6 PLENUM TO OFFICE NETWORK PATCH PANEL. TERMINATE AND TEST. RUN IN 3/4" CONDUIT.

VOICE DROP. 4-11/16' OUTLET BO W/ I GANG RING ONE CAT. 3 VOICE JACK. CAT. 3 PLENUM. TERMINATE AND TEST. RUN IN 3/4" CONDUIT.

ELECTRICAL LINETYPES

						_
				DRAWN	N.D. JOHNSON	
				DEGIGNED	N.E. 1011110011	1
				DESIGNED	N.E. JOHNSON	[
NO.	REVISIONS	BY	DATE	APPROVED	N.E. JOHNSON	Г
This document or any part thereof in detail or design						Ι'
conce	document or any part thereof in det ept is the property of Forsgren Asso not be copied without the written au	Inc. and ation of	ΟΔ	R CLARK		

ATTENTION
LINE IS 2 INCHES



Project for:

THE CHURCH OF **JESUS CHRIST** OF LATTER-DAY SAINTS





COBBLE CREEK RCMP

05-14-0086 SHEET NO:

ELECTRICAL SYMBOL LEGEND

E-001 DATE: PAGE NO: MAR. 2015 11 OF 16



L							
L					DRAWN	N.D. JOHNSON	
L							Λ
					DESIGNED	N.E. JOHNSON	,
							<u> </u>
	NO.	REVISIONS	BY	DATE	APPROVED	N.E. JOHNSON	aF
Г	This	document or any part thereof in det	ail or d	esign	ATTROVEL	11121 001110011	(11-
	conc shall	document or any part thereof in det ept is the property of Forsgren Asso not be copied without the written au	04	R CLARK			

ATTENTION
LINE IS 2 INCHES
AT FULL SIZE
(IF NOT 2*- SCALE ACCORDINGLY)

328126 NOLAN E. JOHNSON

Project for: THE CHURCH OF JESUS CHRIST OF LATTER-DAY SAINTS



	/////// HEATH	
2	Engineering Company Machanical/Electrical/Plumbing Consultants	
Ĭ	27 Maring in	

COBBLE CREEK RCMP

SHEET NO:
E-100
DATE: PAGE NO: **ELECTRICAL SITE PLAN**

MAR. 2015 12 OF 16

PROJECT NO: **05-14-0086**

igg(2igg) Solar panel feed. See control cabinet diagram.

(3) NEW SOLAR CABINET.

CORE DRILL WALL. RISE TO ROOF WITH L.B. TERMINATE WITH WEATHERHEAD. WHIP TO SOLAR PANEL.

5 D.C. DISCONNECT.


6 NEW CONTROL CABINET.

CORE DRILL WALL. SILICONE SEAL AROUND CONDUIT.
DROP TO GROUND WITH L.B.

8 2° CONDUIT WITH 8-#10, 1-FLOW METER CABLE, TO VALVE ACTUATOR, SEE SITE PLAN.


9 DOSING PUMP LMI MODEL J54D MOUNTED ON WALL.

5 SEAMETRICS FT-420 METER DISPLAY.

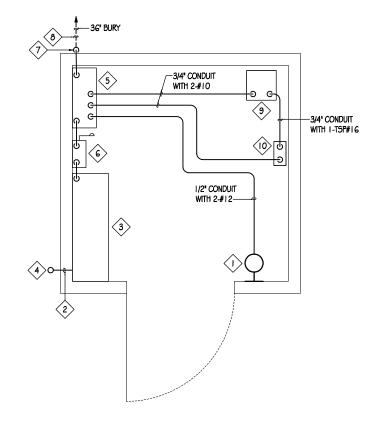

DISINFECTION BUILDING POWER PLAN

1 0 2 4

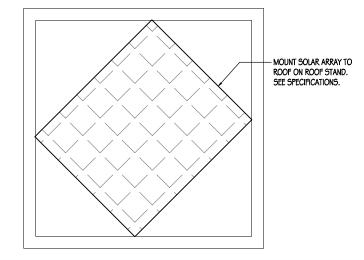


DISINFECTION BUILDING ROOF POWER PLAN

5CALE: 3/4"=1"-0"

				DRAWN	ND	JOHNSON	
				DRAWIN	N.D	JUNIOUN	ı
							ı
				DESIGNED	N.E. ,	JOHNSON	١.
							١.
NO.	REVISIONS	BY	DATE		N.E.	IOHNSON	ľ
This o	document or any part thereof in deta ept is the property of Forsgren Asso not be copied without the written au aren Associates inc.	ail or d	esign	74 1 10 12			1
CONCE	ept is the property of Forsgren Asso	clates	Inc. and				ı
snali Eomo	not be copied without the written au	itnoriza	ation of	QA		R. CLARK	

ATTENTION
LINE IS 2 INCHES
AT FULL SIZE
(IF NOT 2"- SCALE ACCORDINGLY)

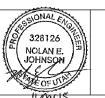

Project for:

THE CHURCH OF
JESUS CHRIST
OF LATTER-DAY SAINTS





COBBLE CREEK RCMP


DISINFECTION BUILDING ELECTRICAL PLANS

PROJECT NO: 05-14-0086 SHEET NO: E-101

DATE: PAGE NO: MAR. 2015 13 OF 16

3 ELECTRICAL CONDUIT TO FOLLOW PIPELINE ROUTE TO PUMP HOUSE.

4 SEE SITE PLAN FOR CONDUIT CALLOUT

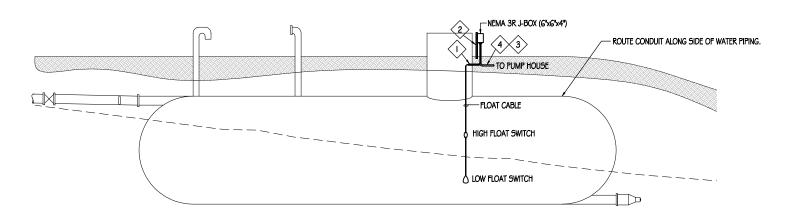

TANK ELEVATION

1					
				DRAWN	N.D. JOHNSON
				DESIGNED	N.E. JOHNSON
NO.	REVISIONS	BY	DATE		
				APPROVED	N.E. JOHNSON
shall Forse	document or any part thereof in det ept is the property of Forsgren Asso not be copied without the written at aren Associates inc.	QA	R. CLARK		

ATTENTION
LINE IS 2 INCHES
AT FULL SIZE
(IF NOT 2"- SCALE ACCORDINGLY)

328126 NOLAN E. JOHNSON

THE CHURCH OF JESUS CHRIST

OF LATTER-DAY SAINTS

Project for:






COBBLE CREEK RCMP

ELECTRICAL TANK ELEVATION

PROJECT NO: **05-14-0086** SHEET NO: **E-201**

DATE: PAGE NO: MAR. 2015 14 OF 16

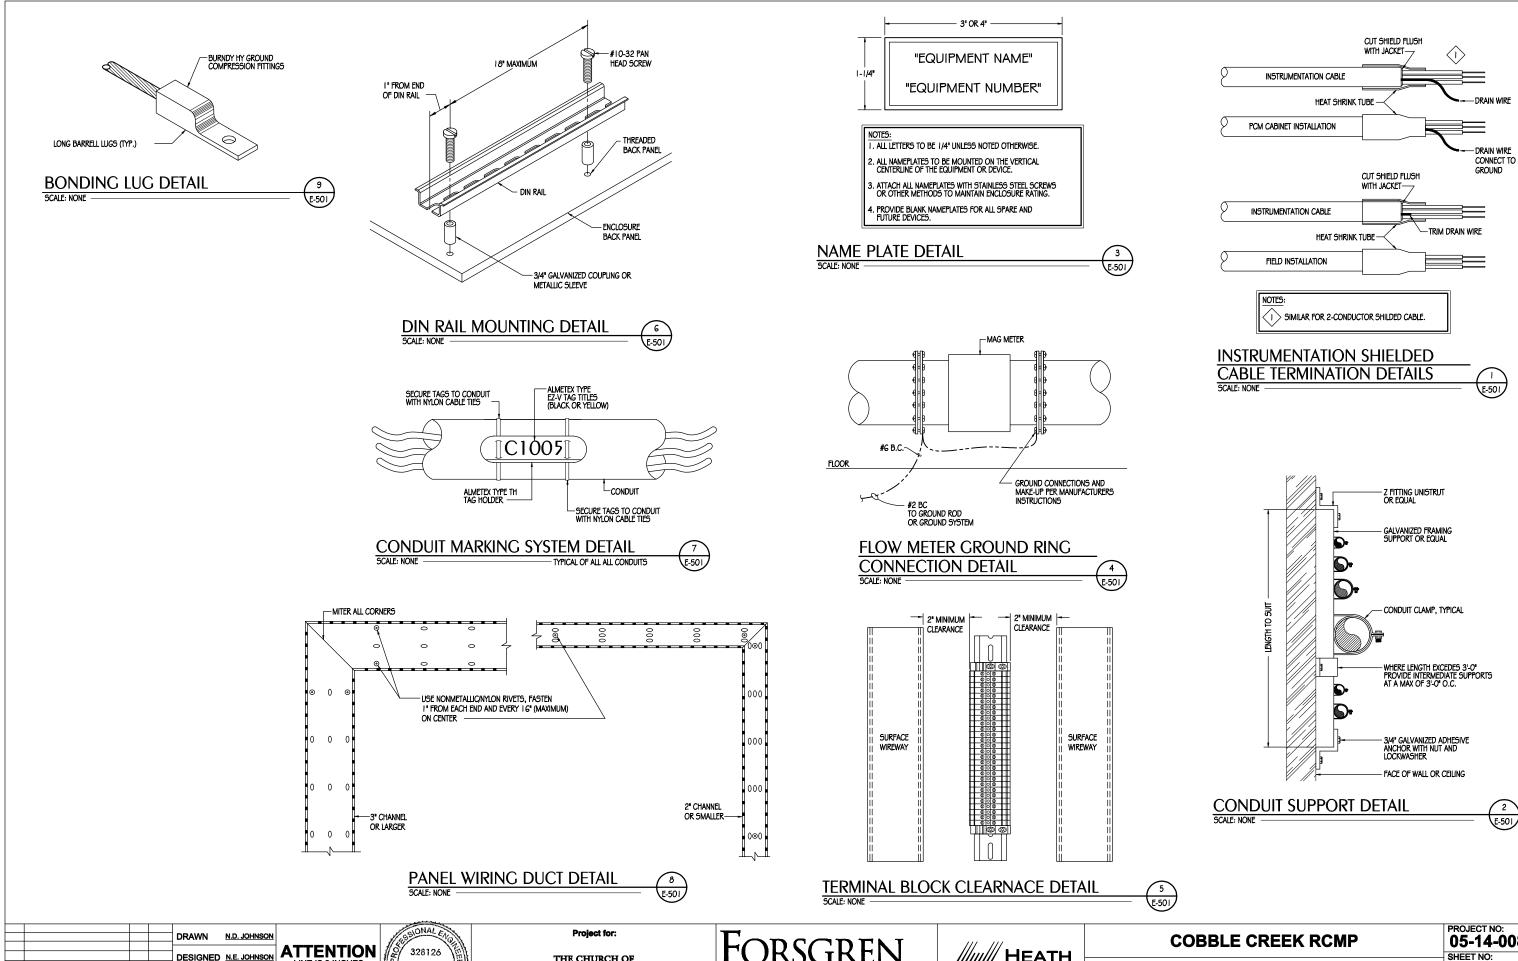

REVISIONS BY DATE APPROVED N.E. JOHNSON This document or any part thereof in detail or design concept is the property of Forsgren Associates Inc. and shall not be copied without the written authorization of Forsgren Associates

ATTENTION
LINE IS 2 INCHES

328126 NOLAN E. JOHNSON

THE CHURCH OF **IESUS CHRIST** OF LATTER-DAY SAINTS






05-14-0086 SHEET NO: E-501


ELECTRICAL DETAILS

DATE: PAGE NO: MAR. 2015 15 OF 16

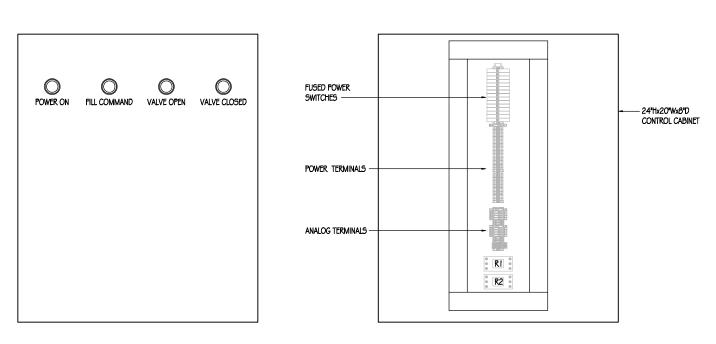



CONTROL CABINET BACK PANEL LAYOUT

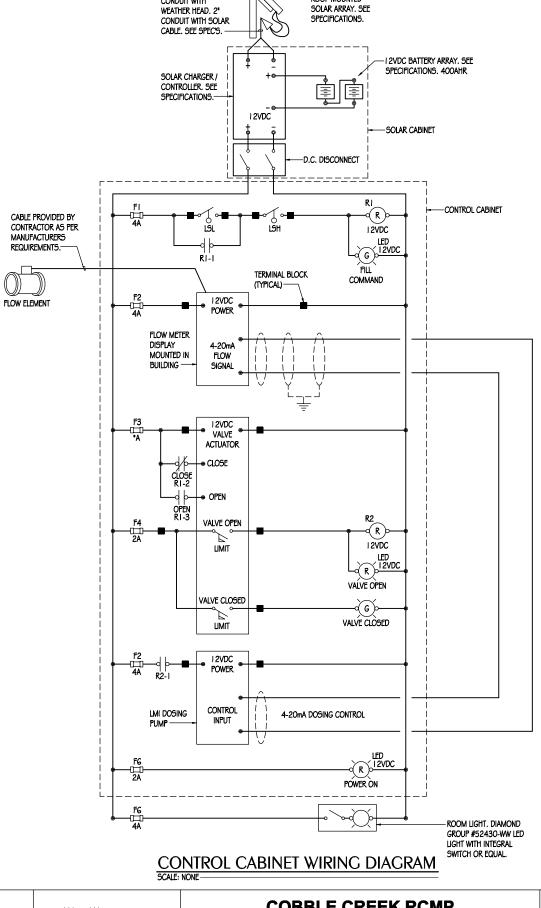


CONDUIT WITH WEATHER HEAD. 2"

ROOF MOUNTED

DRAWN N.D. JOHNSON DESIGNED N.E. JOHNSON REVISIONS BY DATE APPROVED N.E. JOHNSON This document or any part thereof in detail or design concept is the property of Forsgren Associates Inc. and shall not be copied without the written authorization of Forsgren Associates Inc.

ATTENTION
LINE IS 2 INCHES

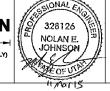

Project for:

THE CHURCH OF **IESUS CHRIST** OF LATTER-DAY SAINTS





COBBLE CREEK RCMP

SHEET NO: E-601 **ELECTRICAL DIAGRAMS** DATE:

MAR. 2015 16 OF 16

PROJECT NO:

05-14-0086

PAGE NO: