

## Staff Report to the Ogden Valley Planning Commission

Weber County Planning Division

## **Synopsis**

**Application Information** 

Application Request: Request for approval of a conditional use permit for Reuse Pump Station located at 4350 N

4450 E. Eden, UT 84310.

**Application Type:** Administrative File Number: CUP 2024-01

**Applicant:** Rob Thomas-Authorized Representative

Agenda Date: Tuesday, March 23, 2024

Approximate Address: 4350 N E 4450 E., Eden UT 84310

**Project Area:** 21.24 Acres

**Zoning:** FV-3

Existing Land Use: Sewer Improvement
Proposed Land Use: Sewer Improvement

Parcel ID: 22-006-0014

22-006-0015 22-006-0016

Township, Range, Section: Township 7 North, Range 1 East, Section 16

**Adjacent Land Use** 

North:VacantSouth:Vacant RE-20East:ResidentialWest:Vacant

**Staff Information** 

**Report Presenter:** Marta Borchert

mborchert@webercountyutah.gov

801-399-8761

Report Reviewer FL

#### **Applicable Ordinances**

- Weber County Land Use Code Title 104 Chapter 14 (FV-3 Zone)
- Weber County Land Use Code Title 108 Chapter 4 (Conditional Uses)
- Weber County Land Use Code Title 108 Chapter 10 (Public Utility Substations)
- Weber County Land Use Code Title 108 Chapter 2 (Ogden Valley Architectural, Landscape, and Screening Standards)
- Weber County Land Use Code Title 108 Chapter 1 (Design Review)

#### **Background and Summary**

The applicant is requesting approval of a conditional use permit for the installation of a Reuse Pump Station a "public utility substation" Located at The proposed pump station will move treated effluent from the treatment plant through a new pipeline to a new reuse pond. The FV-3 Zone allows a "public utility substation" as a conditional use. The proposal has demonstrated that the operation will comply with the applicable regulations, with reasonable conditions imposed.

The application is being processed as an administrative review due to the approval procedures in Uniform Land Use Code of Weber County, Utah (LUC) §108-1-2 which requires the planning commission to review and approve applications for conditional use permits and design reviews.

## **Analysis**

<u>General Plan:</u> As a conditional use, this operation is allowed in the FV-3 Zone. With the establishment of appropriate conditions as determined by the Planning Commission, this operation will not negatively impact any of the goals and policies of the General Plan.

<u>Zoning:</u> The subject property is located within the Forest Residential (FR-3) Zone. The purpose of the FR-3 Zone can be further described in LUC §104-17-1 as follows:

The purpose of the Forest Valley Zone, FV-3 is to provide area for residential development in a forest setting at a low density, as well as to protect as much as possible the naturalistic environment of the development.

The following setbacks apply for this public utility substation within the FV-3 zone:

-Front: 10 feet -Side: 20 feet -Rear: 20 feet

<u>Conditional Use Review:</u> A review process has been outlined in LUC §108-4-3 to ensure compliance with the applicable ordinances and to mitigate anticipated detrimental effects. Thus far, the applicant has received approval from the County Engineering Division, for the proposal.

The following is an analysis of the proposal reviewed against the conditional use standards:

- (1) Standards relating to safety for persons and property. The proposal is not anticipated or expected to negatively impact this property, surrounding properties, or persons.
- (2) Standards relating to infrastructure, amenities, and services: The proposal is part of the infrastructure related to adjacent development, and is not anticipated or expected to negatively impact any existing infrastructure, amenities, or services in the area.
- (3) Standards relating to the environment. The proposal is not anticipated or expected to negatively impact the environment.
- (4) Standards relating to the current qualities and characteristics of the surrounding area and compliance with the intent of the general plan. The property on which the conditional use permit is sought will support future residential development. The proposal complies with and supports the intent of the general plan.

<u>Design Review</u>: The FV-3 zone and the proposed conditional use mandate a design review as outlined in LUC §108-1 to ensure that the general design, layout and appearance of the building remains orderly and harmonious with the surrounding neighborhood. The submitted plans are, including exterior finishes, similar to existing infrastructure within this development. As part of this review, the Planning Commission shall consider the applicable matters based on the proposed conditional use and impose conditions to mitigate deficiencies where the plan is found deficient. The matters for consideration related to this project are as follows:

**Considerations relating to traffic safety and traffic congestion.** The proposal includes a site plan that identifies the location of the proposed reuse pond and associated buildings. The access road leading to the site is far removed from public roads, therefore traffic congestion and traffic safety issues will not occur. As a means of preventing service vehicles from creating a congestion issue, the planning staff have added a condition that no parking is permitted within the public ROW's.

All vehicles going to and from the site will be relegated to the designated route of Wolf Creek Drive and Fairways Drive.

**Considerations relating to landscaping.** The applicant has indicated that the landscaping of this site will be consistent with the overall landscaping plan will be consistent with the surroundings.

**Considerations relating to buildings and site layout**. The existing buildings meet the site development standards of the FV-3 Zone.

**Considerations relating to utility easements, drainage, and other engineering questions.** The A preliminary review from the County Engineering Dapartment in complete. The County Engineering Department may have further requirements that will need to be addressed before the planning division will issue a conditional use permit.

## **Staff Recommendation**

Staff recommends approval of this conditional use application subject to the applicant meeting the conditions of approval in this staff report and any other conditions required by the Planning Commission. This recommendation is subject to all review agency requirements and is based on the following condition:


- 1. Wolf Creek Water and Sewer Improvement District service vehicles and hauling vehicles shall not park within the public ROW
- 2. Dust control measures shall be taken.
- 3. Trucks hauling material shall obey the speed limit
- 4. Dirt tracked onto the public street shall be cleared immediately and kept clear of dirt gravel and rocks.
- 5. All requirements from the County Engineering Department will be satisfied before the issuance of the conditional use permit.
- 6. Construction activity is limited to weekdays from 7:00 am to 5:00 pm.

This recommendation is based on the following findings:

- The proposed use is allowed in the FR-3 Zone and meets the appropriate site development standards.
- The criteria for issuance of a conditional use permit have been met because mitigation of potential detrimental effects can be accomplished.

## **Exhibits**

- A. Project Narrative
- B. Site Plan
- C. Photos of Reuse pond and pump station

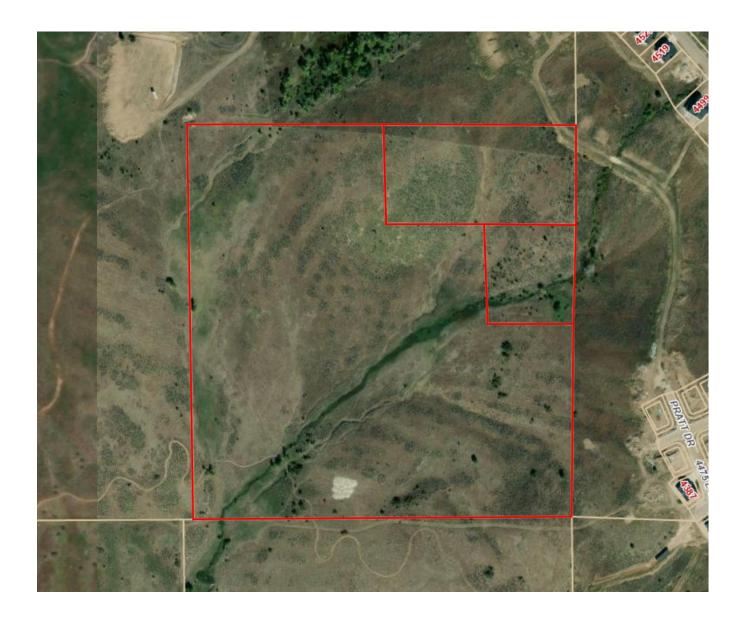

WCWSID Reuse pond and pump station

**Project narrative:** It is proposed to construct a reservoir with a volume of approximately 45 acrefeet and install a packaged pump station at the toe of the dam as a conditional use under Weber County Ordinance 104-2-3(h) - Utility Stations. The proposed reservoir will store reuse water from the Wolf Creek Water and Sewer Improvement District (WCWSID) treatment plant, and the pump station will move water from that reservoir to the Wolf Creek Golf Course for irrigation.

Reasonably anticipated detrimental effects of a proposed conditional use can be substantially mitigated by the proposal or by the imposition of reasonable conditions to achieve compliance with applicable standards. Examples of potential negative impacts are odor, vibration, light, dust, smoke, or noise: Note that the proposed pump station will be placed approximately concurrently with the construction of the mentioned reservoir. The pump station placement will have negligible impacts relative to the construction of the reservoir and the two components will be considered a single and complete project. The statements below refer to the construction of the pump station and reservoir installation.

Possible detrimental effects include:

Construction traffic during an anticipated construction period less than 6 months.

Construction activities associated with the pump station will be typical of what might be experienced during construction of a new accessory building on a residential lot: Underground electricity, water pipelines, a new concrete pad on which to place the pump station, site grading and a new access road (the road providing access to the proposed pump station will be constructed as part of the reservoir project and a small turnout/parking area for the proposed pump station will be constructed as part of the reservoir maintenance/access road). Construction of the earthen reservoir will require large equipment that will utilize material on site to build the pond. Adherence to standard County requirements for site construction (SWPPP, dust control, etc.) will be required of the contractor to mitigate impacts due to construction activities.

Long-term operation impacts:

It is anticipated that operation and maintenance of the proposed pump station and reservoir will have negligible impact on the traffic pattern of the surrounding area. The proposed pump station would generate one daily trip by operators. The pumps will be enclosed to reduced sound impacts, have no lighting and access will be made on a maintained gravel roadway around the associated reservoir.

Since the project deals with movement of treated effluent (post plant: clean water), there will be no odor impact.


That the proposed use will comply with the regulations and conditions specified in the Zoning Ordinance and other applicable agency standards for such use:

The proposed use will be on property zoned AV-3. Property north, east, and west of the parcel on which this pump station and pond will be located is zoned RE-15. Property south of the parcel on which this pump station and pond will be located is zoned RE-20. The pump station and pond will be well away from property lines. Applicant commits to comply with the regulations and conditions specified in the Zoning Ordinance and other applicable agency standards for such use in the AV-3 zone.

R:\2319 - Wolf Creek Water and Sewer\2302 - Reuse Pipeline\DOCUMENTS\CUP\WCWSID Reuse pond and pump station application narrative.docx

## Exhibit B - Site Plan



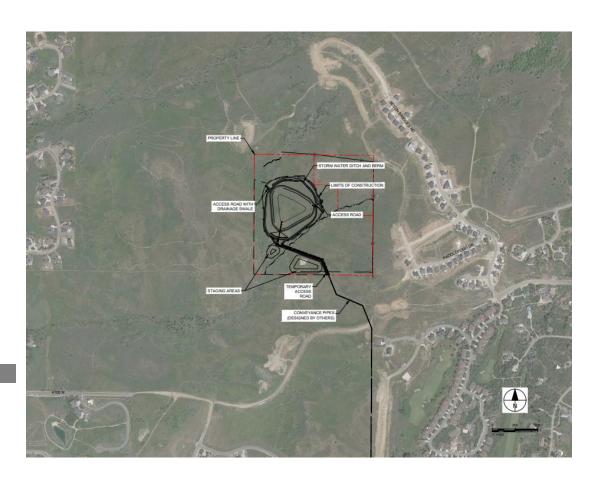


# REUSE PROJECT

# SCHEDULE C UPPER PUMP STATION **VICINITY MAP**

WOLF CREEK WATER AND SEWER IMPROVEMENT DISTRICT - WEBER, UTAH

**LOCATION MAP** 

JANUARY 2024

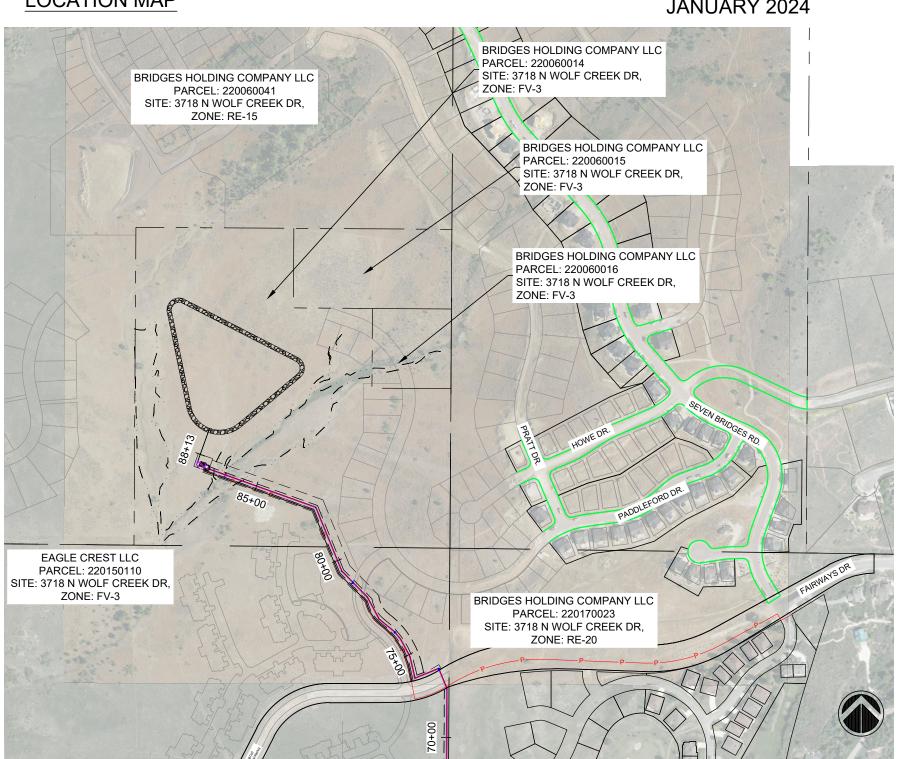

## SHEET INDEX:

CIVIL UPS1 UPS2

**COVER SHEET** OVERVIEW

SITE PLAN UPS3

PUMP STATION DETAILS PUMP STATION DETAILS UPP2 UPP3 PUMP STATION DETAILS


ELECTRICAL


ENGINEER: GARDNER ENGINEERING 1580 S 2100 W WEST HAVEN, UTAH 84401 801-476-0202

## PREPARED FOR:

WOLF CREEK WATER AND SEWER IMPROVEMENT DISTRICT

UPS1

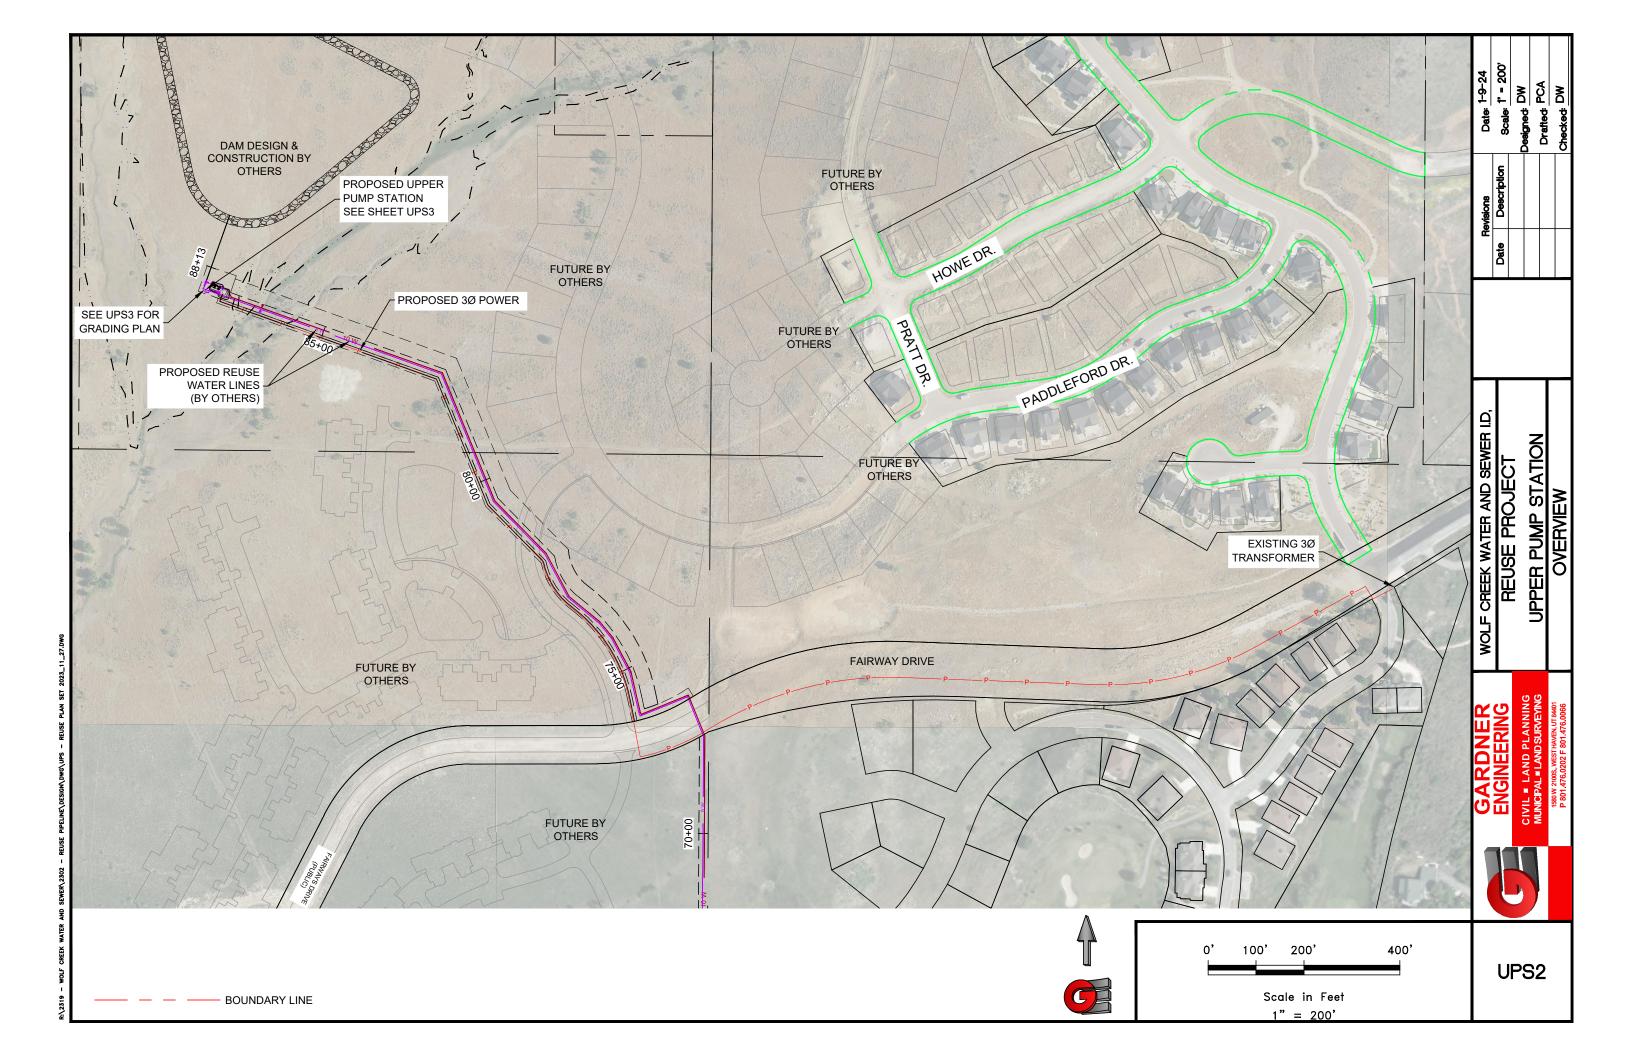

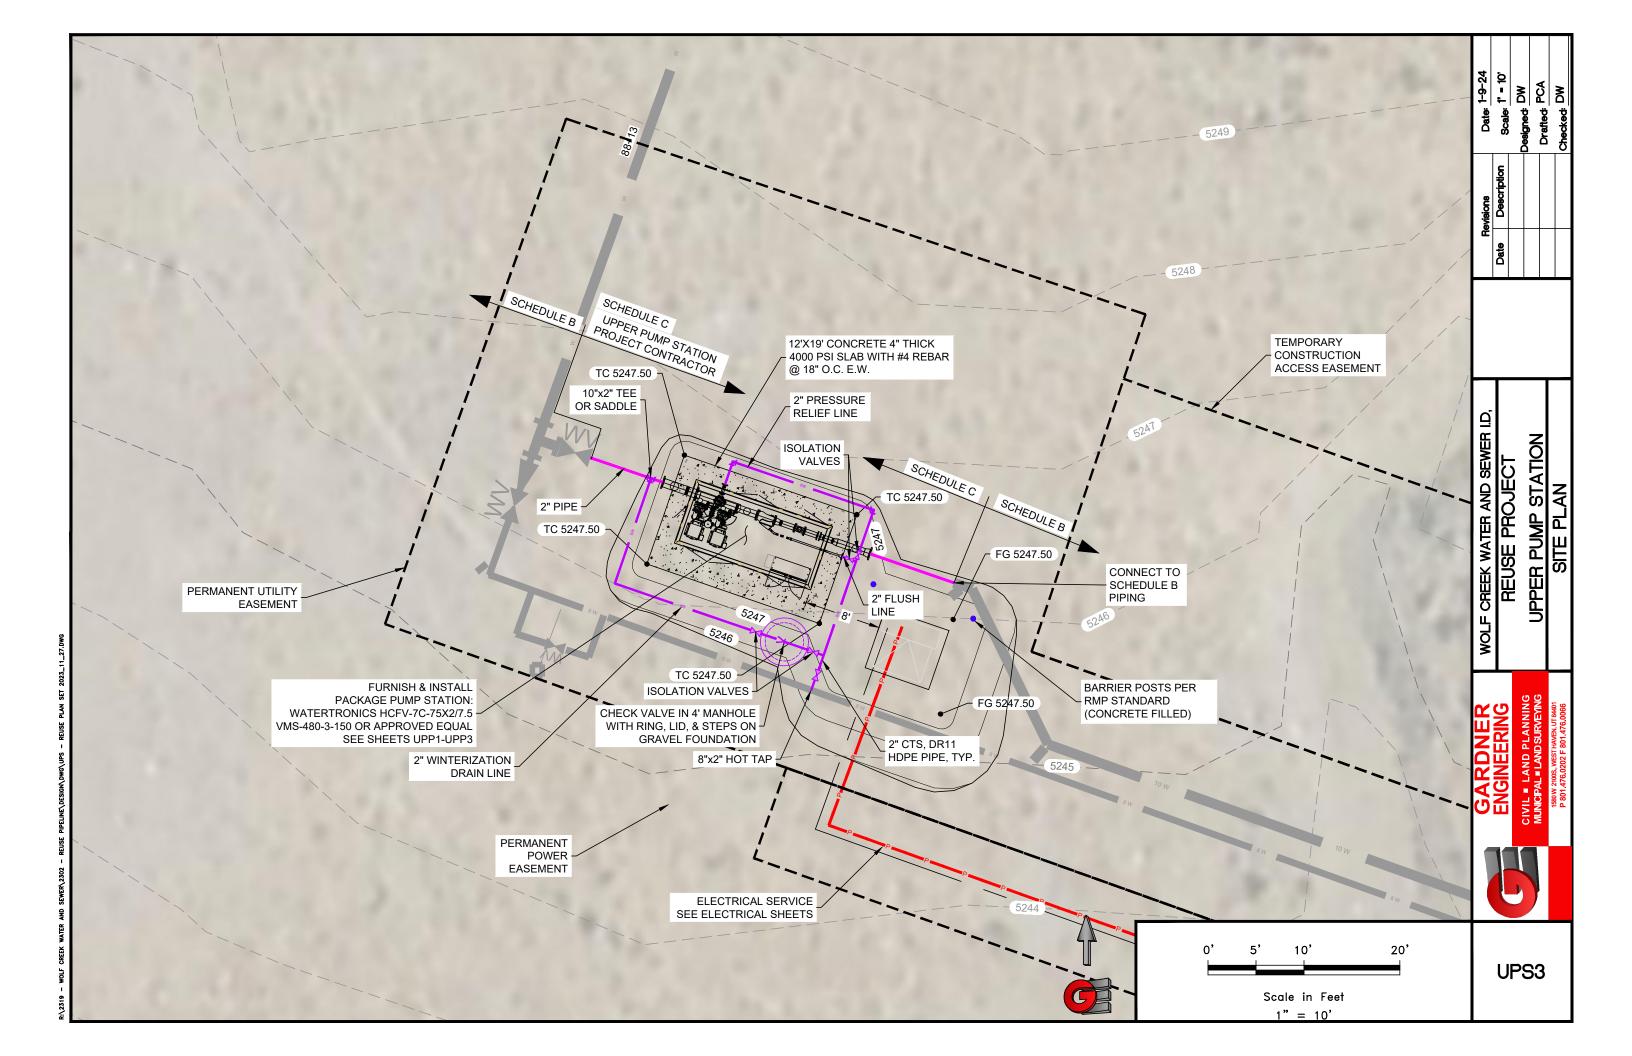

PUMP HORSEPOWER: SUSTAIN PUMP: 7.5HP PUMP NO.1-2: 75 HP CHECK VALVE SIZE SUSTAIN: 2" PUMP NO.1-2: 5" ISOLATION VALVE SIZES: SUSTAIN PUMP: 5" PUMP NO.1-2: 5"

DISCHARGE ISOLATION VALVE: 6"
RELIEF VALVE SIZE: 3"
PUMP STATION DISCONNECT: 400 AMP

POWER REQUIREMENTS: 480V, 60 HZ, 3 PH, 198 FLA

EXHAUST FAN REQ'D FOR BUILDING: 2550 CFM

INTAKE/SUCTION CONNECTION: 10" FL	INITIAL DW	DATE 1/9/24
DISCHARGE CONNECTION: 10" FL	DW	1/9/24
NOMINAL PIPE SIZE:		
DROP PIPE COVER: 60"	DW	1/9/24
PLEASE VERIFY ALL INFO WITH YOUR INITIALS AND DATE		

Pump station shall be provided with the following options per Watertronics quote Wolf Creek GC HC BoosterUT\_230804Q1 (See quote for full station purchase specs)

230-000004 Filter VAF-V1000 - 8" Flange, 1200 GPM, 300 Micron

900-000001 Composite Station Enclosure 120 x 96 Inches

910-0000008 Ship Loose Disconnect 400A Fused NEMA 3R

#### PLEASE USE THE SPACE BELOW FOR ANY ADDITIONAL COMMENTS:

Purchasing/installing contractor shall be entirely responsible for electrical and hydraulic connections, a fully and properly functioning pump station and providing 1 full year of communications, which contract(s) shall be assumable, transferable and renewable by the Owner, at the Owner's discretion.

<b>✓</b> APPROVED	AS SUBMITTED
APPROVED	AS NOTED
REVISE AND	RESUBMIT
REVIEWED BY:	
NAME:	an Will PPROVED

DIMENSIONS AND SIZES OF EXISTING STRUCTURES, AND/OR COMPONENTS MUST BE VERIFIED TO WATERTRONICS BEFORE STATION CONSTRUCTION BEGINS.

UNLESS SPECIFIED BY THE CUSTOMER, PUMP HOUSE/CONCRETE SLAB DIMENSIONS ARE RECOMMENDED MINIMUMS FOR NEC AND SERVICE CLEARANCE, AND ARE FOR ILLUSTRATION PURPOSES ONLY. PROJECT MANAGER SHALL BE CONSULTED ON FINAL DESIGN.


THE PUMP STATION PROPOSED HEREIN IS DESIGNED TO BE PLACED IN A PUMP HOUSE FOR PROTECTION FROM THE ENVIRONMENT. IF A PUMP HOUSE IS NOT USED, WATERTRONICS MUST BE NOTIFIED AT TIME OF QUOTATION SO SPECIAL PROVISIONS CAN BE MADE.

<b>SWATERTRONICS</b>						
PHONE: 1-262-367-5000 FAX: 1-262-367-5551						
SHEET 1 OF	3 SHEETS					
DRAWING NO.	PRHC11102 R1	8/4/2023 1/9/2024				

Date: 1-9-24	Scale: ######	WO	Cealgred	•	Drefted: TCA		Checked: DW
Revisions	Description						
	Date						
WOLF CREEK WATER AND SEWER I.D,							
GARDNER	ENGINEERING		CIVIL   LAND PLANNING	MINICIPAL I I AND SURVEYING		1580 W 2100S., WEST HAVEN, UT 84401	P 801 476 0202 F 801 476 0066

UPP1

2319 – WOLF CREEK WATER AND SEWER\2302 – REUSE PIPELINE\DESIGN\DWG\UPS – REUSE PLAN SET 2023\_11\_

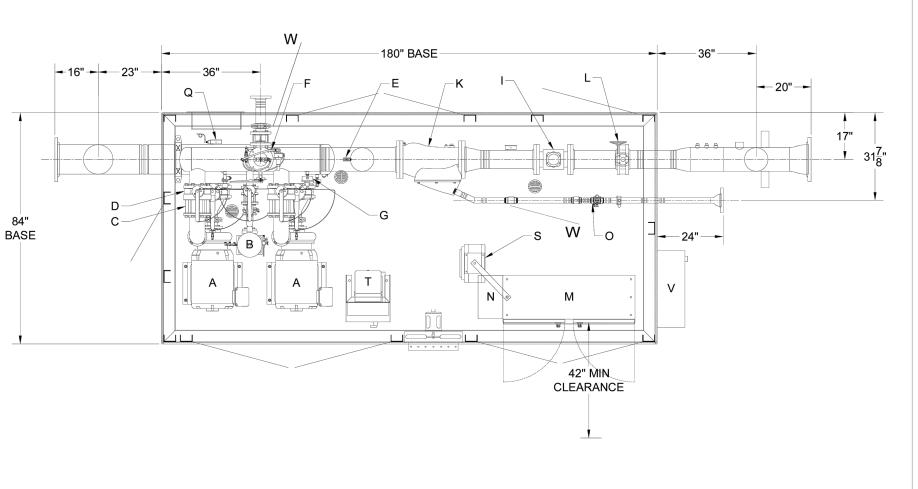

STATION COMPONENTS:

- A 75HP PUMP AND MOTOR W/ WINDING HEATERS
- B 7.5HP SUSTAIN PUMP AND MOTOR
- C CHECK VALVE
- D PUMP ISOLATION VALVE W/ EBV
- E DRAIN
- F 3" PRESSURE RELIEF VALVE
- G DISCHARGE PRESSURE TRANSDUCER W/
- H PAINTED STEEL BASE (SANDSTONE)
- I 6" ELECTROMAGNETIC FLOW METER
- K 8" WYE STRAINER W/ SOLENOID AUTOFLUSH
- L 6" STATION ISOLATION VALVE
- M CONTROL CABINET
- N HEAT EXCHANGER (AC WITHOUT ENCLOSURE)
- O INLINE CHECK VALVE
- P 6" X 10" FL DISCHARGE DROP PIPE
- Q INTAKE PRESSURE TRANDUCER W/ GAUGE
- R 10" X 10" FL INTAKE DROP PIPE
- S 5KW STATION HEATER
- T 3KVA TRANSFORMER & LOAD CENTER
- U COMPOSITE STATION ENCLOSURE (OPTIONAL)
- V 400AMP EXTERNAL DISCONNECT (OPTIONAL)
- W Check Valves

CONCEPT DRAWING ADDITIONAL INFORMATION

WATERVISION CLOUD HINGED WINDOW KIT

CONCEPT DRAWING ONLY NOT TO BE USED FOR CONSTRUCTION

ADD CHECK VALVE TO PRV AND WYE FLUSH

**DESCRIPTION** 

**PLAN VIEW** 

DATE:

CHECKED BY: CG DATE: 8/4/2023 THIS DRAWING AND DESIGN, IS THE PROPERTY OF WATERTRONICS AND IS NOT TO BE REPRODUCED IN WHOLE OR PART, NOR EMPLOYED FOR ANY PURPOSE OTHER THAN SPECIFICALLY PERMITTED IN WRITING BY WATERTRONICS.

THIS DRAWING LOANED AND SUBJECT

MTM

DRAWN BY:

CHK DATE CHK BY TO RETURN ON DEMAND

8/4/2023 TITLE:

WOLF CREEK GC HCFV-7C-75X2/7.5VMS-480-3-1000-150



SCALE: NTS SHEET 2 OF 3 SHEETS JOB NO.: DRAWING NO. PRHC11102

[2022616]

WOLF CREEK WATER AND SEWER ID.
REUSE PROJECT

UPPER PUMP STATION PUMP STATION DETAILS


UPP2

3

1/9/2024

DATE

BY

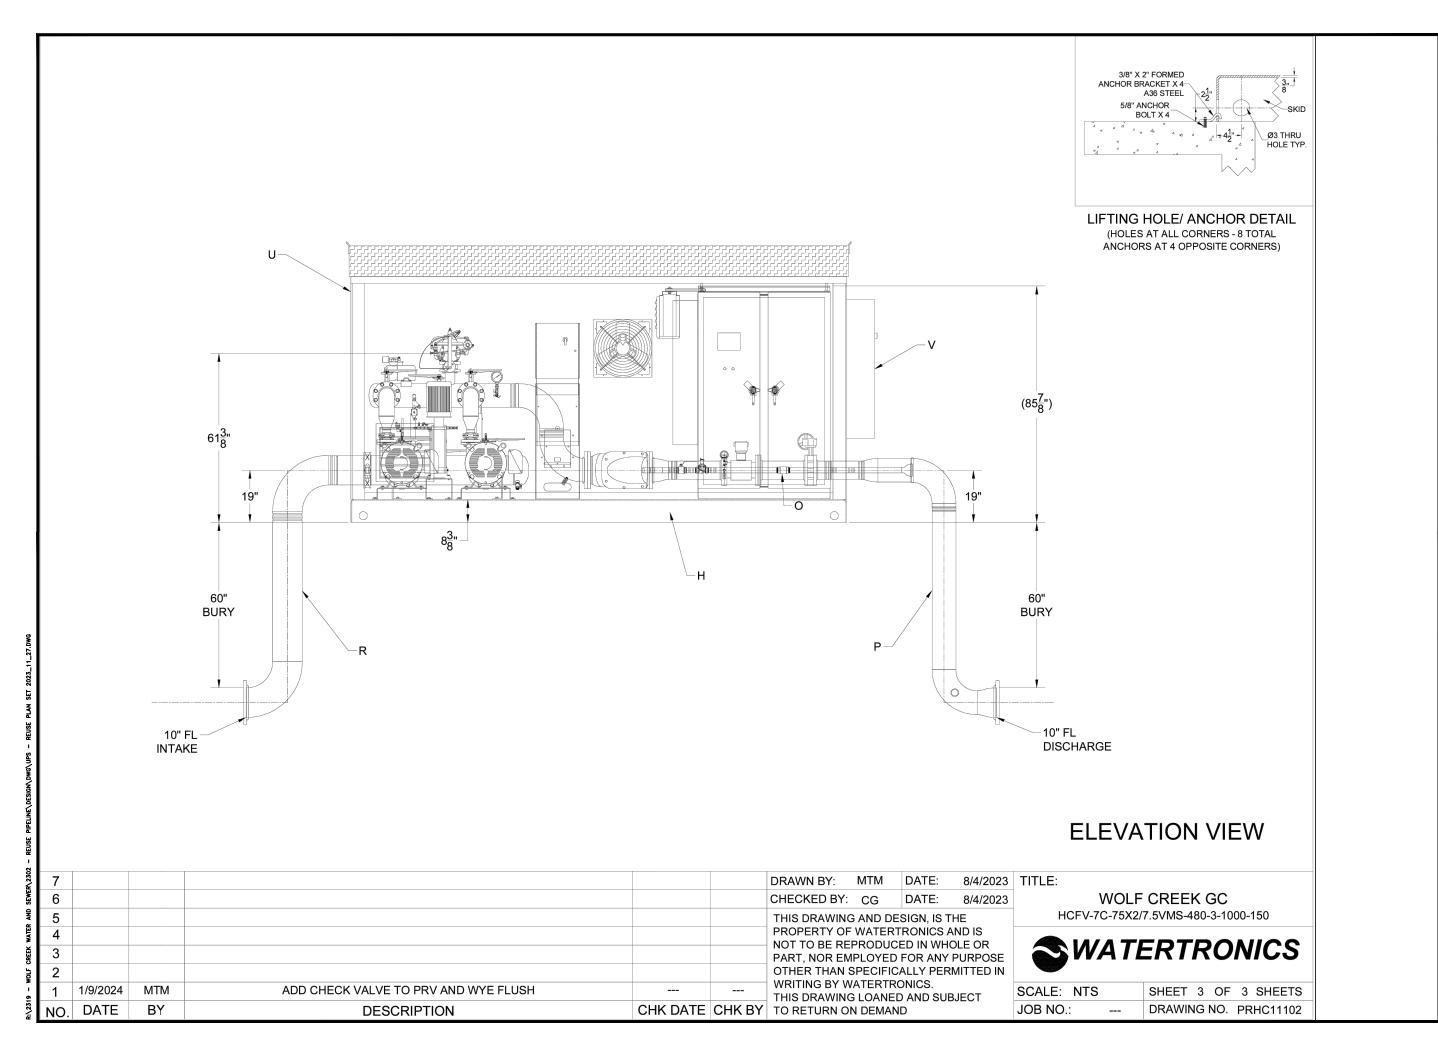

Pate Description Scale: 1-9-24

Date Description Scale: #######

Designed: DW

Designed: PCA

WOLF CREEK WATER AND SEWER ID,
REUSE PROJECT

RDNER WINEERING



UPP3