

The Barn at Terakee Farms No. 2

A PRUD Subdivision

A part of the Southeast Quarter of Section 17, T6N, R2W, SLB&M, U.S. Survey

Weber County, Utah

March 2021

* See All Sheets*

NOTES

- All construction shall conform to Weber County standards and specifications.
- Underground utility piping materials will meet or exceed Weber County Standards.
- Culinary water services will be 3/4" Dia. C-900 DR14 PVC to be centered on the frontage and extended 10' beyond the right of way line.
- 4" Sanitary sewer laterals to be constructed 10' down slope from the center of the lot and extended 10' beyond the right of way line.
- All Utility trenches within the Street right of way shall have a County approved imported granular backfill.
- Thrust block all water line fittings.
- All inlet grates shall be bicycle safe.
- All fire hydrants and access roads shall be installed prior to any construction of any buildings.
- All fire hydrants shall be placed with 4 1/2 inch connections facing the point of access for the Fire Department Apparatus.
- Prior to the beginning of construction of any buildings, a fire flow test of new hydrants shall be conducted to verify the actual fire flow for this project. The Fire Prevention Division shall witness this test and shall be notified a minimum of 48 hours prior to the test.
- Curb & gutter installed along 900 South Street will be set to ensure a 1.5% minimum/3.0% Maximum cross slope from edge of asphalt. Contractor to verify prior to construction of curb.
- An excavation permit is required for all work done within the existing Right of Way.
- A Storm Water Construction Activity Permit is required for any construction that disturbs more than 5000 Sq. Ft. or 200 Cubic Yards.
- All improvements need to be either installed or escrowed prior to recording of the subdivision.
- If construction activity will disturb more than an acre then a State SWPPP will be required. This includes the construction of the homes etc. on each lot.
- Private Roads that are less than 32 feet in width shall be posted with "NO PARKING FIRE LANE" on the West and South sides as indicated on the Grading and Drainage plan. (Roadways and signage shall comply with appendix D of the 2015 International Fire Code as adopted by Weber Fire District).
- Construct ADA Ramps with Truncated Domes with detectable warning systems cast in place, gray in color per APWA Plan 235.1.

GENERAL UTILITY NOTES:

- Coordinate all utility connections to building with plumbing plans and building contractor.
- Verify depth and location of all existing utilities prior to constructing any new utility lines. Notify Civil Engineer of any discrepancies or conflicts prior to any connections being made.
- All catch basin and inlet box grates are to be bicycle proof.
- All inlet boxes located in curb and gutter are to be placed parallel to the curb and gutters and set under the frame and grate. Improperly placed boxes will be removed and replaced at no additional cost to the owner. Precast or cast in place boxes are acceptable.
- Refer to the site electrical plan for details and locations of electrical lines, transformers and light poles.
- Gas lines, telephone lines, and cable TV lines are not a part of these plans unless otherwise noted.
- Water meters are to be installed per water district standards and specifications. It will be the contractor's responsibility to install all items required.
- Water lines, valves, fire hydrants, fittings etc. are to be constructed as shown. Contractor is responsible to construct any vertical adjustments necessary to clear sewer, storm drain or other utilities as necessary including valve boxes and hydrant spools to proper grade.
- Field verify all existing and/or proposed Roof Drain/Roof Drain down spout connections to Storm Water System with Civil, Plumbing & Architectural plans. Notify Engineer of any discrepancies.
- All gravity flow utility lines shall be installed prior to any pressurized utilities unless written permission is obtained from the engineer of record before construction begins.

UTILITY PIPING MATERIALS:

- All piping to be installed per manufacturers recommendations. Refer to project specifications for more detailed information regarding materials, installation, etc.

CULINARY SERVICE LATERALS

- 3/4" to 2" diameter pipe - copper tube ASTM B, Type K, Soft Temper
- Over 2" diameter pipe - AWWA C-900 Class 150 pipe

WATER MAIN LINES AND FIRE LINES


- Pipe material as shown on utility plan view or to meet County standards.

SANITARY SEWER LINES

- All sewer piping to be Polyvinyl Chloride (PVC) sewer pipe, ASTM D 3034, Type PSM, SDR 35

STORM DRAIN LINES

- 10" pipes or smaller - Polyvinyl Chloride (PVC) sewer pipe, ASTM D3034, Type PSM, SDR 35
- 12" to 21" pipes - Reinforced Concrete Pipe, ASTM C14, Class III up to 13' of cover. For greater than 13' feet of cover, use reinforced concrete pipe and classes listed below.
- 24" pipes or larger - Reinforced Concrete Pipe, ASTM C76, Class III up to 13' of cover, Class IV for 13' to 21' of cover, Class V for 21' to 32' of cover, and Special Design for cover greater than 32 feet.

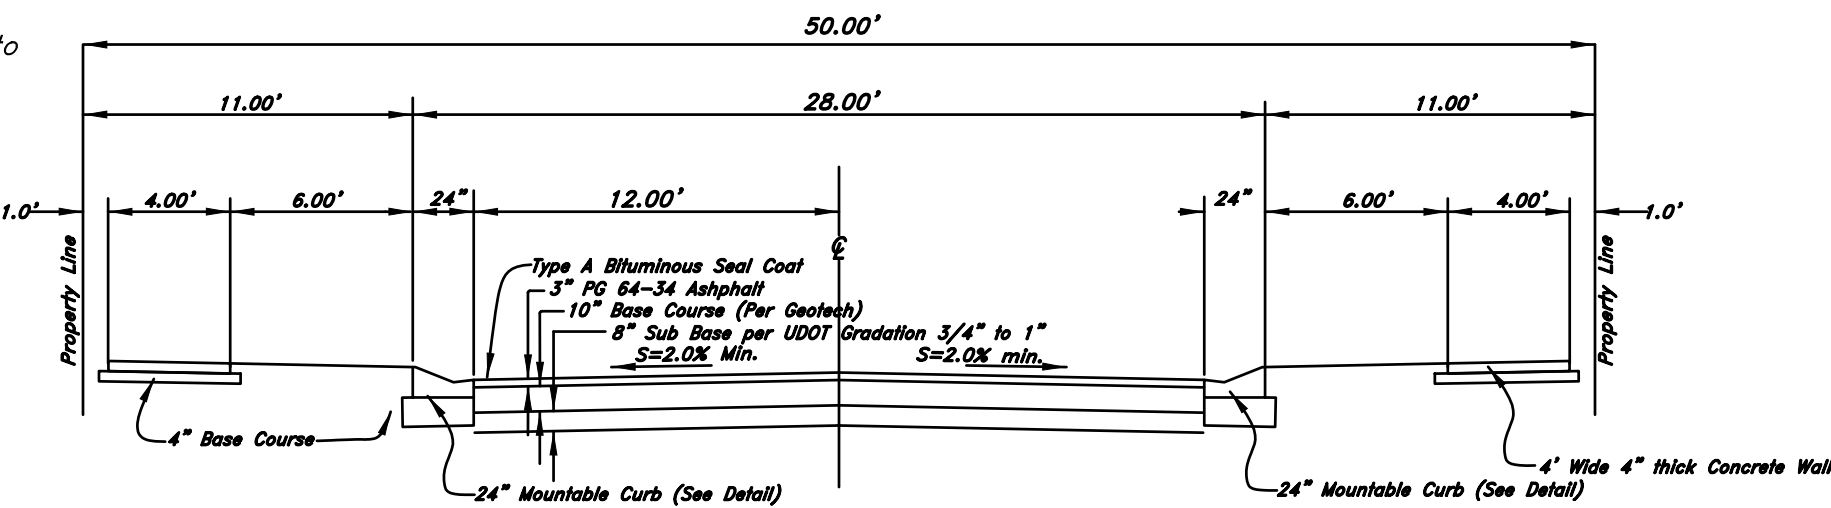


50' Private Roadway Section
Not to Scale

- NOTES:**
- These pavement thicknesses shall be considered as minimums and may be increased by the County Engineer when the subgrade C.B.R. is less than 10 or when a greater depth is necessary to provide sufficient stability. Developer may submit and alternate pavement design based on a detailed soils analysis for approval by the County Engineer.
 - Minor & Major arterial shall be constructed with a 10" untreated base course & 3" bituminous surface course as required by the City Engineer.
 - County Engineer has discretion to call for more.
 - Provide 4" thickness of 1/2" or 1" gravel base course under sidewalk, driveway approaches and curb & gutter when subgrade is clay or C.B.R. is less than 10 or as directed by the County Engineer.

NOTE: County Engineer may specify use of standard high back curb & gutter on collector & arterials.

- NOTES:**
- Maximum difference in elevation between curbs on opposite sides of street shall not exceed 1.0'.
 - On arterial streets the County Engineer will provide a pavement design. Location of sidewalk and rolled curb & gutter may vary on individual arterial streets per direction of the County Engineer.
 - See Geotechnical Engineering Study prepared by CMF Engineering Laboratories Project No. 10241, dated October 2018 for preparation of Sub Grade.


FF = Lowest allowable livable Finished Floor Elevation unless approved by Geotechnical Engineer and County Engineer due to ground water table.

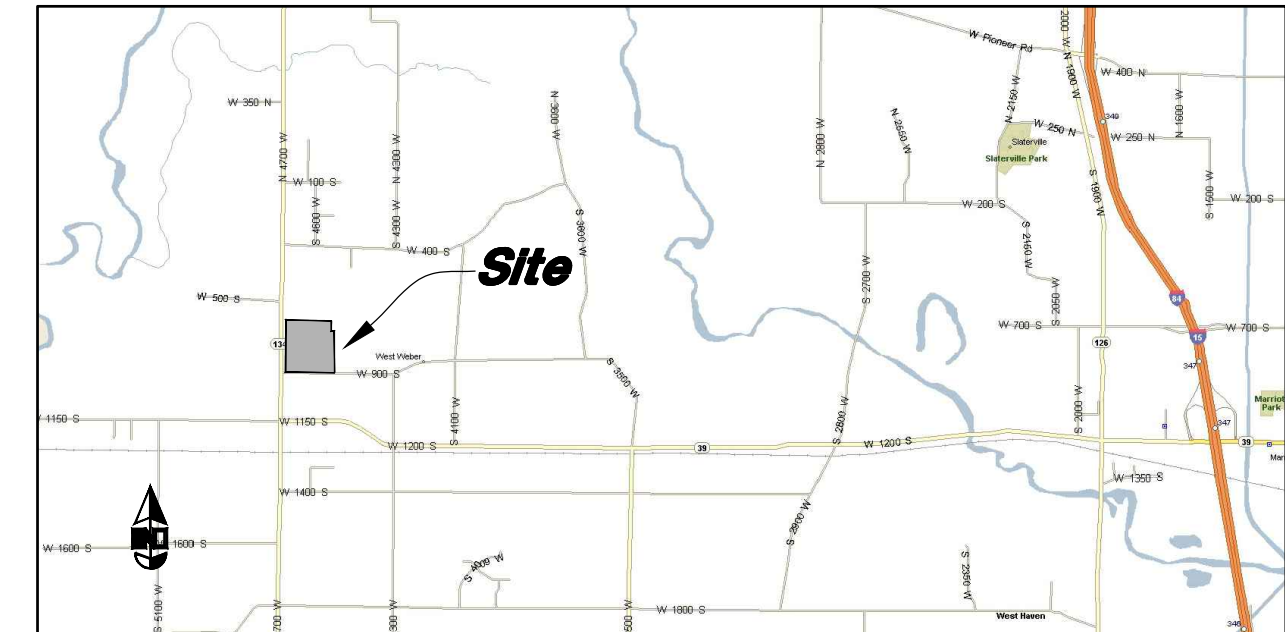

VICINITY MAP
Not to Scale




Key Map
Not to Scale

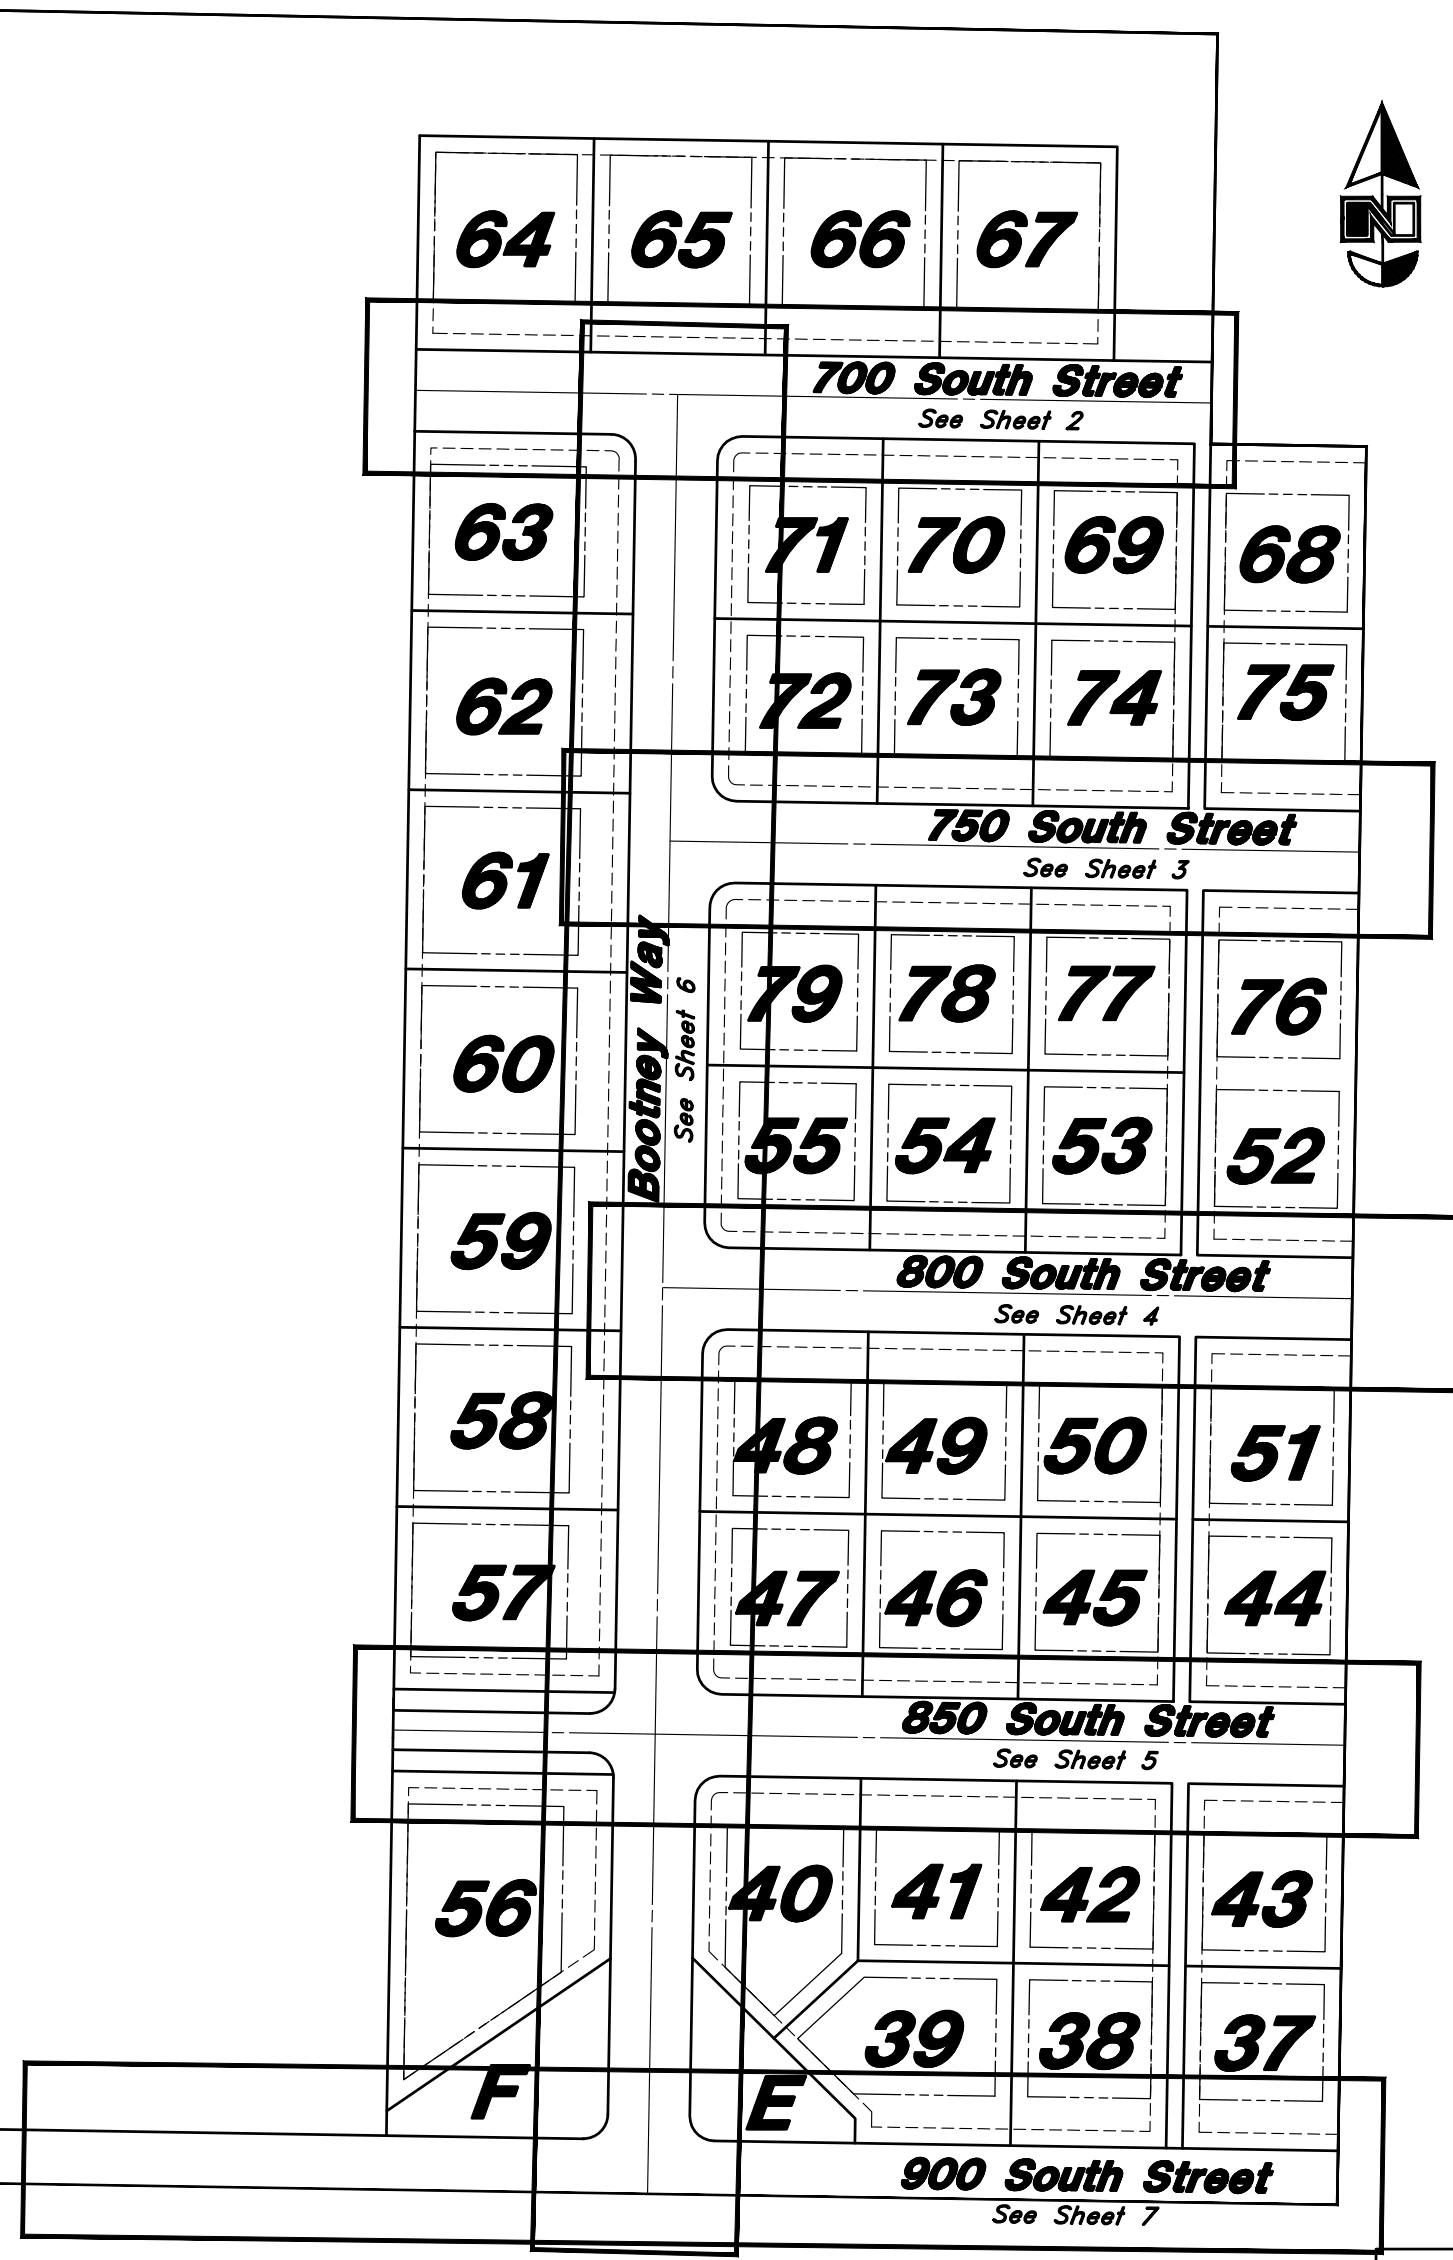

Legend

(Note: All items may not appear on drawing)

- San. Sewer Manhole
- Water Manhole
- Storm Drain Manhole
- Cleanout
- Electrical Manhole
- Catch Basins
- Exist. Fire Hydrant
- Fire Hydrant
- Exist. Water Valve
- Water Valve
- Sanitary Sewer
- Culinary Water
- Gas Line
- Irrigation Line
- Storm Drain
- Telephone Line
- Secondary Waterline
- Power Line
- Fire Line
- Land Drain
- Power pole
- Power pole w/guy
- Light Pole
- Fence
- Flowline of ditch
- Overhead Power line
- Corrugated Metal Pipe
- Concrete Pipe
- Reinforced Concrete Pipe
- Ductile Iron
- Polyvinyl Chloride
- Top of Asphalt
- Edge of Asphalt
- Centerline
- Flowline
- Finish Floor
- Top of Curb
- Top of Wall
- Top of Walk
- Top of Concrete
- Natural Ground
- Finish Grade
- Match Existing
- Fire Department Connection
- Finish Contour
- Exist. Contour
- Finish Grade
- Exist. Grade
- Ridge Line
- Direction of Flow
- Existing Asphalt
- New Asphalt
- Existing Concrete
- New Concrete

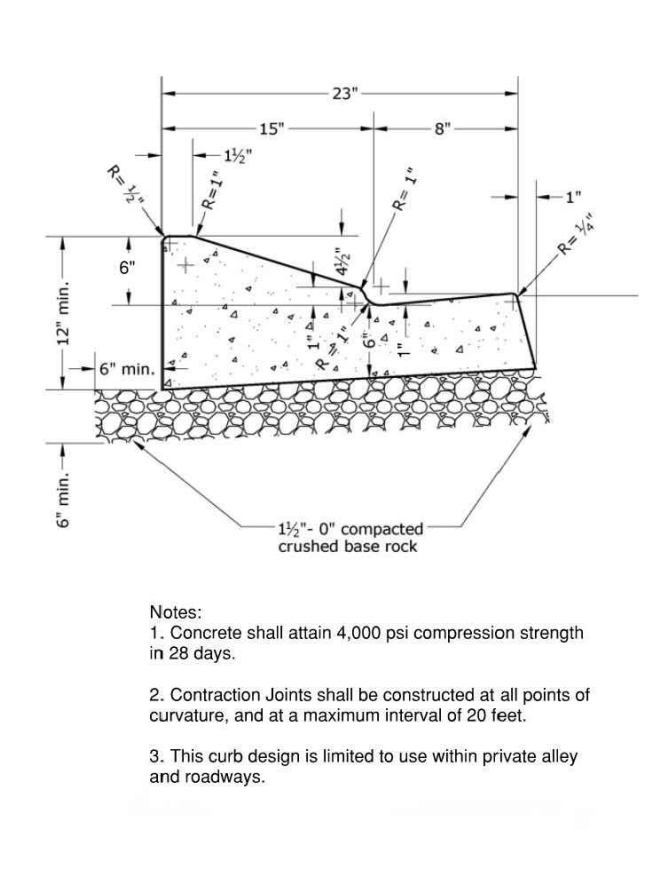

- Notes:**
- Concrete shall attain 4,000 psi compression strength in 28 days.
 - Contraction Joints shall be constructed at all points of curvature, and at a maximum interval of 20 feet.
 - This curb design is limited to use within private alley and roadways.

BENCHMARK

Brass Cap Section Monument located in the South Quarter Corner of Section 17, T6N, R2W, SLB&M, U.S. Survey 4' below surface grade with an elevation of 4238.10.

Call before you Dig
Avoid cutting underground utility lines. It's costly.



1-800-662-4111

Cover sheet

The Barn at Terakee Farms 2

9400 South State Street
Sandy City, Salt Lake County, Utah
A part of Section ??, T6N, R2W, SLB&M, U.S. Survey

23 Sep, 2021

SHEET NO.

C1

16N719

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REVISIONS

DATE


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DESCRIPTION



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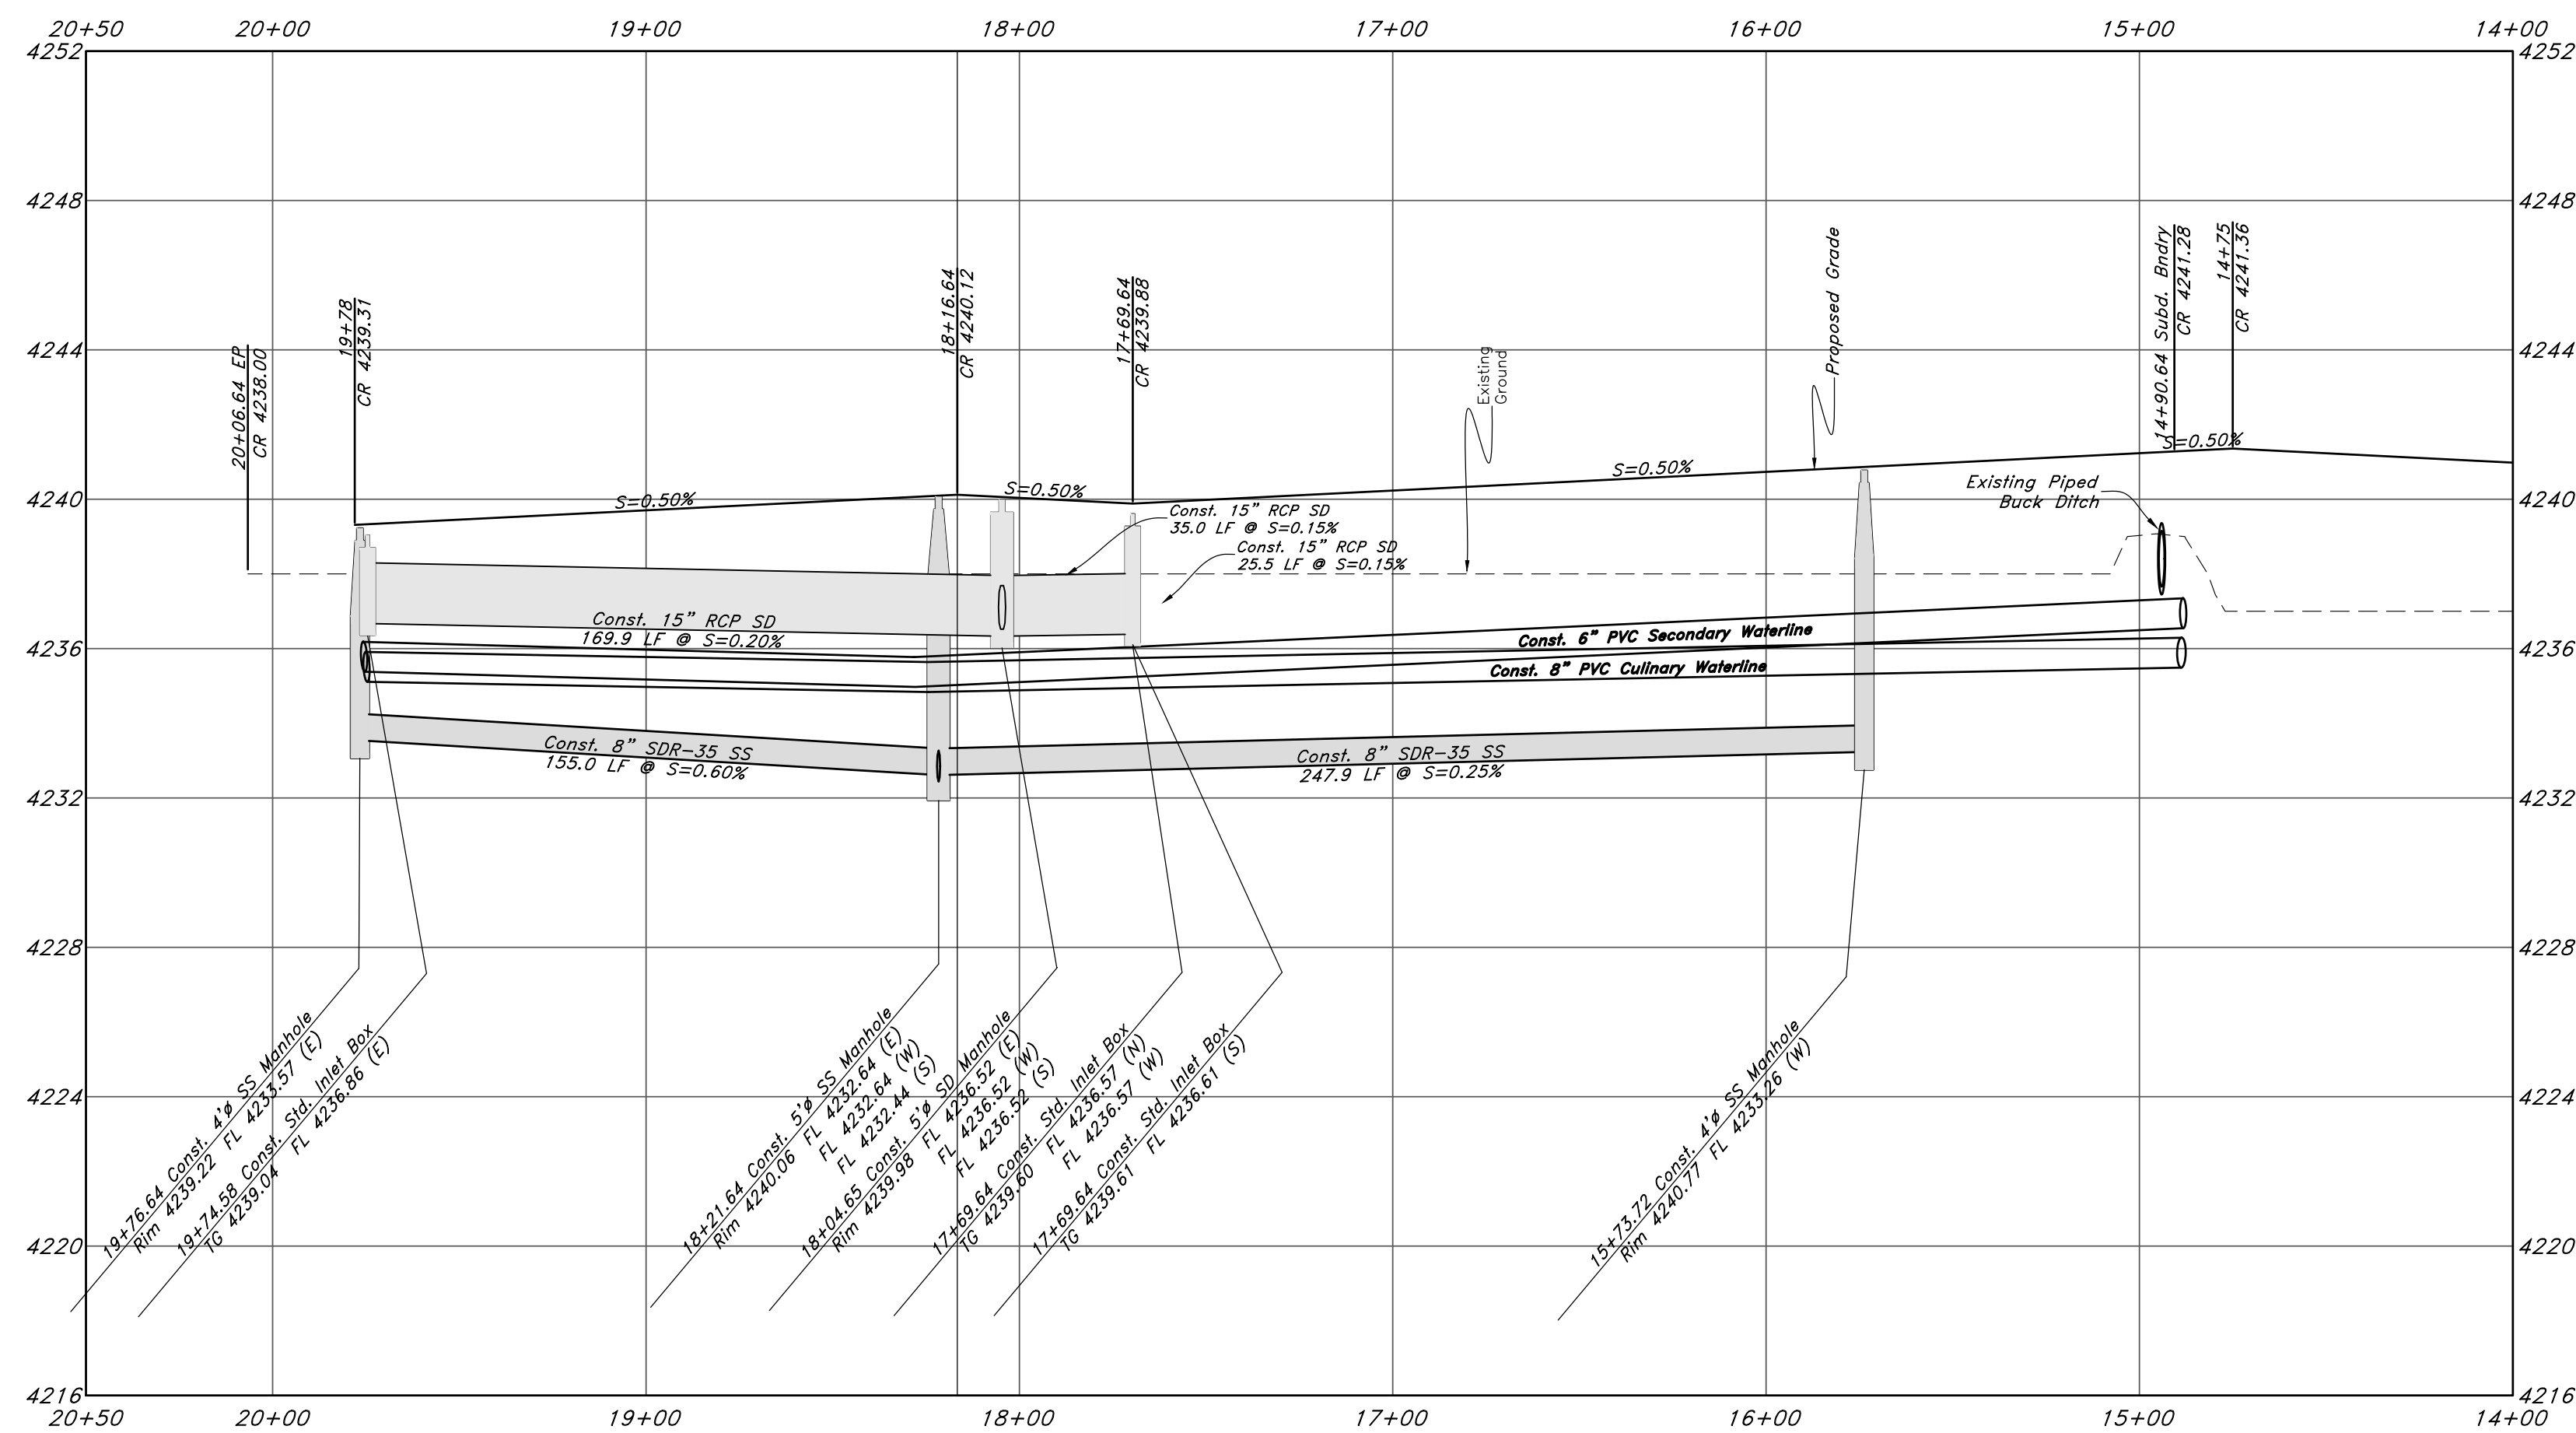
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- Water Valve (Culinary)
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- Top of Curb
- Top of Wall
- Top of Walk
- Top of Concrete
- Natural Ground
- Finish Contour
- Exist. Contour
- Finish Grade
- Exist. Grade
- Ridge Line
- Direction of Flow
- Existing Asphalt
- New Asphalt
- Heavy Duty Asphalt
- Concrete
- Open Face
- Curb & Gutter



Scale:
1" = 40' Horiz.
1" = 4' Vertical

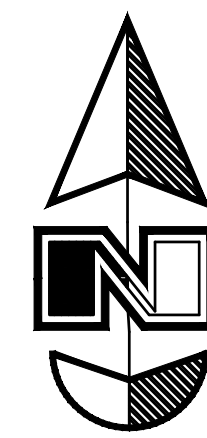

700 South Street

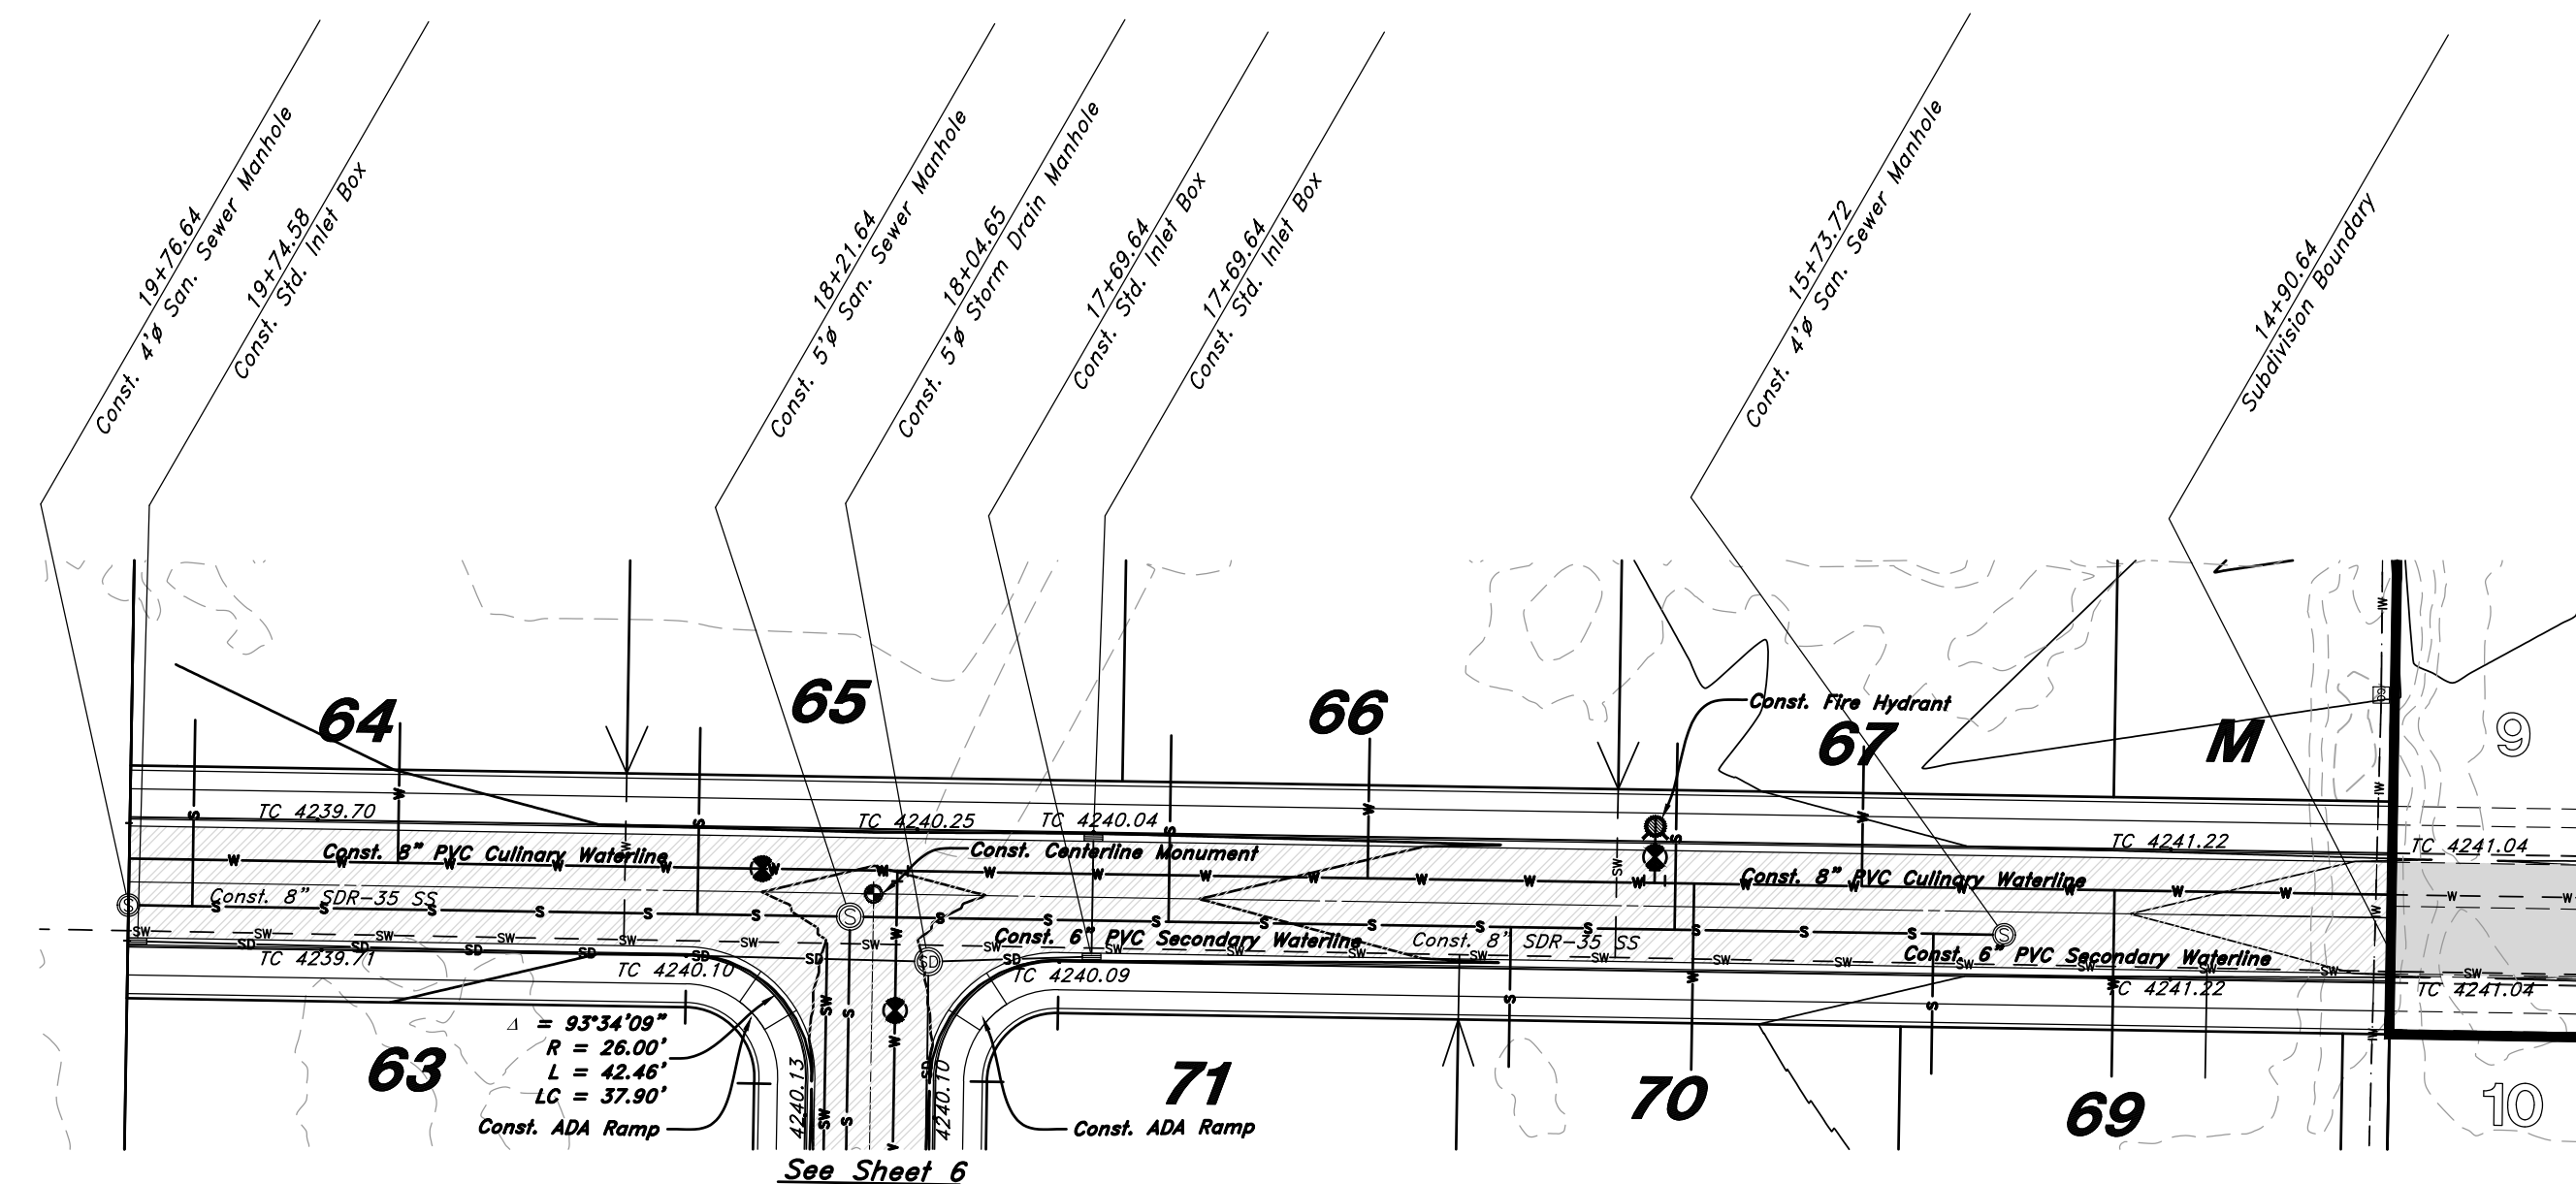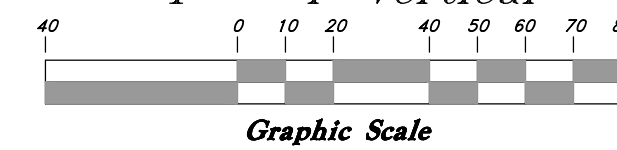

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The Barn at Terakee Farms 2
 9400 South State Street
 Sandy City, Salt Lake County, Utah
 A part of Section ??, T1N, R2W, SLB&M, U.S. Survey

23 Sep, 2021

SHEET NO.

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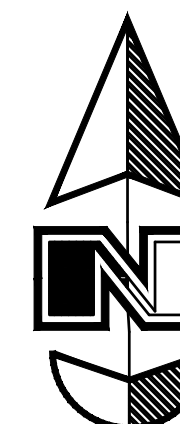
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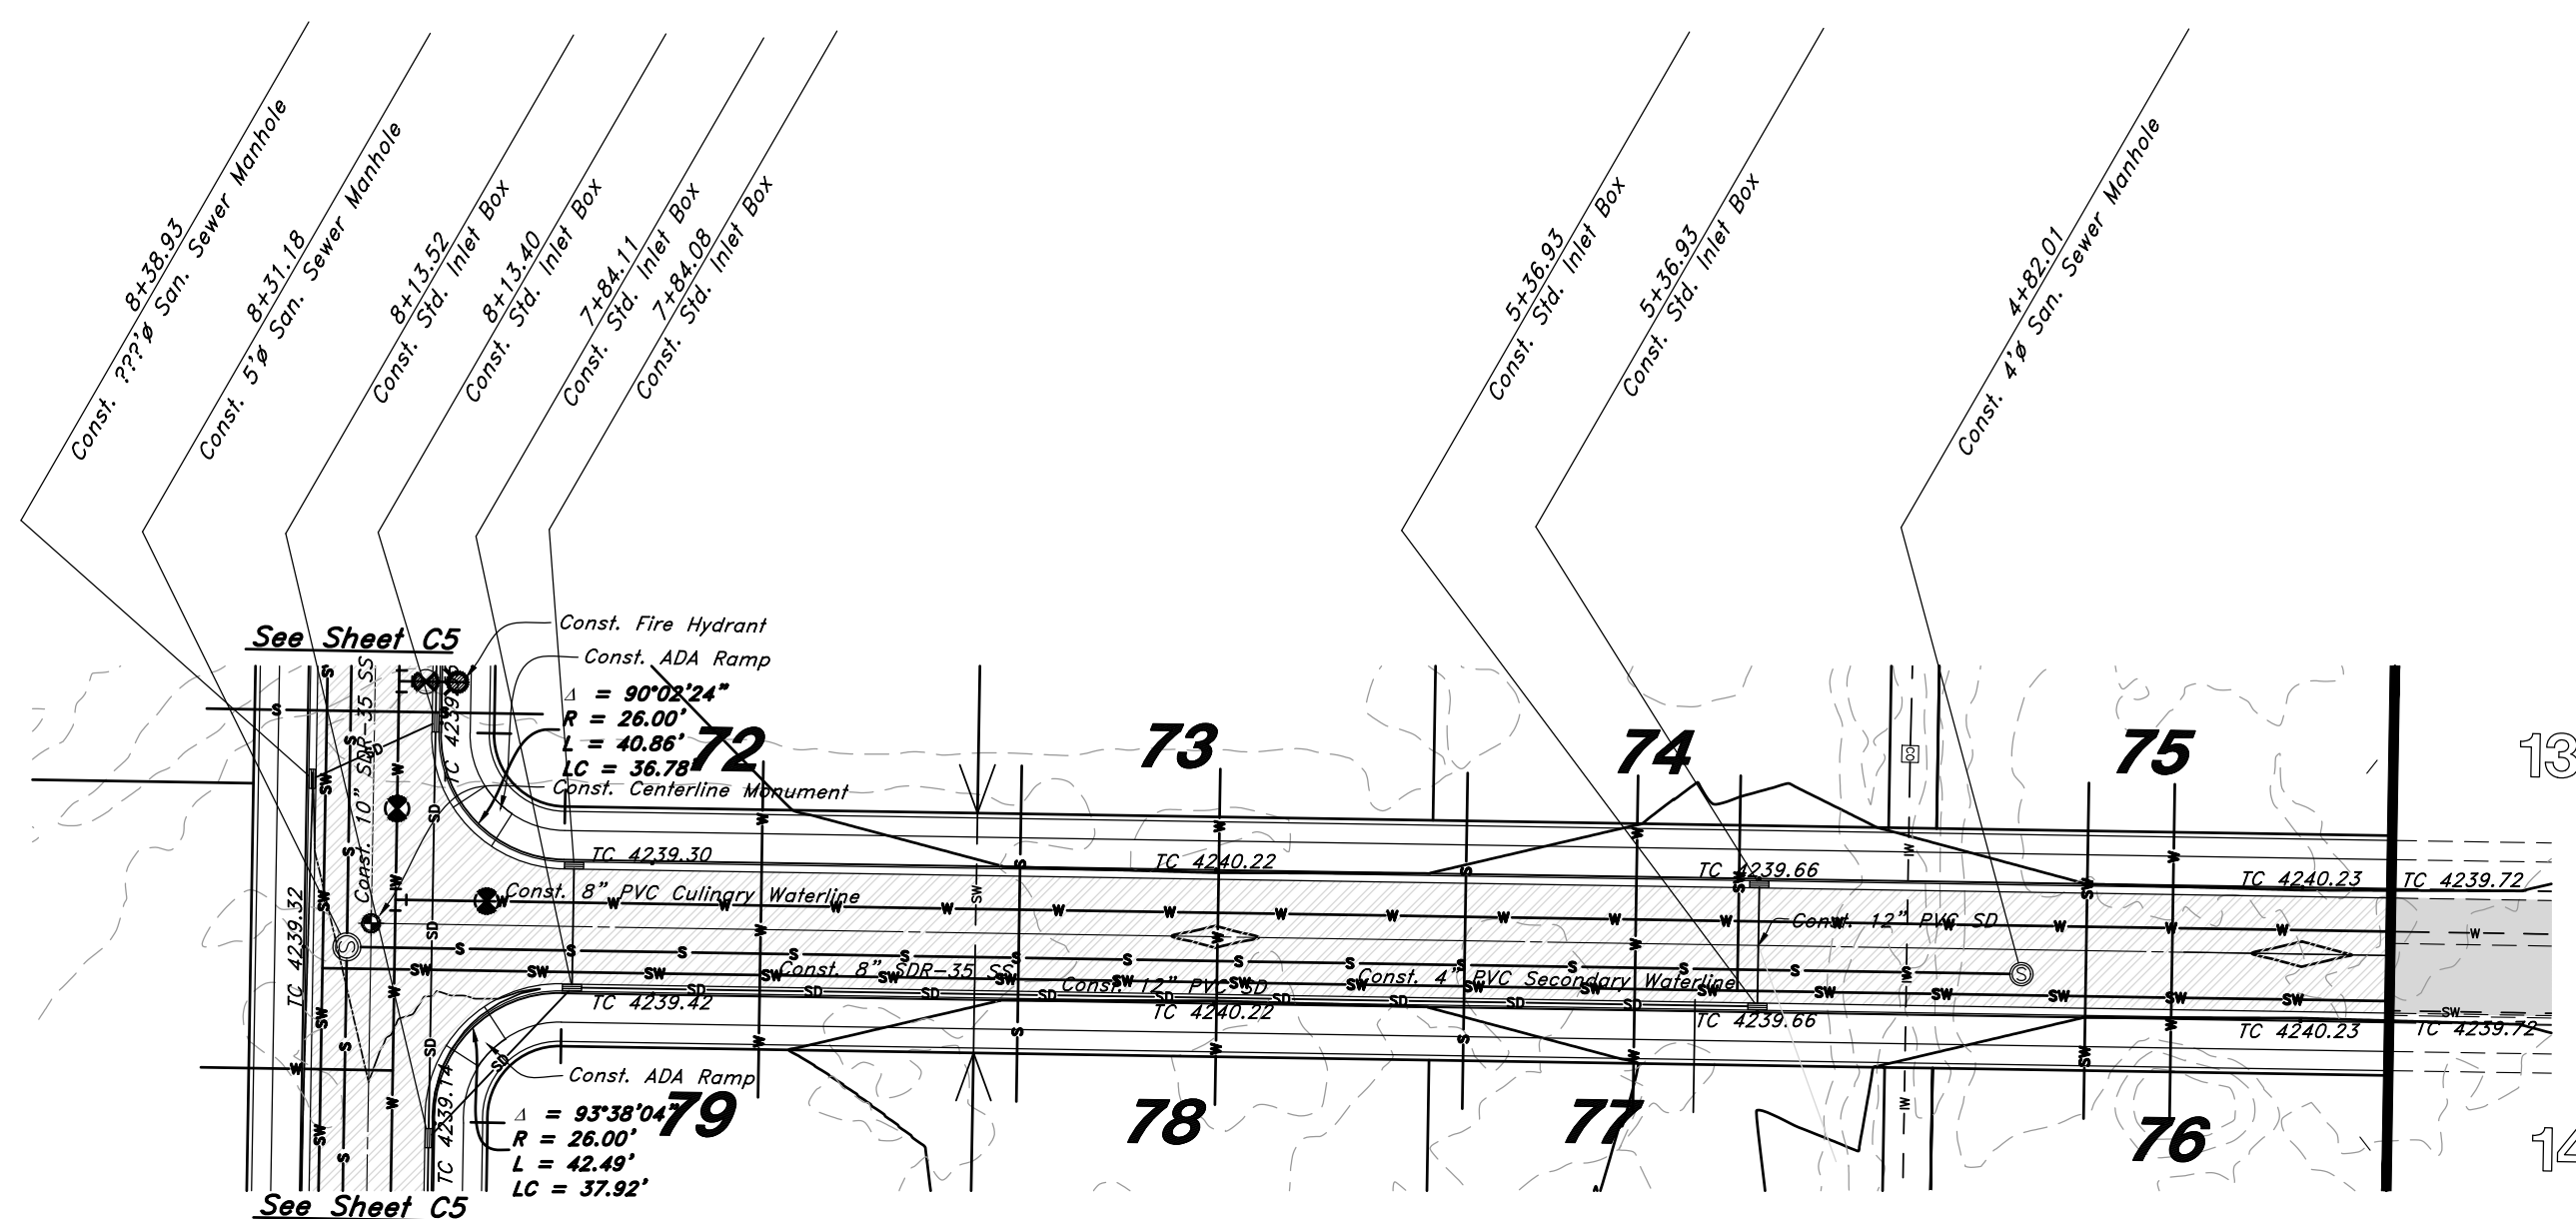
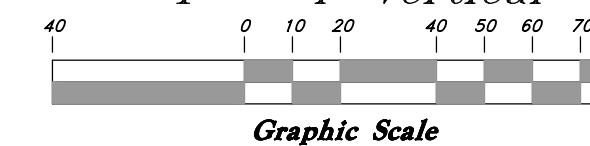
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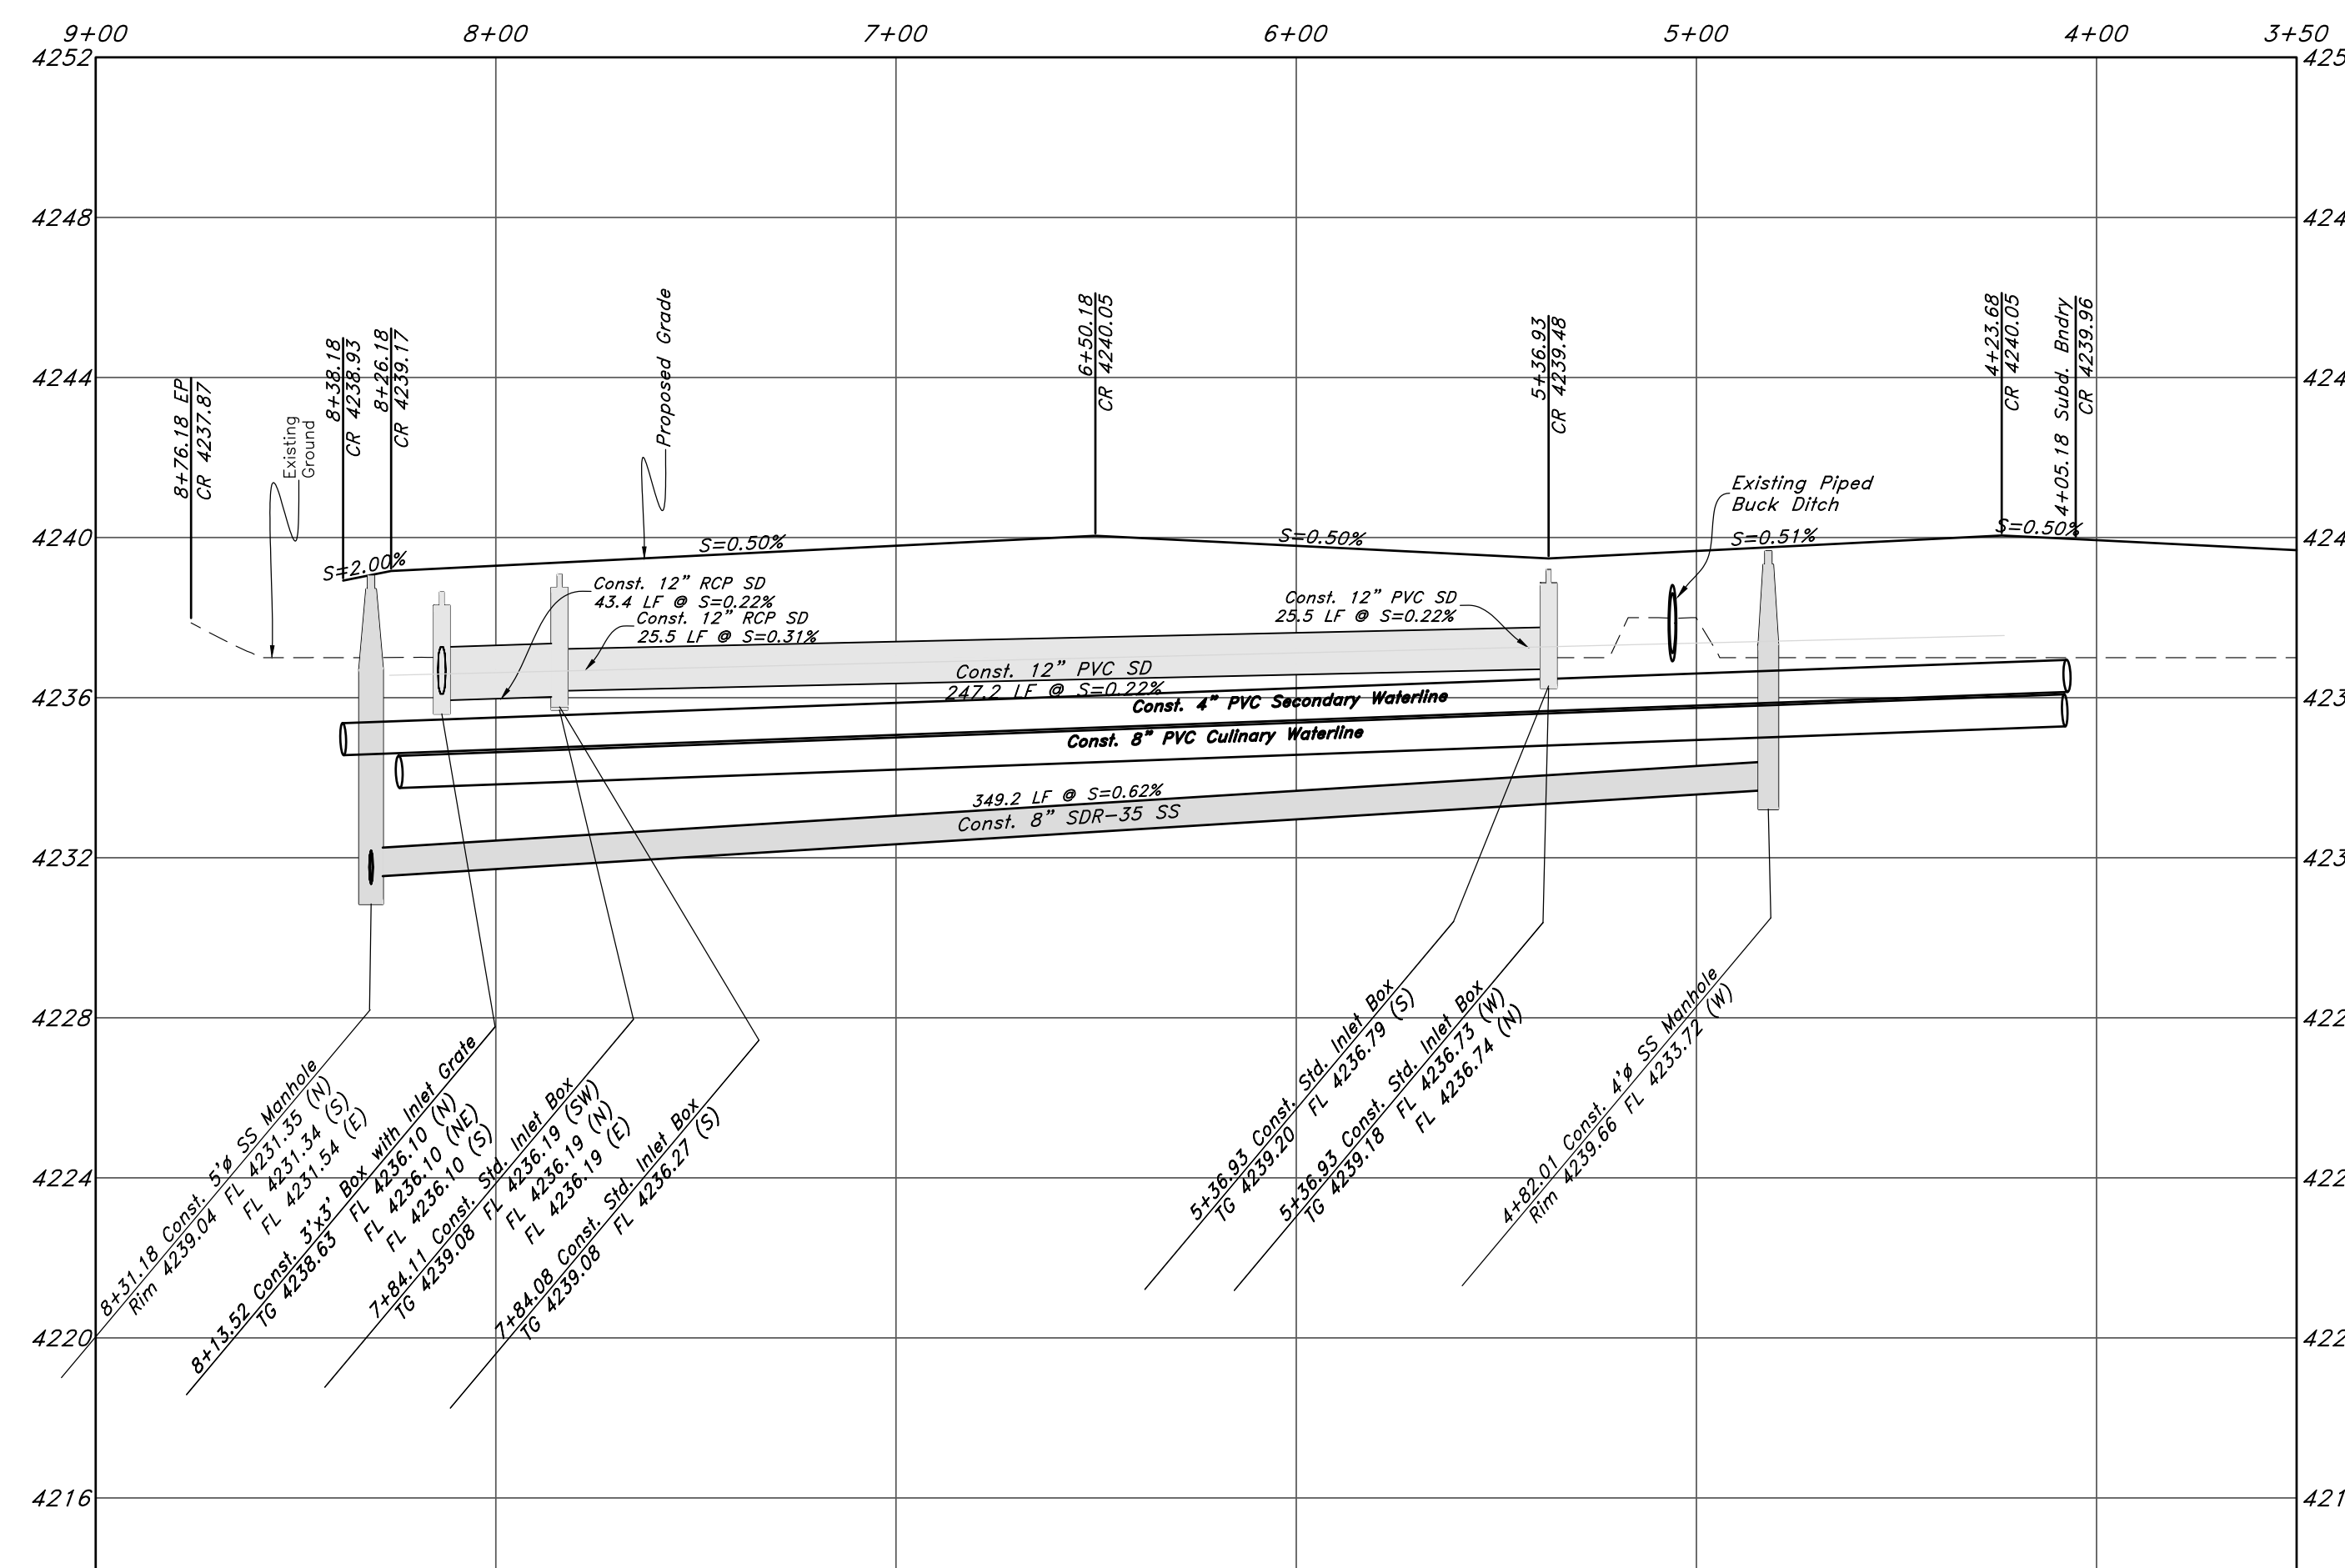
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- Top of Asphalt
- Edge of Asphalt
- Centerline
- Flowline
- Finish Floor
- Top of Curb
- Top of Wall
- TW
- TJN
- Top of Concrete
- Natural Ground
- Finish Contour
- Exist. Contour
- Finish Grade
- Exist. Grade
- Ridge Line
- Direction of Flow
- Existing Asphalt
- New Asphalt
- Heavy Duty Asphalt
- Concrete
- Open Face
- Curb & Gutter



Scale:
1" = 40' Horiz.
1" = 4' Vertical



750 South Street



NOT FOR CONSTRUCTION

DESCRIPTION	DATE	REV

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Plan & Profile

The Barn at Terakee Farms 2


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 16N719



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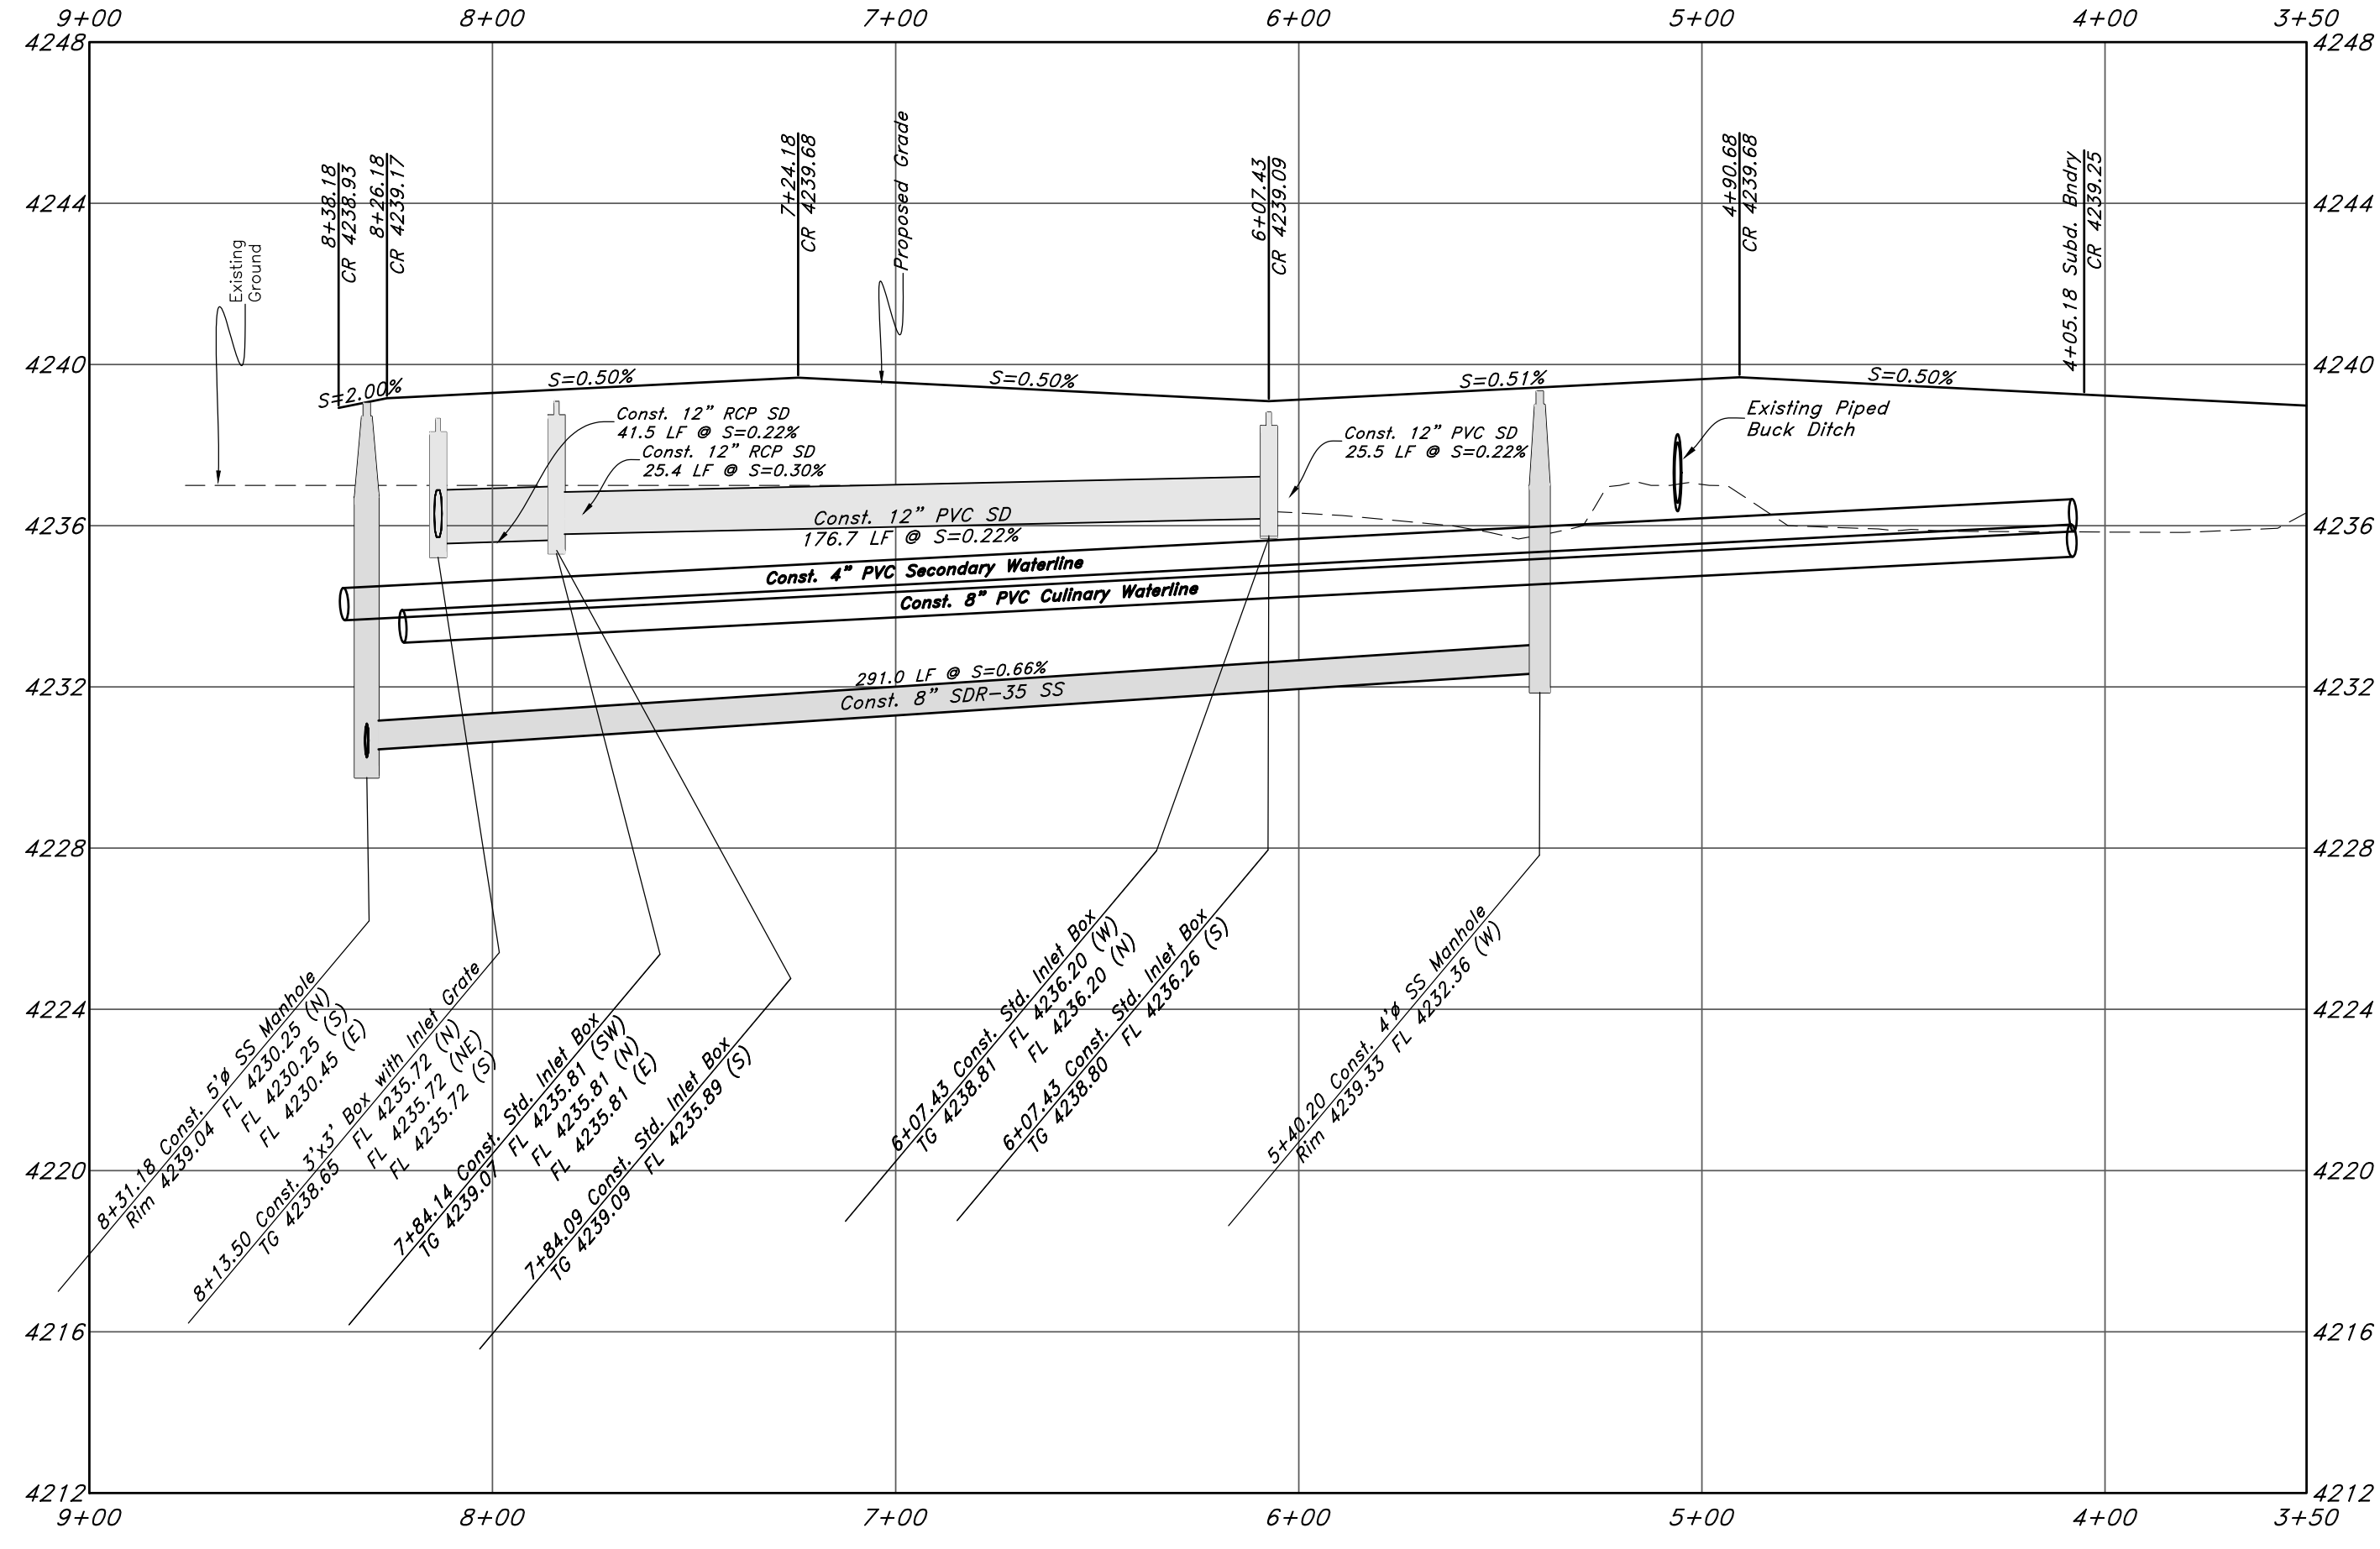
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- Finish Floor
- Top of Curb
- Top of Wall
- TW
- TJ
- TCN
- NG
- 90
- 90
- 95.33TA
- 95.72A
- Ridge Line
- Direction of Flow
- Existing Asphalt
- New Asphalt
- Heavy Duty Asphalt
- Concrete
- Open Face
- Curb & Gutter



Scale:
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1" = 4' Vertical

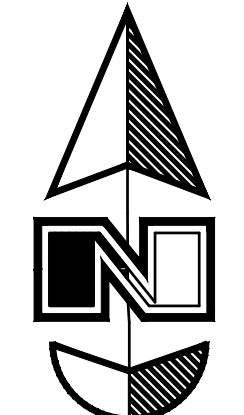

800 South Street

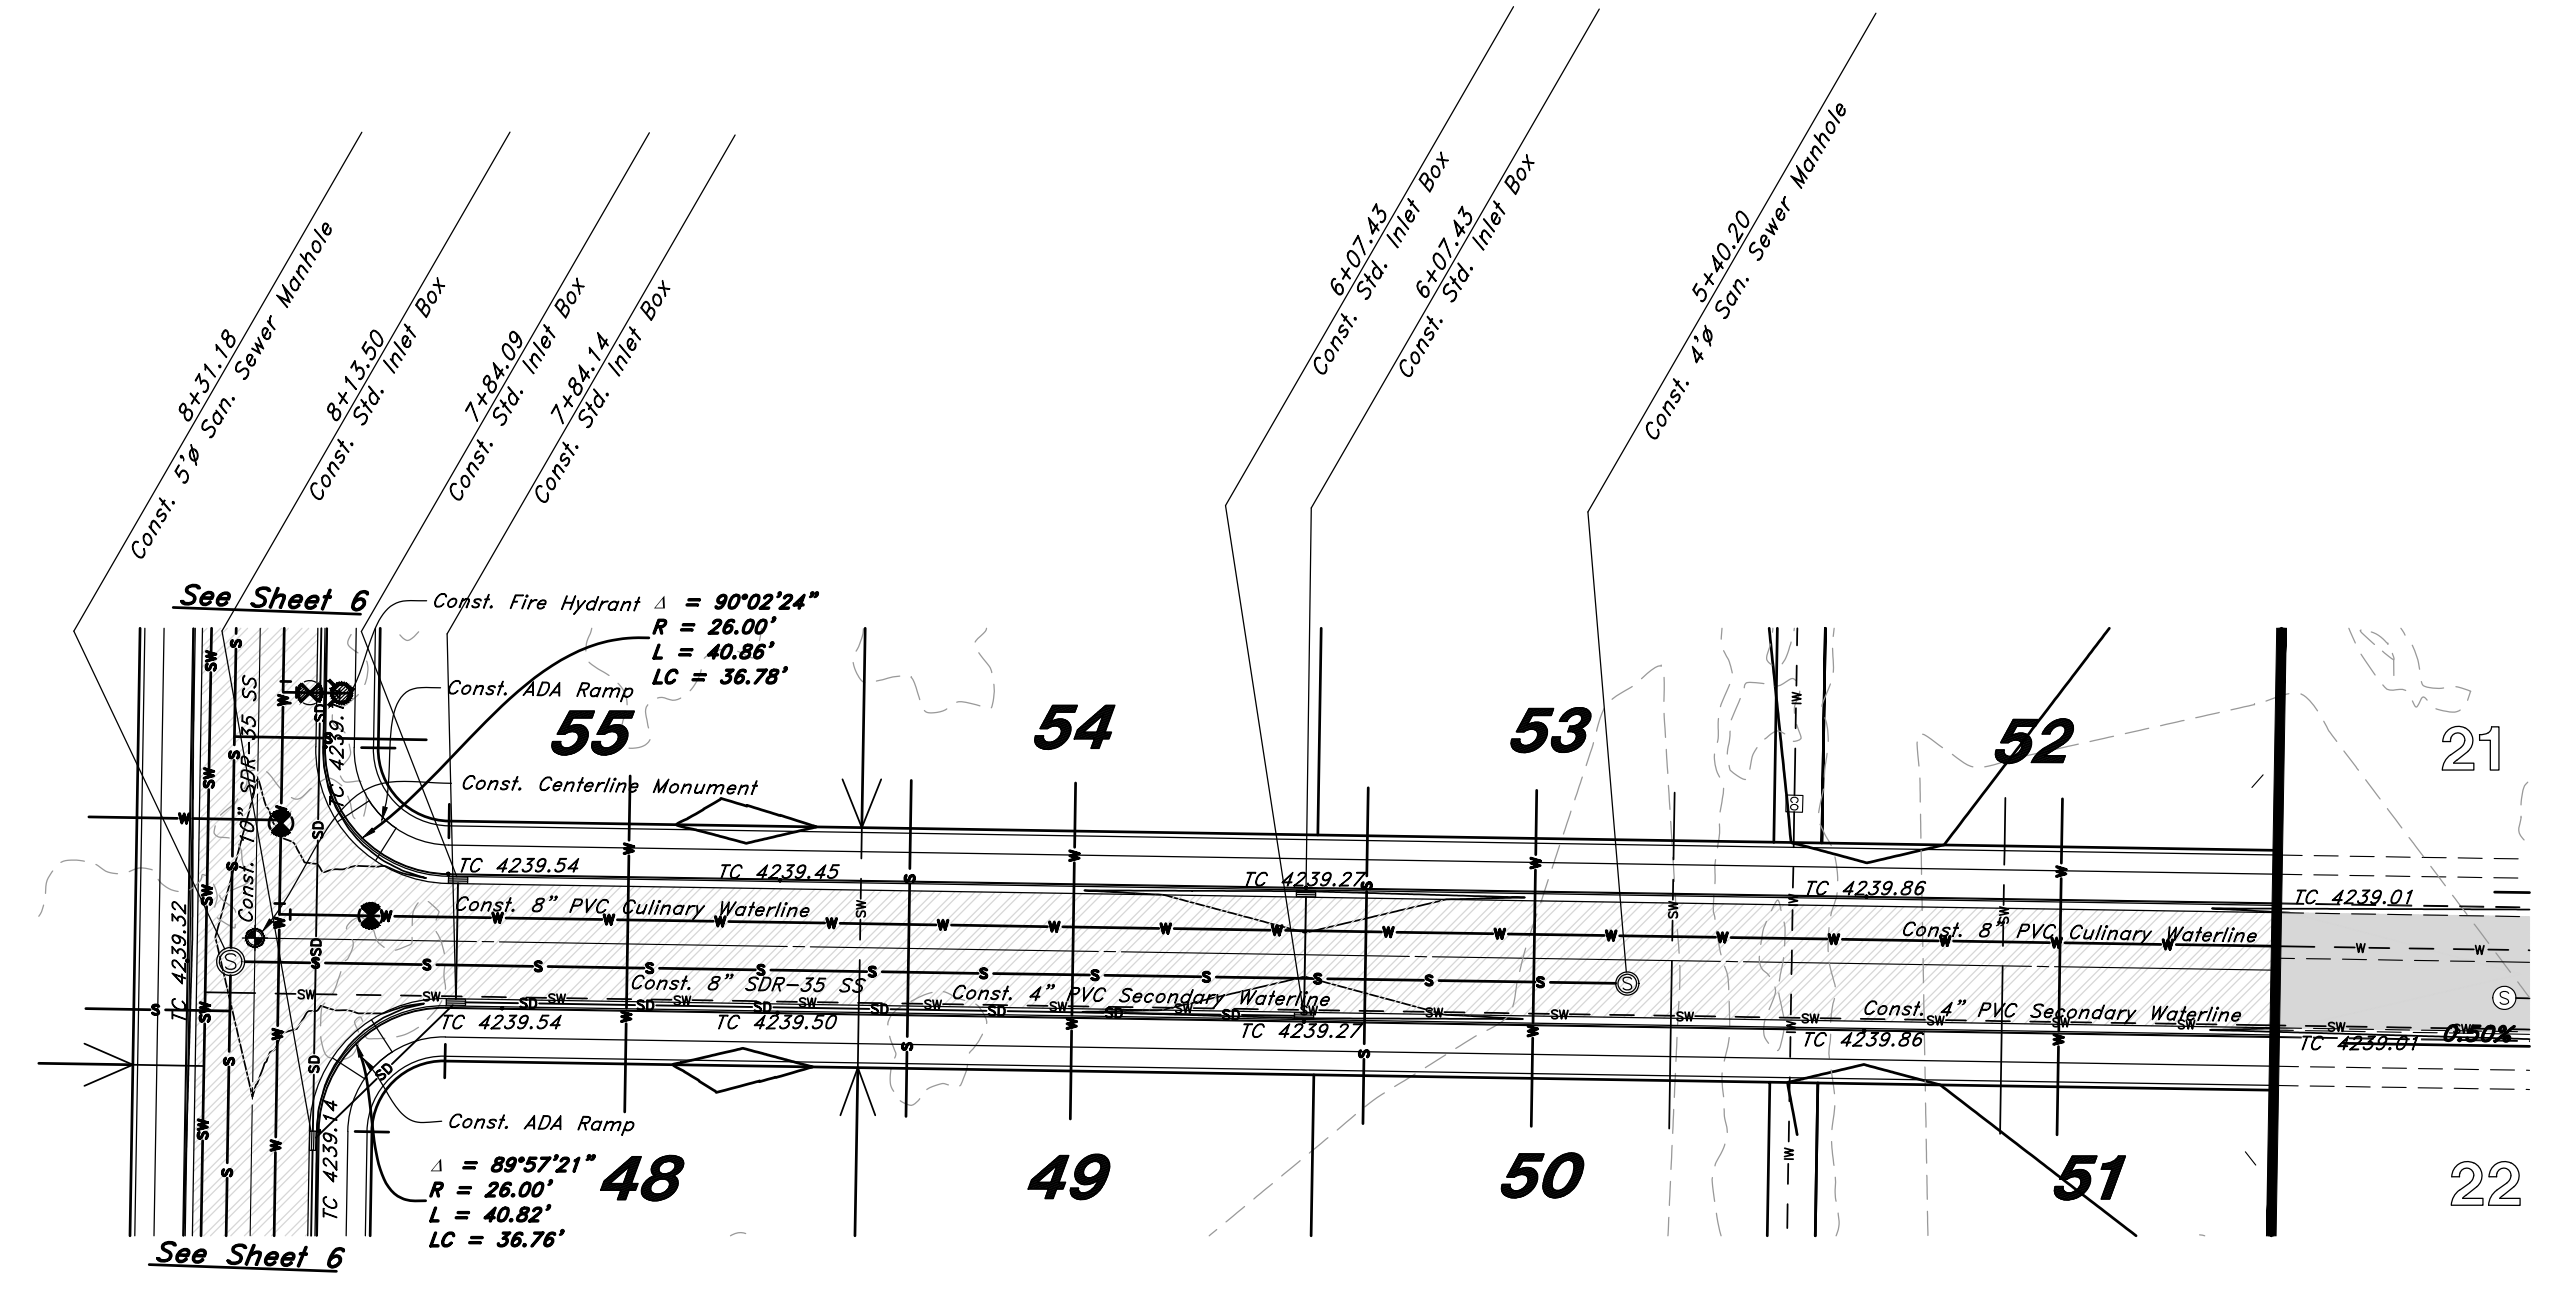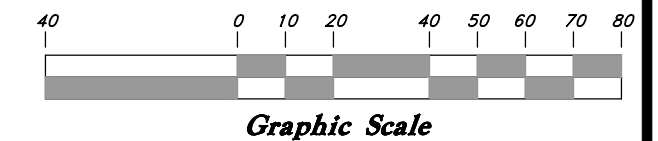

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Plan and Profile


The Barn at Terakee Farms 2

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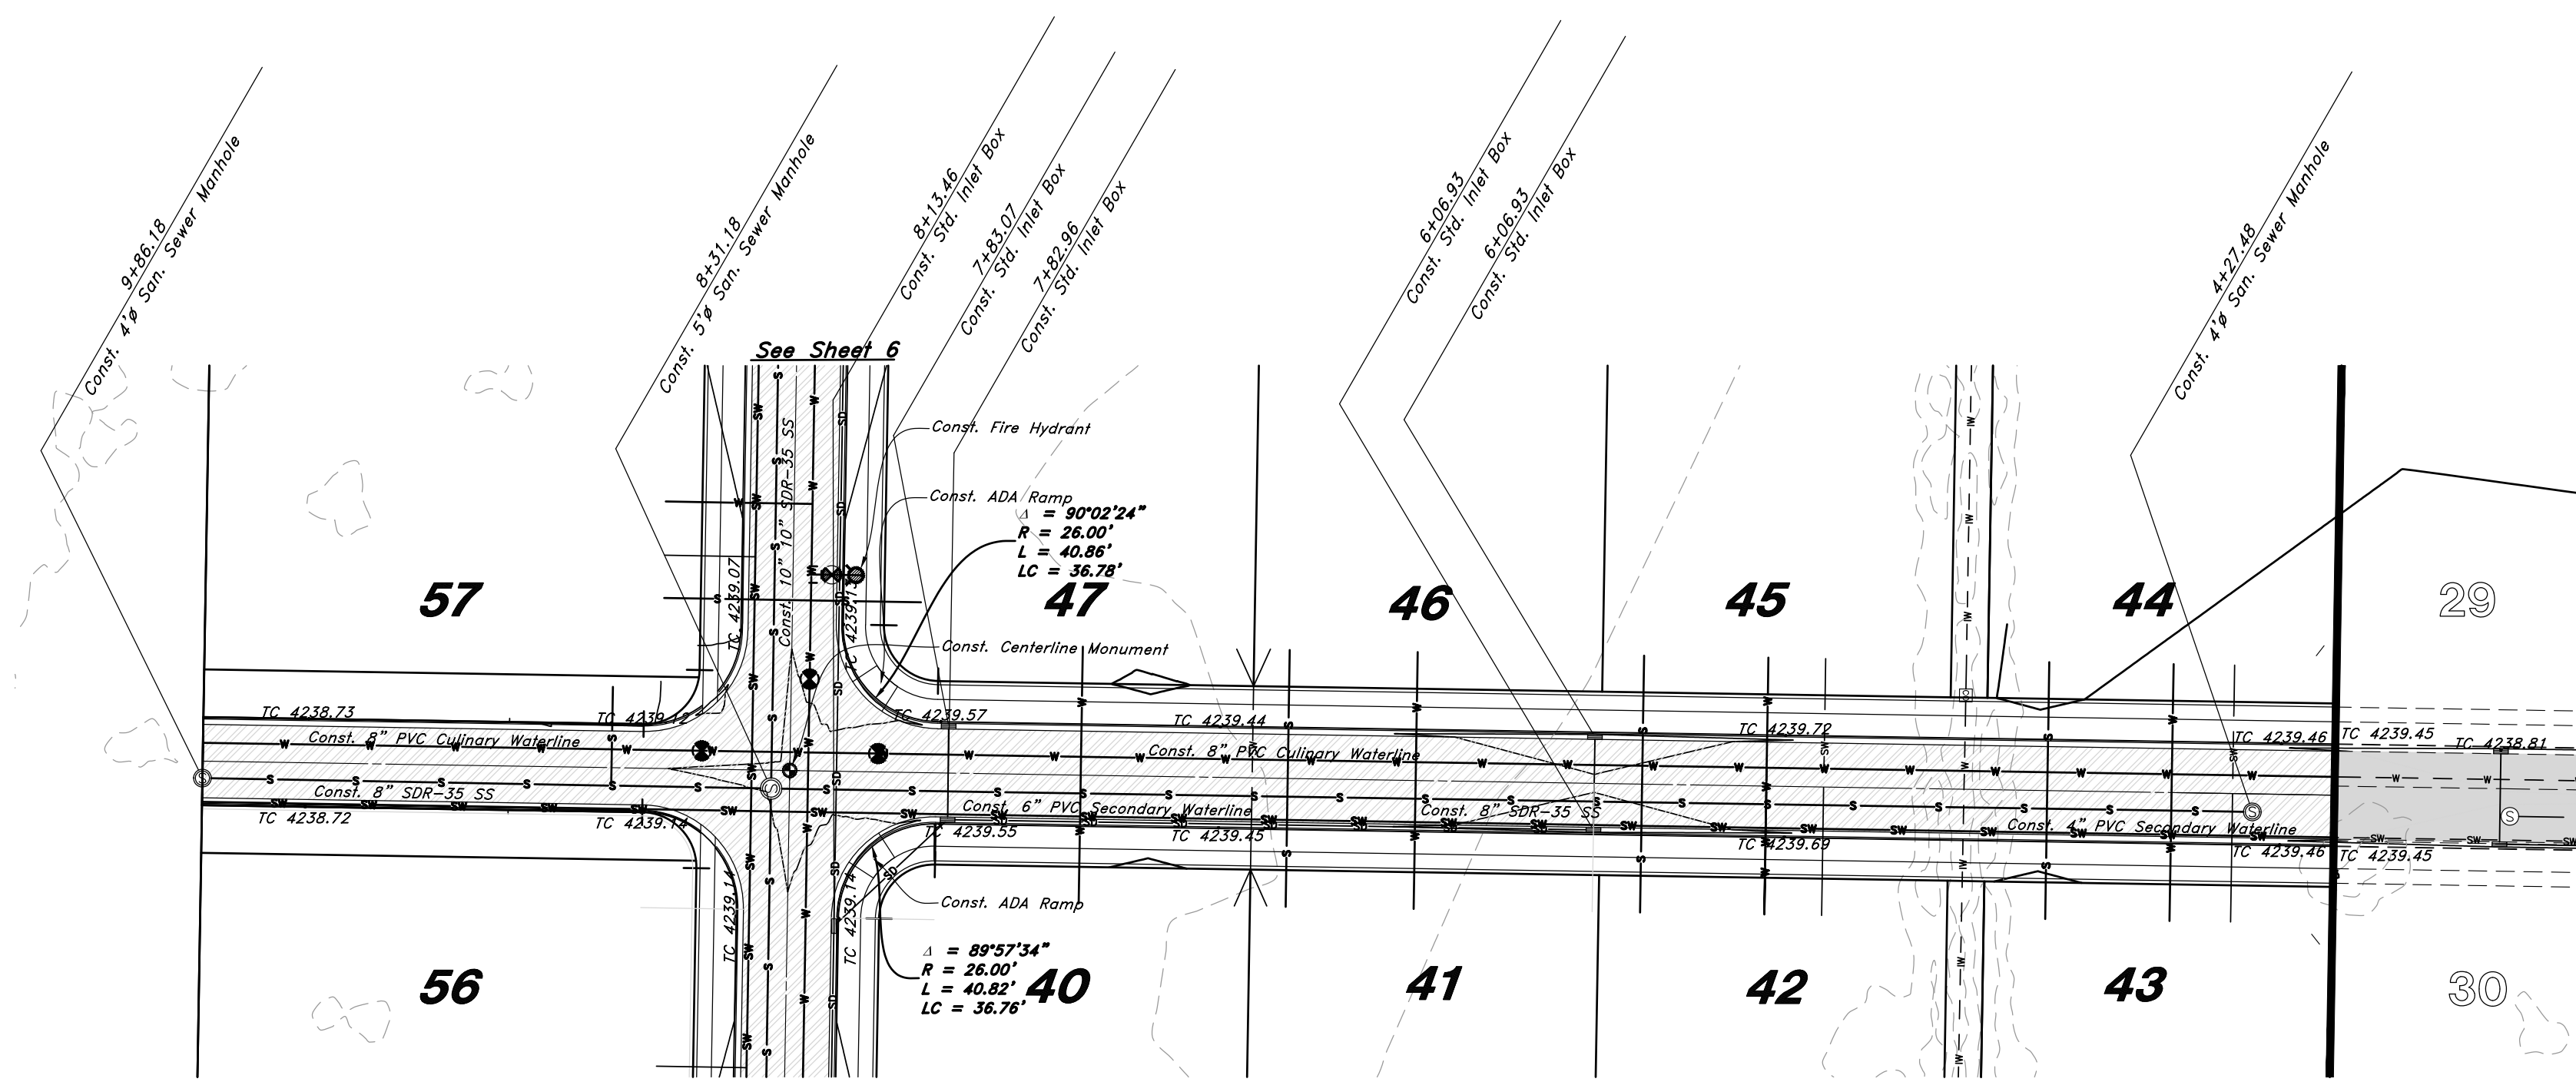
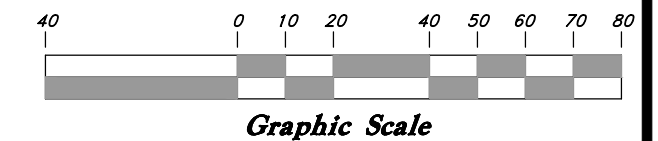
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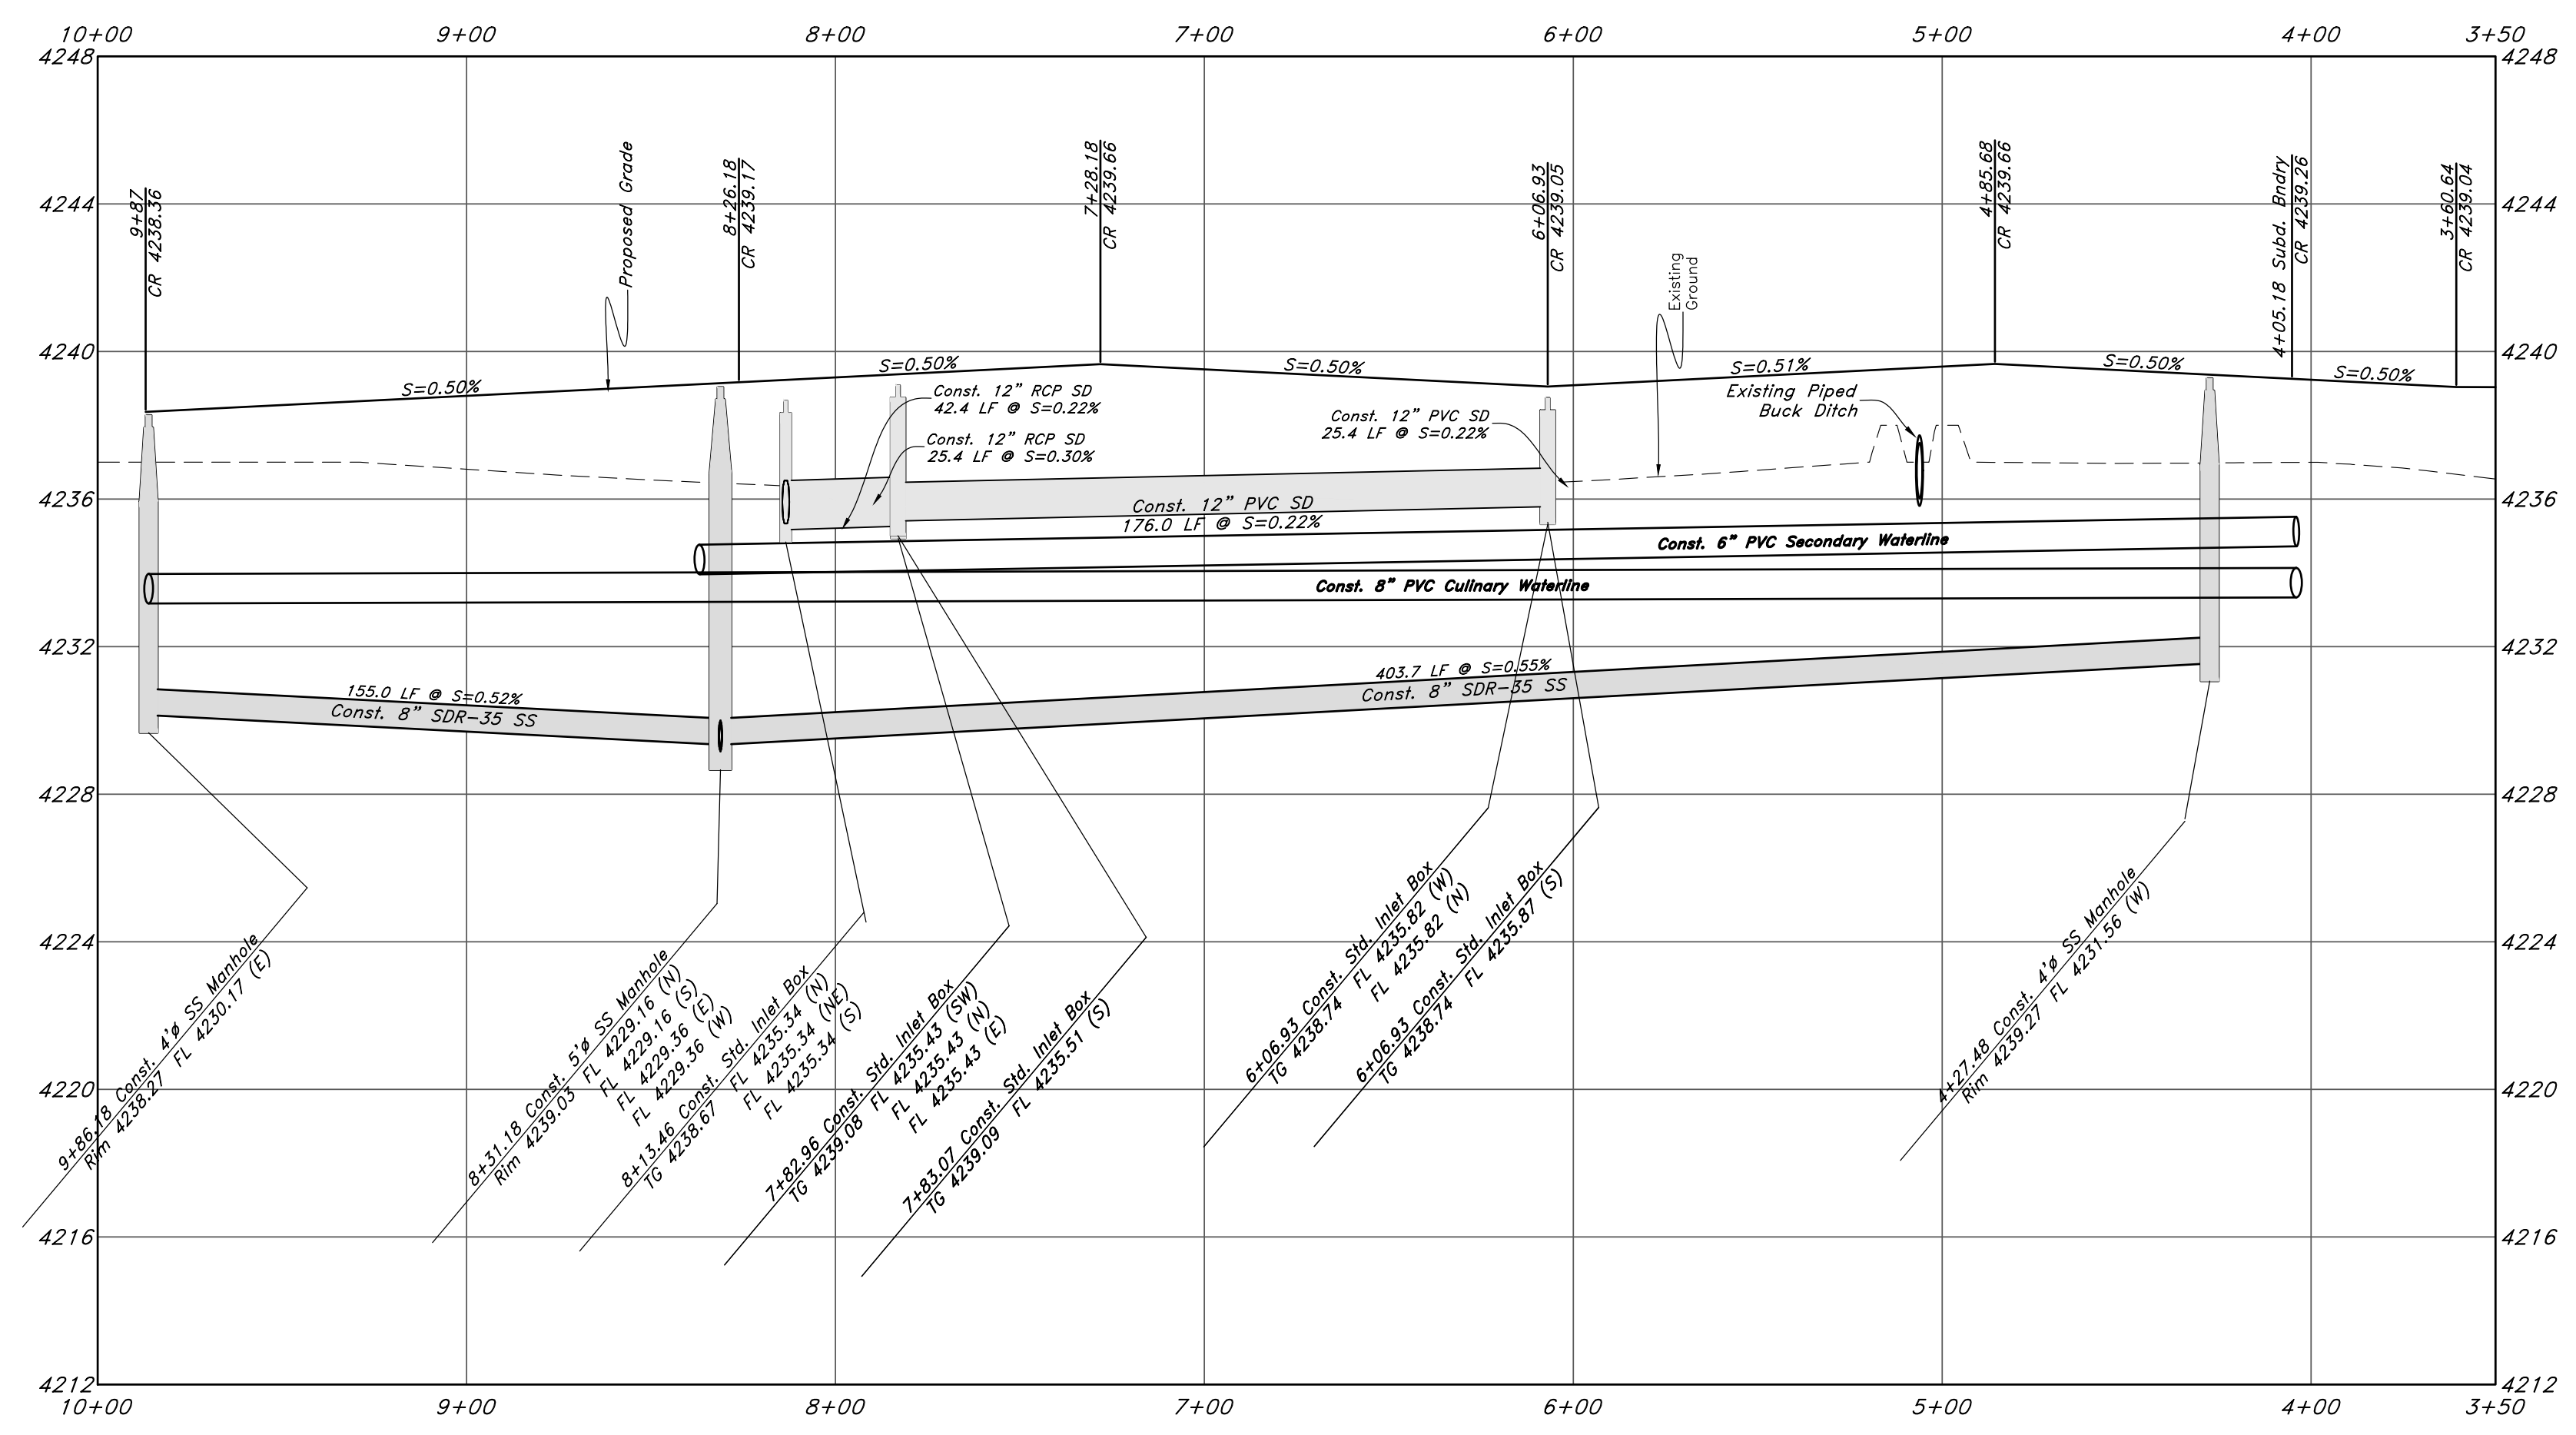
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- New Asphalt
- Heavy Duty Asphalt
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Scale:
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850 South Street



NO.	DESCRIPTION	DATE	REV

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Plan and Profile
The Barn at Terakee Farms 2
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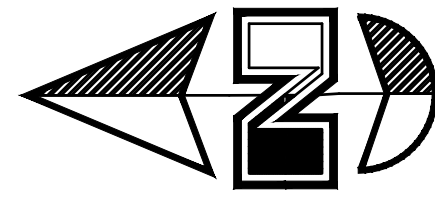
23 Sep, 2021
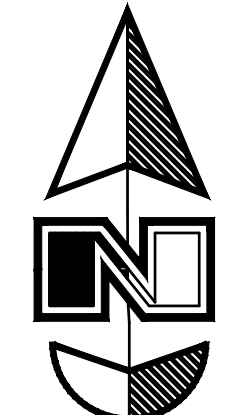
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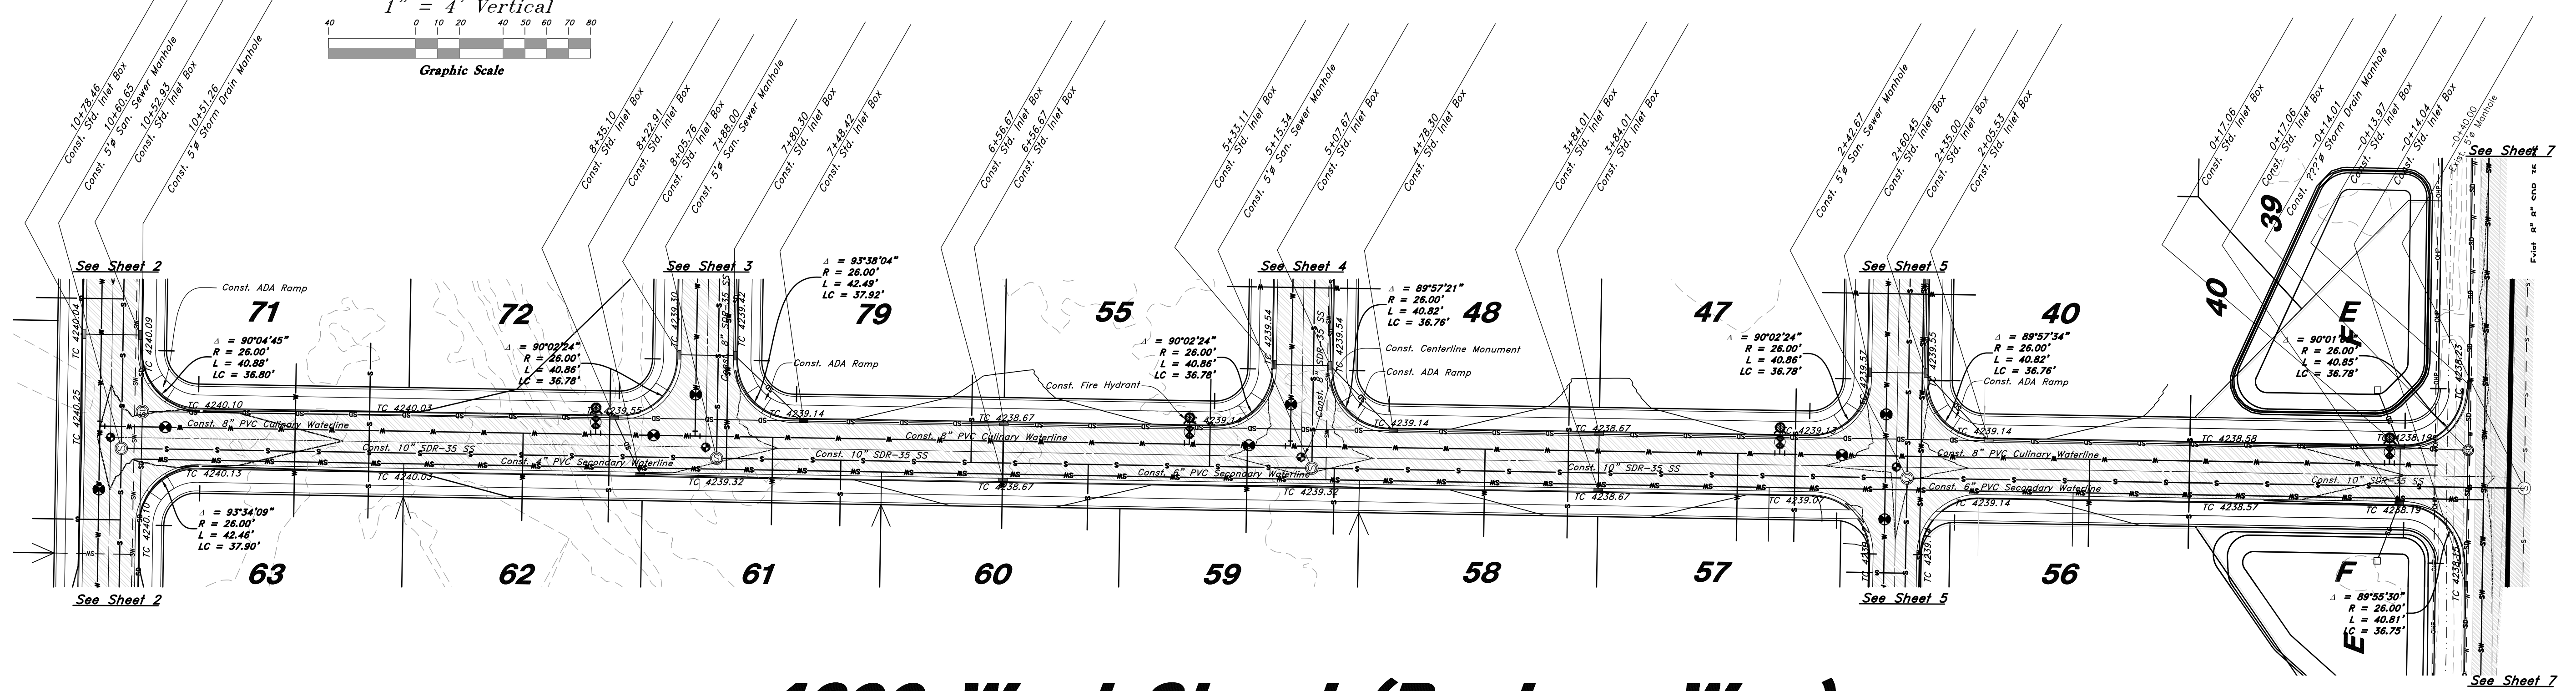
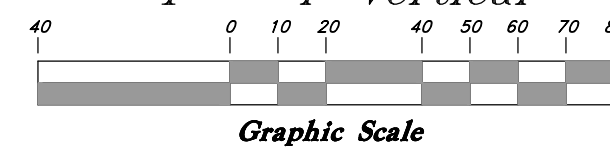
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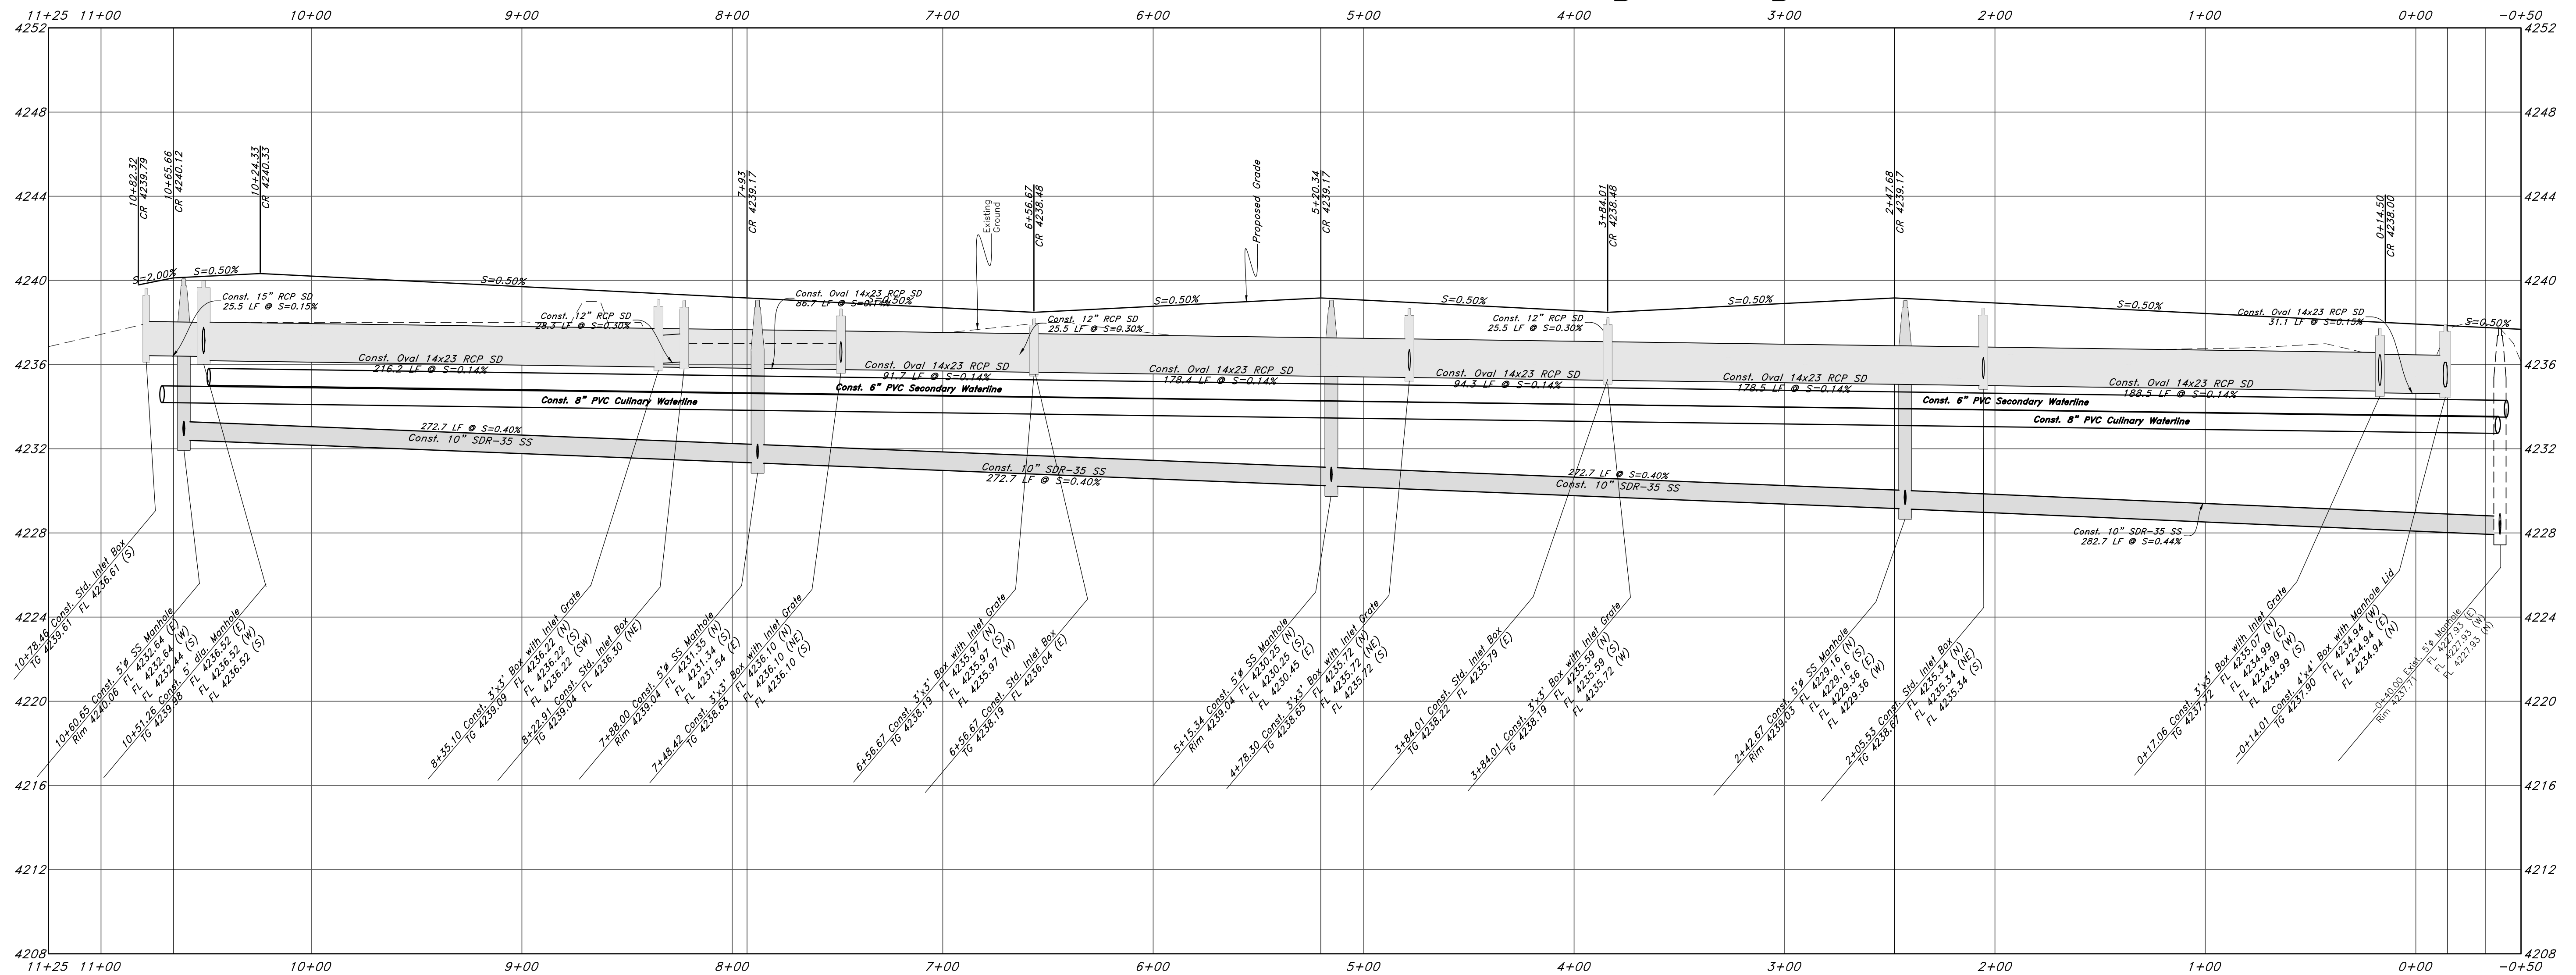
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Scale:
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1" = 4' Vertical



4600 West Street (Bootney Way)



REV	DATE	DESCRIPTION

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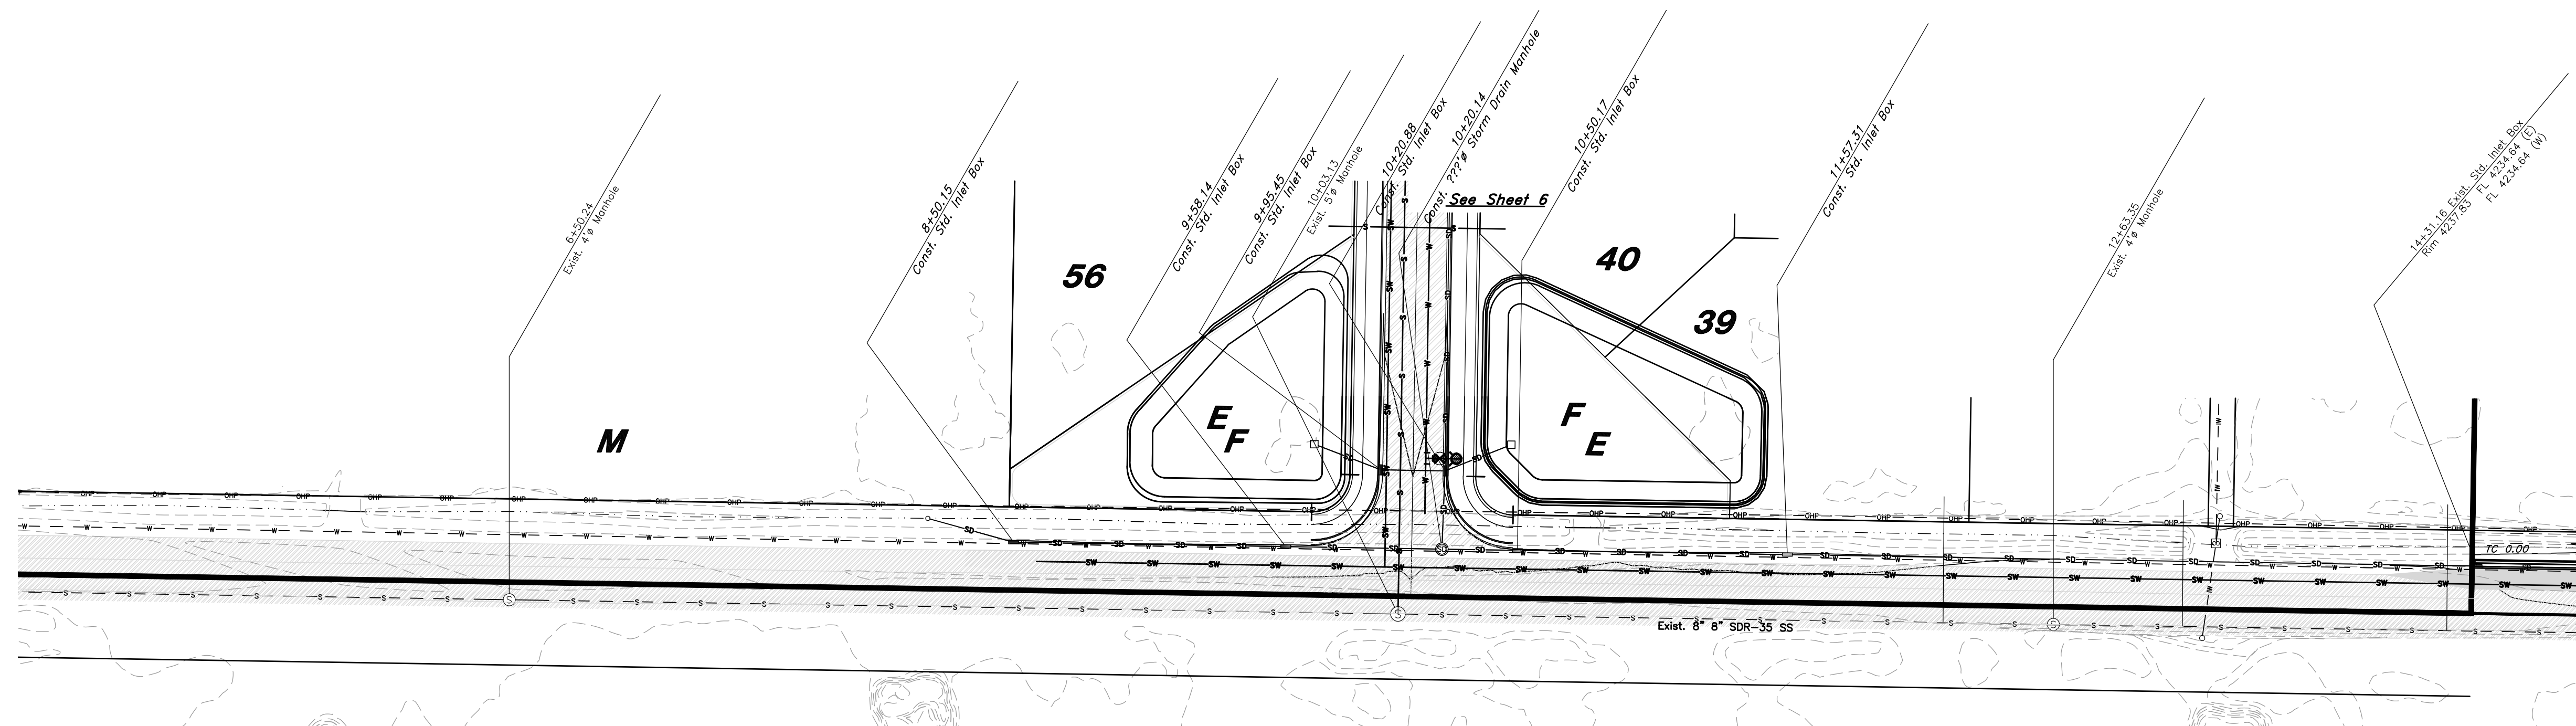
Plan and Profile

The Barn at Terakee Farms 2

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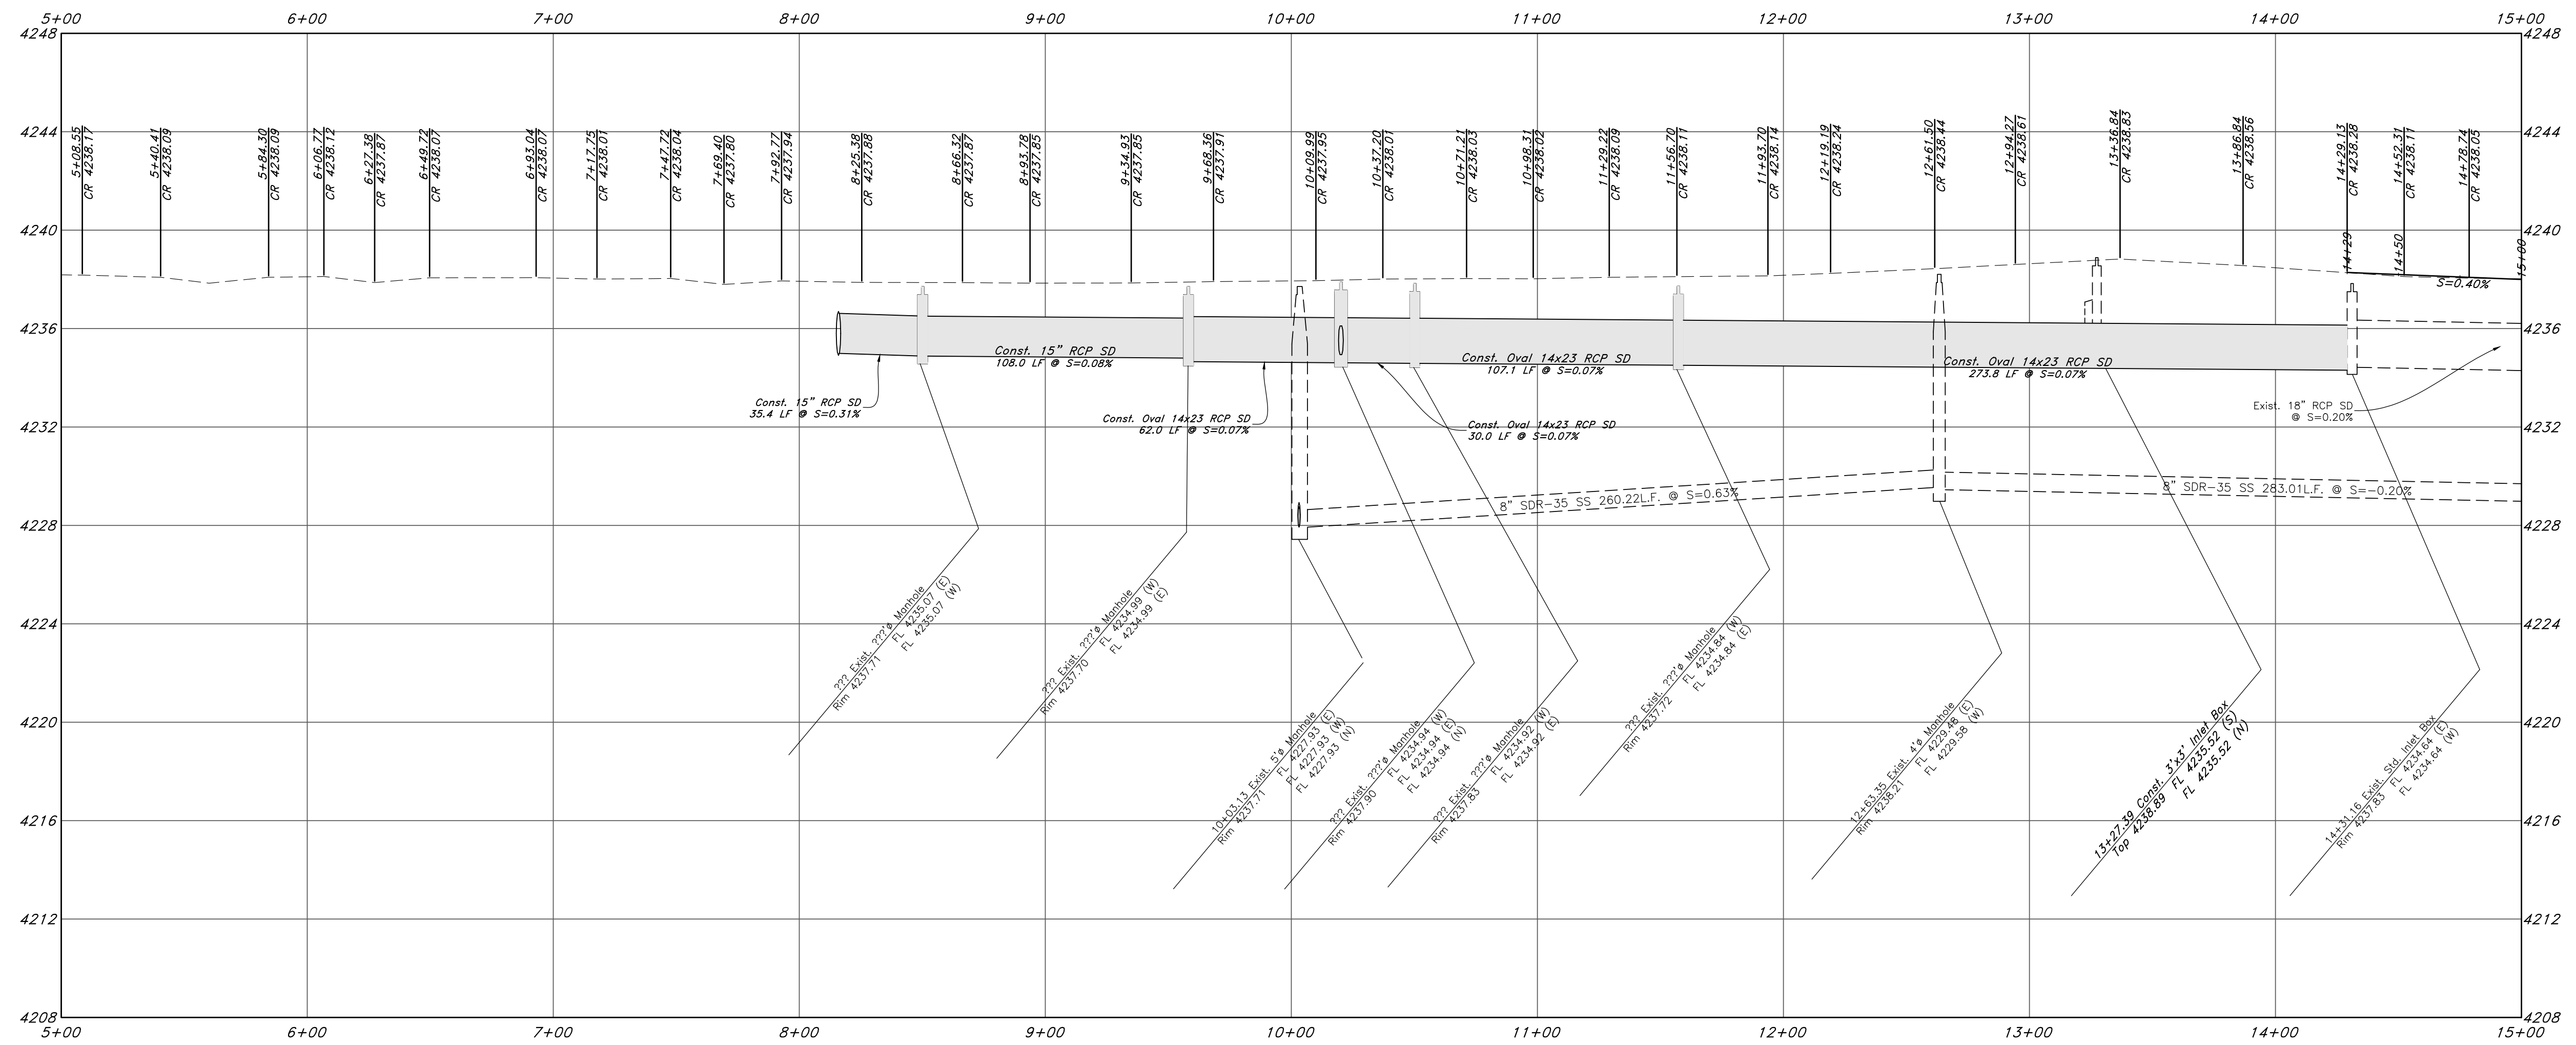
23 Sep, 2021
 SHEET NO.
C6
 16N719

NOT FOR CONSTRUCTION



NOTES:
 Parcel M is an Agricultural Parcel
 and no curb and gutter will be installed
 along its frontage at this time

900 South Street



NOT FOR CONSTRUCTION

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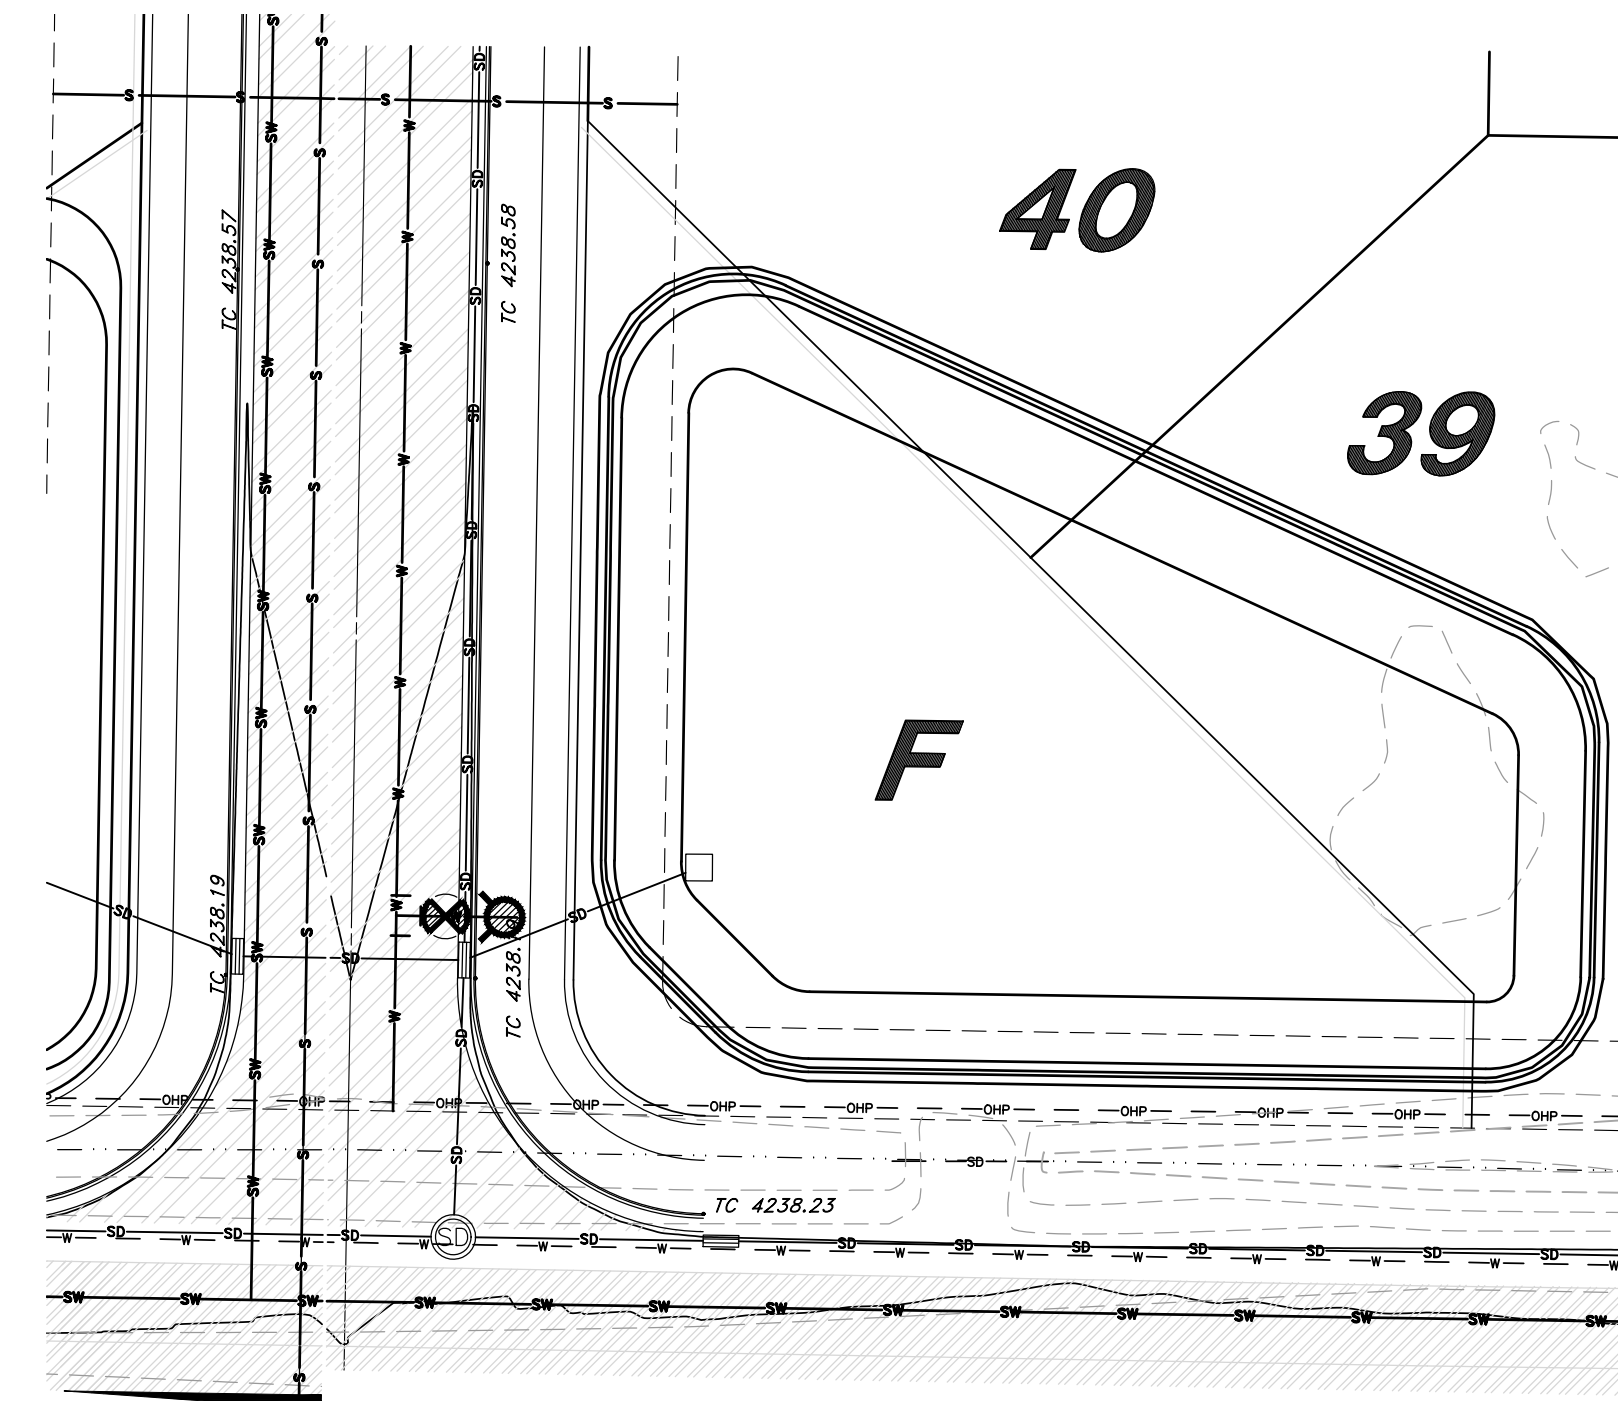
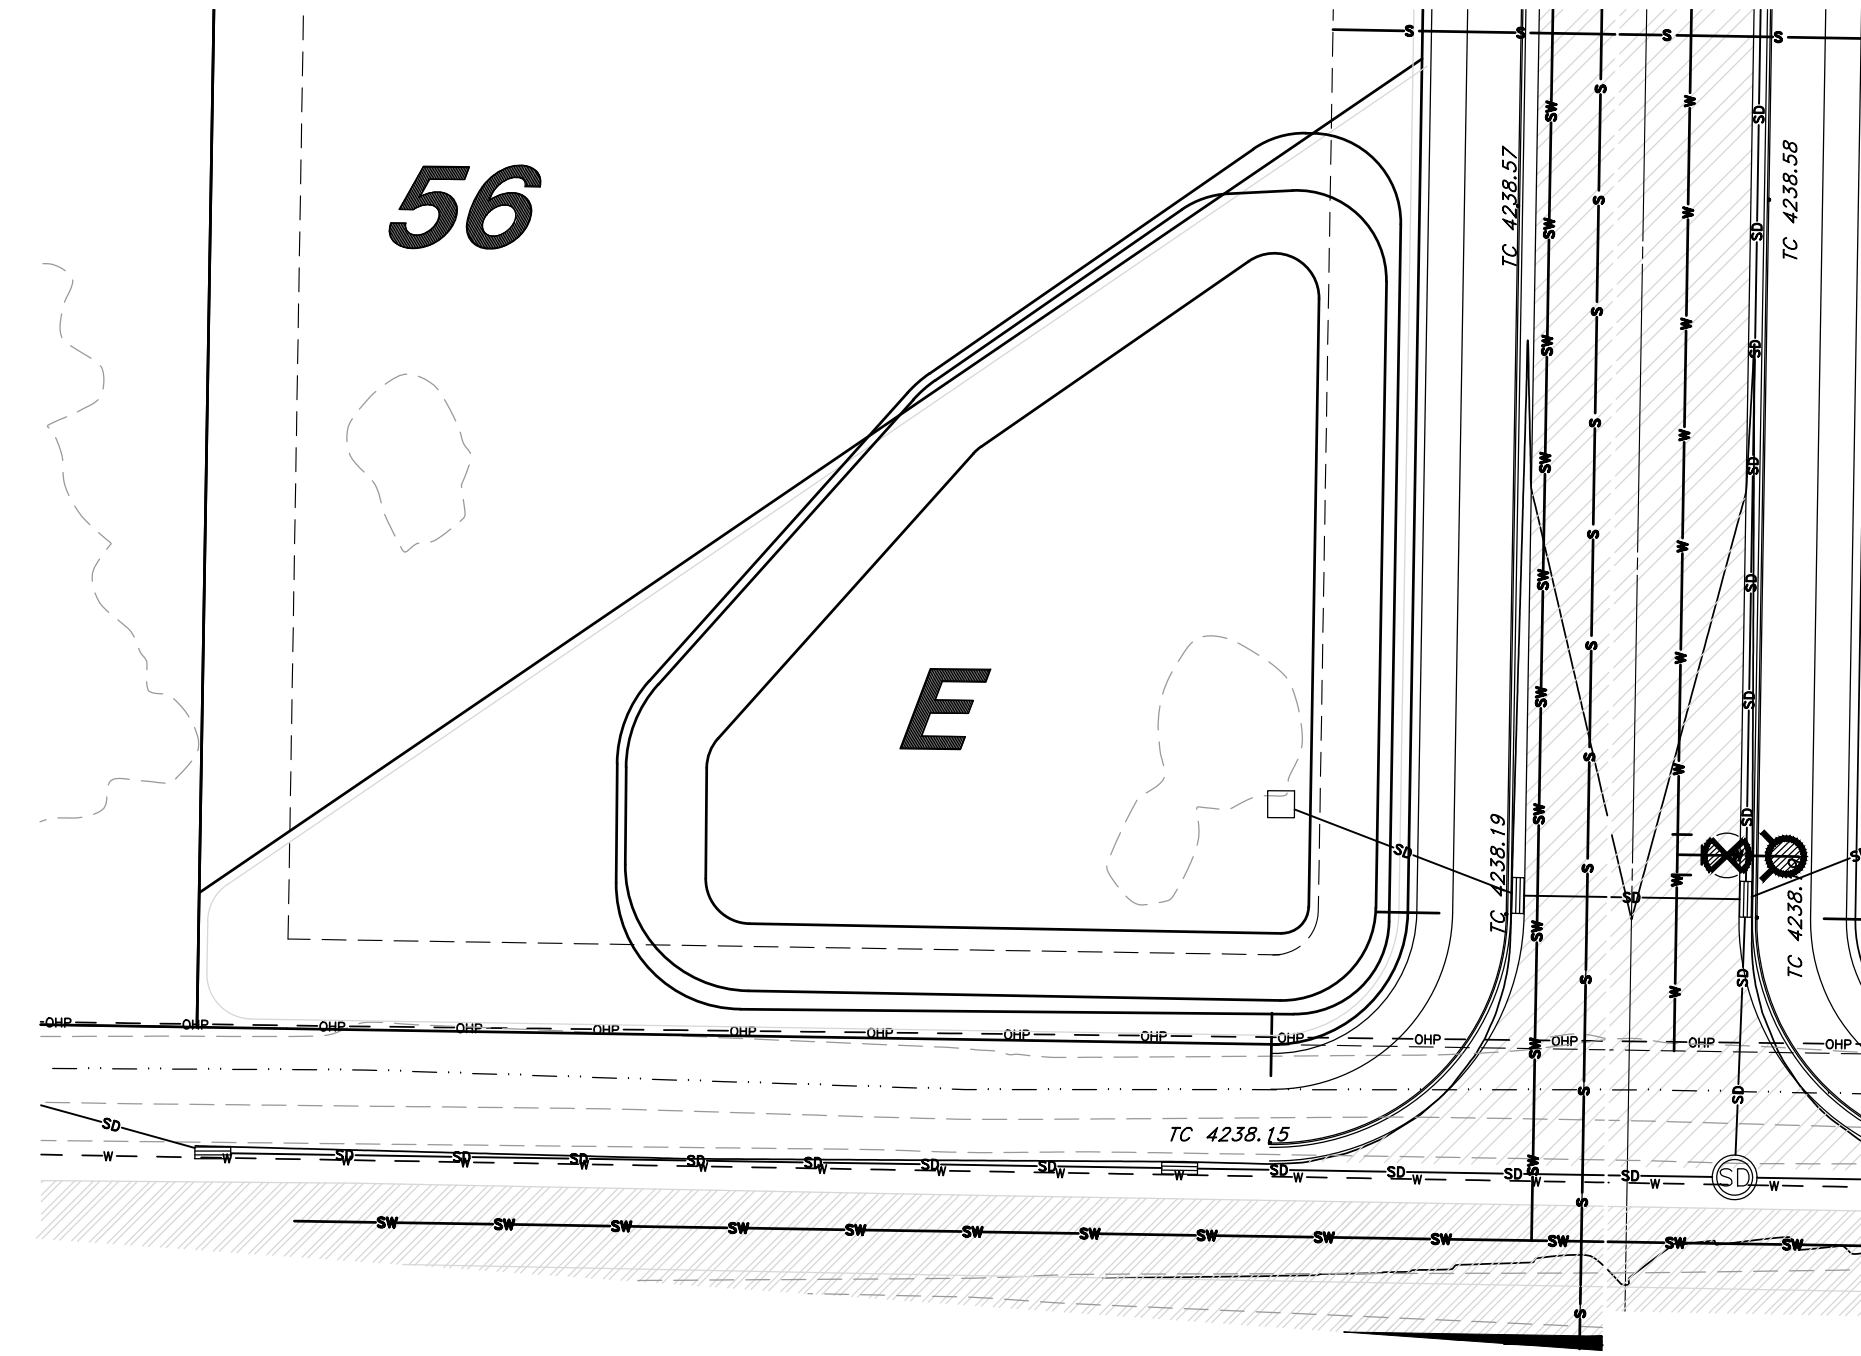
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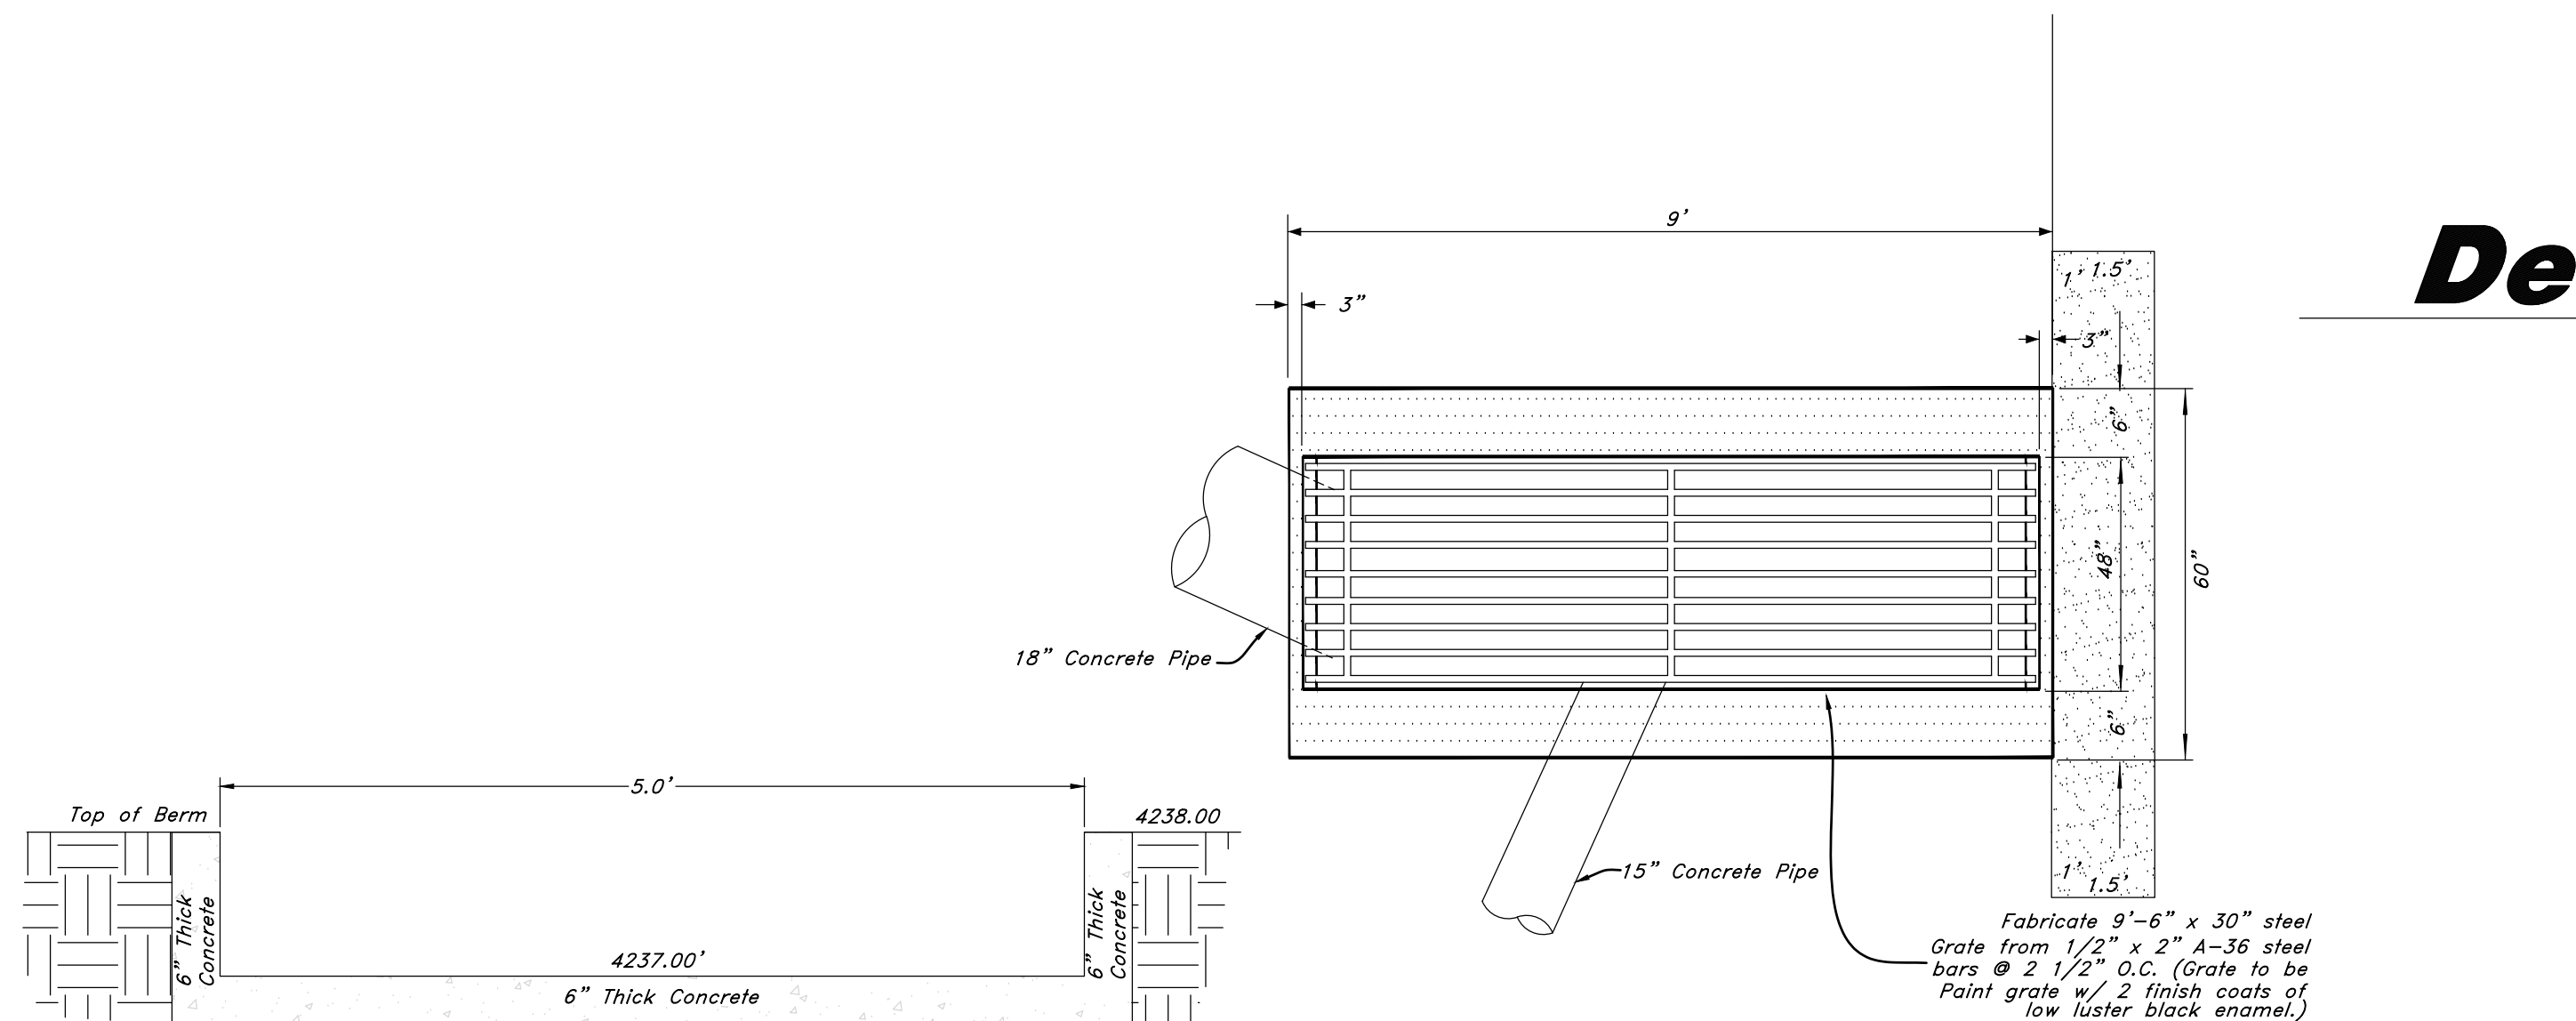
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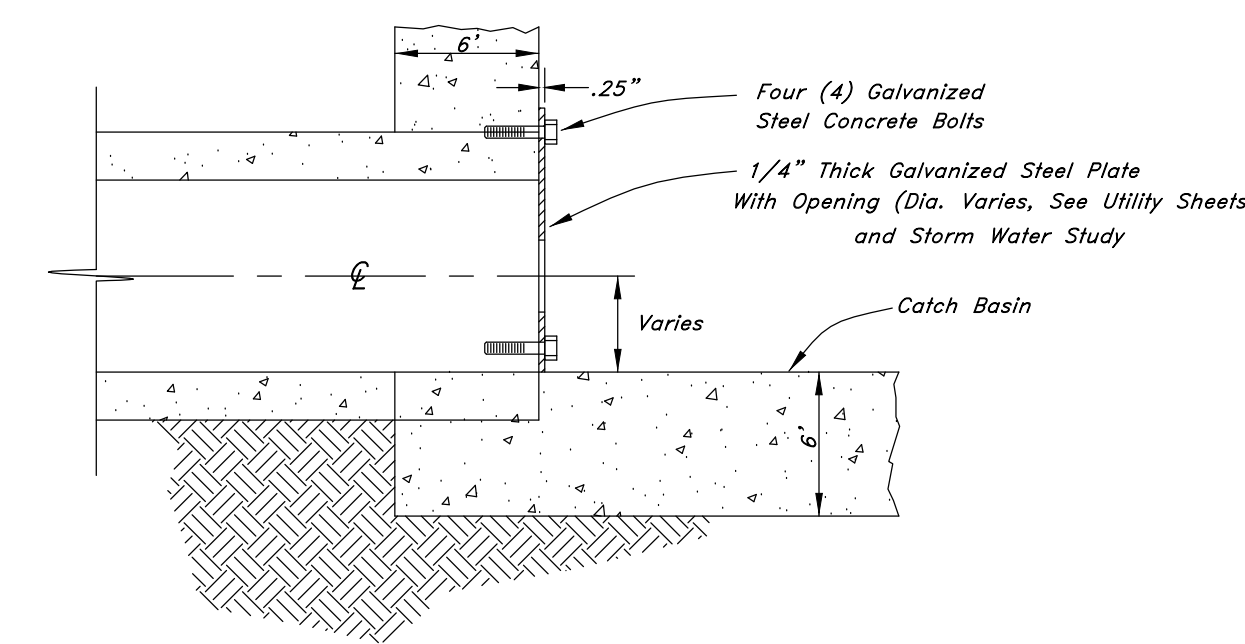
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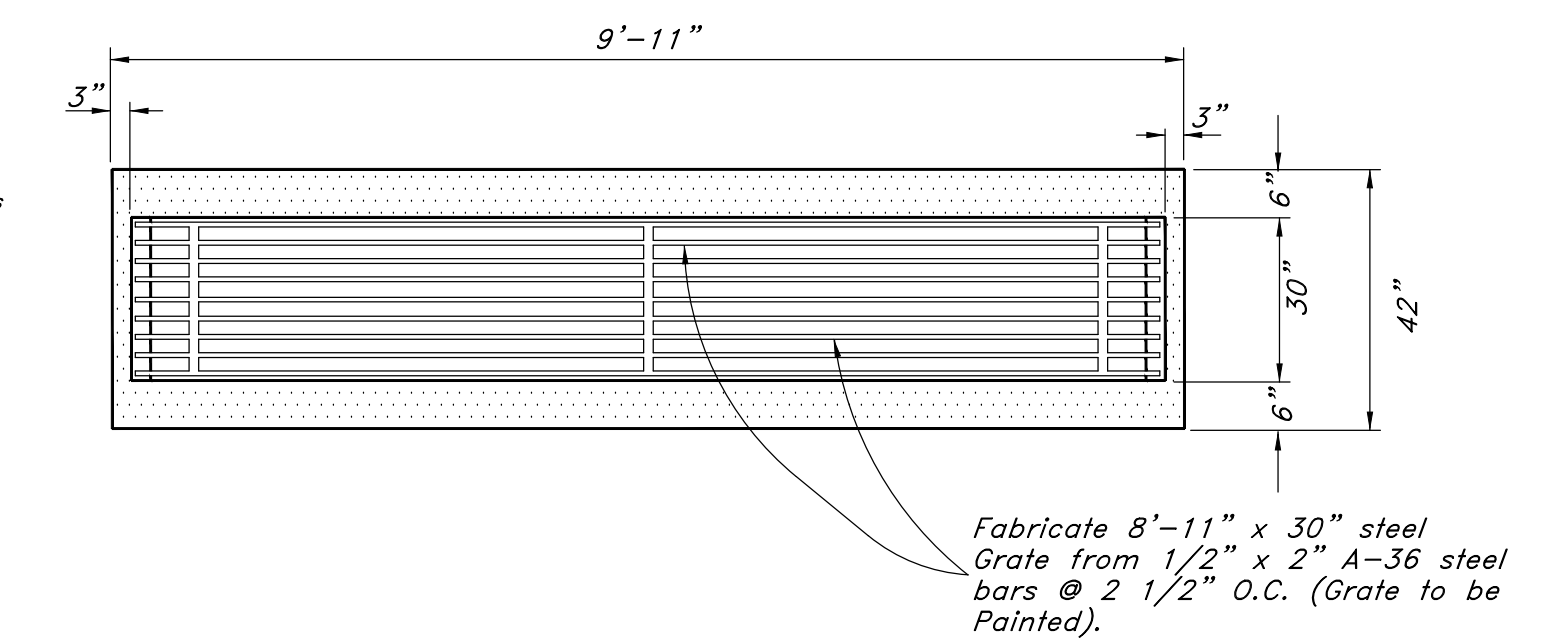
Detention Pond




Plan View Detail of Inlet / Outlet Structure




Orifice Plate Detail





Plan View Detail of Inlet / Outlet Structure

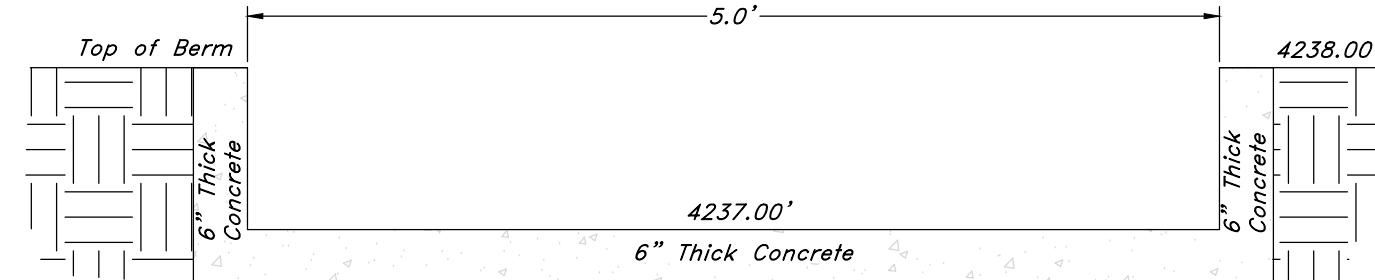

Emergency Spillway Detail

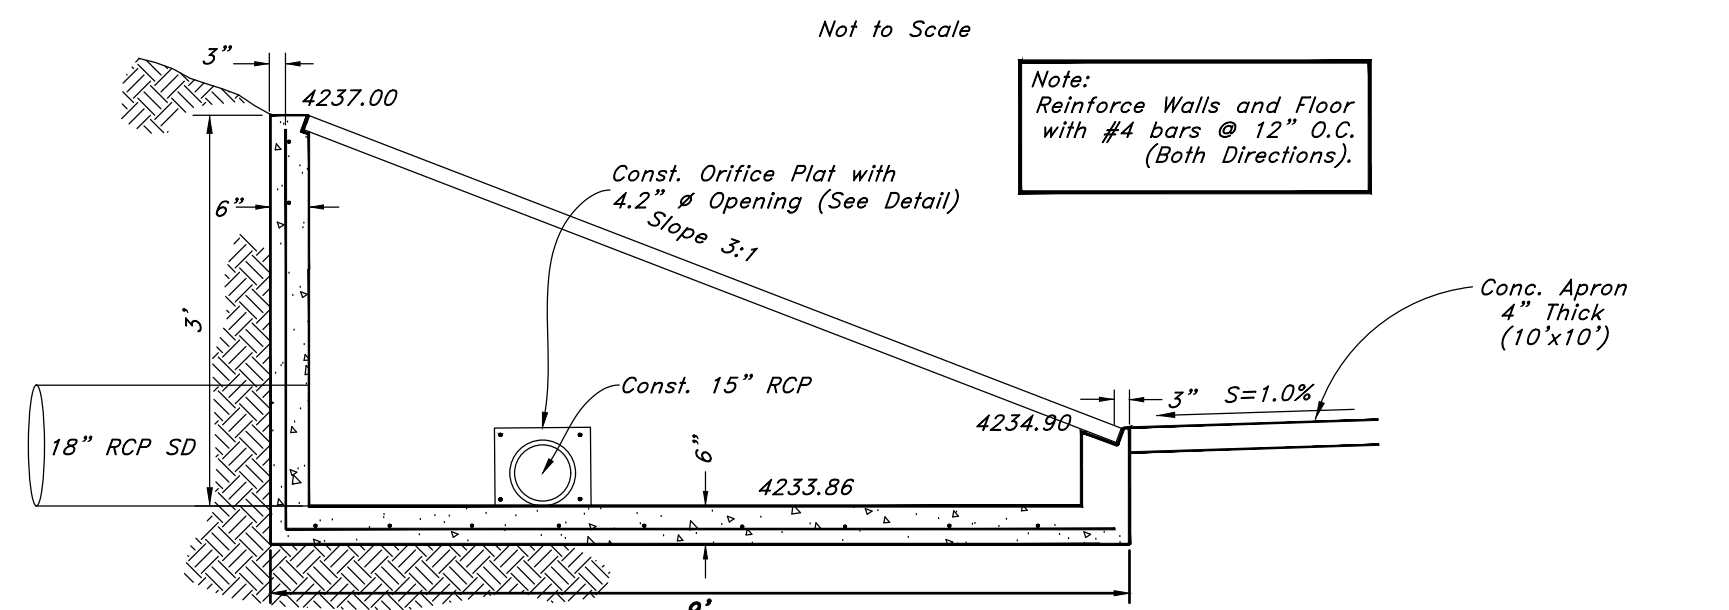

Profile View Detail of East Inlet / Outlet Structure

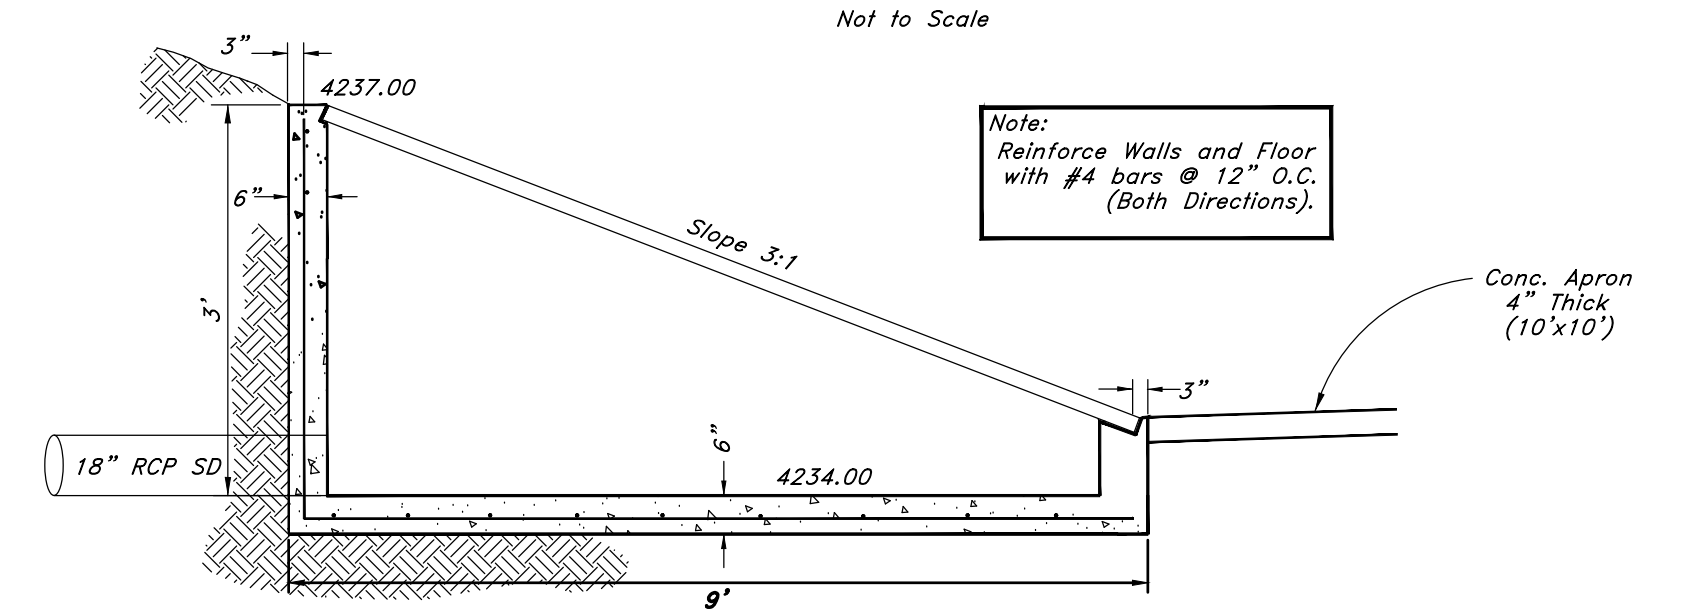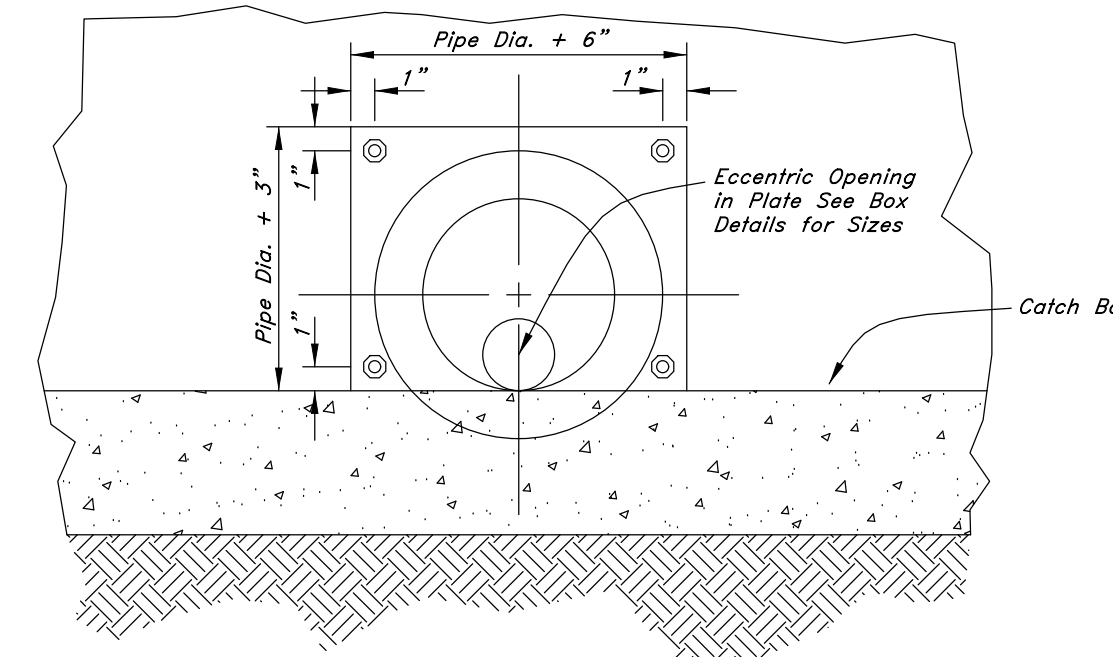

Profile View Detail of West Inlet / Outlet Structure

REV	DATE	DESCRIPTION

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NOT FOR CONSTRUCTION

Call before you Dig
 Avoid cutting underground utility lines. It's costly.

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