BUILDING NUMBER: 49174



FINISH SCHEDULE
NO FINISH SCHEDULE REQUIRED. BUILDING SHALL HAVE STANDARD EXPOSED AGGREGATE FINISH.

	STRUCTURAL CONTRACTION							
	STRUCTURA ON D. ANDERSON 9824959-2203					1	THESE PLANS ARE THE CONFIDENTIAL PROPERTY AND TRADE SECRETS OF FIBREBOND CORPORATION. ANY USE OF THESE	
	9824959-2203						DRAWINGS OR THE INFORMATION CONTAINED HEREIN FOR ANY REASON OTHER THAN AS EXPRESSLY	
d	$(\lambda \lambda \lambda \lambda)$	-					AUTHORIZED BY FIBREBOND CORPORATION IS STRICTLY PROHIBITED. THESE DRAWINGS HAVE BEEN	
	STATE OF UT MISS						OTHERWISE OBTAINING	BY: GD
	~~~~~~~~~~~~~~~~~~~~~~~~~~~~~~~~~~~~~~~	REV.	BY	DATE	REVISION	APP.	POSSESSION OF THEM WILL BE EXPRESSLY NOTIFIED OF THEIR CONFIDENTIAL NATURE	^{CHK.} ^{BY:} JC

# **DESIGN: D11401**

1300 DAVENPORT DRIVE, MINDEN, LA 71055 ph. (800) 824-2614 www.fibrebond.com						REE	зоир
ALL WEST COMMUNICATIONS						d for: PROVA	L A.01*
12' - 0" X 16' - 0" BUILDING					A	PPROVAL DATAE	
BUILDING COVERSHEET						ANGLE ECTION	$\oplus$
)	DATE: 21-DEC-2020	^{APP.} ^{BY:} <b>PM</b>	DATE:		SCALI NTS	E	SHEET NO: 49174
	DATE:	APP. BY:	DATE:		SIZE B	DWG NO.:	011401

## INDEX OF SHEETS

SHEET#	DESCRIPTION	REV.	SHEET#	DESCRIPTION	REV.
1-0	INDEX OF SHEETS	A.01	3-3	ELEVATION, INTERNAL, WALL-B, GROUNDING	A.01
1-1	MANUFACTURED BUILDING DATA SHEET	A.01	3-4	ELEVATION, INTERNAL, WALL-C, GROUNDING	A.01
1-2	BUILDING WEIGHT, C.G, LIFTING, STORAGE & TRANSPORTATION	A.01	3-5	ELEVATION, INTERNAL, WALL-D, GROUNDING	A.01
1-3	BUILDING NOTES	A.01	3-6	HALO GROUNDING DETAILS	A.01
2-1A	BUILDING INSULATION DETAILS	A.01	4-1	FOUNDATION PLAN	A.01
2-1	FLOOR PLAN	A.01	5-1	ELECTRICAL SCHEMATIC #1	A.01
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2-4	ELEVATION, EXTERNAL, WALL-C	A.01	6-1	STRUCTURAL LAYOUT, ROOF	A.01
2-5	ELEVATION, EXTERNAL, WALL-D	A.01	6-2	STRUCTURAL LAYOUT, FLOOR	A.01
2-6	ELEVATION, INTERNAL, WALL-A	A.01	6-3	STRUCTURAL LAYOUT, SIDE PANEL-A	A.01
2-7	ELEVATION, INTERNAL, WALL-B	A.01	6-4	STRUCTURAL LAYOUT, END PANEL-B	A.01
2-8	ELEVATION, INTERNAL, WALL-C	A.01	6-5	STRUCTURAL LAYOUT, SIDE PANEL-C	A.01
2-9	ELEVATION, INTERNAL, WALL-D	A.01	6-6	STRUCTURAL LAYOUT, END PANEL - D	A.01
2-10	CEILING VIEW, ELECTRICAL	A.01	6-7	STRUCTURAL ROOF SECTION DETAILS	A.01
2-11	CEILING VIEW, CABLE RACK, FIBER RACK	A.01	6-8	STRUCTURAL FLOOR SECTION DETAILS	A.01
2-11.1	CABLE RACK & FIBER RACK DETAILS	A.01	6-9	STRUCTURAL WALL SECTION DETAILS	A.01
3-1	CEILING VIEW, GROUNDING	A.01	6-10	STRUCTURAL MISC. DETAILS	A.01
3-2	ELEVATION, INTERNAL, WALL-A, GROUNDING	A.01	8-1 & 8-2	BILL OF MATERIALS	A.01

## **REFERENCED DRAWINGS:**

DWG NO	REV	SHEET DESCRIPTION
ELEC-0103	0	ICM T-STAT - MARVAIR A/C UNIT W/ OR W/O ECONOMIZERS
MECH-0005	4	STANDARD CABLE RACK MOUNTING DETAILS

	STRUCTURA STRUCTURA ON D. ANDERSO 9824959-2203						THESE PLANS ARE THE CONFIDENTIAL PROPERTY AND TRADE SECRETS OF	
	9824959-2203						FIBREBOND CORPORATION. ANY USE OF THESE DRAWINGS OR THE INFORMATION CONTAINED HEREIN FOR ANY REASON OTHER THAN AS EXPRESSLY AUTHORIZED BY FIBREBOND	
2	STATE OF UT NY SCA						CORPORATION IS STRICTLY PROHIBITED. THESE DRAWINGS HAVE BEEN DISTRIBUTED WITH THE UNDERSTANDING THAT ANYONE RECEIVING OR OTHERWISE OBTAINING	DRN. BY: GD
	COCCOCCOSO DI	REV.	BY	DATE	REVISION	APP.	POSSESSION OF THEM WILL BE EXPRESSLY NOTIFIED OF THEIR CONFIDENTIAL NATURE	^{CHK.} JC

1300 DAVENPORT DRIV ph. (800) 824-2614 ww	:IB	REE	воир			
ALL WEST COM		d for: PROVA	L A.01*			
12' - 0" X 16' - 0" BUILDING					PPROVAL DATAE	
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DATE: 19-NOV-2020	^{APP.} ^{BY:} PM	DATE:		SCAL NTS	E	SHEET NO: 1-0
DATE:	APP.	DATE:		SIZE	DWG NO .:	
	BY:			В	D1	1401

### **GENERAL DESIGN NOTE**

/1 This is an unmanned storage and equipment shelter only.

2 Shelter f'c = 5000psi @ 28 days.

/3 Per IBC 2012 Table 705.8 any wall w/10% or less of unprotected openings may utilize a setback greater than 5'-0". Any wall w/15% or less of unprotected openings may utilize a setback greater than 10'-0". Any wall w/25% or less of unprotected openings may utilize a setback greater than 15'-0". Any wall w/45% or less of unprotected openings may utilize a setback greater than 20'-0". Any wall w/70% or less of unprotected openings may utilize a setback greater than 25'-0".

4 All items noted as "FIELDWORK" shall be installed and tested at the factory then removed for transport and reinstalled at the final site.

5 Model may be built as "mirror image".

 $\sqrt{6}$  Door swing and waveguide location may change due to site requirements.

 $\sqrt{7}$  Building shall be placed on a foundation supplied by others.

8 Building not designed for installation in a flood prone area. 9 Fire extinguisher installed by others when not supplied by

Fibrebond. 10 Electrical components shown per customer's design

requirements.

11 This building does not contain plumbing facilities. Plumbing facilities shall be provided on site subject to the local authority having jurisdiction

	NON-RATED	1 HOUR	2 HOUR
CONCRETE THICKNESS (INCHES)	2"	2.5"	4"
-ALL VALUES FOR LIGHT WEIGHT -TABLE 719.1(2) - 4-1.1 (IBC 2012) -TABLE 720.1(2) - 4-1.1 (IBC 2012)	CONCRETE		


STRUCTURAL DESIGN BY: ANDERSON STRUCTURAL GROUP, INC. SACRAMENTO,CA PHONE: 916-514-9109


CODE COMPLIANCE NEEDS TO BE PER THE 2018 INTERNATIONAL BUILDING CODE,2018 IMC,2018 IFGC AND THE 2020 NATIONAL ELECTRICAL CODE AS ADOPTED AND AMENDED BY THE STATE OF UTAH. PLEASE UPDATE TO SHOW COMPLIANCE AND HAVE THE ENGINEER OF RECORD UPDATE AND DATE HIS SEAL PER STATE STATUTE.

## 

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2012
2011
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2009
1.2, USE

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## **GROUNDING NOTES:**
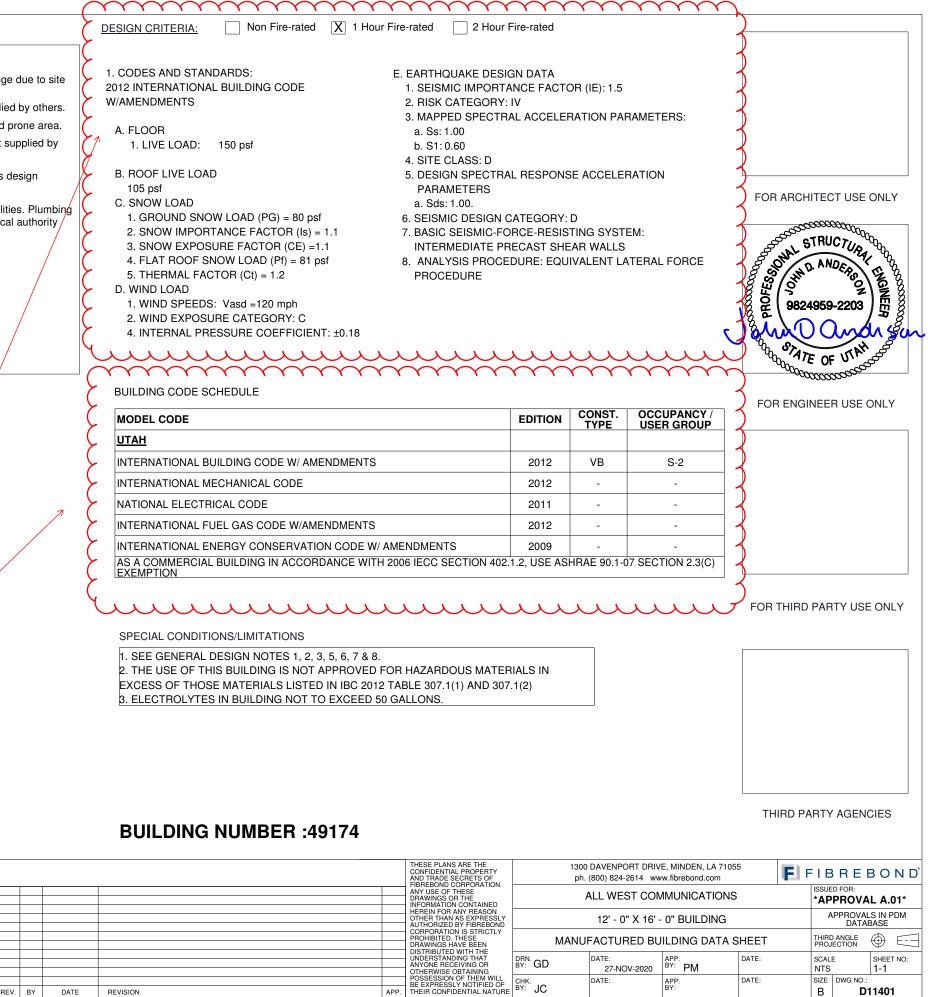
### **GENERAL ELEVATION NOTES:**

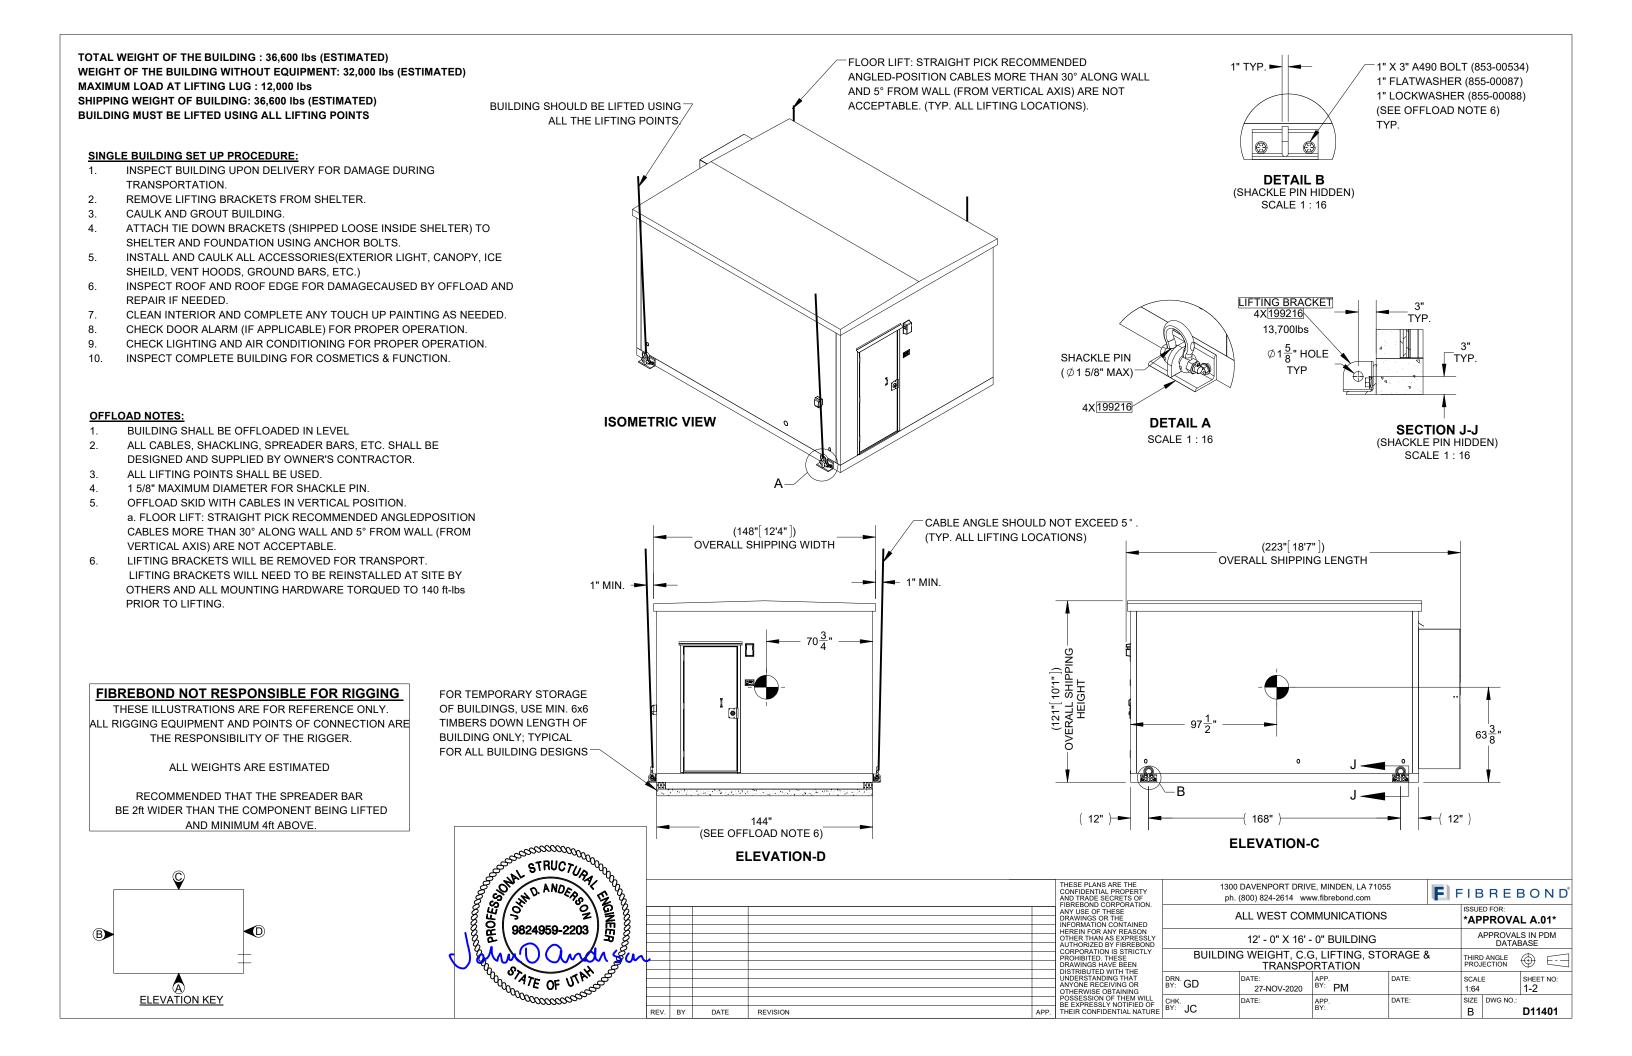1. ALL ITEMS MARKED FIELD WORK SHALL BE INSTALLED, TESTED, REMOVED & PACKED IN BUILDING PRIOR TO SHIPMENT.

2. ALL DOOR CLOSERS SHALL BE SET TO 90°

3. UNLESS OTHERWISE SPECIFIED, ALL PROJECTED VIEWS ARE THIRD ANGLE PROJECTION.

### **CABLE TRAY NOTES:**

CT1. BOTTOM OF THE CABLE TRAY TO BE MOUNTED 96" ABOVE FINISHED FLOOR

CT2.ALL CABLE TRAYS MEASUREMENTS ARE ACCURATE WITHIN +/- 1/4"

CT3. UNISTRUT MEASUREMENTS ARE ACCURATE WITHIN 2" WHEN MOVEMENT IS REQUIRED TO MISS TRIM, CABLE TRAY RUNGS, ETC. CONSIDERATION OF THE PREVIOUS UNISTRUT MOVEMENT SHOULD BE TAKEN INTO ACCOUNT.

CT4. UNISTRUTS MAY HAVE THEIR MEASUREMENT VARIED BY16" WITH NO MORE THAN 48" BETWEEN UNISTRUTS. PARAMETERS FOR MOVING THE UNISTRUT ARE AS FOLLOWS: LIGHTS, CONDUIT, ELECTRICAL BOXES.RACEWAYS AND VARIOUS EQUIPMENT MOUNTED ON CABLE RACK THAT ARE IN THE WAY. INCOMPATIBLE PRINT LAYOUTS ARE ALSO A PARAMETER FOR MOVEMENT.

CT5. CABLE TRAY MAY BE MOVED, IF APPROVED BY ENGINEERING, WHEN ITEMS ALREADY MOUNTED, SUCH AS CONDUIT, BOXES, LIGHTS, WIRE WAY, ETC., INTERFERE WITH THE MEASUREMENT ON THE PRINT.

CT6. THE POSITIONS FOR THE CABLE TRAY SPLICERS THAT ARE SHOWN ON THE PRINT ARE FOR ILLUSTRATION. THE BEST POSITION SHOULD BE DETERMINED WHEN LAYING OUT THE CABLE TRAY IN THE BUILDING TO GET THE OPTIMUM USE OF THE CABLE TRAY.

CT7. CABLE TRAY INSTALLATION TO BE IN ACCORDANCE WITH LATEST ADOPTED NEC, ARTICLE 392.18.

CT8. CABLE TRAY GROUNDING TO BE IN ACCORDANCE WITH LATEST ADOPTED NEC. ARTICLE 392.60.

### **CONDUIT NOTES:**

### C1. ALL MEASUREMENTS SHOWN ARE ACCURATE WITHIN ±1/4". ALL ADJACENT BOXES SHALL BE THE SAME DIMENSION.

C2: THE LOCATIONS OF NON-CRITICAL ITEMS MAY BE ADJUSTED AS DEFINED BELOW. ALL ADJACENT BOXES SHALL BE THE SAME DIMENSION.

PULL BOXES OF ANY SIZE:	(HORIZONTAL ±3", VERTICAL ±3")
LIGHT SWITCHES:	(HORIZONTAL ±3", VERTICAL PER NOTE C1)
INTERIOR & EXTERIOR RECEPTACLES	S: (HORIZONTAL ±3", VERTICAL PER NOTE C1)
FIRE SAFETY DEVICES:	(HORIZONTAL ±3", VERTICAL ±3")

THERMOSTATS: (HORIZONTAL ±3", VERTICAL ±3")

C3. CONDUIT SHOULD BE INSTALLED AS SHOWN IF POSSIBLE. ANY CHANGES TO BENDS, OFFSETS, AND SADDLES MAY BE DONE WHEN NEEDED AND SHOULD BE UNDER THE GUIDANCE OF A QUALIFIED SENIOR CREW LEADER. ANY CHANGE MUST BE WITHIN THE GUIDELINES OF THE S.O.P.

C4. ALL CONDUIT TO HAVE A MINIMUM OF 3/4" BETWEEN THEM.

C5. ALL CONDUIT TO BE 3/4" UNLESS NOTED OTHERWISE.

C6. ALL LIGHT SWITCHES TO BE MOUNTED AT 48" A.F.F. UNLESS NOTED OTHERWISE.

C7. ALL RECEPTACLES TO BE MOUNTED AT 18" A.F.F. UNLESS NOTED OTHERWISE.

C8. ALL CONDUITS INSIDE BUILDING SHALL BE EMT UNLESS OTHERWISE NOTED.

C9. ALL CONDUITS OUTSIDE BUILDING SHALL BE RIGID GALVANIZED CONDUIT UNLESS OTHERWISE NOTED.

C10. ALL CONDUITS THROUGH A WALL SHALL BE RIGID GALVANIZED UNLESS OTHERWISE NOTED.

C11. ALL INTERIOR BOXES SHOWN WITHOUT A PART NUMBER ARE ASSUMED TO BE 4"X4".

C12. NOTE REMOVED.

C13. ALL EXTERIOR NIPPLES SHALL HAVE A WEATHERPROOF SEAL & LOCKNUT.

	CONDU	JIT KEY					
A.C	LOW VOLTAGE	LFMC	PVC				
A=1/2"	AA=1/2"	LA=1/2"	XA=1/2"				
B=3/4"	BB=3/4"	LB=3/4"	XB=3/4"				
C=1"	CC=1"	LC=1"	XC=1"				
D=1 1/4"	DD=1 1/4"	LD=1 1/4"	XD=1 1/4"				
E=1 1/2"	EE=1 1/2"	LE=1 1/2"	XE=1 1/2"				
F=2"	FF=2"	LF=2"	XF=2"				
G=2 1/2"	GG=2 1/2"	LG=2 1/2"	XG=2 1/2"				
H=3"	HH=3"	LH=3"	XH=3"				
I=3 1/2"	II=3 1/2"	LI=3 1/2"	XI=3 1/2"				
J=4"	JJ=4"	LJ=4"	XJ=4"				
	LIQUID	LIQUIDTIGHT FLEXIBLE METAL CONDUIT					

5.ALL GROUNDING WIRES FOR HVAC GRILLES, BOXES, DOORS, CABLE TRAY JUMPERS, ETC, SHALL BE #6 AWG GREEN STRANDED COPPER WIRE AND A 2-HOLE LUG

6.ALL CONNECTIONS TO HALO SHOULD POINT AWAY FROM INSTALLED AIR GAP.

7.BARE COPPER CONDUCTORS SHALL NOT BE IN CONTACT WITH ANY DISSIMILAR MATERIAL. PLACE ON STANDOFFS, IF NECESSARY, TO ALLOW FOR PROPER INSTALLATION.

8.SHARP BENDS IN GROUNDING CONDUCTORS SHALL BE AVOIDED. 90° BENDS SHALL NOT BE USED.

9.ALL GROUNDING CONDUCTORS SHALL BE KEPT AS SHORT AS POSSIBLE. THE SHORTEST PRACTICAL ROUTE SHALL BE CHOSEN WITH THE LEAST AMOUNT OF BENDS AND SPLICES. USE THIS RULE AT ALL TIMES, EVEN IF ELEVATION PLAN SHOWS OTHERWISE. PLANS ARE SOMETIMES CLUTTERED AND UNCLEAR DUE TO LARGE AMOUNTS OF GROUNDING.

10.ALL CONNECTIONS TO GROUND BARS SHALL BE WITH A 2-HOLE LUG UNLESS OTHERWISE SPECIFIED.

11.ALL SOLID WIRE SHALL USE A 2-HOLE LONG BARREL LUG.

12.DO NOT GROUND MORE THAN ONE PIECE OF EQUIPMENT PER DROP.

13.EACH METALLIC CONDUIT MAY BE CONNECTED TO THE HALO GROUND WITH A CONTINUOUS GROUNDING CONDUCTOR USING REMOVABLE SADDLE CLAMPS OR OTHER CLAMPS THAT SPECIFICALLY PERMIT THE USE OF A SINGLE CONTINUOUS CONDUCTOR FOR GROUNDING MULTIPLE RUNS OF CONDUIT. IF MULTIPLE CONDUITS ARE GROUNDED USING A SINGLE CONDUCTOR, THE CONDUCTOR SHALL BE CLAMPED TO EACH CONDUIT RUN SUCH THAT REMOVAL OF ONE CLAMP DOES NOT INTERRUPT THE PATH TO GROUND FOR THE OTHER CONDUIT RUNS.

14. REMOVE ALL PAINT BENEATH THE SURFACE OF GROUND LUGS.

15.ALL CABLE TRAY BONDING JUMPERS MAY BE INSTALLED ACROSS JUNCTION AS SHOWN OR AT OPPOSITE JUNCTION.

16.ALL SECURING HARDWARE FOR MECHANICALLY BOLTED CLAMPS AND LUGS SHALL BE STAINLESS STEEL OR APPROVED FOR THE APPLICATION.

17.SEE BUILDING COVERSHEET FOR WAIVEGUIDE AND AIR GAP LOCATIONS.

18.SEE HALO GROUND DETAILS SHEET FOR DETAILS.

19.EQUIPMENT GROUND BACKBONE RUN, ON CABLE TRAY, TO BE STOPPED 3" PAST LAST RUNG ON CABLE TRAY.

19.EQUIPMENT GROUND PAST LAST RUNG ON CA	
AND TRADE SCREES OF Ph. (8	0AVENPORT DRI 800) 824-2614 w
	L WEST CO
ETRATION SIZE	12' - 0" X 16'
IDUIT IDENTIFICATION	BUILDIN
UNDERSTANDING THAT ANYONE RECEIVING OR OTHERWISE OBTAINING	DATE: 27-NOV-2020
Possession of The Will       REV.     BY       Date     REVISION	ATE:

LEGEND:



X-X/

PART NUMBER WITH ELECTRI (XXXXXXX)(1)**IDENTIFICATION** 

> $|XX\rangle$ CONDUIT SECTION CALL OUT

PART NUMBER CALL OUT

VIEW NUMBER  $\langle X \rangle$ PEN

/X\ **REVISION NOTE TRIANGLE** 

SHEET NUMBER


1.HALO GROUND SHALL BE #2 AWG STRANDED GREEN COPPER WIRE.


2.ALL BENDS MINIMUM 8" RADIUS.


3. APPLY ANTI-OXIDATION COMPOUND TO ALL CONNECTIONS.

4.1/2" SCH. 40 PVC CAST AT 45° ANGLE.

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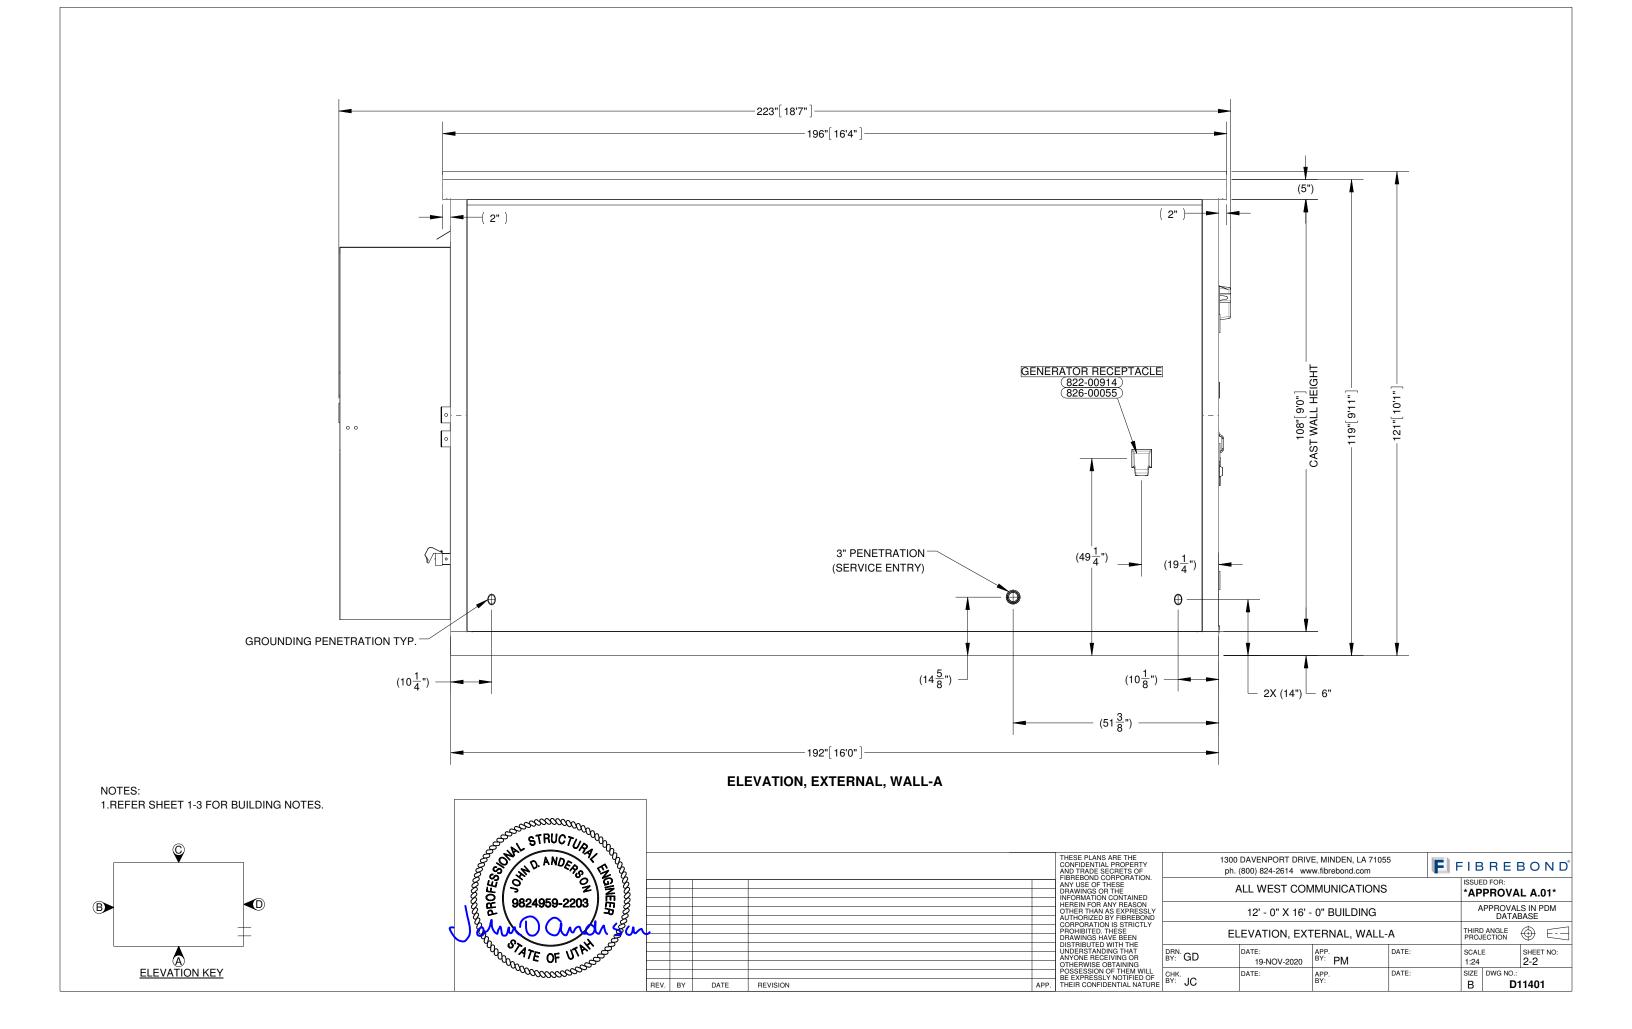
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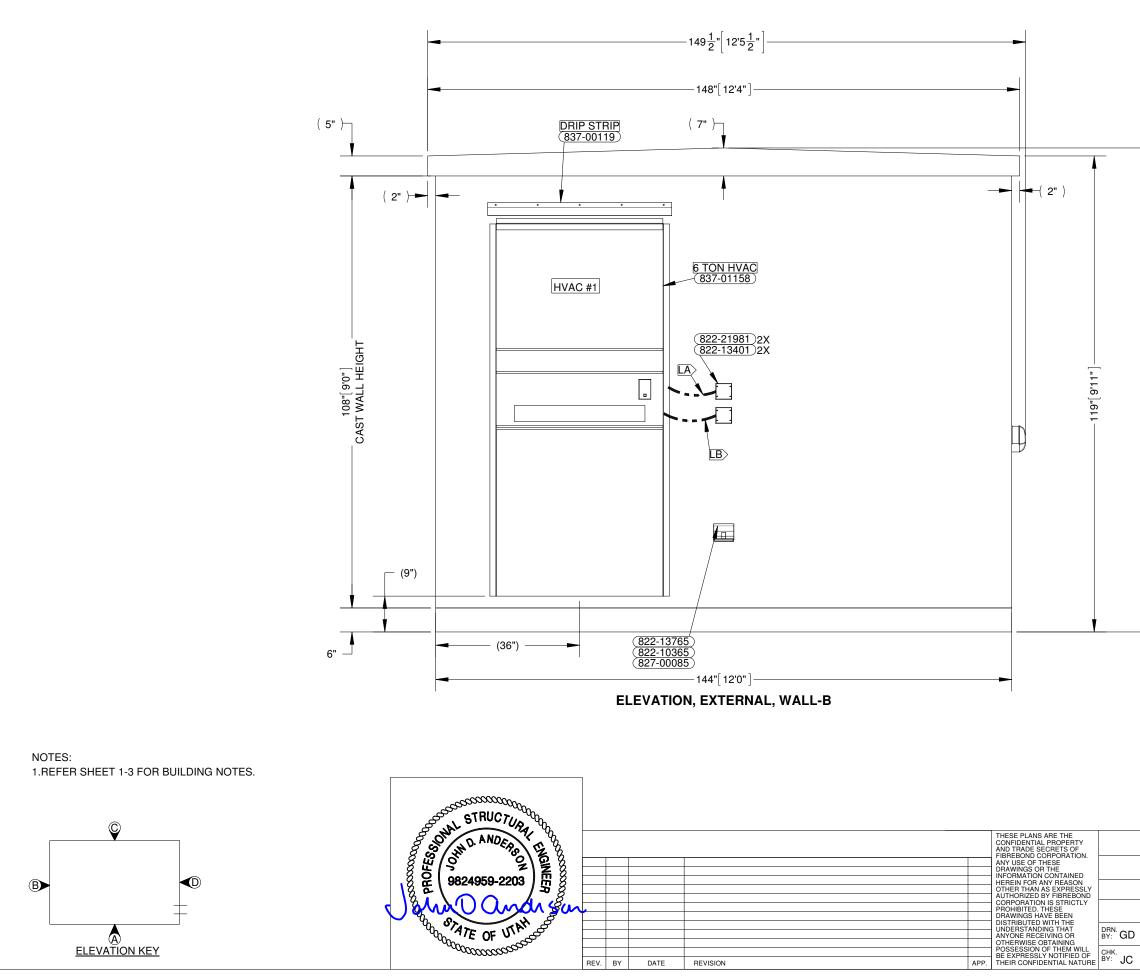
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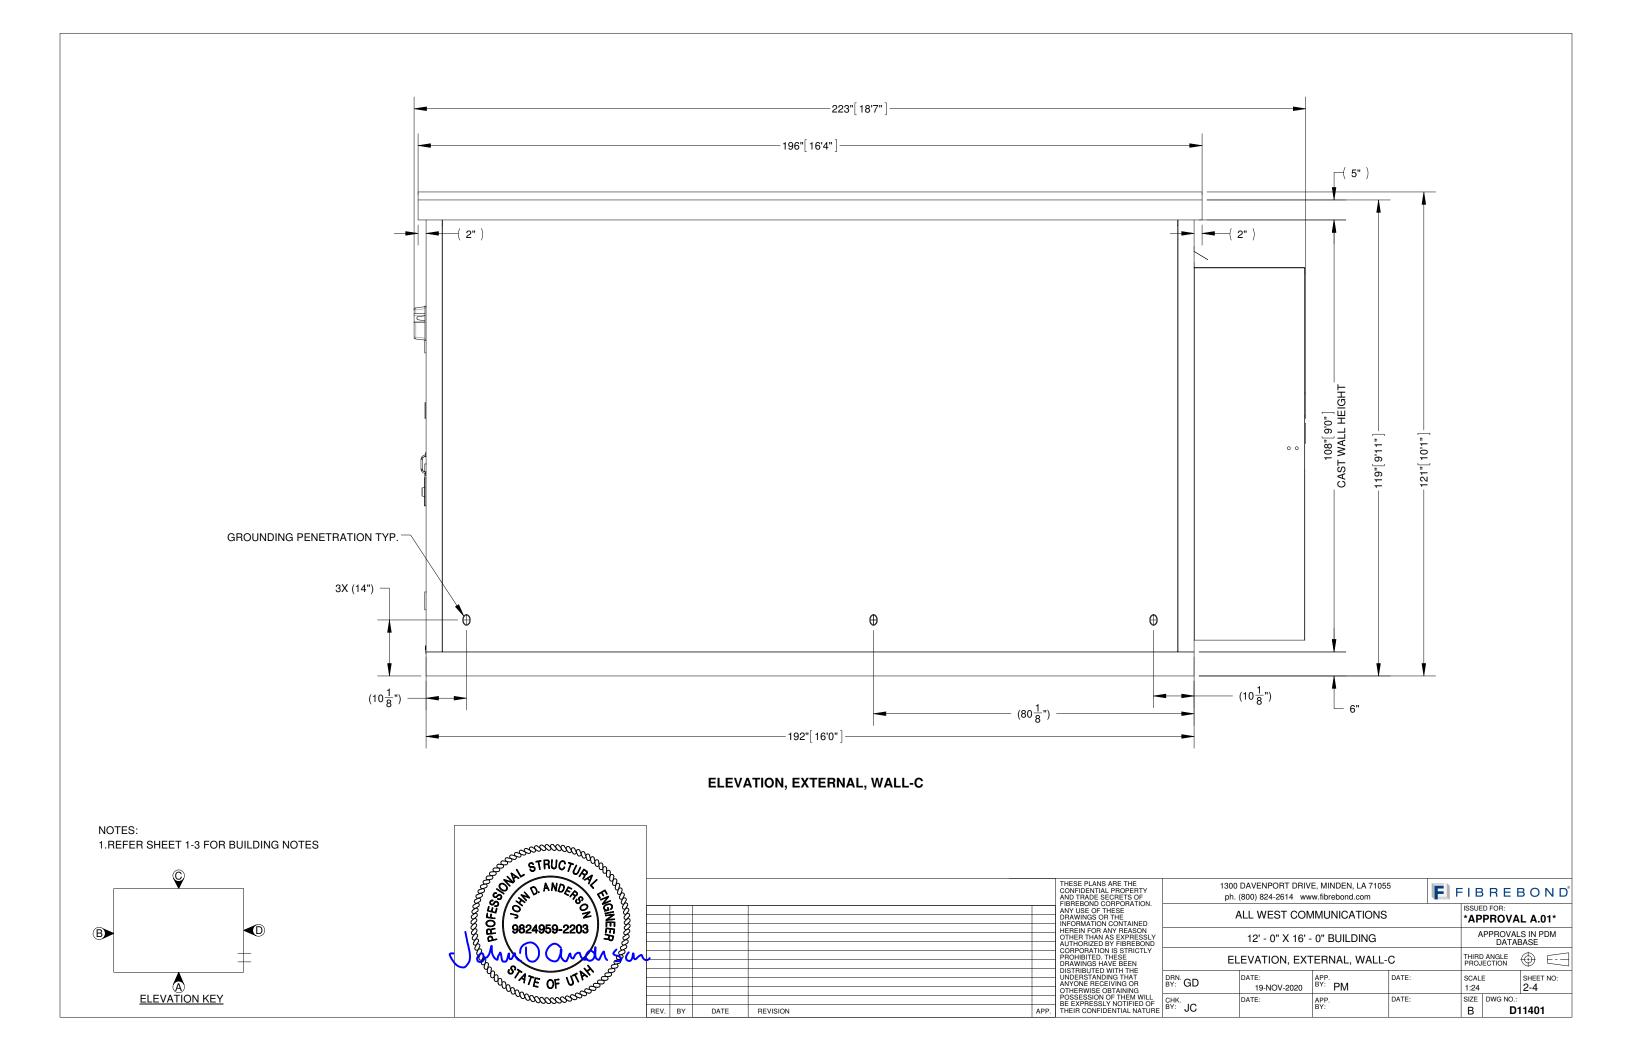
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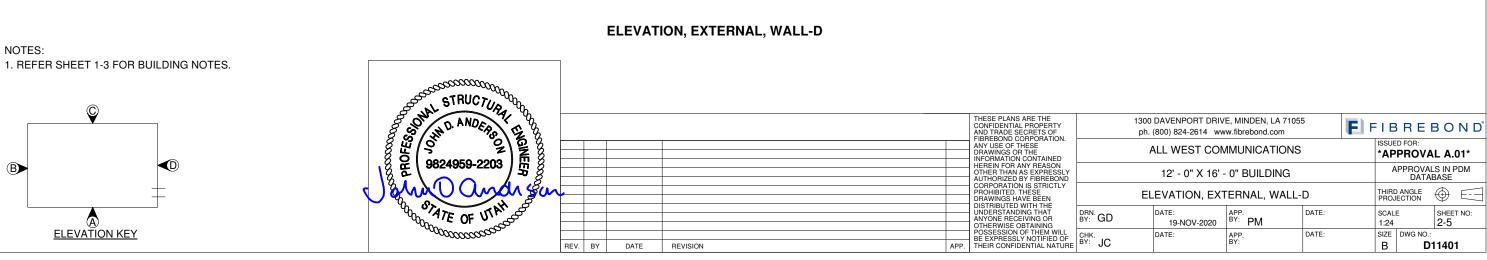


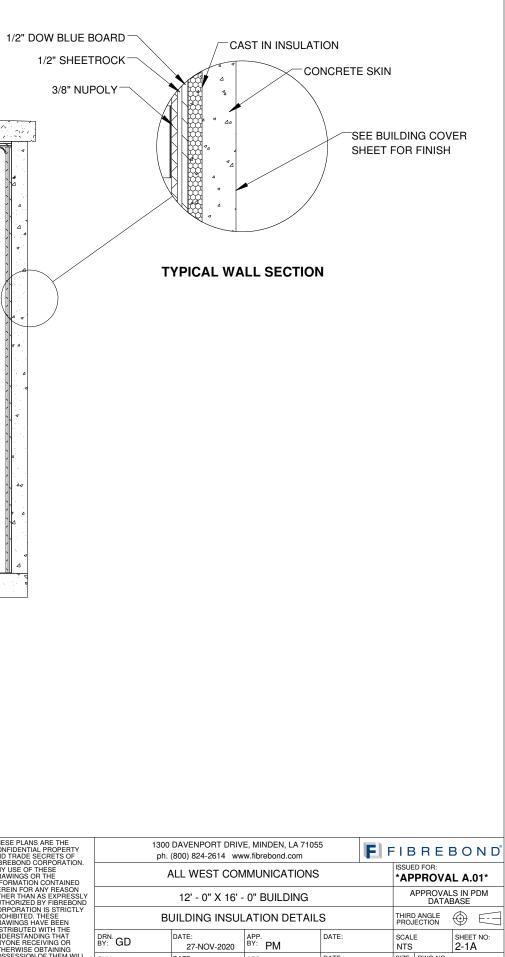
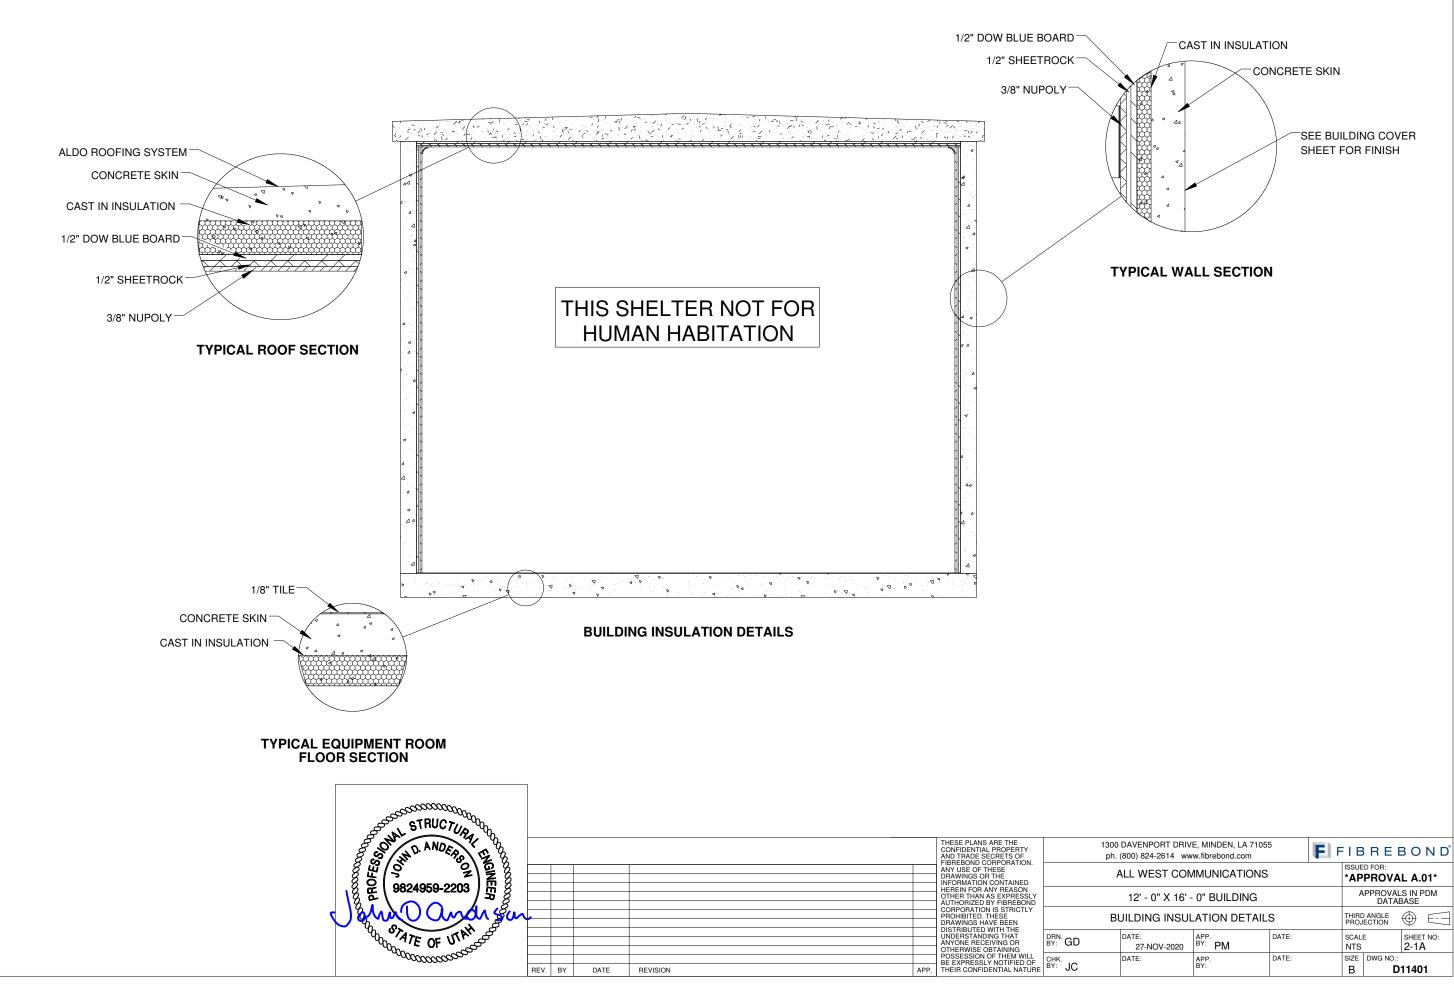
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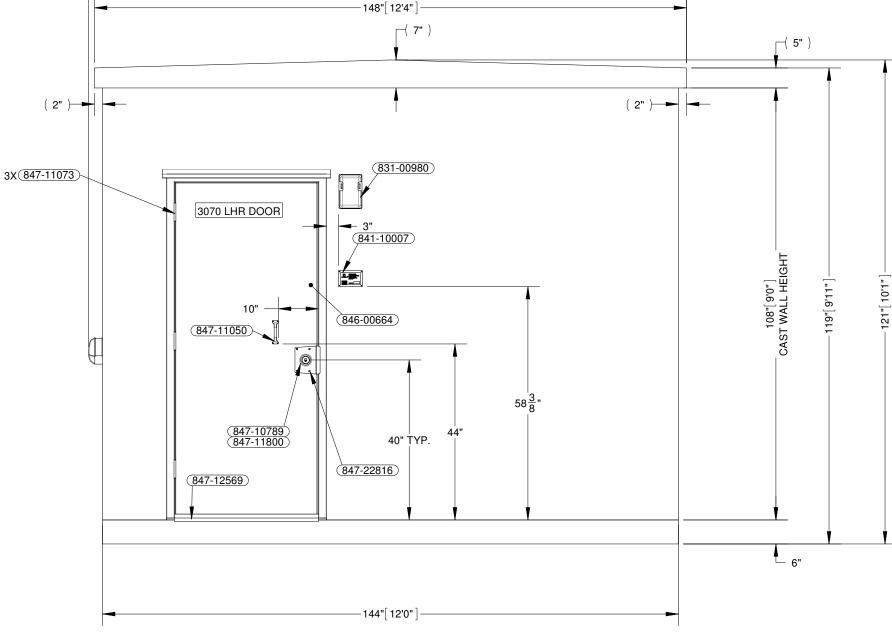
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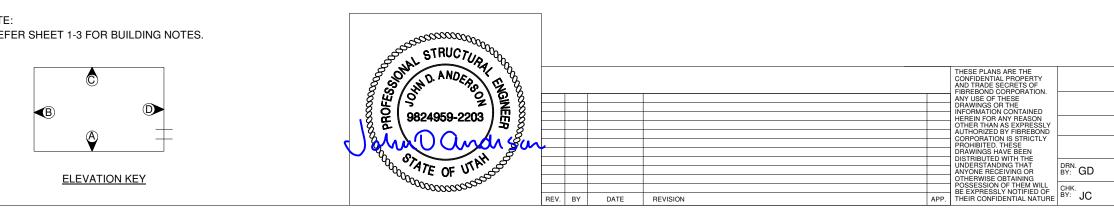


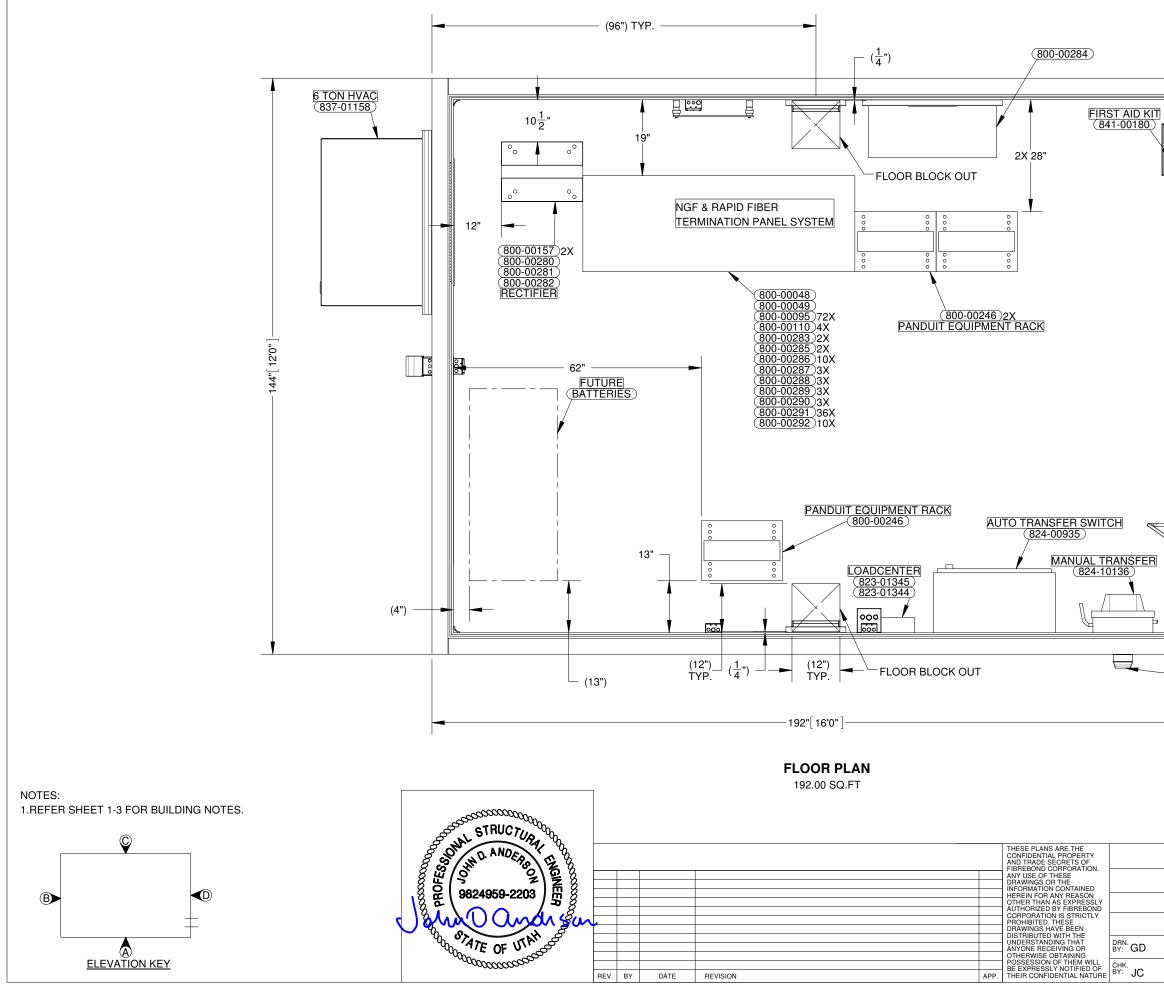







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NOTE: 1.REFER SHEET 1-3 FOR BUILDING NOTES.



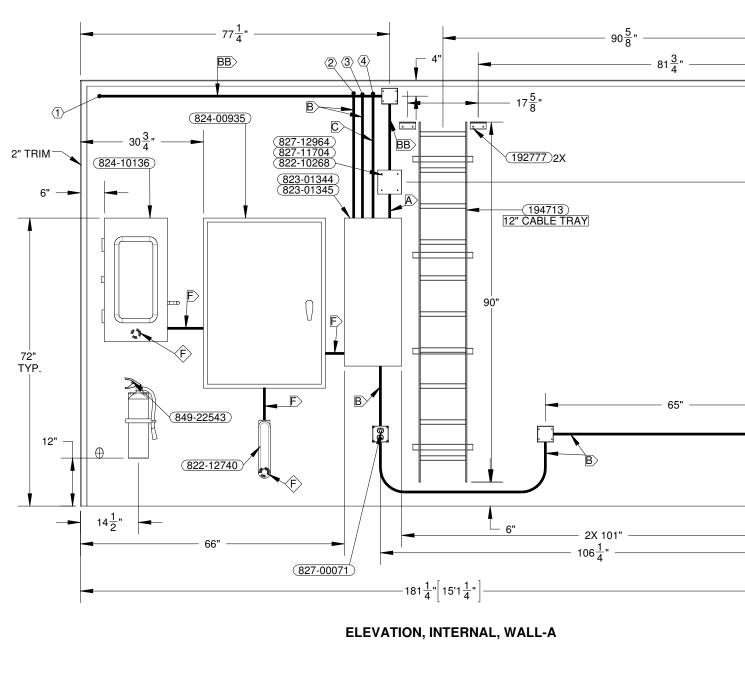

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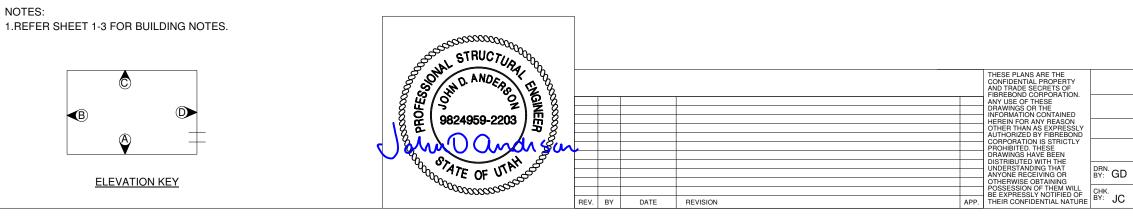
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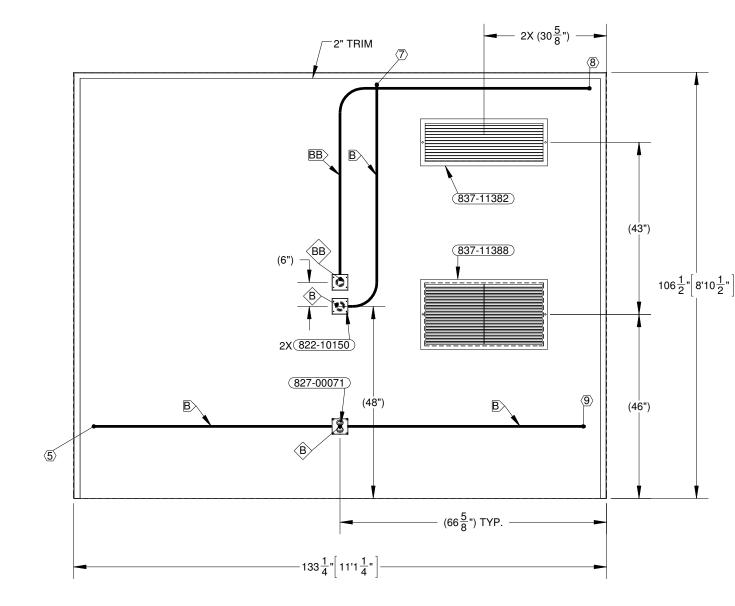
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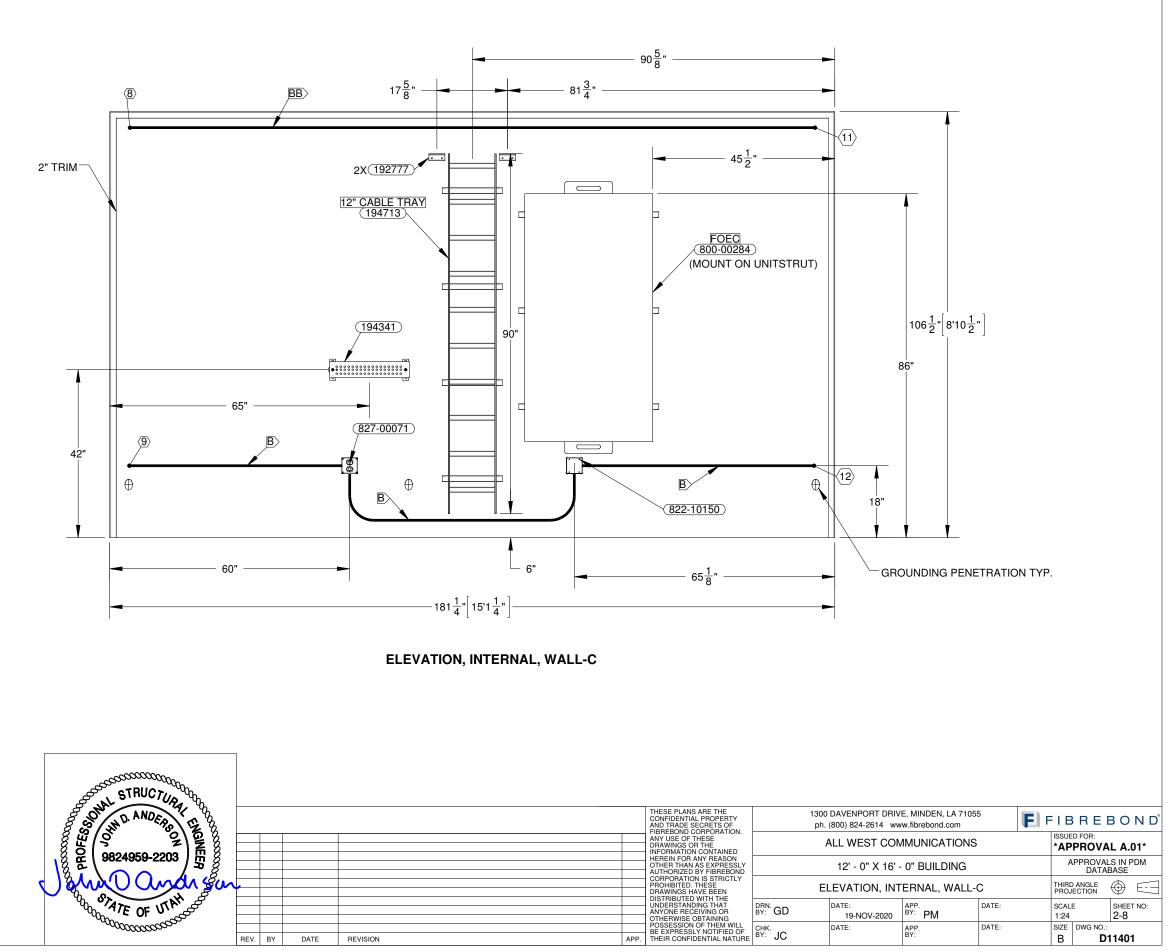
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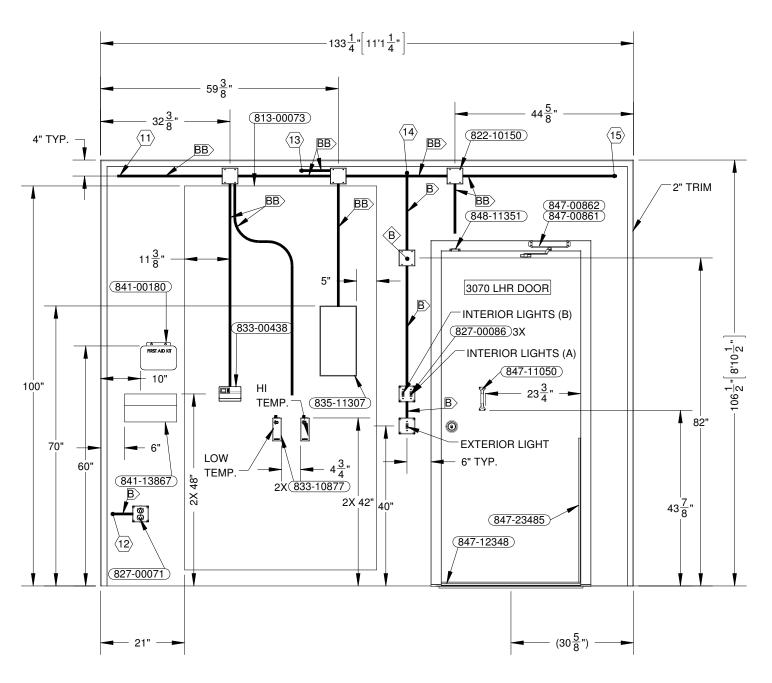

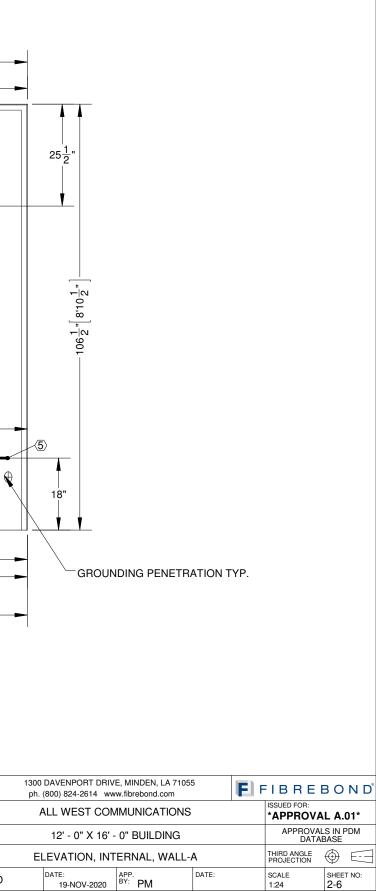
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INFORMATION CONTAINED HEBEIN FOR ANY REASON	
OTHER THAN AS EXPRESSLY AUTHORIZED BY FIBREBOND	
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DISTRIBUTED WITH THE UNDERSTANDING THAT ANYONE RECEIVING OR OTHERWISE OBTAINING	DRN. BY: GD
POSSESSION OF THEM WILL BE EXPRESSLY NOTIFIED OF THEIR CONFIDENTIAL NATURE	^{CHK.} ^{BY:} JC




C

ELEVATION KEY



**ELEVATION, INTERNAL, WALL-D** 

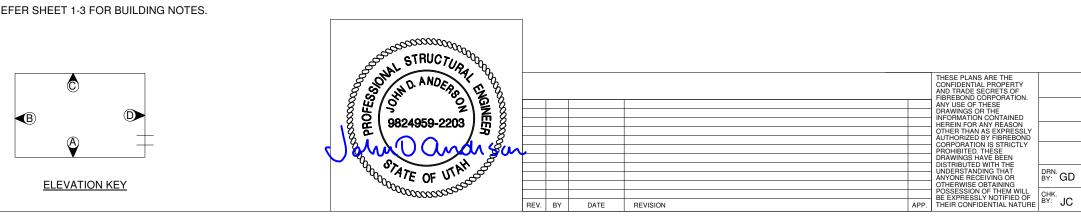


NOTES: 1.REFER SHEET 1-3 FOR BUILDING NOTES.

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FIBREBOND

1300 DAVENPORT DRIVE, MINDEN, LA 71055

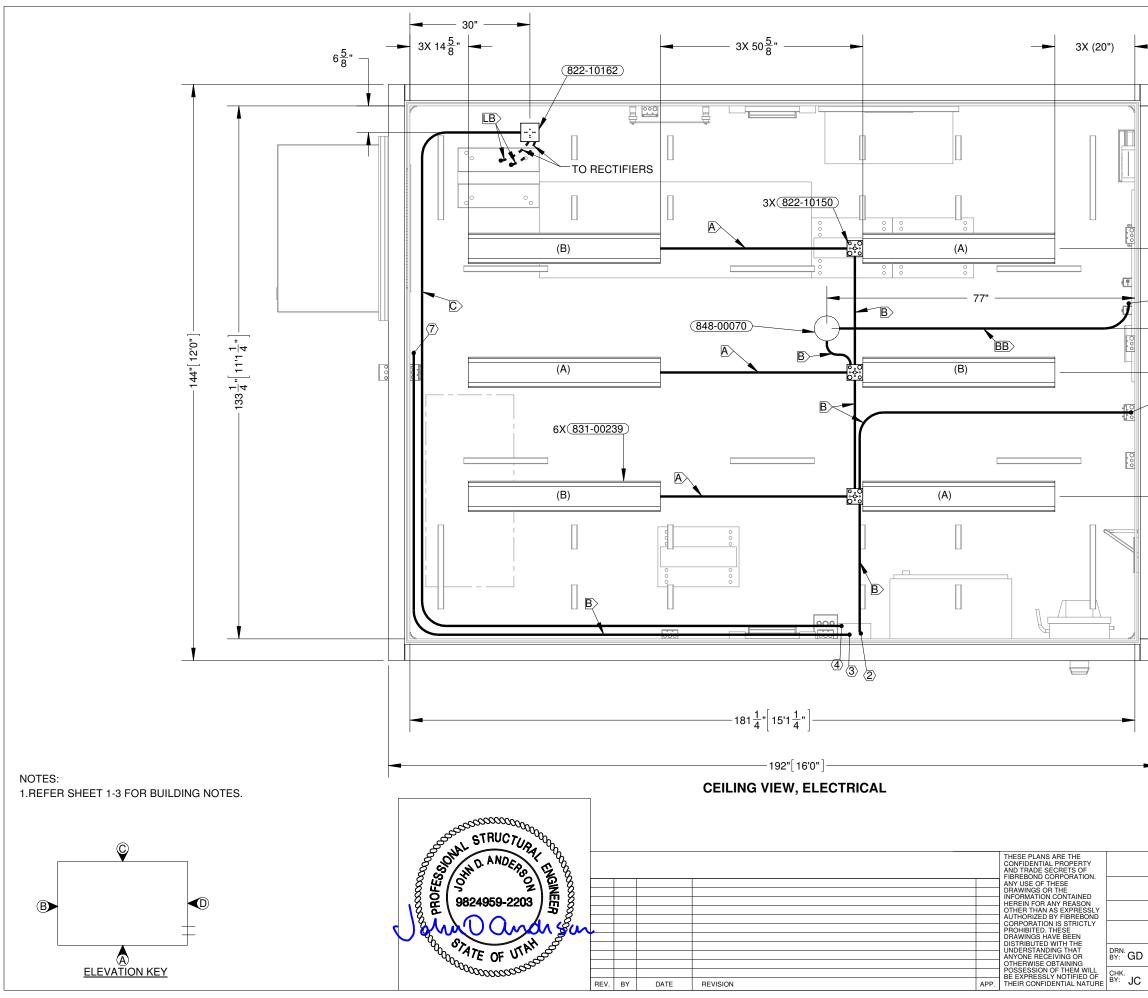

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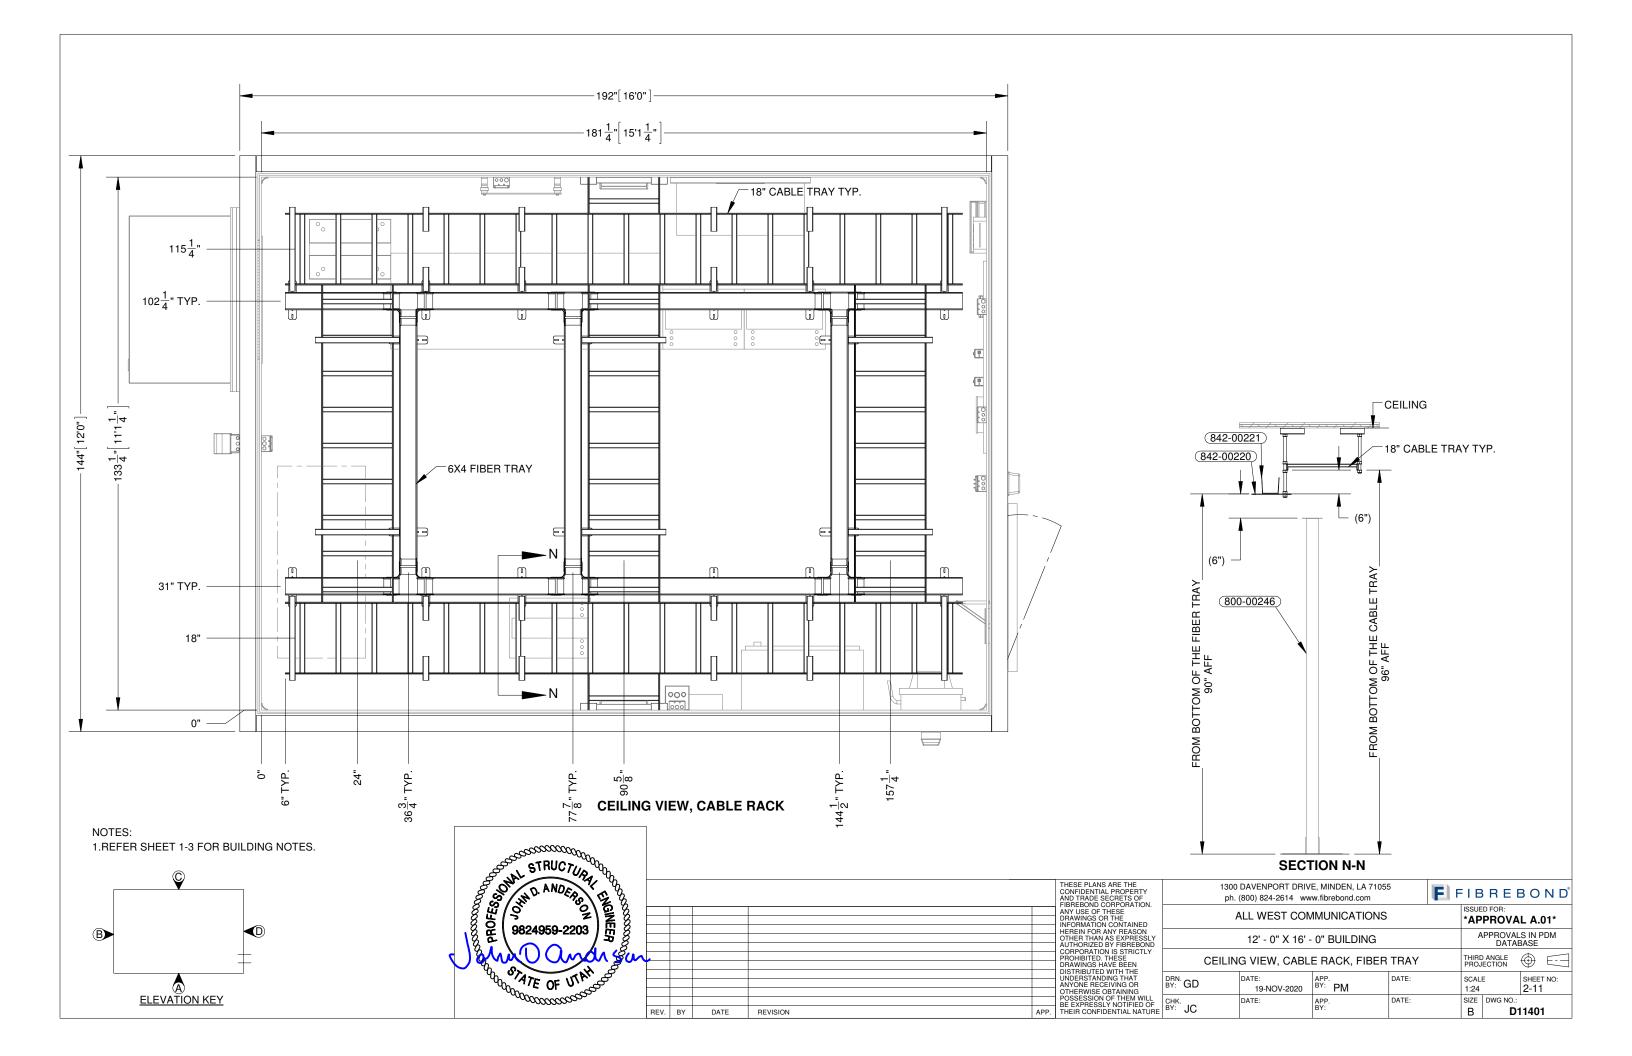
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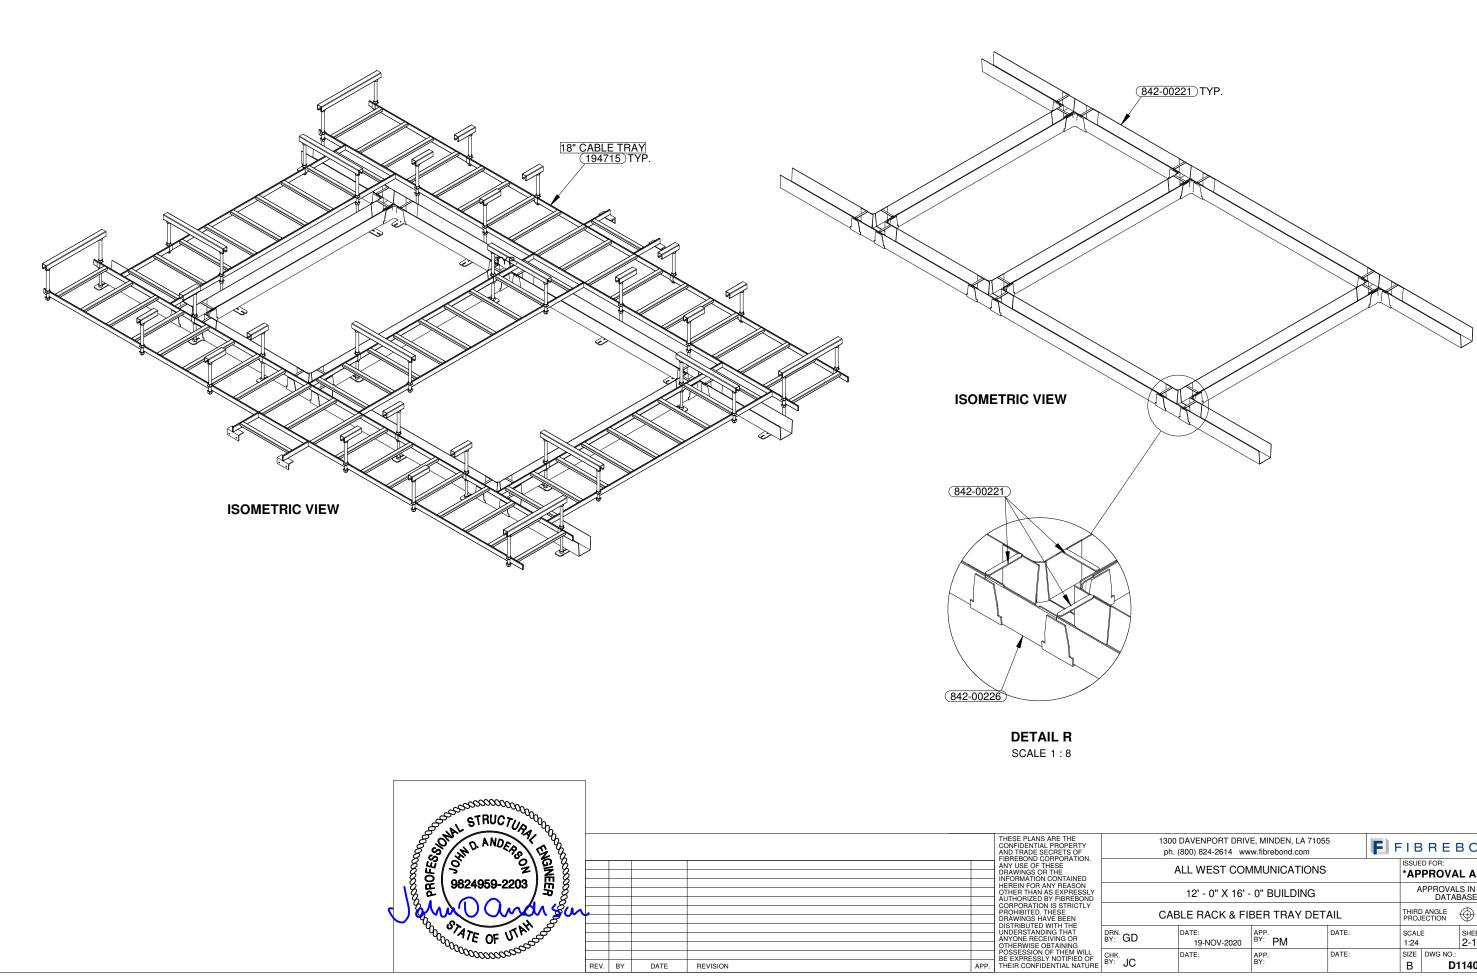
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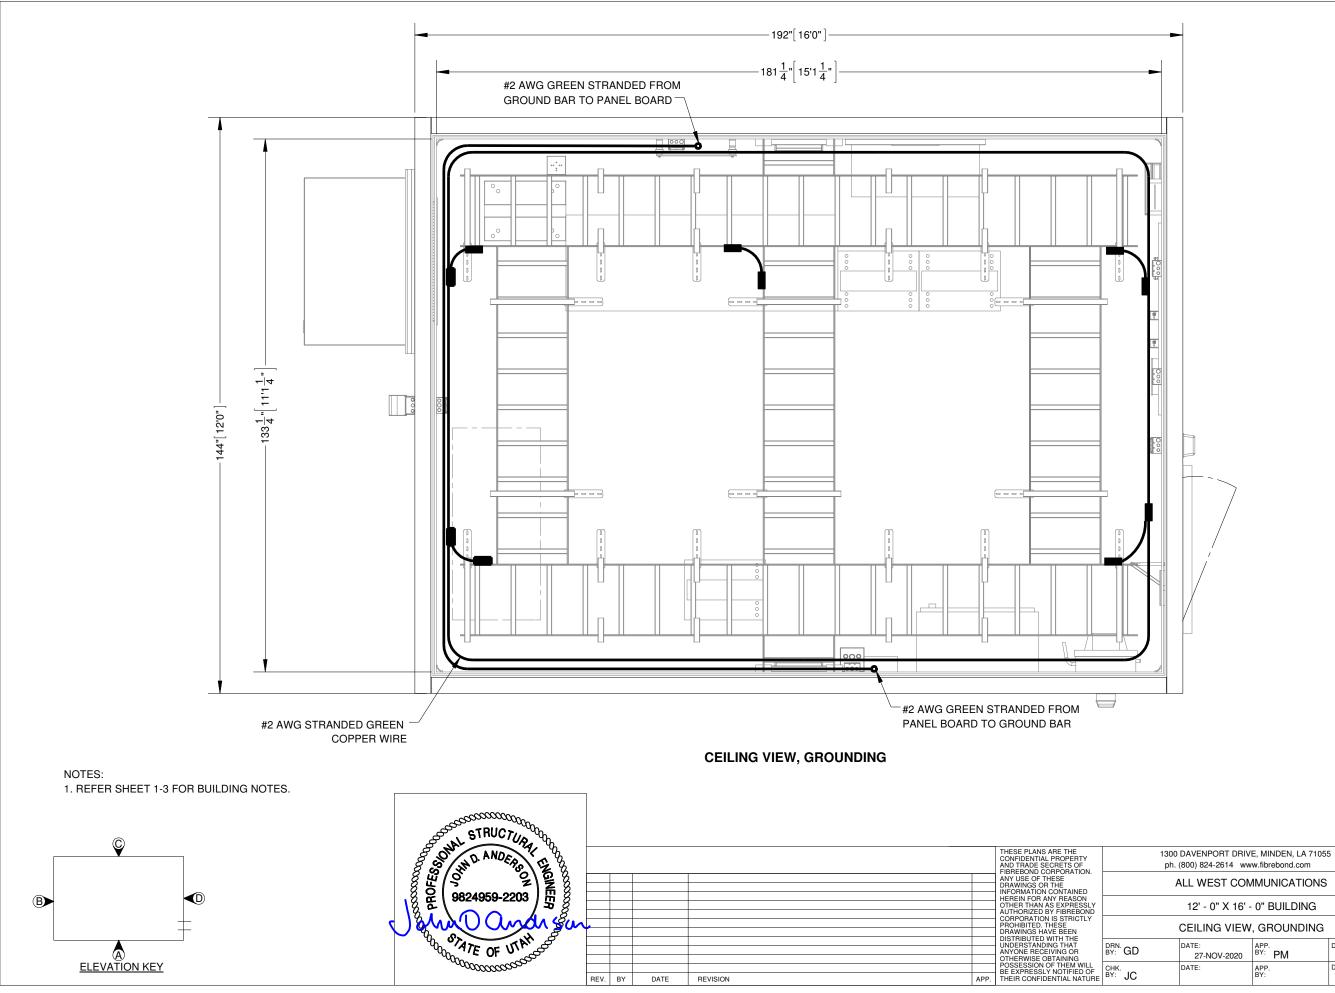
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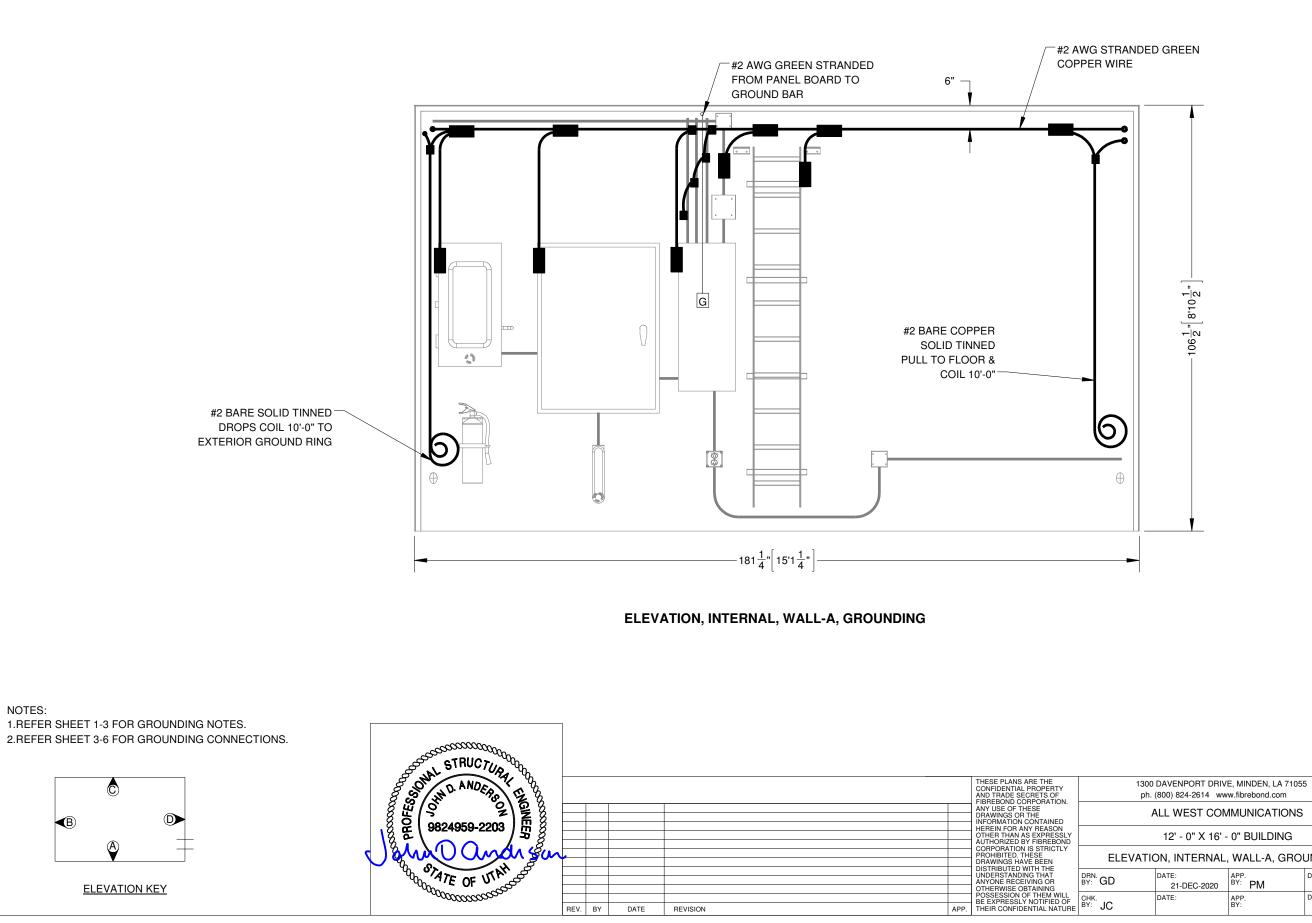




FIBREBOND[®] *APPROVAL A.01* APPROVALS IN PDM DATABASE THIRD ANGLE PROJECTION SHEET NO: 2-11.1 В D11401



	1300 DAVENPORT DRIV ph. (800) 824-2614 ww	, ,	5	E) F	EIE	REI	B O N D
	ALL WEST COM	MUNICATIONS	i			D FOR: PROVA	L A.01*
	12' - 0" X 16' -	0" BUILDING			A	PPROVAL DATA	LS IN PDM BASE
	CEILING VIEW	, GROUNDING				ANGLE ECTION	$\oplus$
)	DATE: 27-NOV-2020	^{APP.} ^{BY:} <b>PM</b>	DATE:		SCAL 1:24	E	SHEET NO: 3-1
;	DATE:	APP. BY:	DATE:		SIZE B	DWG NO.: D	11401




DATE

REVISION


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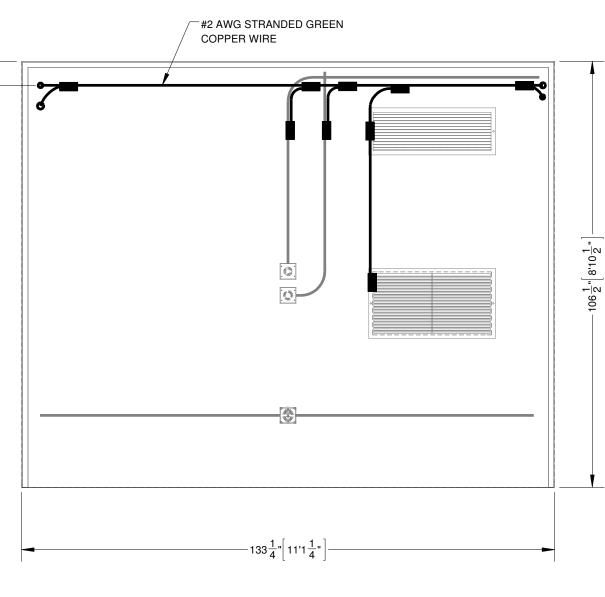
	DAVENPORT DRIVI (800) 824-2614 www	E, MINDEN, LA 7105 w.fibrebond.com	5	E F	I B	REE	B O N D
ŀ	ALL WEST COM	IMUNICATIONS				d for: PROVA	L A.01*
	12' - 0" X 16' -	0" BUILDING			A	PPROVAL DATAE	
LEVATIO	ON, INTERNAL,	WALL-A, GRO	UNDING			ANGLE	
)	DATE: 21-DEC-2020	^{APP.} ^{BY:} PM	DATE:		SCALE 1:24	1	SHEET NO: 3-2
	DATE:	APP.	DATE:		SIZE	DWG NO .:	
		BY:			В	D1	1401

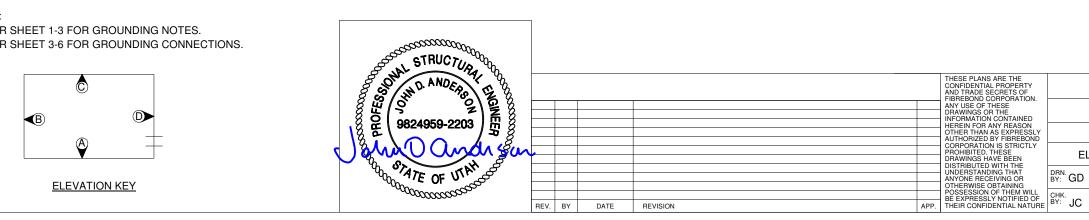

6"

NOTES: 1.REFER SHEET 1-3 FOR GROUNDING NOTES.




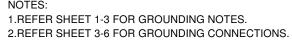


**ELEVATION, INTERNAL, WALL-B, GROUNDING** 


1300 DAVENPORT DRIVI ph. (800) 824-2614 www	5	E F	I B	REE	3 O N D°	
ALL WEST COM	IMUNICATIONS				d for: PROVA	L A.01*
12' - 0" X 16' -	0" BUILDING			А	PPROVAL DATAE	.S IN PDM BASE
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DATE: 21-DEC-2020	^{APP.} ^{BY:} <b>PM</b>	DATE:		SCAL 1:24	E	SHEET NO: 3-3
DATE:	APP.	DATE:		SIZE	DWG NO .:	
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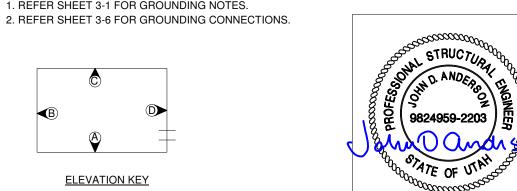
1300 DAVENPORT DRIVE, MINDEN, LA 71055

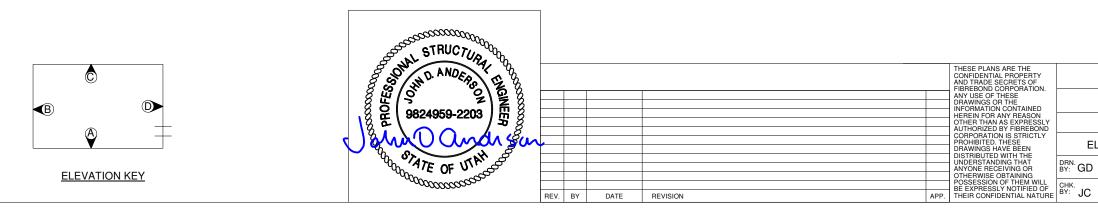


NOTES: 1.REFER SHEET 1-3 FOR GROUNDING NOTES. 2.REFER SHEET 3-6 FOR GROUNDING CONNECTIONS.



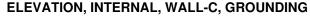

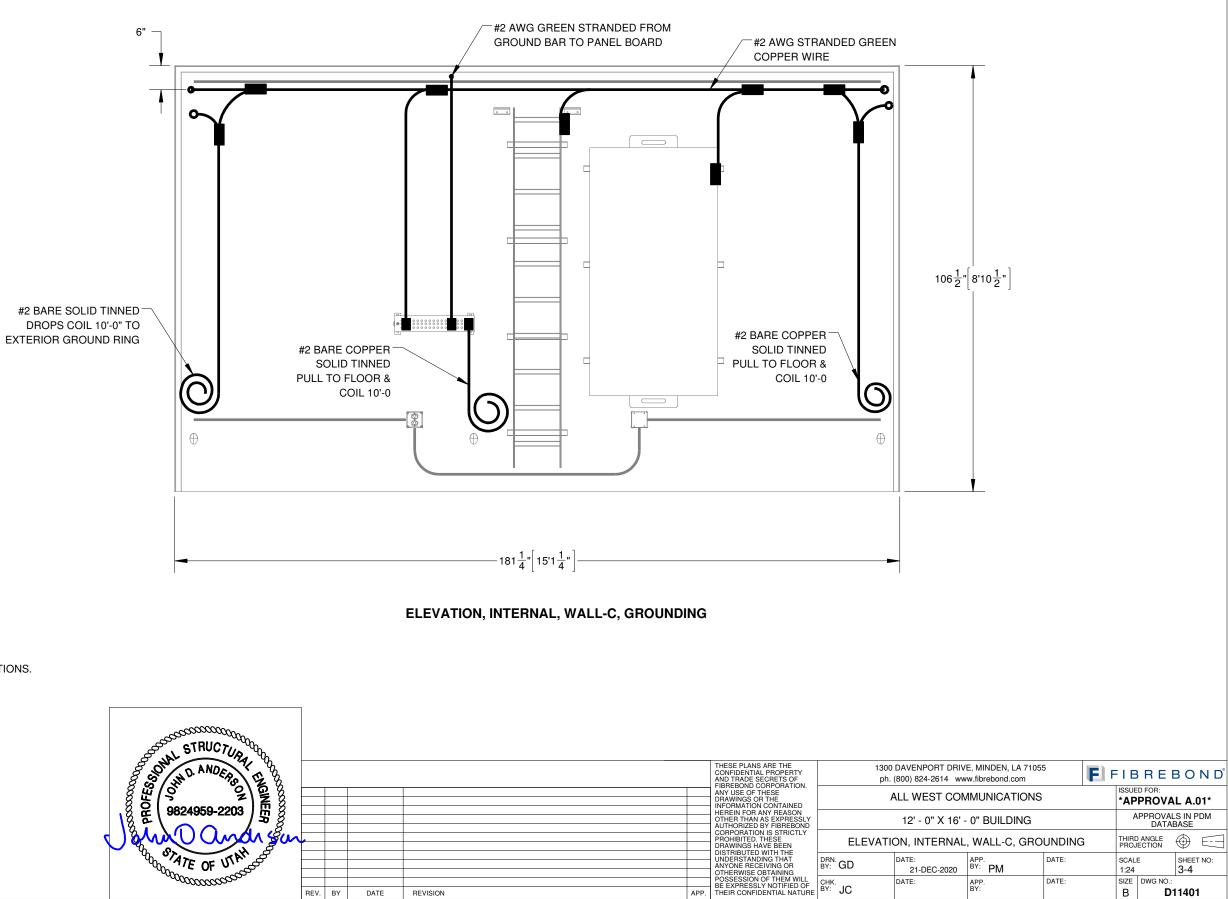


6" —

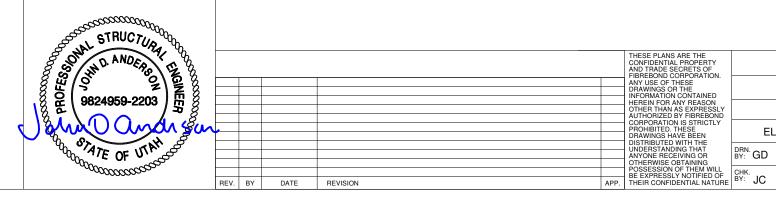

NOTES: 1. REFER SHEET 3-1 FOR GROUNDING NOTES. 2. REFER SHEET 3-6 FOR GROUNDING CONNECTIONS.




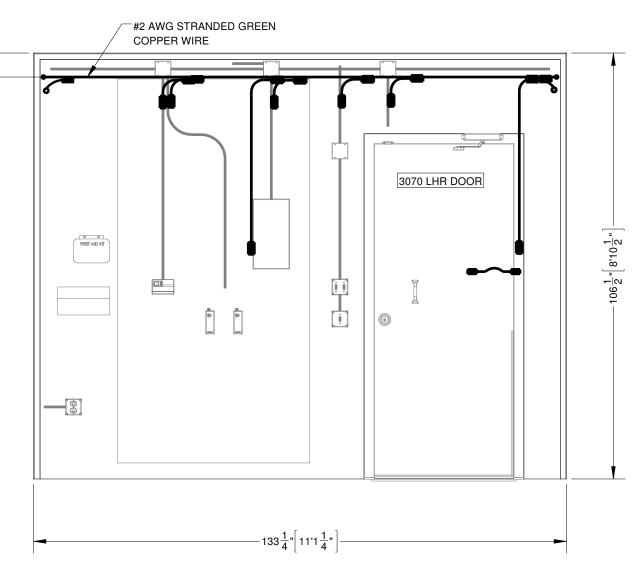


ph.	(800) 824-2614 www	w.fibrebond.com	-	I B	REE	3 0	ND
Þ	ALL WEST COM	IMUNICATIONS			d for: PROVA	L A.(	D1*
	12' - 0" X 16' -	0" BUILDING		A	PPROVAL DATAE		DM
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	DATE:	APP. BY:	DATE:	SIZE	DWG NO .:		
		BY:		В	D1	1401	

FIBREBOND

1300 DAVENPORT DRIVE, MINDEN, LA 71055

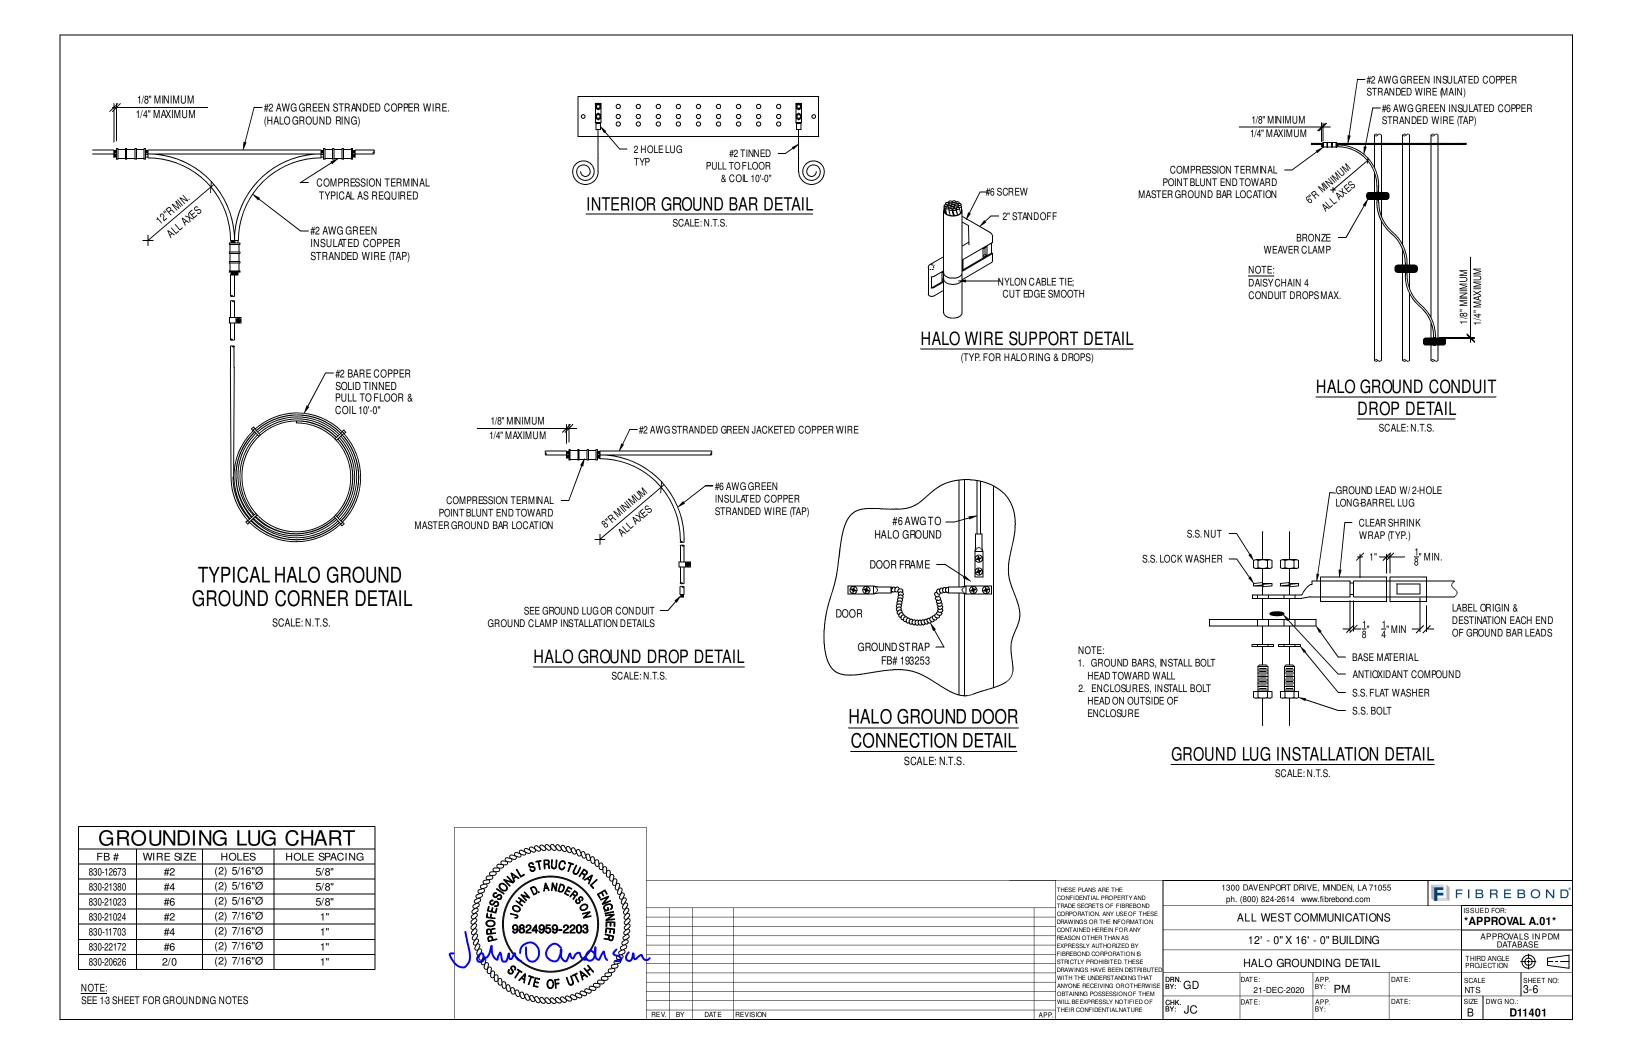

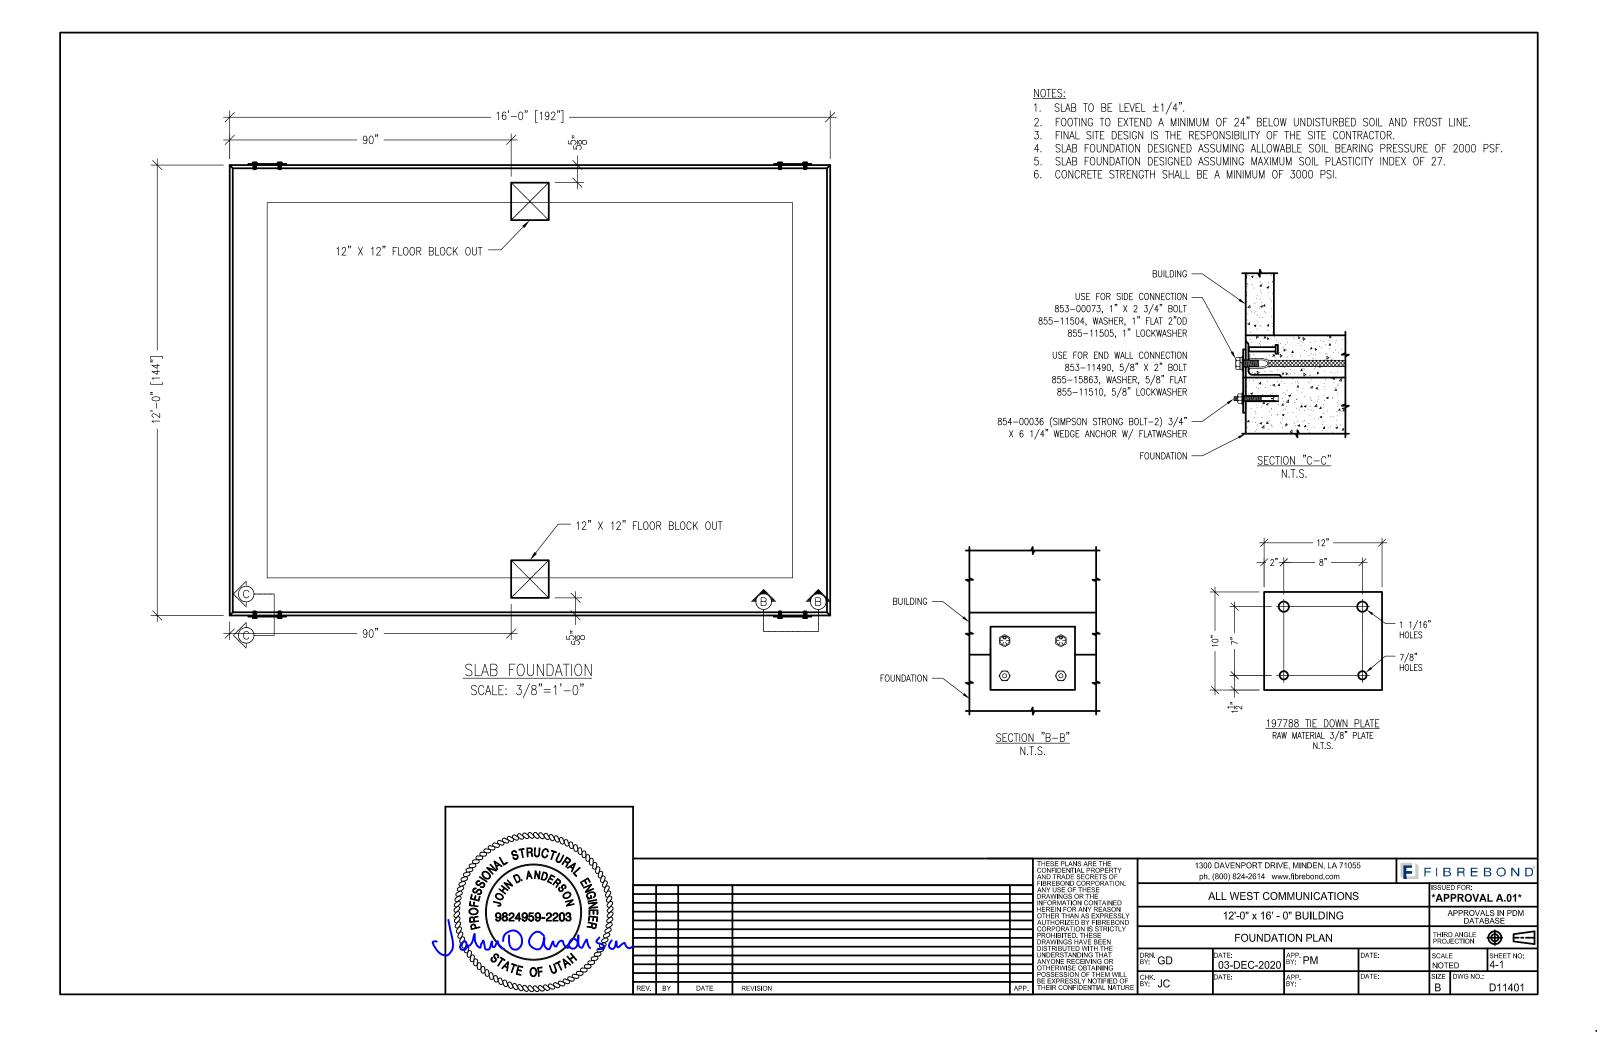

		LOAD			LOAD PER	PHASE (VA)	BO OR	SUOUS			ų l		SR	ZE	딬	SNOUL	SI BI	LOAD PER	PHASE (VA)			LOAD		
		DESCRIPTION	QTY.	UNIT V.A.	PH	ASE B	WIRE COLOR LOADS		SUB-PAN	WIRE SIZE GROUNDING	TRIP	TRIP	GROUNDING WIRE SIZE	WIRE SIZE	LOADS SUB-PANEL	VON-CONTINUOL LOADS	WIRE COLOR	PH/ A	ASE B	UNIT V.A.	QTY.	DESCRIPTION		
	1		1	4428	4428		BLK					20	12	12		X	BLK	216		36	6	INTERIOR LIGHTS	2	827-00086 831-00239(A 827-00086 831-00239(E
1158	3	HVAC #1	1	4428		4428	RED	X	1	8 (8)	) 70	20	12	12		x	RED		15	15	1	EXTERIOR LIGHT	4	
00071	5	INTERIOR RECEPTACLES	4	180	900		BLK X		1	12 12	20	20	12	12		x	BLK	9		9	1	SMOKE DETECTOR	6	
0085	7	EXTERIOR GFCI RECEPTACLE	1	180		180	RED X		1	12 (12	20						RED		1200	1200	1		8	
2964	9	POWER FAIL	1	10	10		BLK X		1	12 (12	.) 20	30	8	8			BLK	1200		1200	1	RECTIFIER #1	10	800-00157(A)
	11	SPACE					RED										RED		1200	1200	1	4-	12	
	13	SPACE					BLK					30	8	8			BLK	1200		1200	1	RECTIFIER #2	14	800-00157(B)
	15	SPACE					RED										RED					SPACE	16	
	17	SPACE					BLK										BLK					SPACE	18	1
	19	SPACE					RED										RED					SPACE	20	
	21	SPACE					BLK										BLK					SPACE	22	
	23	SPACE					RED										RED					SPACE	24	
	25	SPACE					BLK										BLK					SPACE	26	
	27	SPACE					RED										RED					SPACE	28	
	29	SPACE					BLK										BLK					SPACE	30	
	31	SPACE					RED										RED					SPACE	32	
	33	SPACE					BLK										BLK					SPACE	34	
	35	SPACE					RED										RED					SPACE	36	
	37	SPACE					BLK										BLK					SPACE	38	
	39	SPACE					RED										RED					SPACE	40	
	41	SPACE					BLK										BLK					SPACE	42	
				JBTOTAL NTINUOUS	720	180												2,415	2,415	SUBTOT CONTINU	AL DUS	TOTAL KVA CONTINUOUS x 1.25	7.44	
			SU NON-(	JBTOTAL CONTINUOUS	4,428	4,428	-											-	-	SUBTOT NON-CONTI		TOTAL KVA NON-CONTINUOUS	8.86	
		L DESIGNATION: ELECTRICAL PAN		JBTOTAL B-PANEL 3-01345)	-	-												-	-	SUBTO1 SUB-PA	NËL	TOTAL KVA SUB-PANEL	-	
		LUGS: N/A MAIN BREAK		· · · · · ·	IN BREAKER	A.I.C RATING	: 22,000 A	.I.C E	RANCH	BREAKE	R A.I.C F	RATING:	10,000	) A.I.C		BRANCH	BREAKE	R TYPE: CUTTI	LER HAMMER	– SNAP IN		TOTAL KVA	16.30	
	VOLT		E: 60		PHASE: 1	WI	RES: 3	MAIN C	OPPER	BUS: 2	00 AMPS	5	NEUT	RAL: 20	00 AMPS							TOTAL AMPS	67.92	



 $\overline{\text{PC}}$  = PHOTOCELL

- (M) = MOTION DETECTOR
- = CONDUIT GROUND
- # = NON-DEDICATED GROUND

(#) = DEDICATED GROUND

<#>= ISOLATED GROUND

NOTES: 1. ALL WIRE TO BE #12 THHN/THWN UNLESS NOT COLOR CODE: • AØ = BLACK • DA = RED


- NEUTRAL = WHITE
- GROUND = GREEN

2. ALL WORK TO CONFORM TO N.E.C. LATEST STA

- 3. LABEL SERVICE DISCONNECT WITH A RED TAG. 4. SWITCH LEG CONDUCTORS SHALL BE THE SAME COLOR AS CIRCUIT
- CONDUCTORS. 5. ALL GFCI RECEPTACLES TO HAVE A DEDICATED GROUND WIRE.
- SEE ELECTRICAL SCHEMATIC #2 SHEET FOR MORE DETAILS.
   EQUIPMENT TERMINATION LUGS AND CONDUCTORS ARE RATED AT A MINIMUM OF 75°C.

	STRUCTURAL CONTRACTION								
	0 0 0 0 0 0 0 0 0 0 0 0 0 0 0 0 0 0 0							THESE PLANS ARE THE CONFIDENTIAL PROPERTY AND TRADE SECRETS OF FIBREBOND	
								CORPORATION, ANY USE OF THESE	
	. 8 <b>₽ ( 9824959-2203 )</b> ∰ 8	<u> </u>					<u> </u>	DRAWINGS OR THE INFORMATION CONTAINED HEREIN FOR ANY	
								REASON OTHER THAN AS	
_								EXPRESSLY AUTHORIZED BY FIBREBOND CORPORATION IS	
	James and and an	ř—						STRICTLY PROHIBITED, THESE	
	STATE OF UT M							DRAWINGS HAVE BEEN DISTRIBUTED WITH THE UNDERSTANDING THAT	
								WITH THE UNDERSTANDING THAT ANYONE RECEIVING OR OTHERWISE OBTAINING POSSESSION OF THEM	BY: GD
	TOOOOOOOO	<u> </u>					—		CHK.
		REV.	BY	DATE	REVISION		APP.	THEIR CONFIDENTIAL NATURE	^{снк} JC

	) DAVENPORT DRIV (800) 824-2614 ww				B O N D		
ALL WEST COMMUNICATIONS						d for: PROVA	L A.01*
12'-0" X 16'-0" BUILDING						APPROVAI DATAE	LS IN PDM BASE
	ELECTRICAL S	CHEMATIC #1	_		TH <b>I</b> RI PROJ	O ANGLE ECTION	
)	DATE: 18-DEC-2020	^{APP.} ^{BY:} <b>PM</b>	DATE:		SCALI NTS	=	SHEET NO: 5-1
;	DATE:	APP. BY:	DATE:		size B	DWG NO.: D1	1401

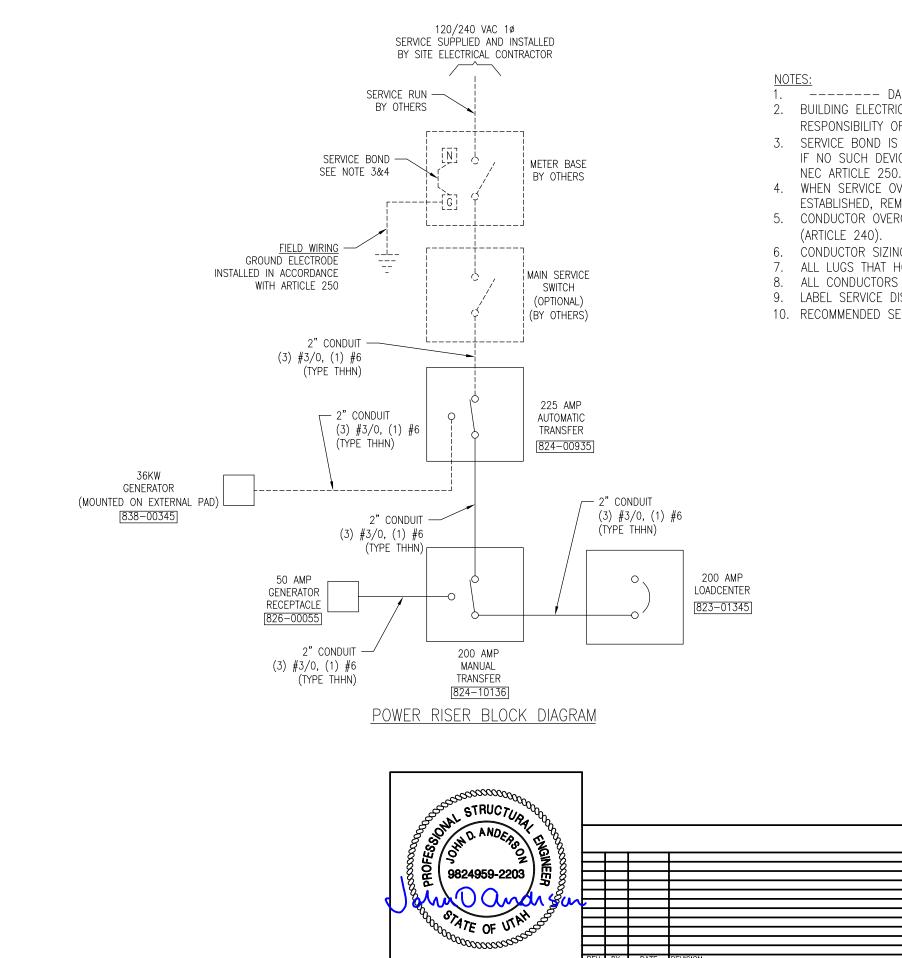

- ----- DASHED LINES DENOTE FIELD WORK.
- BUILDING ELECTRICAL SYSTEM IS RATED AT 10,000 A.I.C. IF HIGHER RATINGS ARE REQUIRED, IT IS THE RESPONSIBILITY OF SITE CONTRACTOR/ ENGINEER TO MEET SUCH REQUIREMENTS.
- 3. SERVICE BOND IS TO BE MADE BY DEVICES (STRAPS, SCREWS, ETC.) SUPPLIED BY EQUIPMENT MANUFACTURER. IF NO SUCH DEVICE IS SUPPLIED, BOND IS TO BE MADE IN ACCORDANCE WITH THE LASTEST STATE APPROVED
- 4. WHEN SERVICE OVERCURRENT DISCONNECT IS FIELD INSTALLED AND HAS A NEUTRAL TO GROUND CONNECTION ESTABLISHED, REMOVE NEUTRAL TO GROUND CONNECTION IN MANUAL TRANSFER.
- 5. CONDUCTOR OVERCURRENT PROTECTION DEVICES ARE SELECTED IN ACCORDANCE WITH NATIONAL ELECTRIC CODE
- CONDUCTOR SIZING IS SELECTED FROM NATIONAL ELECTRIC CODE (ARTICLE 215).
- ALL LUGS THAT HOLD MORE THAN ONE WIRE SHALL BE LISTED FOR MULTI-BARRELL CONNECTIONS.
- ALL CONDUCTORS SHALL BE COPPER.
- 9. LABEL SERVICE DISCONNECT WITH A RED TAG.
- 10. RECOMMENDED SERVICE ENTRANCE CONDUCTOR SIZE: (3) 3/0 AWG & (1) #4 GROUND

THESE PLANS ARE THE CONFIDENTIAL PROPERTY AND

ADE SECRETS OF FIBREBOND ORPORATION, ANY USE OF THES DRAWINGS OR THE INFORMATION EASON OTHER THAN AS XPRESSLY AUTHORIZED BY IBREBOND CORPORATION IS TRICTLY PROHIBITED. THESE


RAWINGS HAVE BEEN DISTRIBU WITH THE UNDERSTANDING THAT ANYONE RECEIVING OR OTHERWISE

OBTAINING POSSESSION OF THEM WILL BE EXPRESSLY NOTIFIED OF THEIR CONFIDENTIAL NATURE BY: GD

снк ^{вү:} JC

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12'-0" X 16'-(			APPROVAI DATAE		PDM		
ELECTRICAL S	CHEMATIC #2				D ANGLE	<b>(</b>	ß
DATE: 18-DEC-2020	^{app.} ^{by:} PM	DATE:		SCALI NTS	=	SHEET 5-2	ΓNO:
DATE:	APP. BY:	DATE:		size B	DWG NO.: D1	1401	1

### INTRUSION ALARM

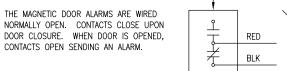


848-11351

NOTE 3




CONTACTS OPEN UPON TEMPERATURE INCREASE (OR RISE) ABOVE THE SET POINT SENDING AN ALARM. PULL FROM CONTROLLER TERMINALS 9 & 29.

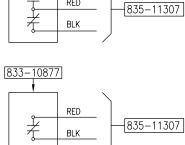





THE COMMERCIAL POWER FAIL RELAY IS CONNECTED TO EACH PHASE OF THE IN-COMING COMMERCIAL POWER. COMMERCIAL POWER IS THE POWER SUPPLIED BY THE UTILITY COMPANY. THE NORMALLY OPEN CONTACTS CLOSE UPON POWER UP OF THE BUILDING. CONTACTS OPEN UPON LOSS OF COMMERCIAL POWER SENDING AN ALARM. (THIS ALARM <u>MUST NOT</u> BE CONNECTED TO THE SYSTEM SUCH THAT IT RECEIVES POWER FROM A GENERATOR, UPS SYSTEM, OR ANY OTHER EMERGENCY POWER SOURCE.)

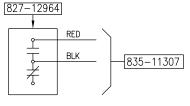

LOW TEMPERATURE ALARM [833] CONTACTS OPEN UPON TEMPERATURE DECREASE (OR FALL) BELOW THE SET POINT RESULTING IN ALARM. PULL FROM

CONTROLLER TERMINALS 10 & 30.

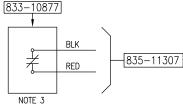

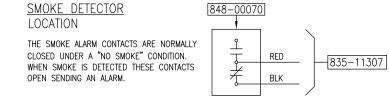


### NOTES:

- 1. ALARM STATES SHOWN ARE THE CONDITION AT THE ALARM BLOCK WITH BUILDING POWERED BY COMMERCIAL POWER.
- 2. ALARM WIRES TO BE 22/2 SOLID WIRE UNLESS OTHERWISE SPECIFIED.
  - * N.C.=BLK * N.O.=BLK
  - * C.=RED * C.=RED
- 3. SEE ELEC-0074 FOR SPECIFIC TERMINAL LOCATIONS.
- 4. FOR DC, PLEASE TAPE & TAG ACCORDING TO ELECTRICAL SCHEMATIC #2.
- 5. GENERATOR ALARMS TO BE PULLED ONLY WHEN GENERATOR IS INSTALLED @ FIBREBOND
- 6. APPLY A PERMANENT HEAT SHRINK LABEL TO THE INSULATING JACKET AT EACH END OF THE 2-CONDUCTOR ALARM CABLE. PRINT THE NAME OF THE SPECIFIC ALARM FROM THE DIRECTORY ON ALARM WIRING SHEET #2.
- 7. TAG ALL ALARM WIRES.

	STRUCTURA STRUCTURA SHOCK 9824959-2203							
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							CORPORATION, ANY USE OF THESE DRAWINGS OR THE INFORMATION	
	S & C 9824959-2203 ) H S						CONTAINED HEREIN FOR ANY REASON OTHER THAN AS EXPRESSLY AUTHORIZED BY	
4	Jour Oundr Sa	-					FIBREBOND CORPORATION IS STRICTLY PROHIBITED. THESE DRAWINGS HAVE BEEN DISTRIBUTED	
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	TO COLOCOLOGIC						OBTAINING POSSESSION OF THEM WILL BE EXPRESSLY NOTIFIED OF THEIR CONFIDENTIAL NATURE	снк ^{вү:} JC
		REV.	BY	DATE	REVISION	APP.		30

	ALARM	TERMINAL BL	OCK 835-113	07				
	н	CIAL POWER FAIL SMOKE ALARM IGH TEMP ALARM OW TEMP ALARM TIC DOOR ALARM		$ \begin{array}{c} 1 \\ 2 \\ 3 \\ 4 \\ 5 \\ 6 \\ 7 \\ 8 \\ 9 \\ 10 \\ 11 \\ 12 \\ 13 \\ 14 \\ 15 \\ 16 \\ 17 \\ 18 \\ 19 \\ 20 \\ 21 \\ 22 \\ 23 \\ 24 \\ 25 \\ 26 \\ 27 \\ 28 \\ 29 \\ 30 \\ 31 \\ 32 \\ 33 \\ 34 \\ 35 \\ 36 \\ 37 \\ 38 \\ 39 \\ 40 \\ 41 \\ 42 \\ 43 \\ 44 \\ 45 \\ 46 \\ 47 \\ 48 \\ 49 \\ 50 \\ \hline $				
	RAWING NO.	REFERENCE TO CON icm t—stat — m	APLETE TH	IS SHEET		IIZERS		
	ph.	DAVENPORT DRIVI (800) 824-2614 www	w.fibrebond.com			R E	ΒО	ND
		ALL WEST CON		S	*AP	PROV	ALS IN	
		12'-0" X 16'-( ALARM WIRIN	)" BUILDING		<u> </u>			
DRN.	GD	DATE:	APP.	DATE:	SCALE		SHEE	
	JC	18-DEC-2020 DATE:	^{by} : PM	DATE:		DWG NO.		
BY:	JC		BY:		В	D	01140	1

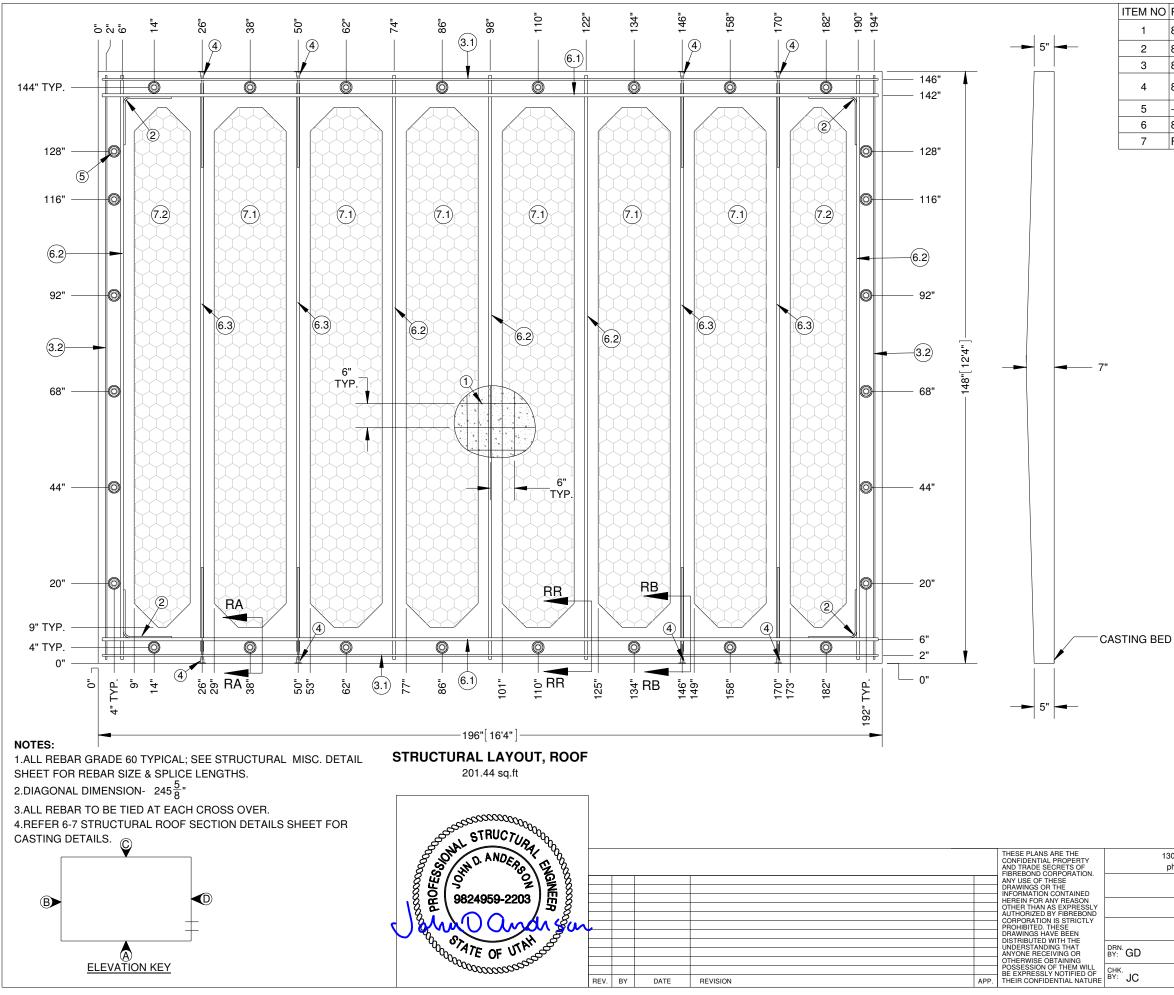

M NO	PART NUMBER	DESCRIPTION	QTY.
1	810-11400	WIRE MESH, 11'-6" X 20' D5-D5	0.87
2	810-11450	REBAR BEND, #3 X 24" 90 DEG	4
3	810-11442	REBAR, #3 (3/8") GRADE 60	56.67
4	806-40448	SPLICER, #4 X 24" DOWEL BAR 78194 (USA - 100%)	8
5	-	POCKET FORMER	28
6	810-11443	REBAR #6, (3/4") GRADE 60	140.5
7	FOAM	3" EPS FOAM INSULATION	-


ITEM NO	DESCRIPTION	QTY.	LENGTH
6.1	#6 REBAR	2	194"
6.2	#6 REBAR	5	146"
6.3	#6 REBAR	4	142"

ITEM NO	DESCRIPTION	QTY.	LENGTH
3.1	#3 REBAR	2	194"
3.2	#3 REBAR	2	146"

ITEM NO	DESCRIPTION	QTY.	LENGTH	WIDTH
7.1	FOAM	6	130"	18"
7.2	FOAM	2	130"	14"

ALL FOAM CORNERS ARE TO BE CHAMFERED 6"

1300 DAVENPORT DRIVE, MINDEN, LA 71055 ph. (800) 824-2614 www.fibrebond.com						ЗОИД	0
ALL WEST COMMUNICATIONS					D FOR: PROVA	L A.01*	
12' - 0" X 16' -	12' - 0" X 16' - 0" BUILDING					.S IN PDM BASE	
STRUCTURAL L	AYOUT, ROOF				ANGLE	$\oplus$	][
DATE: 04-JAN-2021	^{APP.} ^{BY:} <b>PM</b>	DATE:		SCALI 1:24	1	SHEET NO: 6-1	
DATE: APP. DATE: SIZI BY: B					DWG NO.: D1	1401	

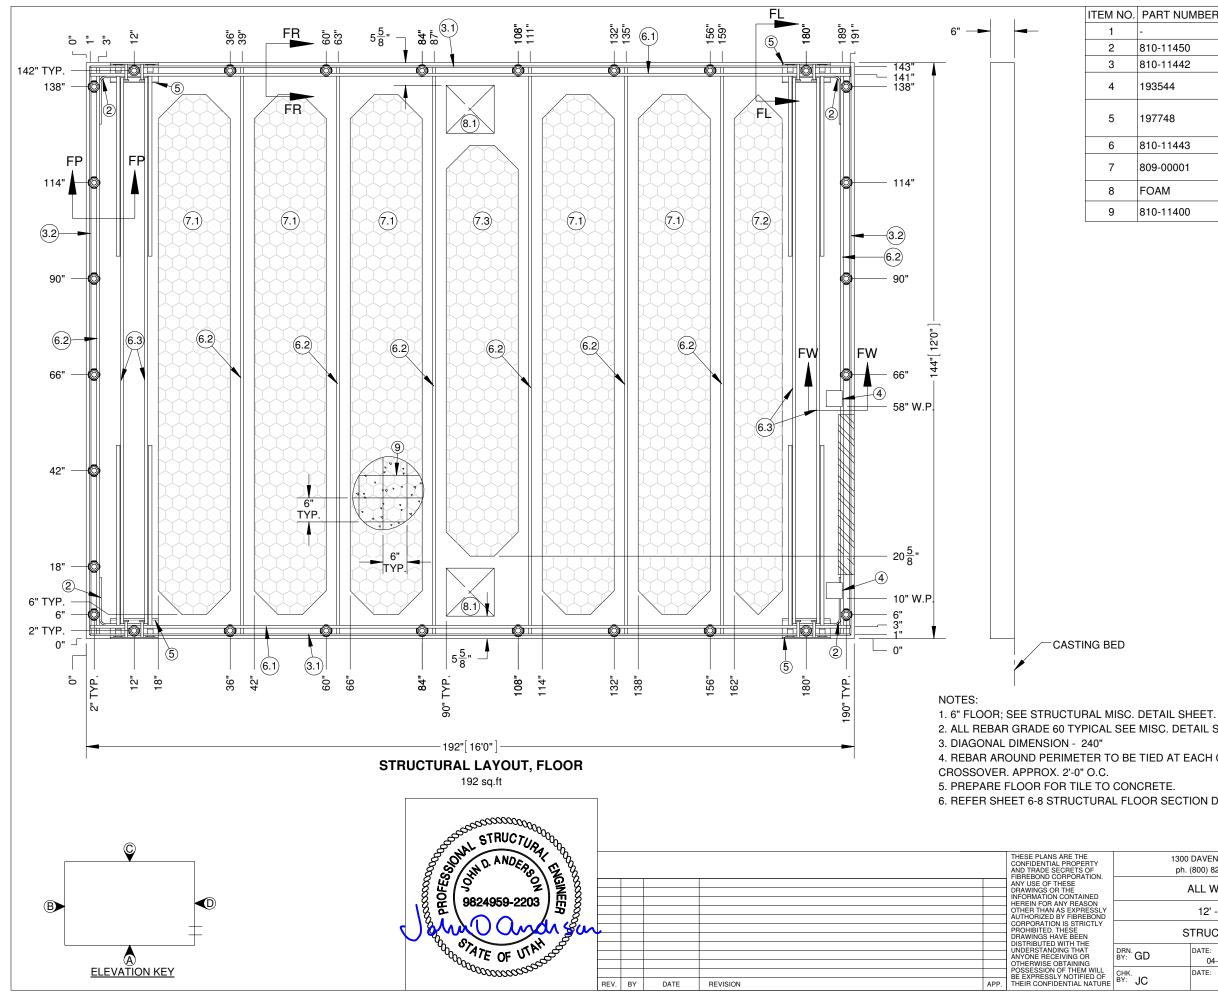

PART NUMBER	DESCRIPTION	QTY.
	POCKET FORMER	28
10-11450	REBAR BEND, #3 X 24" 90 DEG	4
10-11442	REBAR#3 (3/8") GRADE 60	55.33
93544	WELD PLATE ASSY 3/8" X 4" X 4" W/ 1/2" X 2 5/8" NELSON STUD	2
97748	INTERNAL LIFTING ANGLE ASSEMBLY 3/8" X 5" X 5" X 12" W/ #7 DB'S AND CENTER POCKET FORMER RELIEF	4
10-11443	REBAR#6 (3/4") GRADE 60	172.33
09-00001	EPS PURCHASE FOAM INSULATION - 130" X 18" X 4"	-
OAM	6" EPS FOAM INSULATION	-
10-11400	WIRE MESH, 11'-6" X 20' D5-D5	0.83

ITEM NO	DESCRIPTION	QTY.	LENGTH
3.1	#3 REBAR	2	190"
3.2	#3 REBAR	2	142"

ITEM NO	DESCRIPTION	QTY.	LENGTH
6.1	#6 REBAR	2	190"
6.2	#6 REBAR	8	142"
6.3	#6 REBAR	4	138"

ITEM NO	DESCRIPTION	QTY.	LENGTH	WIDTH
7.1	FOAM	5	130"	18"
7.2	FOAM	1	130"	12"
7.3	FOAM	1	102 3/4"	18"

ALL FOAM CORNERS ARE TO BE CHAMFERED 6"


ITEM NO	QTY.	DESCRIPTION	LENGTH	WIDTH
8.1	2	FOAM	12"	12"

2. ALL REBAR GRADE 60 TYPICAL SEE MISC. DETAIL SHEET FOR REBAR SIZE & SPLICE LENGTHS.

4. REBAR AROUND PERIMETER TO BE TIED AT EACH CROSSOVER. REMAINDER TO BE TIED AT EVERY 4TH

6. REFER SHEET 6-8 STRUCTURAL FLOOR SECTION DETAILS SHEET FOR CASTING DETAIL.

					÷ГВ	RE	золд
						D FOR: PROVA	L A.01*
	12' - 0" X 16' -	0" BUILDING			А	PPROVAL DATAE	
S	TRUCTURAL L	AYOUT, FLOOF	3			ANGLE ECTION	
	DATE: APP. DATE: 04-JAN-2021 BY: PM			SCAL 1:24	E	SHEET NO: 6-2	
	DATE:	APP. BY:	DATE:		SIZE B	DWG NO.: D1	1401

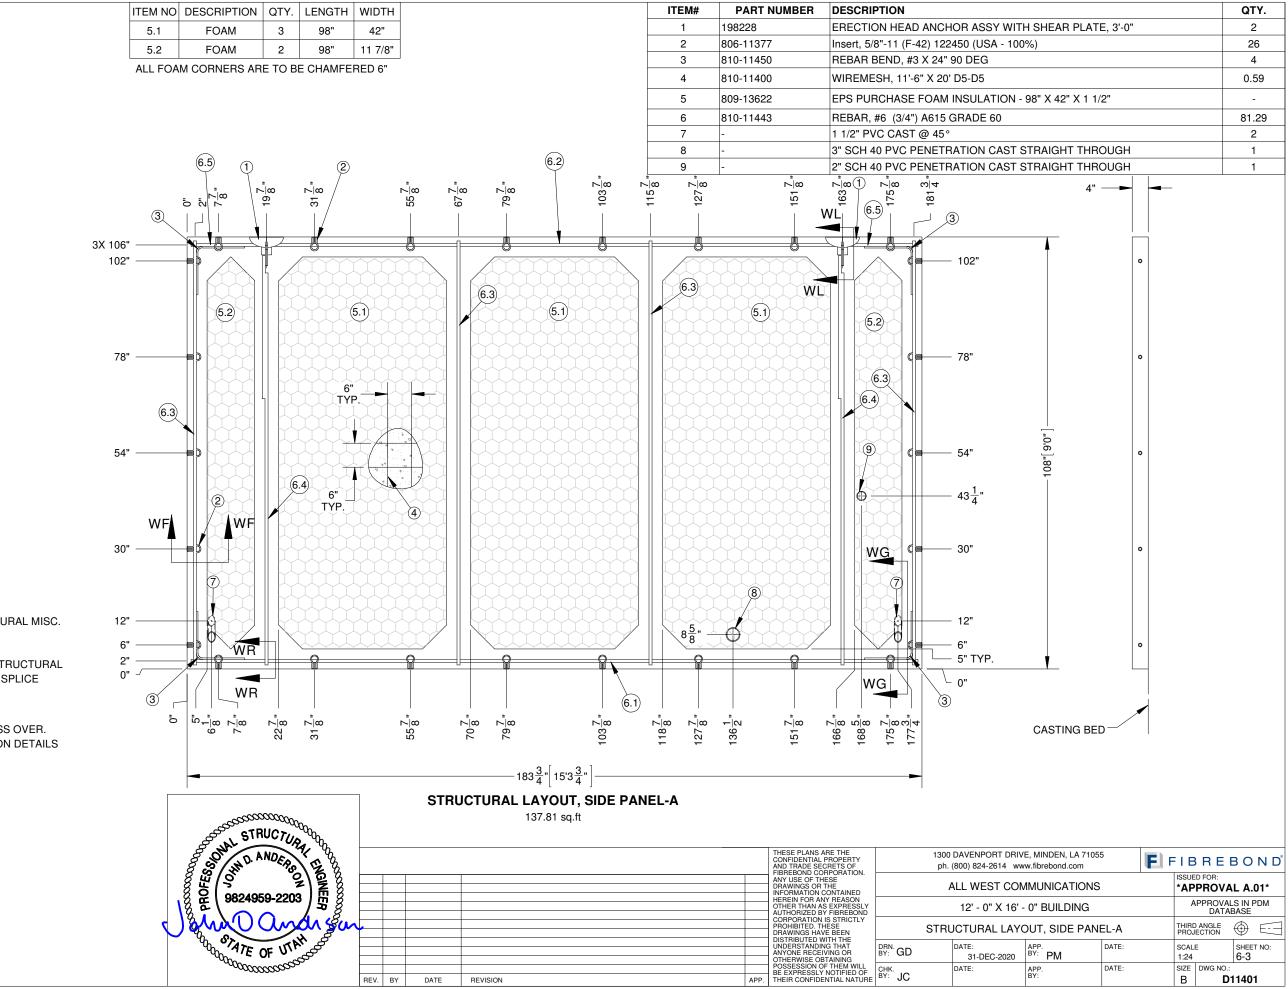

ITEM NO DESCRIPTION QTY. LENGTH 6.1 #6 REBAR 1 181 3/4" 6.2 140" #6 REBAR 1 6.3 4 106" #6 REBAR 6.4 #6 REBAR 98" 2 6.5 #6 REBAR 2 16 7/8"


NOTES:

1. TYPICAL 4" WALL PANEL; SEE STRUCTURAL MISC. DETAIL SHEET.


 SIDE PANEL CAST EXTERIOR SIDE UP.
 ALL REBAR GRADE 60 TYPICAL; SEE STRUCTURAL MISC. DETAIL SHEET FOR REBAR SIZE & SPLICE LENGTHS.


4. DIAGONAL DIMENSION - 213¹/₈"

 ALL REBAR TO BE TIED AT EACH CROSS OVER.
 REFER 6-9 STRUCTURAL WALL SECTION DETAILS SHEET FOR CASTING DETAILS.

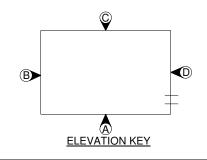

	DESCRIPTION	OTV		
ITEM NO	DESCRIPTION #3 REBAR	QTY.	LENGTH	-
3.1	#3 NEDAN	2	106"	J
		1	1	1
ITEM NO	DESCRIPTION	QTY.	LENGTH	
6.1	#6 REBAR	1	142"	
6.2	#6 REBAR	1	128"	
6.3	#6 REBAR	5	106"	
6.4	#6 REBAR	2	98"	
DETAIL 2. END 3. ALL F MISC. D LENGTH	CAL 4 " WALL PA SHEET. PANEL CAST EX REBAR GRADE 60 DETAIL SHEET FC	TERIOF D TYPIC DR REB	SIDE UP. CAL; SEE S AR SIZE &	TRUCTUR

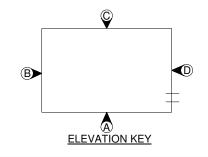

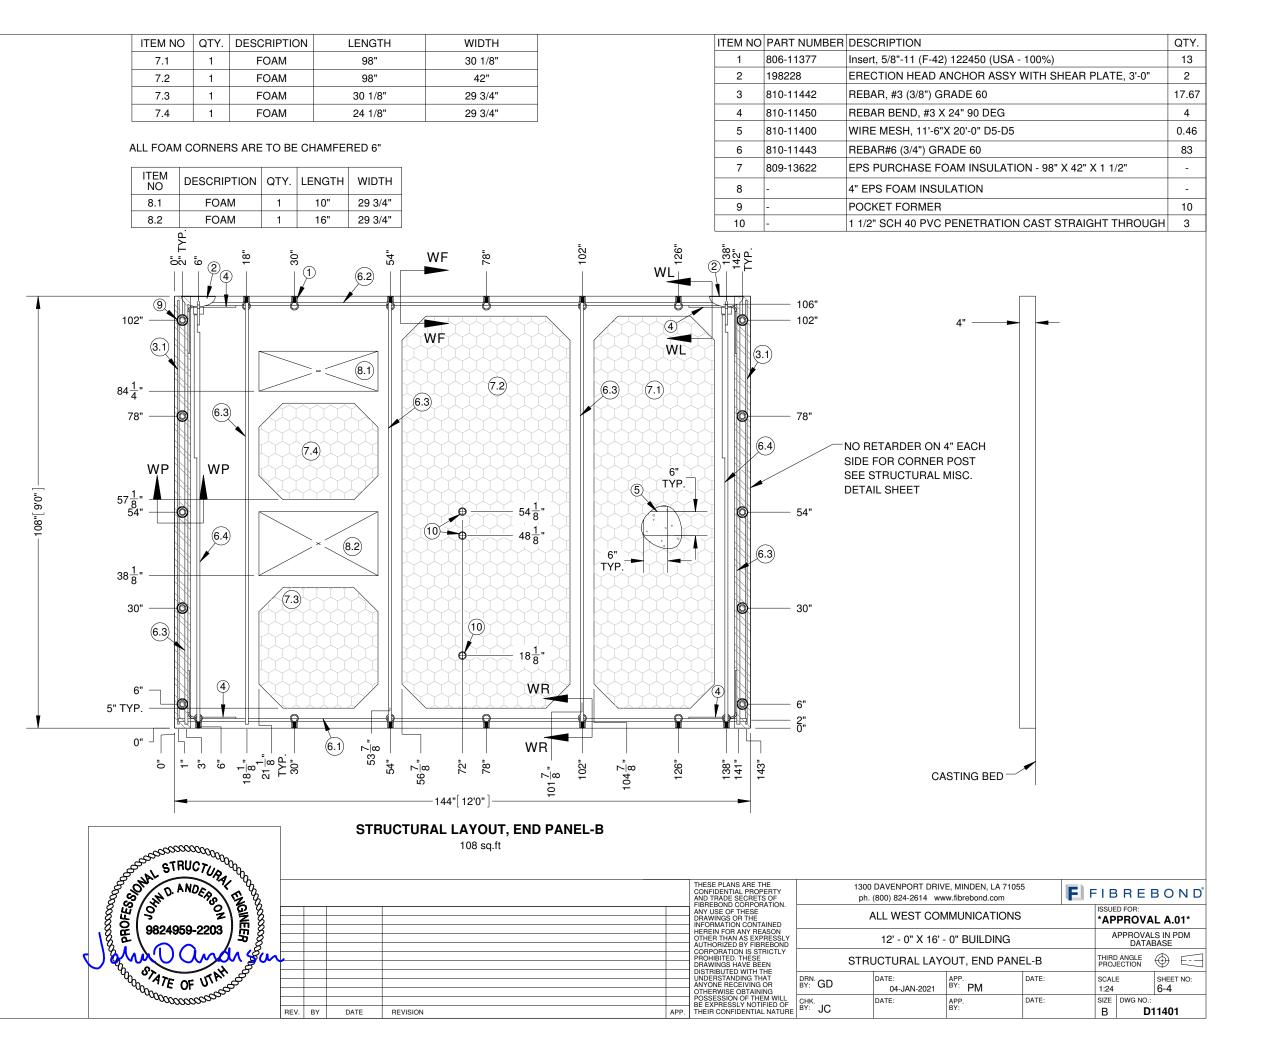

	1	1	1				
		PART NUMBER					QTY.
	1	806-11377	Insert, 5/8"-11 (F-42	, ,	,		26
	2	198228 810-11450	ERECTION HEAD A REBAR BEND, #3 >		WITH SHEAR	PLATE, 3-0	4
	4	-	1 1/2" PVC CAST @				3
	5	810-11400	WIRE MESH, 11'-6"				0.59
	6	810-11443	REBAR, #6 (3/4"), 0				81.29
	7	809-13622	EPS PURCHASE F			V 1 1/0"	- 01.29
	1	009-13022			JN - 30 X 42	X 1 1/2	
	$\begin{bmatrix} 1008\\ 175 \frac{7}{8} \end{bmatrix}$		<ul> <li>3X 106"</li> <li>102"</li> <li>78"</li> <li>54"</li> <li>54"</li> <li>30"</li> <li>12" TYP.</li> <li>6"</li> <li>5" TYP.</li> <li>0" TYP.</li> </ul>	IG BED	- 4"		
CONF AND FIBRI	E PLANS ARE T IDENTIAL PROP TRADE SECRET BOND CORPOP	ERTY S OF	1300 DAVENPORT DRIV ph. (800) 824-2614 ww		⁵⁵ E I		BOND
ANY DRAV INFO	USE OF THESE VINGS OR THE RMATION CONT/	AINED	ALL WEST COM	MUNICATIONS	3	ISSUED FOR: *APPROVA	AL A.01*
HERE OTHE AUTH	IN FOR ANY RE R THAN AS EXP IORIZED BY FIBP	ASON RESSLY REBOND	12' - 0" X 16'	- 0" BUILDING			LS IN PDM BASE
PROH DRAV	PORATION IS ST HIBITED. THESE WINGS HAVE BEI RIBUTED WITH T	EN	STRUCTURAL LAY	OUT, SIDE PAN	EL-C	THIRD ANGLE PROJECTION	$\oplus$
	NUDIED WIIH I		DATE:	APP.	DATE:	SCALE	SHEET NO:
UNDE ANYC	ERSTANDING TH DNE RECEIVING ERWISE OBTAINI	OR BY: GD	04-JAN-2021	^{BY:} PM	DATE.	1:24	6-5

ITEM NO	DESCRIPTION	QTY.	LENGTH
6.1	#6 REBAR	1	181 3/4"
6.2	#6 REBAR	1	140"
6.3	#6 REBAR	4	106"
6.4	#6 REBAR	2	98"
6.5	#6 REBAR	2	16 7/8"

NOTES:

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ALL FOAM CORNERS ARE TO BE CHAMFERED 6"

FOAM

FOAM

7.1

7.2

ITEM NO DESCRIPTION QTY. WIDTH LENGTH


3

42"

2 11 7/8"

98"


98"

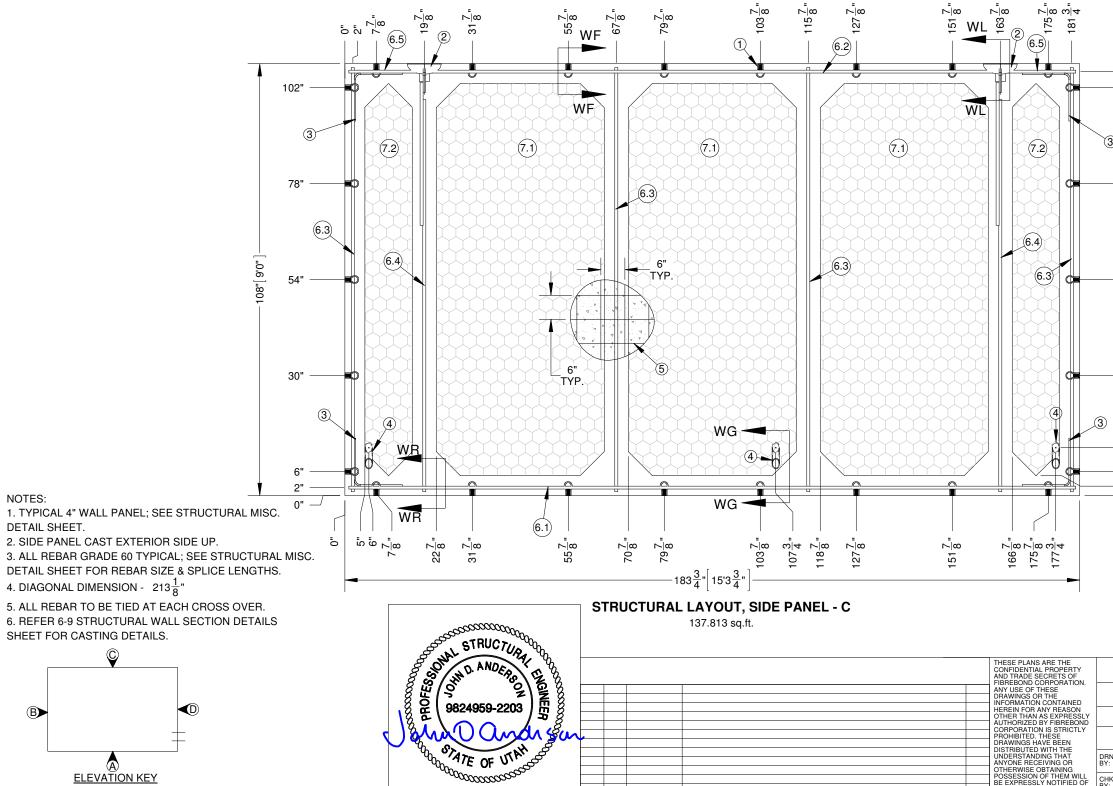

DATE

REV. BY


REVISION

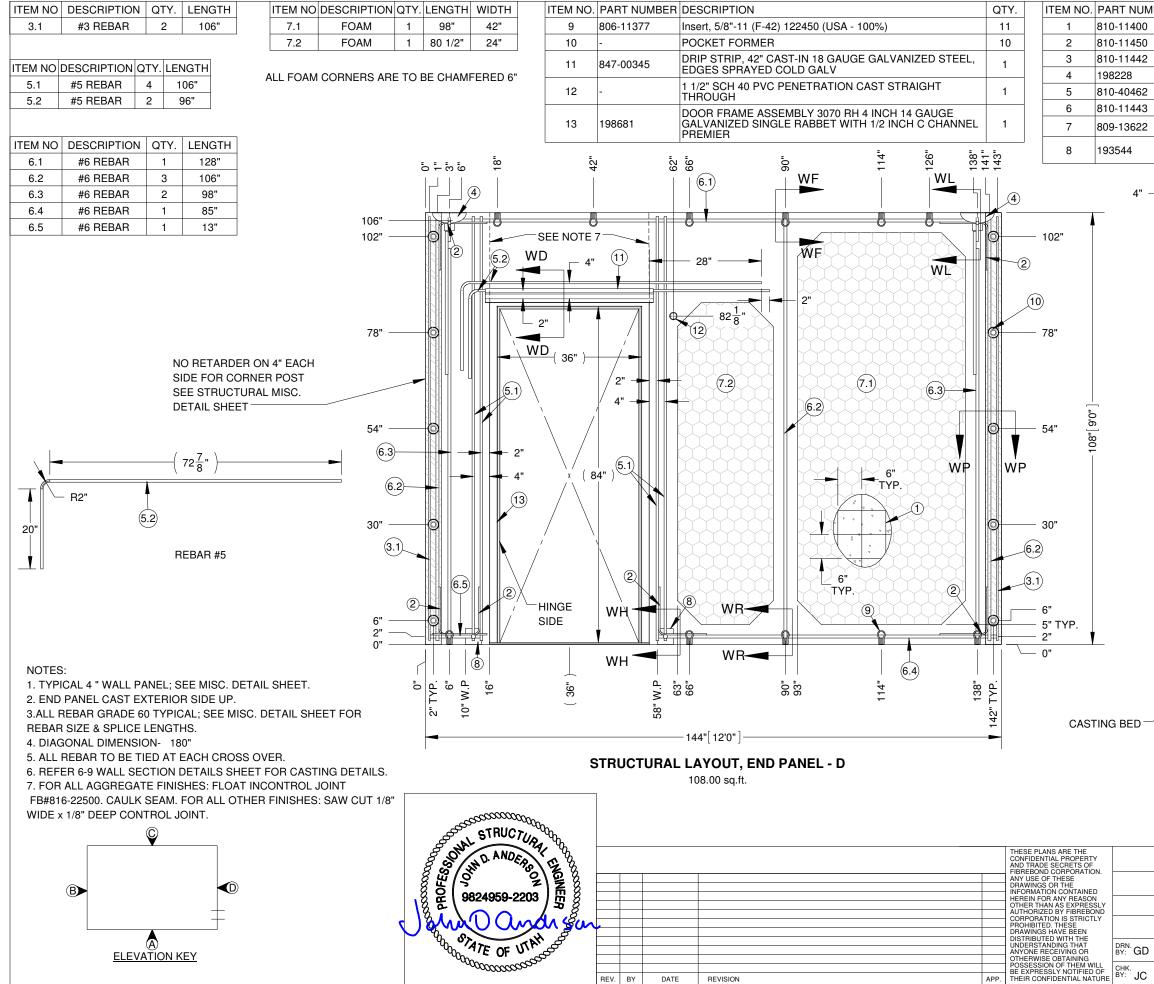


MBER	DESCRIPTION	QTY.
)	WIRE MESH, 11'-6"X 20'-0" D5-D5	0.47
)	REBAR BEND, #3 X 24" 90 DEG	6
2	REBAR, #3 (3/8") GRADE 60	17.67
	ERECTION HEAD ANCHOR ASSY WITH SHEAR PLATE, 3'-0"	2
2	REBAR, #5 (5/8") GRADE 60	51.33
}	REBAR, #6 (3/4") GRADE 60	61.67
2	EPS PURCHASE FOAM INSULATION - 98" X 42" X 1 1/2"	-
	WELD PLATE ASSY 3/8" X 4" X 4" W/ 1/2" X 2 5/8" NELSON STUD	2

1300 DAVENPORT DRIVE, MINDEN, LA 71055 ph. (800) 824-2614 www.fibrebond.com					:IB	REE	3 0	ND°	
						d for: PROVA	L A.(	)1*	
		12' - 0" X 16' -	0" BUILDING			A	PPROVAL DATAE		DM
	STRU	CTURAL LAYC	UT, END PANE	L - D			ANGLE ECTION	$\bigoplus$	$\square$
)		DATE: 04-JAN-2021 BY: PM			SCAL 1:24	E	SHEET	NO:	
		DATE	100	DATE.		CITE	DIALO NO .		

	12' - 0" X 16' - 0" BUILDING						DM
STRU	ICTURAL LAYC	L - D		ANGLE	$\bigoplus$		
	DATE: 04-JAN-2021	^{APP.} ^{BY:} <b>PM</b>	DATE:	SCALE SHEET NO: 1:24 6-6			ΓNO:
	DATE:	APP. BY:	DATE:	SIZE B	DWG NO.: D1	1401	I

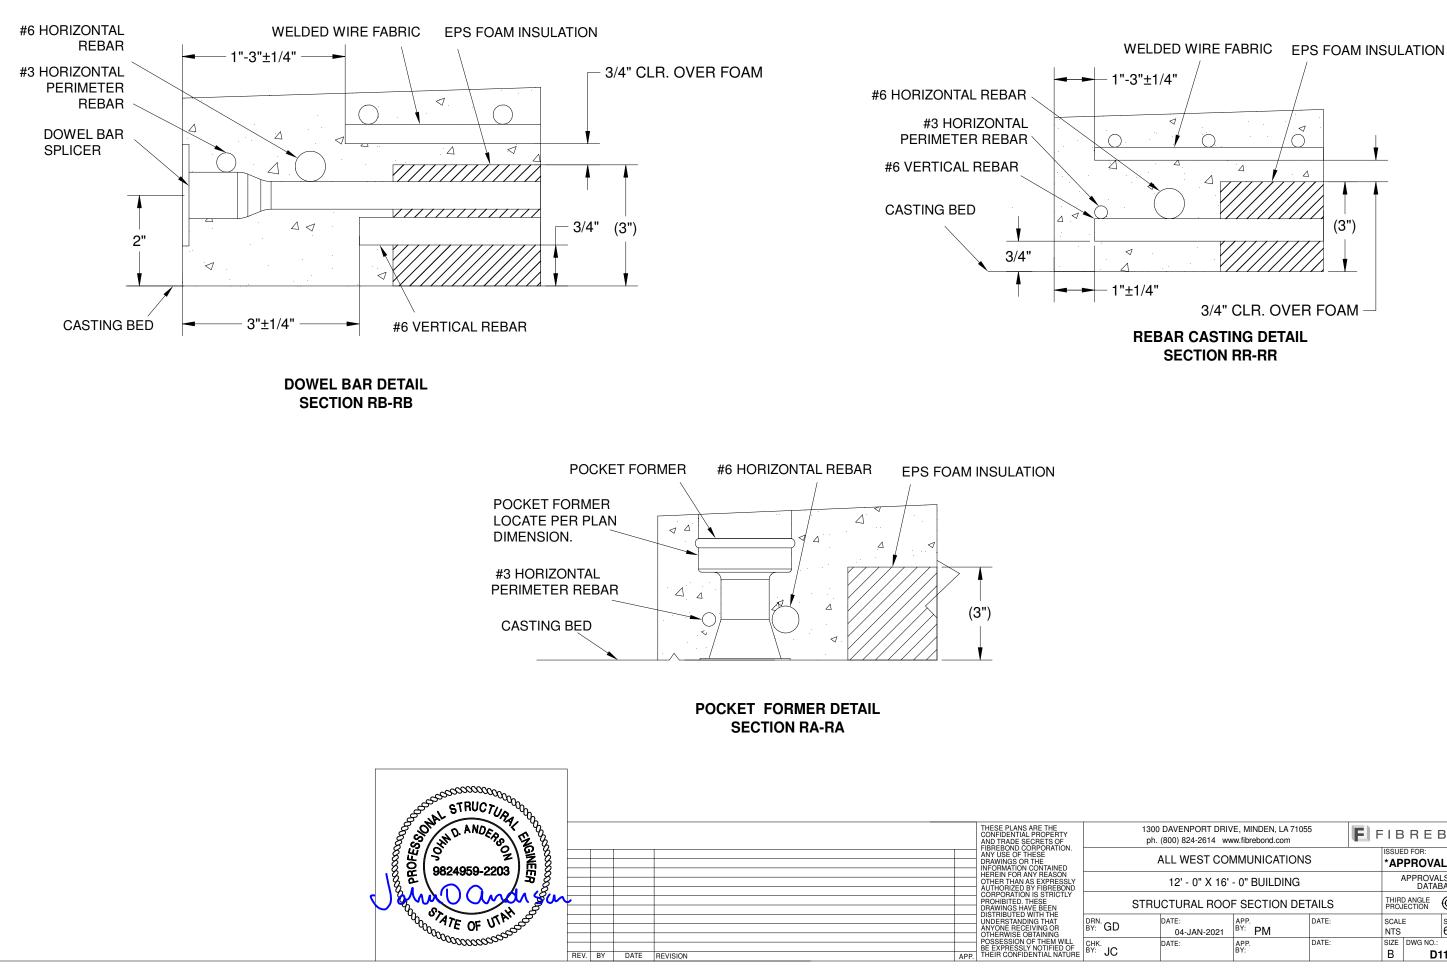


1"-3"±1	/4" /				
)					
(			(3")		
A					
1"±1/4"					
	3/4"	CLR. OVEF	r foam —		
REE	BAR CASTI SECTION	NG DETAIL RR-RR			
	DAVENPORT DRIV (800) 824-2614 ww	/E, MINDEN, LA 7105 ww.fibrebond.com	5 <b>E</b> F	I B	REBOND®
		MUNICATIONS	6		D FOR: PROVAL A.01*
	12' - 0" X 16'	- 0" BUILDING			APPROVALS IN PDM DATABASE
STRU		F SECTION DET	1		DANGLE
D	DATE: 04-JAN-2021	APP. BY: PM	DATE:	SCAL NTS	6-7
>	DATE:	APP. BY:	DATE:	SIZE B	DWG NO.: D11401

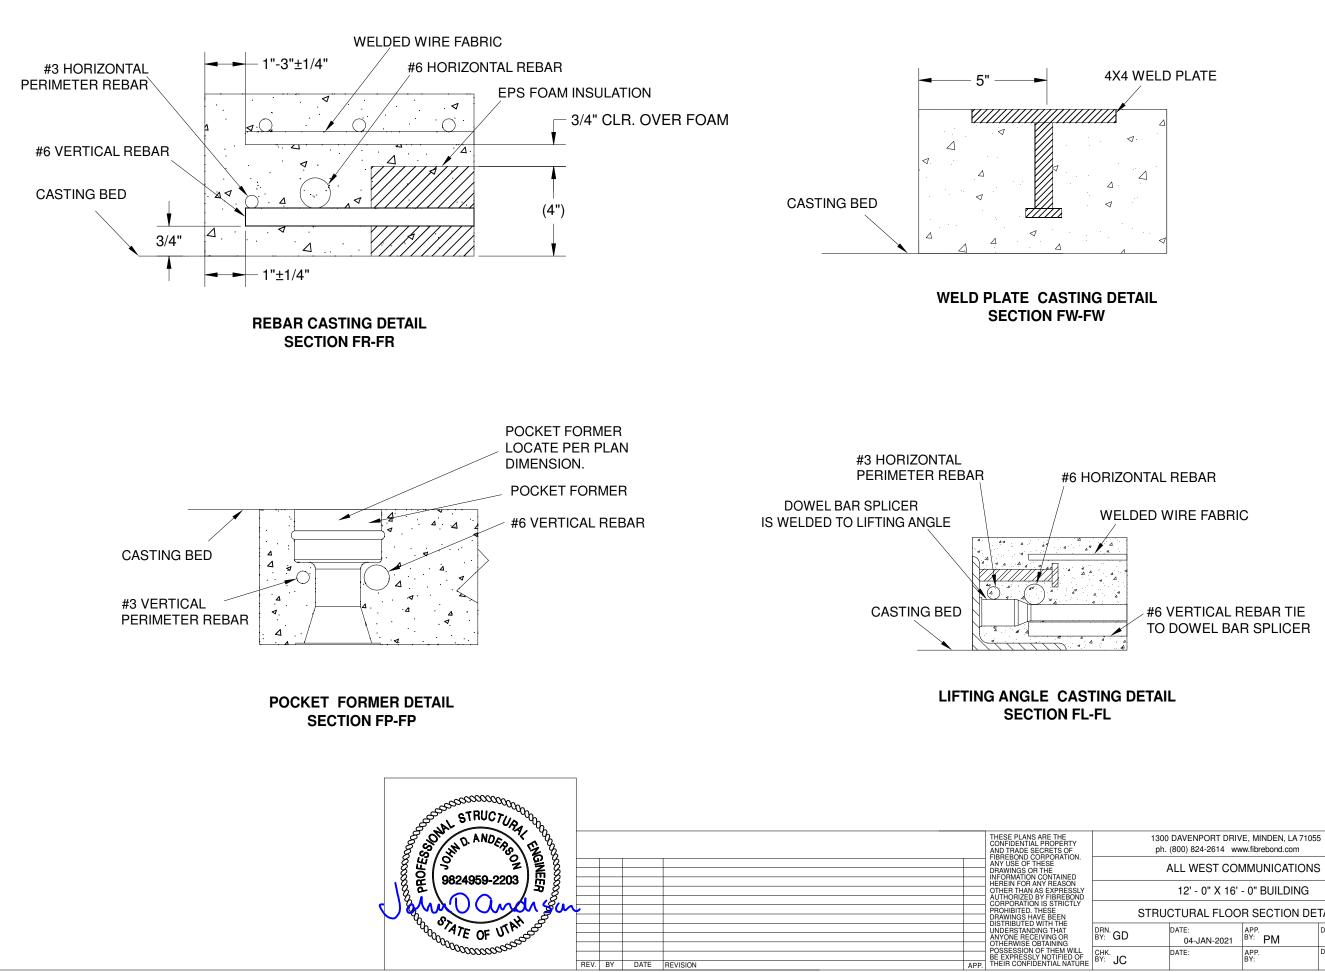

pri. (800) 824-2814 www.iibiebond.com						REE	3 O N D
	ALL WEST CON		d for: PROVA	L A.01*			
12' - 0" X 16' - 0" BUILDING						APPROVAL DATAE	LS IN PDM BASE
STRU	CTURAL FLOO	R SECTION DE	TAILS		THIRE PROJ	O ANGLE ECTION	
DATE: APP. DATE: BY: PM						E	SHEET NO: 6-8
	DATE:		SIZE B	DWG NO.: <b>D1</b>	1401		

## #6 VERTICAL REBAR TIE TO DOWEL BAR SPLICER

## WELDED WIRE FABRIC

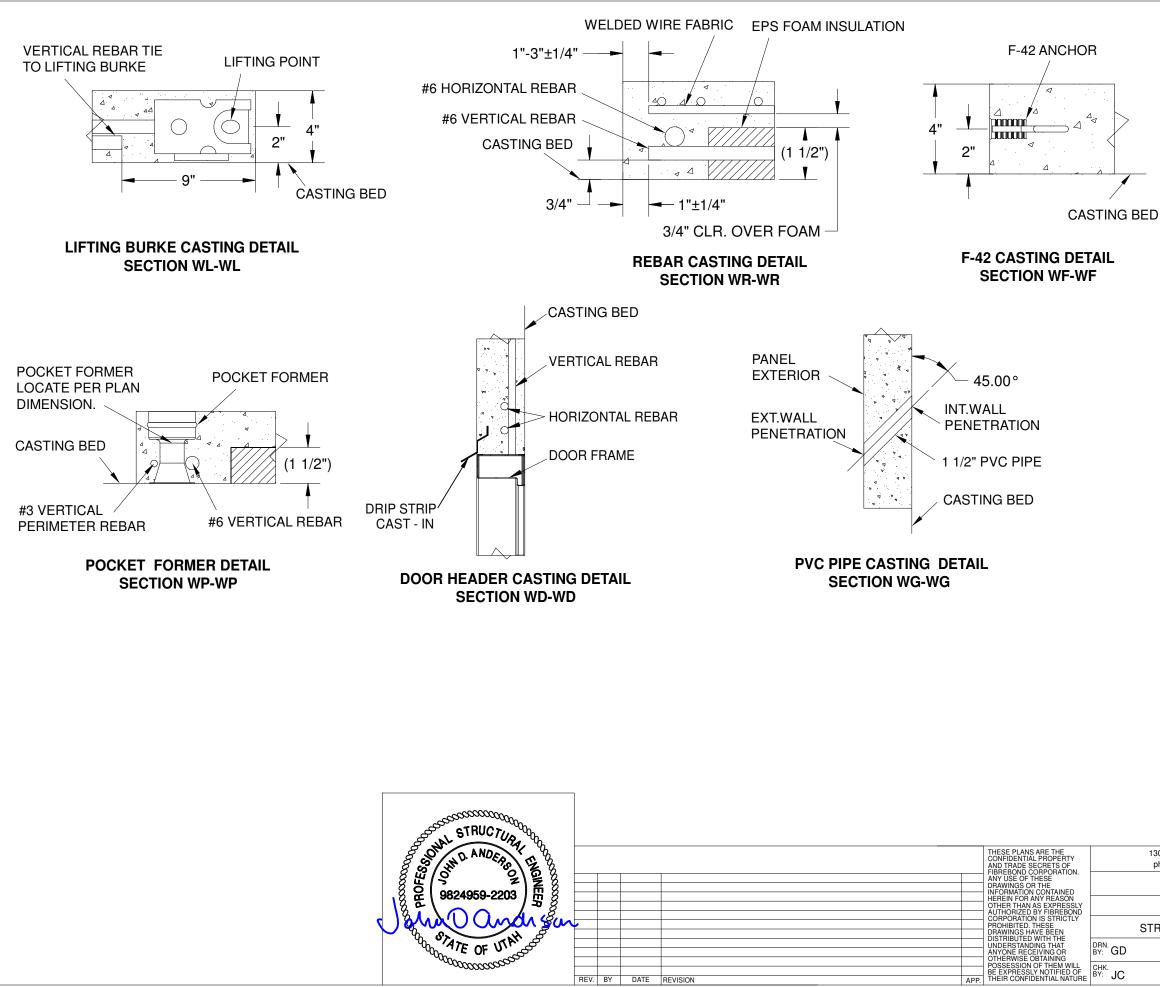

REV. BY DATE REVISION


	) DAVENPORT DRIV (800) 824-2614 ww	/E, MINDEN, LA 7105 w.fibrebond.com	5	E F	IВ	REE	BON	D°	
ALL WEST COMMUNICATIONS									
	12' - 0" X 16'	- 0" BUILDING			ļ	APPROVAI DATAE		1	
STRU	JCTURAL WALI	L SECTION DET	AILS			O ANGLE ECTION	• E	Ē	
S. GD	DATE: 04-JAN-2021	APP. BY: PM	DATE:		SCALE NTS	1	SHEET NO 6-9	:	
^{ik.} JC	DATE:	APP. BY:	DATE:		size B	DWG NO.: <b>D1</b>	1401		

WELD PLATE CASTING DETAIL

SECTION WH-WH

4X4 WELD PLATE CASTING BED

APP.

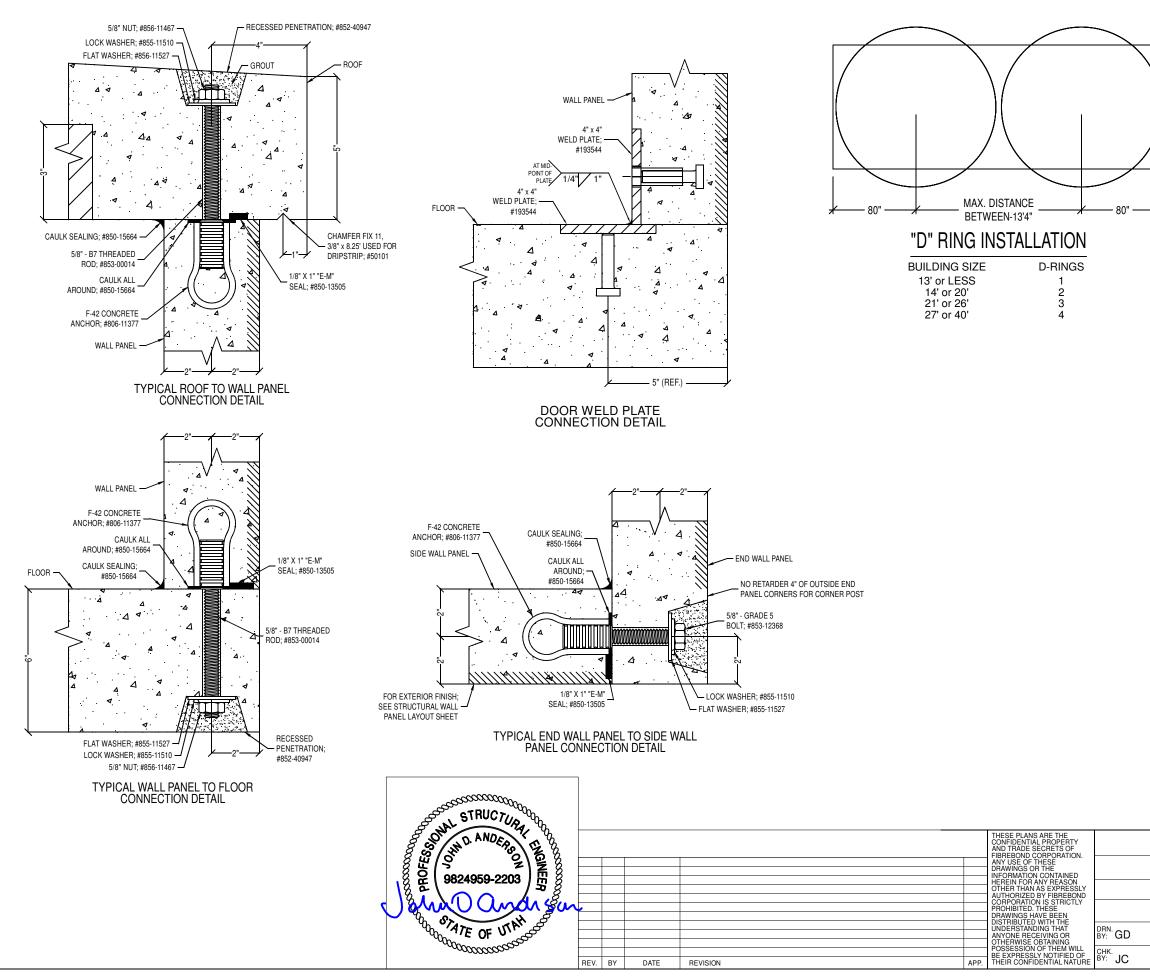

2

PANEL VOLUME / WEIGHT SCHEDULE APPROX. VOL. (yds.) APPROX. WT. (lbs.) PANEL LT. WT. NORMAL LT. WT. NORMAL ROOF 2.60 8454 FLOOR 2.23 7534 PANEL "A" 1.22 4025 PANEL "B" 0.98 3256 PANEL "C" 1.22 4028 PANEL "D" 0.83 2810 TOTAL 9.07  $\approx$ 30107

Refer to individual Structural Layout sheet for actual panel size

### Note:

Building weight is an approximation and shall not be used for Offloads or Shipping. Contact Fibrebond Corporation's Transportation Department for correct transportation weights.

REINFORCING SPLICE SCHEDULE										
SIZE	LIGHTWEIGHT CONCRETE	NORMAL WEIGHT CONCRETE								
WWF	8"	8"								
#2	12"	12"								
#3	17"	13"								
#4	22"	17"								
#5	28"	22"								
#6	33"	26"								

Stagger splice locations 2X splice length in adjacent bars

		ALL	PA	SQ. NEL	S:	
		38	35	0.07		
1300 DAVENPORT DRIVE, MINDEN, LA 710 ph. (800) 824-2614 www.fibrebond.com	E F	ΙB	RE	во	ND°	
ALL WEST COMMUNICATION	S			D FOR:	L A.0	1*
12' - 0" X 16' - 0" BUILDING			1	APPROVA DATA		PDM
STRUCTURAL MISC. DETAILS	6		THIRE	D ANGLE ECTION	$\odot$	Ē
DATE: APP. 04-JAN-2021 BY: <b>PM</b>					^{SHEET} 6-10	NO:
DATE: APP. BY:	DATE:		SIZE B	DWG NO.: D	11401	

## ITEM LIST

ART NUMBER	DESCRIPTION	QT	/MFG1	MFG#1
	CABLE TRAY, MOUNTING ANGLE 4"	4		
194341	GROUND BAR HARGER, 1/4"X4"X20" 1" PATTERN COPPER GB14420J NO HARDWARE	1		
194713	CABLE TRAY, ZINC 12" X 116.5" X 1-1/2" CENTRAL STEE 10012ZYL (USA)		23 LB/EA 1020 LB/PALLET, FC 5	
194715	CABLE TRAY, ZINC 18" X 116.5" CENTRAL STEEL 10018ZY (USA)	3	27 lb/ea 1180 lb/pallet, FC 50	10018ZY, 40/skid
800-00049	NGF End Guard 7' x 24" ADC NGF-ACCEGD007	1	ADC	NGF-ACCEGD007
800-00048	NGF Fiber Storage Bay ADC NGF-ACCFOTSB	1	ADC	NGF-ACCFOTSB
800-00095	NCNR, BC-4: Cable Bracket Kit, Straight, 4 INC 1265198	72	TE Connectivity	BC-4/1265198
800-00110	Extender Bracket Kit 19"-23", EXTR-23-19-EIAU-BK	4	TE Connectivity	EXTR-23-19-EIAU-BK
800-00157	Rectifier, eSure, 2000W, -48VDC, 1R482000E3	2	Emerson Network Power	1R482000E
	Equipment Rack, Panduit 8" x 19" Black Aluminum EIA #R2P	3	Panduit	
800-00280	Power System, Vertiv NetSure 5100 (includes Dist. Cabinet, 19" 2 Row, 600A) #582137100	1		
800-00281	Battery Modules, Narada 48VDC, 100AH, 19" rack mount, w/two dry contacts for other alarms, Lithium Ion #48NPFC100	1		
800-00282	Relay Rack, Alpine Power Systems 84"H x 19"W 45RU Welded, #559824	1		
800-00283	Frame, Commscope 30" x 24" x 7' FMDF NGF Optical Distribution Frame #NGF-MDF7A100	2		
800-00284	Fiber Optic Entrance Cabinet, Commscope 2592 ribbon fibers, single drawer #FEC-864	1		
800-00285	Termination Panel, Commscope Rapid Fiber 48-position 1RU, indoor RBR LCUPC/MPO 31M, #RCP-1K4PUE03100	2		
800-00286	Termination Panel, Commscope 72-position 3RU, Indoor RBRSC UPC MPO, Rapid Fiber #RCP-377PUE03100	10		
800-00287	NGF Fiber Termination Block, Commscope with IFC cable, 144-SC-UPC 31M PIC, #NGF-TB1MLU70ZD031	3		
800-00288	NGF Fiber Termination Block, Commscope w/IFC cable, 144 LC/UPC, singlemode, right orinented #NGF-TB1MRU70ZD031	3		
800-00289	NGF Fiber Termination Block, Commscope 144 LC/UPC, singlemode, left oriented, MPO at rear end, #NGF-MPML0K512	3		
800-00290	NGF Fiber Termination Block, 144 SC/APC, singlemode, right oriented, MPO at rear end, Commscope NGF-MPMR0L512	3		
800-00291	Fiber Optic Splice Tray, Commscope FST-D-HS	36		
800-00292	IFC/OSP Three-Tier Cable Clamp Kit, Commscope OSP-CLPFEC	10		
813-00073	TELCO BOARD 813-00067 3/4" X 48' X 96" NUPOLY 813-00067 WITH 814-00024 CAP TRIM	1		
	GENERATOR RECEPTACLE COVER, TAYMAC, WEATHERPROOF IN-USE COVER, #MX6200	1		
	BOX, THOMAS & BETTS 4" X 4" J-BOX 1/2" & 3/4" KO (USA-ARRA) #521711234E		CROUSE HINDS	TP403
822-10150	BOX, THOMAS & BETTS 4 11/16" DEEP 3/4" & 1" KNOCKOUTS (USA) #72171-3/4 &1		ABB	72171 3/4 1
822-10102	ENCLOSURE, UNITY 6" X 6" X 4" SCRWCVR NK (USA)		Unity	664SCNK
	BOX, PASS & SEYMOUR 2" X 4" 1G 1/2" OUTDOOR WEATHERPROOF (IND)		CROUSE HINDS	TP7010
	Condulet, Thomas & Betts 2" Mogul W/Cover (MEX) #MALB-6		Thomas & Betts	MALB-6
	COVER, PASS & SEYMOUR 4" X 4" W/P BLANK (USA)		MULBERRY	WPB2
	COVER, FASS & SETMOOR 4 X 4 W/F BLANK (USA) COVER, TAYMAC 2" X 4" GFCI WEATHERPROOF HORIZONTAL ALUMINUM (MEX) #MX3300		13765 - T & B RED DOT	CKMU
	BOX, PASS & SEYMOUR 4" X 4" W/P J-BOX W/ 3/4" PLUG (IND) #WPB332		PASS & SEYMOUR	WPB332
	COVER, CUTLER HAMMER, SURFACE MOUNT, PLUG NEUTRAL FOR 150A OR GREATER MB LC, X7 #CHPX7BS	1	PASS & SETWOON	VVFD332
823-01345	LOADCENTER, CUTLER HAMMER PLUG NEUTRAL, 200A, 1PH, MAIN BREAKER, 42 SPACE #CHP42B200X7	1		
824-00935	Transfer Switch, Cummins Auto 225amp 3 pole 240 volt 1PH Nema 1 #OTEC		Cummins	OTEC
824-10136	Transfer, Cutler Hammer 200A 2P N/F #DT224UGK		Cutler Hammer	DT224UGKFB
826-00055				DIZZ4UGKFD
820-00000	GENERATOR RECEPTACLE, HUBBELL, 50A, 125/250V AC, 3P4W, #CS6375 RECEPTACLE, COOPER WIRING DEVICES 20 AMP 125V BACK AND SIDE WIRED DUPLEX (USA) #BR20I	1		BR20V
			COOPER WIRING DEVICES	
	RECEPTACLE, HUBBELL INC. 20 AMP GFCI WEATHER RESISTANT #GFWRST20I (CHN) SWITCH, HUBBELL INC. 20 AMP 120V SINGLE POLE AC TOGGLE BACK WIRED IVORY #CSB120I (CHN)		HUBBELL	GFWRST20W CSB120I
	Socket, IDEC Relay 300V AC (1 & 2-pole 25 Amp, 3-pole 20 Amp)		HUBBELL, INC.	SR3B-05
827-12964			IDEC	RR2P-UAC240V
	Relay, IDEC 2PDT 240V AC 8 Pin Coil Rating 3VA (CHN) #RR2P-UAC240V			
831-00239	FIXTURE, EATON 4' LED CSA COMPLIANT #4WNLED-LD4-40SL-F-UNV-L840-CD1-U	6		4WNLED-LD4-40SL-F-UNV-L840-C
	FIXTURE, WESTGATE EXTERIOR LED 15 WATT WALLPACK WITH PHOTOCELL #LESW-15W-50K-P	1		
	THERMOSTAT, ELECTRONIC NON-PROGRAMMABLE, 2-STAGE HEAT AND 2-STAGE COOL AND HEAT PUMP #ICM SC4811	1	DAYTON	4111110
	THERMOSTAT, DAYTON SPDT #1UHH2		DAYTON	1UHH2
835-11307	ALARM BLOCK, SIEMON #S66M1-100 MH-49	1	11307 - SIEMON	S66M1-100MH49

	STRUCTURATE STRUCT						THESE PLANS ARE THE CONFIDENTIAL PROPERTY AND TRADE SECRETS OF FIBREBOND CORPORATION.	
	9824959-2203						ANY USE OF THESE DRAWINGS OR THE INFORMATION CONTAINED HEREIN FOR ANY REASON OTHER THAN AS EXPRESSLY AUTHORIZED BY FIBREBOND CORPORATION IS STRICTLY	
2	STATE OF UTAN						PROHIBITED. THESE DRAWINGS HAVE BEEN DISTRIBUTED WITH THE UNDERSTANDING THAT ANYONE RECEIVING OR OTHERWISE OBTAINING	DRN. BY: GD
	COCCOCCOUNT	REV.	BY	DATE	REVISION	APP.	POSSESSION OF THEM WILL BE EXPRESSLY NOTIFIED OF THEIR CONFIDENTIAL NATURE	^{CHK.} ^{BY:} JC

	(800) 824-2614 ww	IВ	REE	3 O N D			
	ALL WEST COM		d for: PROVA	L A.01*			
	12' - 0" X 16' -		A	PPROVAL DATAE			
	BILL OF M	ATERIALS				ANGLE	
)	DATE: APP. DATE: BY: PM						SHEET NO: 8-1
	DATE:	SIZE DWG NO.:					
		BY:			В	D1	1401
	•						

PART NUMBER	DESCRIPTION	QT	MFG1	MFG#1
837-00119	DRIP STRIP, MARVAIR & BARD 4 THRU 6 TON 46" PAINTED AC	1		
837-01158	HVAC, MARVAIR 6 TON 10 EER 1PH 5K WITH ECONOMIZER R410A #MGA1072AA050C++1+1CA+A11+++++	1	Marvair	MGA1072AA050C++1+1CA+A11+++++
837-11382	GRILL, 30" X 10" SUPPLY, #GR-L-VH-3010	1	11382 - Tuttle & Bailey	A64 3/4" SPACING
837-11388	GRILL, 30" X 16" RETURN AIR, #GR-L-RA-3016	1	11388 - Tuttle & Bailey	A70D 3/4" SPACING
841-00180	KIT, GENUINE FIRST AID 10 PERSON #FA-10P (34WK73)Ð	1	Genuine First Aid	FA-10PĐ
841-10007	PLÁTE, 4" X 6" BLUE PLASTIC	1		
841-13867	TRAY, WALL POCKET (USA)	1		DEFLECTO 63202 SMOKE, 12/CTN
842-00220	BRACKET KIT, TE CONNECTIVITY COMMSCOPE 5/8" THREADED ROD FIBER TRAY #FGS-HNTR-5/8 / 1176647	23	COMMSCOPE	
842-00221	FIBER TRAY, TE CONNECTIVITY COMMSCOPE STRAIGHT EXTENSION TROUHGH SECTION YELLOW #FGS-MSHS-B / 1135504	3	COMMSCOPE	
842-00226	Tee Cover Kit, TE Connectivity 4" x 6"Yellow Snap-On Fiber Tray #FGS-SHRT-B / 1059403	6	TE Connectivity	FGS-SHRT-B/1059403
846-00664	DOOR, PREMIER 3070 LHR 16G GALV CY PREP 35 3/4" STANDARD HINGE SERIES POLYSTYRENE CORE #S16-4	1		S16-4
847-00861	CLOSER, DESIGN HARDWARE OPENING RANGE SET TO 90 TO 180 DEGREE, UP TO 187LB DOOR #116 SERIES AL, DOOR	1		116 SERIES AL
847-00862	CLOSER ARM, DESIGN HARDWARE #116 SERIES AL ADJUSTABLE TYPE HOLD OPEN ARM DOOR	1		316/116 AL ADJUSTABLE HO ARM
847-10789	LOCK, BEST DEADBOLT #83T-7-K-STK-626 LESS CORE	1	BEST	83T-7-K-STK-626-LESS CORE
847-11050	HANDLE, SIERRA PACIFIC DOOR PULL (5-1/2") FORMED PULL ZINC PLATED #917	2		ROCKWOOD - ALUMINUM
847-11073	HINGE, 4.5" X 4.5" .134 THICKNESS S/S BB NRP (CHN), #CS4545BBNRP-32D	3	GLOBAL	CS4545BBNRP-32D
847-11800	CORE, BEST SFIC CONSTRUCTION, DARK GREEN 7 PIN	1	BEST	
847-12348	THRESHOLD, PEMKO 3 1/2" X 36" ALUMINUM PANIC BUMPER SEAL #1855AV	1	Pemko	
847-12569	DOOR SWEEP, PEMKO 36" CLEAR ANODIZED ALUMINUM/RUBBER #321-NC-36	1	Pemko	321CN36, 50/Box
847-22816	LOCKGUARD, 6 1/4" X 7" HEAVY DUTY 12 GAUGE CUSTOM IMPORT	1		Import, 25/case
847-23485	WEATHERSTRIP, PEMKO 3070 3-PC MAGNET (INT) #2815CM3684	1	Pemko	2815CM36
848-00070	DETECTOR, GENTEX SMOKE ALARM 120VAC/9VDC W/RELAY, #S1209F 917-0057-002	1	GENTEX	S1209F
848-11351	CONTACTS, GEORGE RISK INDUSTRIES SPDT FORM C GRAY DOOR #29C	1	GRI	GRI 29C
849-22543	EXTINGUISHER AMEREX 10 LB C02 10B:C 330 INCLUDES WALL HANGER	1	AMEREX	

## PACKING LIST

ITEM#	QTY.	FIBREBOND PART#	MFG'S PART#	MANUFACTURER	DESCRIPTION
-	4	197788		FINE	TIEDOWN, PLATE FOUNDATION 1/2" X 10" X 12" GAL
-	1	838-00345	CUMMINS		GENERATOR, CUMMINS 36KW, NG FUELED, EXTE
-	1	841-50030		143-9470	BRUSH; 1" PAINT (#47
-	6	850-00226	PRAIRIE	UROFLEX MS-30	CAULK, PRUROFLEX MS-30 ADHESIVE/SEALANT 10.3 OZ
-	0.25 GAL	851-00263	Thorolastic	FINE	PAINT, THOROLASTIC MES
-	8	854-00036		STB2-75614	ANCHOR, 3/4" X 6 1/4" SIMPSON STRONG BOLT 2, I

	STRUCTURA							
							THESE PLANS ARE THE CONFIDENTIAL PROPERTY AND TRADE SECRETS OF FIBREBOND CORPORATION.	
							ANY USE OF THESE DRAWINGS OR THE INFORMATION CONTAINED	
							HEREIN FOR ANY REASON OTHER THAN AS EXPRESSLY AUTHORIZED BY FIBREBOND	
7	Jame Under gen						CORPORATION IS STRICTLY PROHIBITED. THESE DRAWINGS HAVE BEEN DISTRIBUTED WITH THE	
	STATE OF UT M						UNDERSTANDING THAT ANYONE RECEIVING OR OTHERWISE OBTAINING	BY: GD
	TO COLORIDO	REV.	BY	DATE	REVISION	APP.		^{CHK.} ^{BY:} JC

* VARIES WITH SIZE OF BLDG., SEE SEQUENCE 80

### LVANIZED W/1 1/16" & 7/8" HOLES

TERIOR, 120/240V, 1PH, #C36N6

474)

OZ CARTRIDGE - PRARIE TORQUE TAN

ESA TAN

, ICCES APPROVED STB2-75614

	1300 DAVENPORT DRIV ph. (800) 824-2614 ww	I B	RE	B O N D				
	ALL WEST COM		D FOR: PROVA	L A.01*				
	12' - 0" X 16' -	A	PPROVAL DATAE					
	BILL OF M	ATERIALS				ANGLE ECTION		
)	DATE: 27-NOV-2020	^{APP.} ^{BY:} <b>PM</b>	DATE:		SCAL NTS	E	SHEET NO: 8-2	
	DATE:	APP.	DATE:		SIZE	DWG NO .:		
		BY:			В	B <b>D11401</b>		