### TAYLOR LANDING PHASE 1A/2

A CLUSTER SUBDIVISION

PART OF THE NORTH HALF OF SECTION 28, TOWNSHIP 6 NORTH,

RANGE 2 WEST,
SALT LAKE BASELINE AND MERIDIAN
WEBER COUNTY, TAYLOR, UTAH

INDEX SHEET

--- PROJECT



VICINITY MAP

OWNER/DEVELOPER SIERRA HOMES

CIVIL ENGINEER
ALLIANCE CONSULTING
ENGINEERS, INC.
150 EAST 200 NORTH SUITE P
LOGAN, UTAH 84321
435-755-5121

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4	2025 SOUTH/3900 WEST ROAD PLAN
5	IRRIGATION RE-ROUTE PLAN
6	EAST GRADING/DRAINAGE PLAN
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8	DETAILS



ANCE CONSULTIN ENGINEERS 150 EAST 200 NORTH SUITE LOGAN, UTAH 84321 (435)755-5121



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ARE DISTRIBUTED FOR
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AUTHORIZED USE, DISCLOSURE, OR COPYING OF TAWING IS PROHIBITED.

NSTRUCTION DOCUMENTS THAT ARE DISTRIBUTED FAING PURPOSES SHALL NOT BE RETURNED AND SUBSTROYED WITHIN 30 DAYS AFTER THE BID OPETHE PLAN HOLDER.

No. REVISIONS/ SUBMISSIONS DATE

REVIEWED:

CAD FILE:

REVISIONS/ SUBMISSIONS

DRAWN:

PROJECT NO.:

ANDING PHASE 1A/2 ISTER SUBDIVISION

'AYLOR LANDING A CLUSTER

DATE: NOV,2020
DRAWING No.

1. ALL CONSTRUCTION AND MATERIALS SHALL BE IN ACCORDANCE WITH THE PROJECT SPECIFICATIONS, WEBER COUNTY STANDARDS, STATE OF UTAH AND ANY OTHER APPLICABLE STANDARDS ISSUED BY THE CONTROLLING AGENCY.

2. CONTRACTOR SHALL FIELD VERIFY ALL DIMENSIONS BEFORE CONSTRUCTION. ANY DISCREPANCIES BETWEEN CONSTRUCTION DOCUMENTS AND FIELD CONDITIONS SHALL IMMEDIATELY BE BROUGHT TO THE ATTENTION OF THE OWNER. ANY WORK COMPLETED WITHOUT DOING SUCH IS DONE SO AT THE CONTRACTORS EXPENSE.

3. CONTRACTOR SHALL REPAIR AND/OR REPLACE ANY AREAS AND/OR MATERIALS DAMAGED DURING CONSTRUCTION.

4. CONTRACTOR SHALL MAINTAIN ALL ADJACENT PROPERTY (PUBLIC & PRIVATE) FROM ALL CONSTRUCTION DEBRIS.

5. CONTRACTOR SHALL PROVIDE SMOOTH TRANSITION FROM ALL NEW CONSTRUCTION TO EXISTING CONDITIONS.

6. CONTRACTOR SHALL PROVIDE ALL NECESSARY AUTOMOBILE AND PEDESTRIAN TRAFFIC CONTROL DEVICES REQUIRED BY LOCAL, STATE, AND FEDERAL CODES AND ORDINANCES.

7. CONTRACTOR SHALL REPLACE SURVEY MONUMENTS DAMAGED DURING CONSTRUCTION. SURVEY MONUMENTS TO BE REPLACED BY A REGISTERED, LICENSED LAND SURVEYOR.

8. CONTRACTOR TO LOCATE ALL EXISTING UTILITIES, INCLUDING FIBER OPTIC. ANY DAMAGES TO EXISTING UTILITIES WILL BE REPAIRED AT CONTRACTORS EXPENSE.

10. DISTANCES SHOWN ALONG PIPELINES ARE HORIZONTAL DISTANCES AND NOT ACTUAL

9. DIMENSIONS SHOWN ARE TO THE CENTER OF THE PIPELINE UNLESS OTHERWISE NOTED.

PIPE LENGTHS. MORE PIPE MAY BE REQUIRED TO COMPLETE CONSTRUCTION THAN IS DIMENSIONED IN THE PLANS.

11. CONTRACTOR IS REQUIRED TO HAVE A SET OF PLANS ON THE SITE AT ALL TIMES.

ANY WORK COMPLETED WITHOUT A SET PRESENT IS DONE SO AT THE CONTRACTORS RISK AND EXPENSE IF ERRORS OCCUR.

12. CONTRACTOR IS RESPONSIBLE FOR PROVIDING WATER NECESSARY FOR DUST ABATEMENT, COMPACTION, ETC.

13. THE CONTRACTOR SHALL BE RESPONSIBLE FOR SECURING SOURCES FOR GRANULAR MATERIALS, WATER, WASTE SITES, AND ANY OTHER MATERIALS SOURCES AS REQUIRED FOR PROJECT COMPLETION.

14. ANY WORK DONE WITHIN A PUBLIC RIGHT-OF-WAY SHALL BE COORDINATED WITH THE APPROPRIATE TRANSPORTATION AGENCY AND SHALL MEET THE REQUIREMENTS OF THAT AGENCY AND THE REQUIREMENTS OF ANY RIGHT-OF-WAY OR SPECIAL USE

15. THE CONTRACTOR SHALL COORDINATE ALL LIVE TAPS AND ANY OTHER WORK OR MANIPULATION OF THE EXISTING WATER SYSTEM WITH THE TAYLOR—WEST WEBER WATER IMVPROVEMENT DISTRICT, 24 HOURS IN ADVANCE OF AN PRE—CONSTRUCTION MEETING AND CONSTRUCTION ACTIVITY. 801—731—1668.

16. ON SLOPING AREAS THE CONTRACTOR SHALL TAKE PRECAUTIONS TO MITIGATE ANY POSSIBLE EROSION PROBLEMS IN THE TRENCHES DUE TO STORM WATER THAT MIGHT

OCCUR DURING OR AFTER CONSTRUCTION AS DIRECTED OR APPROVED BY ENGINEER.

17. THE CONTRACTOR SHALL INSTALL AND MAINTAIN ALL EROSION CONTROL MEASURES

AS DETAILED IN THE PROJECT PLANS UNTIL FINAL ACCEPTANCE OF THIS PROJECT.

18. THE CONTRACTOR IS REQUIRED TO TAKE ALL PRECAUTIONS NECESSARY TO INSURE

THAT NO STORM WATER/SEDIMENT AND/OR CONSTRUCTION DEBRIS ARE RELEASED FROM THE SITE. ANY RELEASES SHALL BE CLEANED AND MITIGATED AT THE CONTRACTOR'S EXPENSE.

19. CONTRACTOR SHALL COORDINATE ALL CONSTRUCTION ACCESS AND RELATED TRAFFIC CONTROL WITH THE COUNTY, CITY, AND STATE ROADWAY DEPARTMENTS. THE ENGINEER SHALL REVIEW ALL TRAFFIC CONTROL PLANS.

20. CONTRACTOR SHALL PROVIDE ALL NECESSARY FITTINGS, HARDWARE, LABOR, ETC. TO CONSTRUCT VERTICAL AND HORIZONTAL BENDS IN PIPE AS NEEDED TO MEET THE REQUIRED GRADES, ALIGNMENTS AND COVER REQUIREMENTS.

21. ALL AIR RELEASE VALVES SHALL BE INSTALLED AT THE CREST OF THE VERTICAL CURVATURE OF THE WATER LINE. CONTRACTOR SHALL RECORD ACTUAL LOCATION OF VALVES ON FIELD RECORD DRAWINGS.

22. THE CONTRACTOR SHALL COORDINATE WITH WEBER COUNTY FOR ALL UTILITY INSPECTIONS PRIOR TO BACKFILLING.23. ALL WATER SYSTEM COMPONENTS SHALL BE INSTALLED, PRESSURE TESTED, AND


CHLORINATED PRIOR TO COMPLETING ANY ROADWAY CONSTRUCTION.


24. ALL WORK ON THE SECONDARY WATER SYSTEM IS TO BE DONE IN ACCORDANCE WITH HOOPER IRRIGATION COMPANY STANDARDS.


CITY ENGINEER'S CERTIFICATE OF APPROVAL


I hereby approve the above plat having reviewed it for conformity with standard engineering practice and County's Subdivision Ordinance


Weber County Engineer

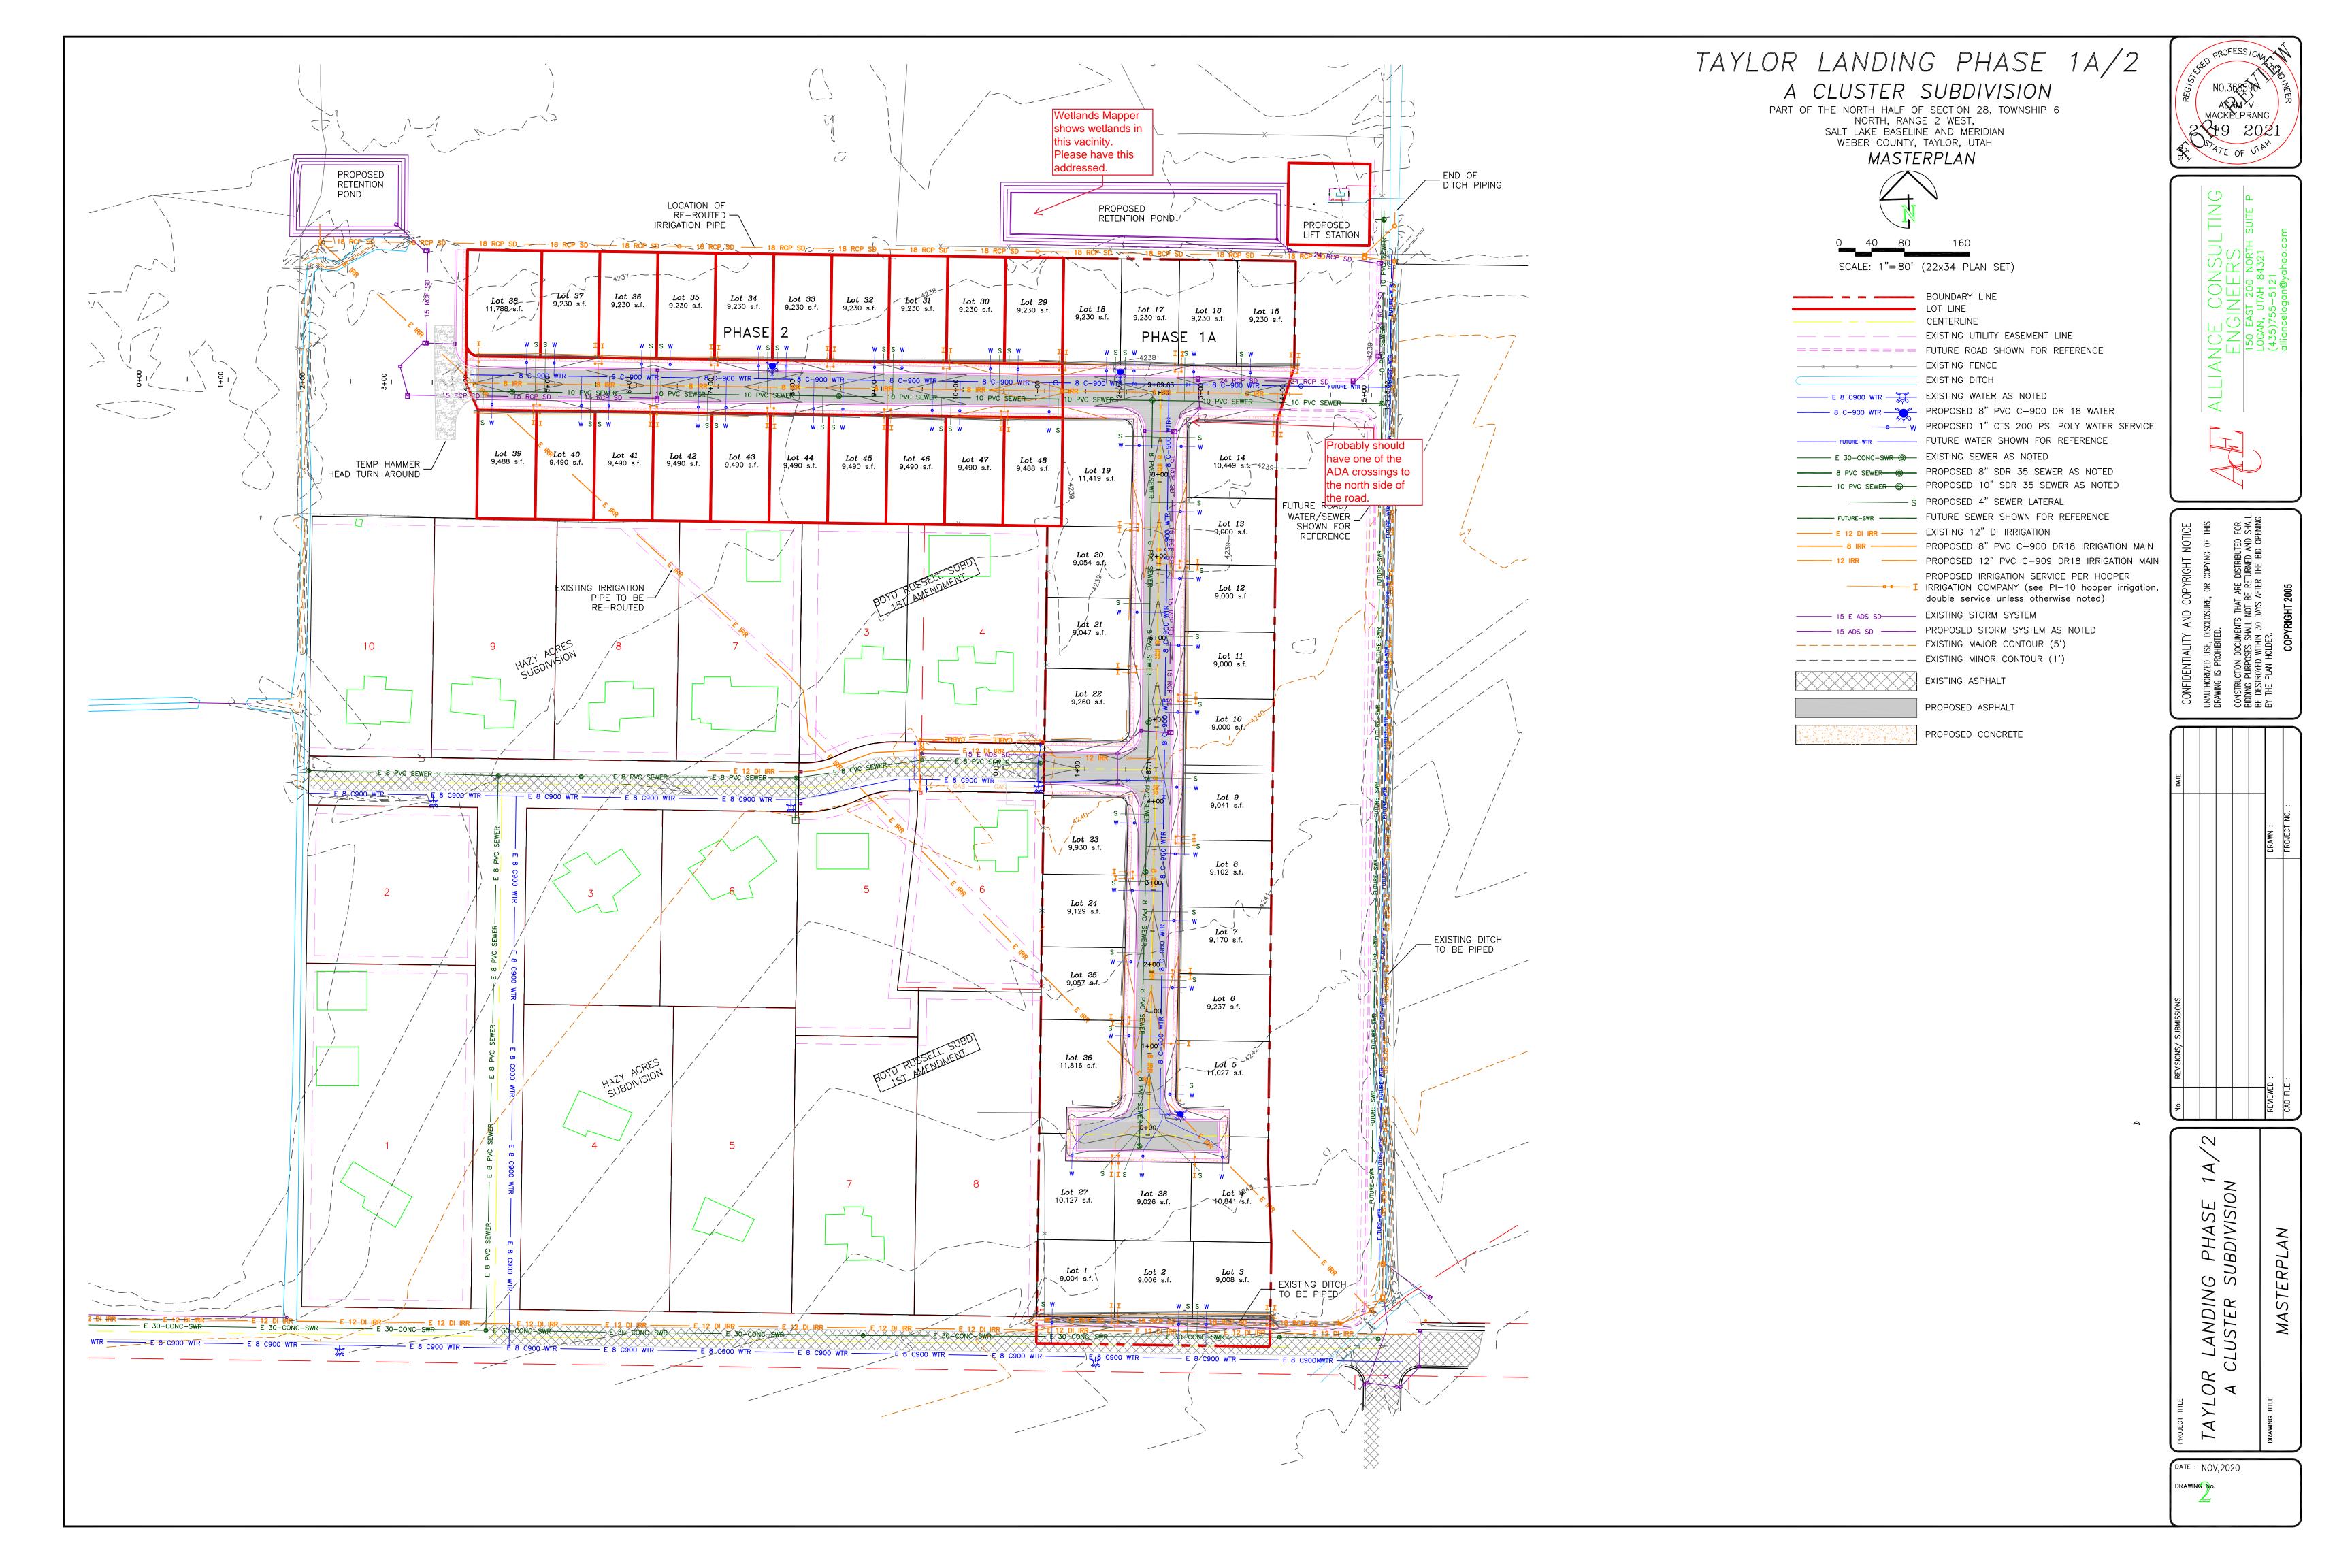

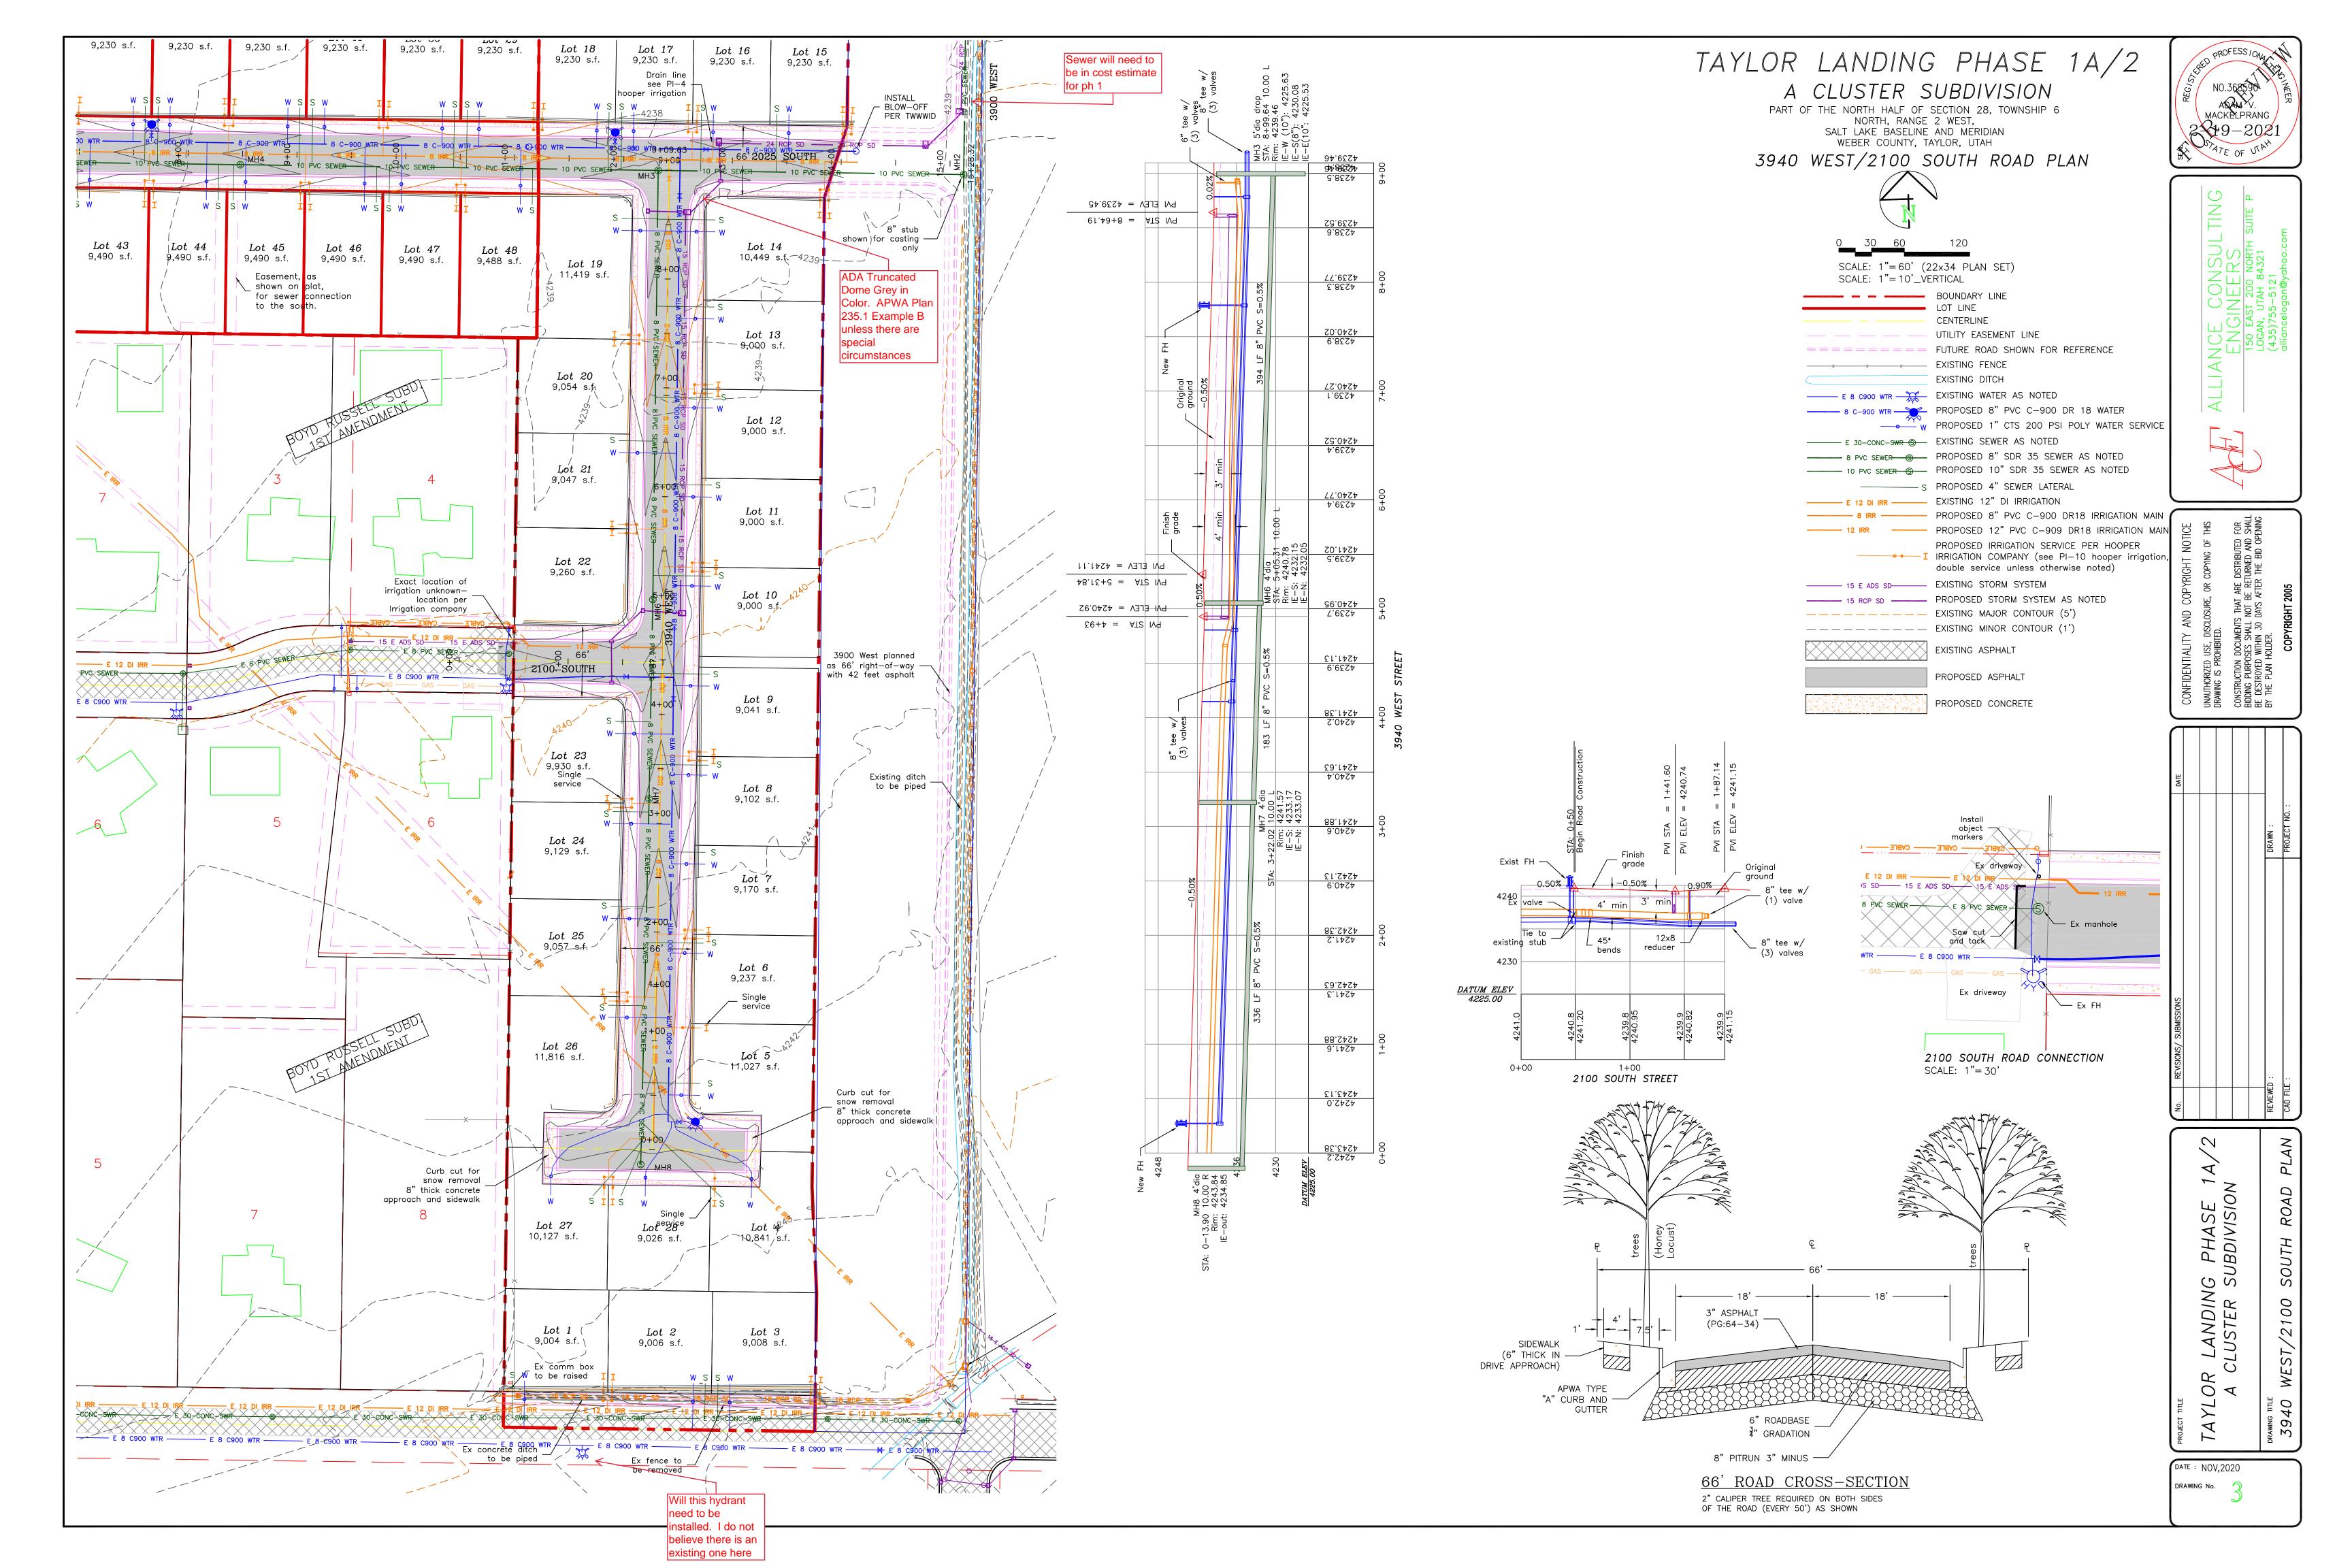

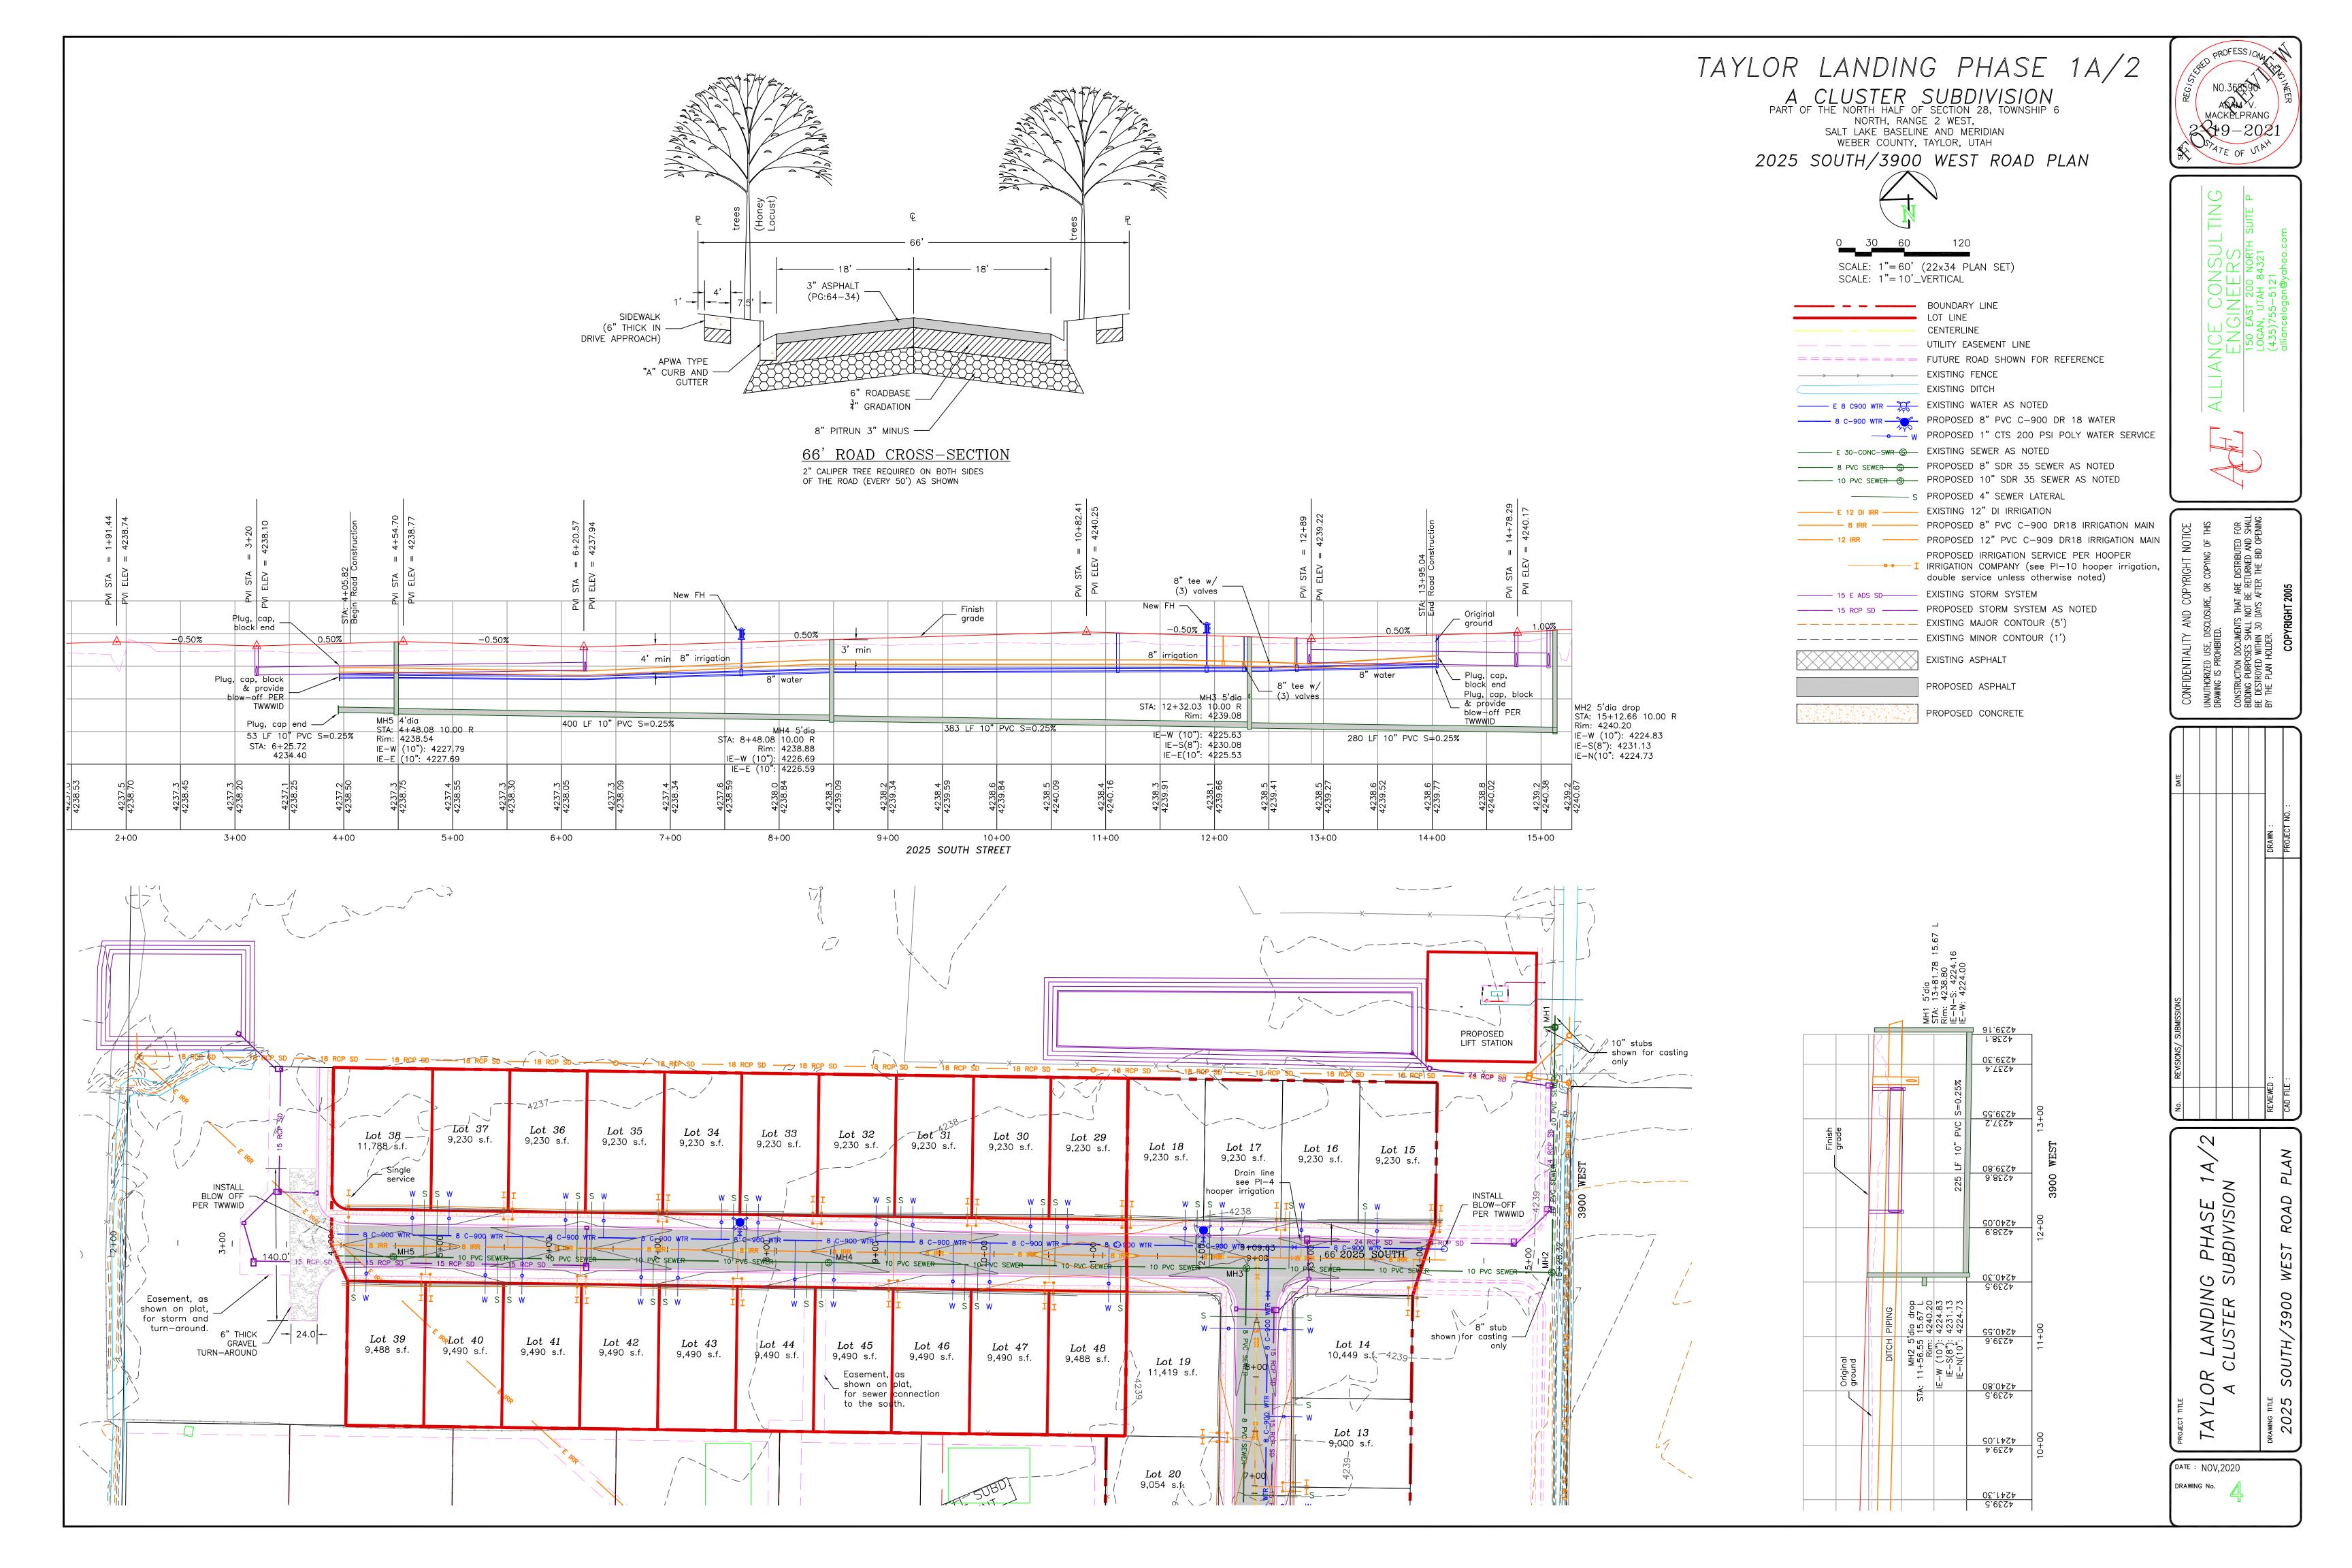

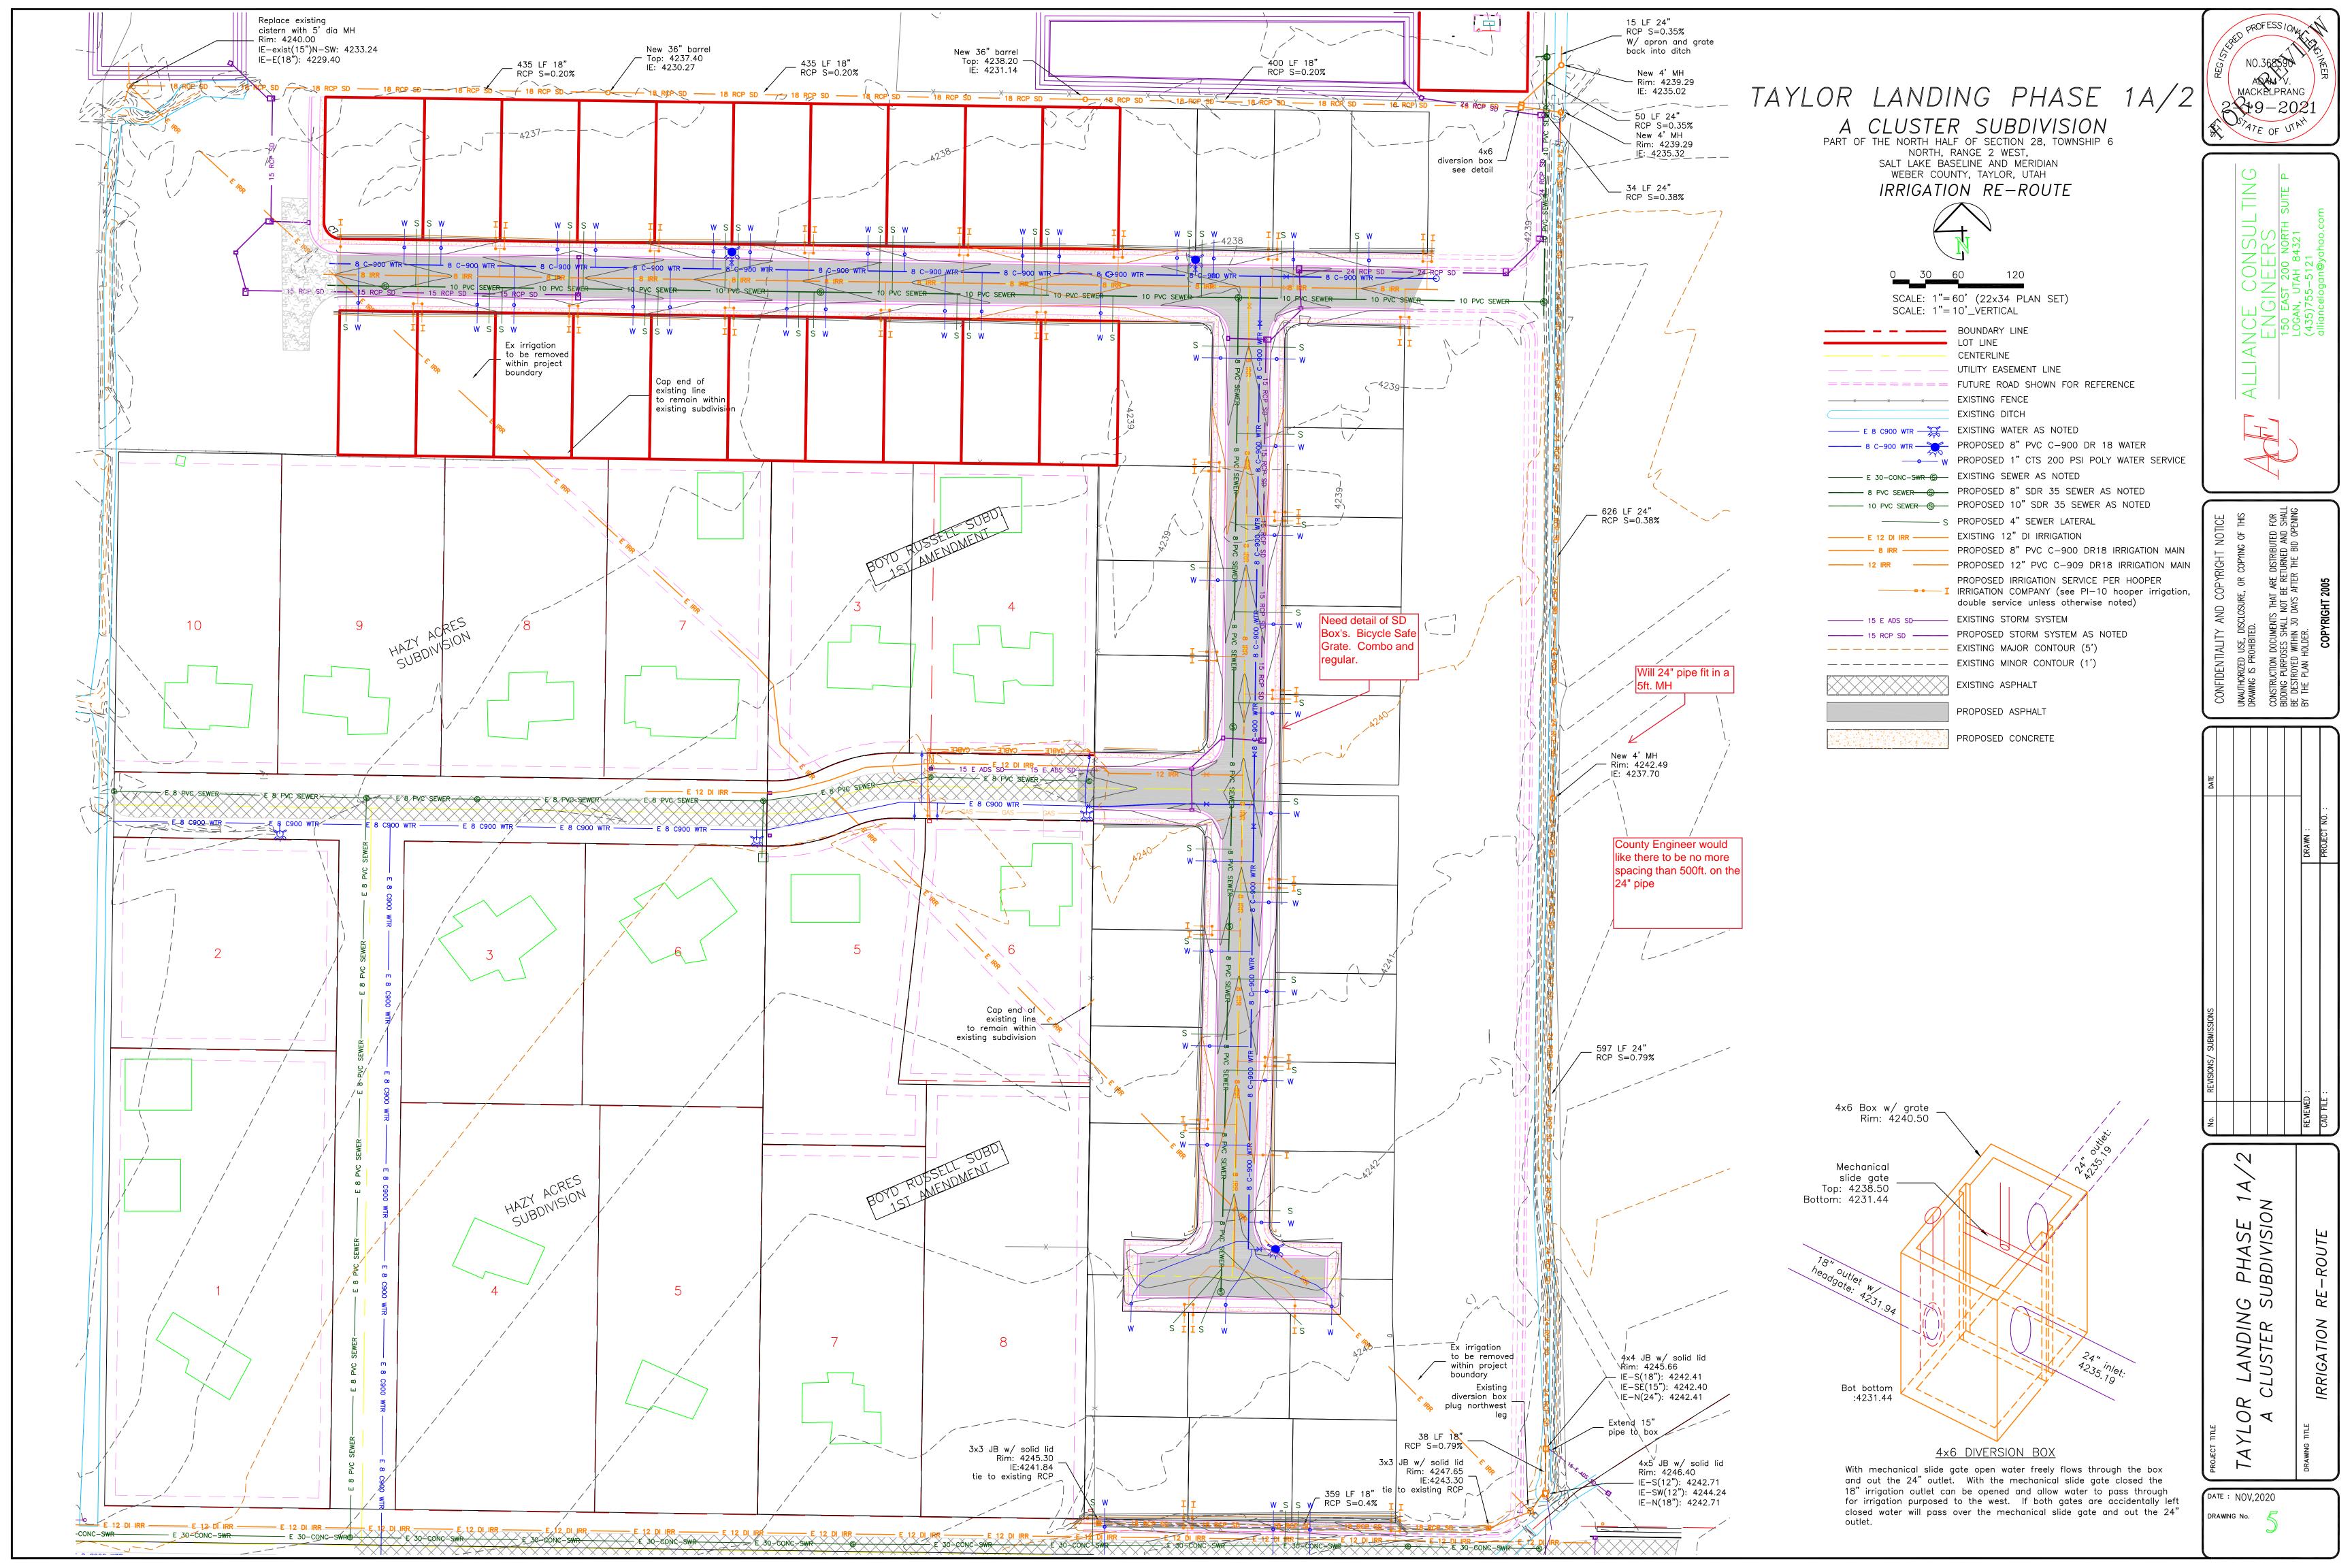

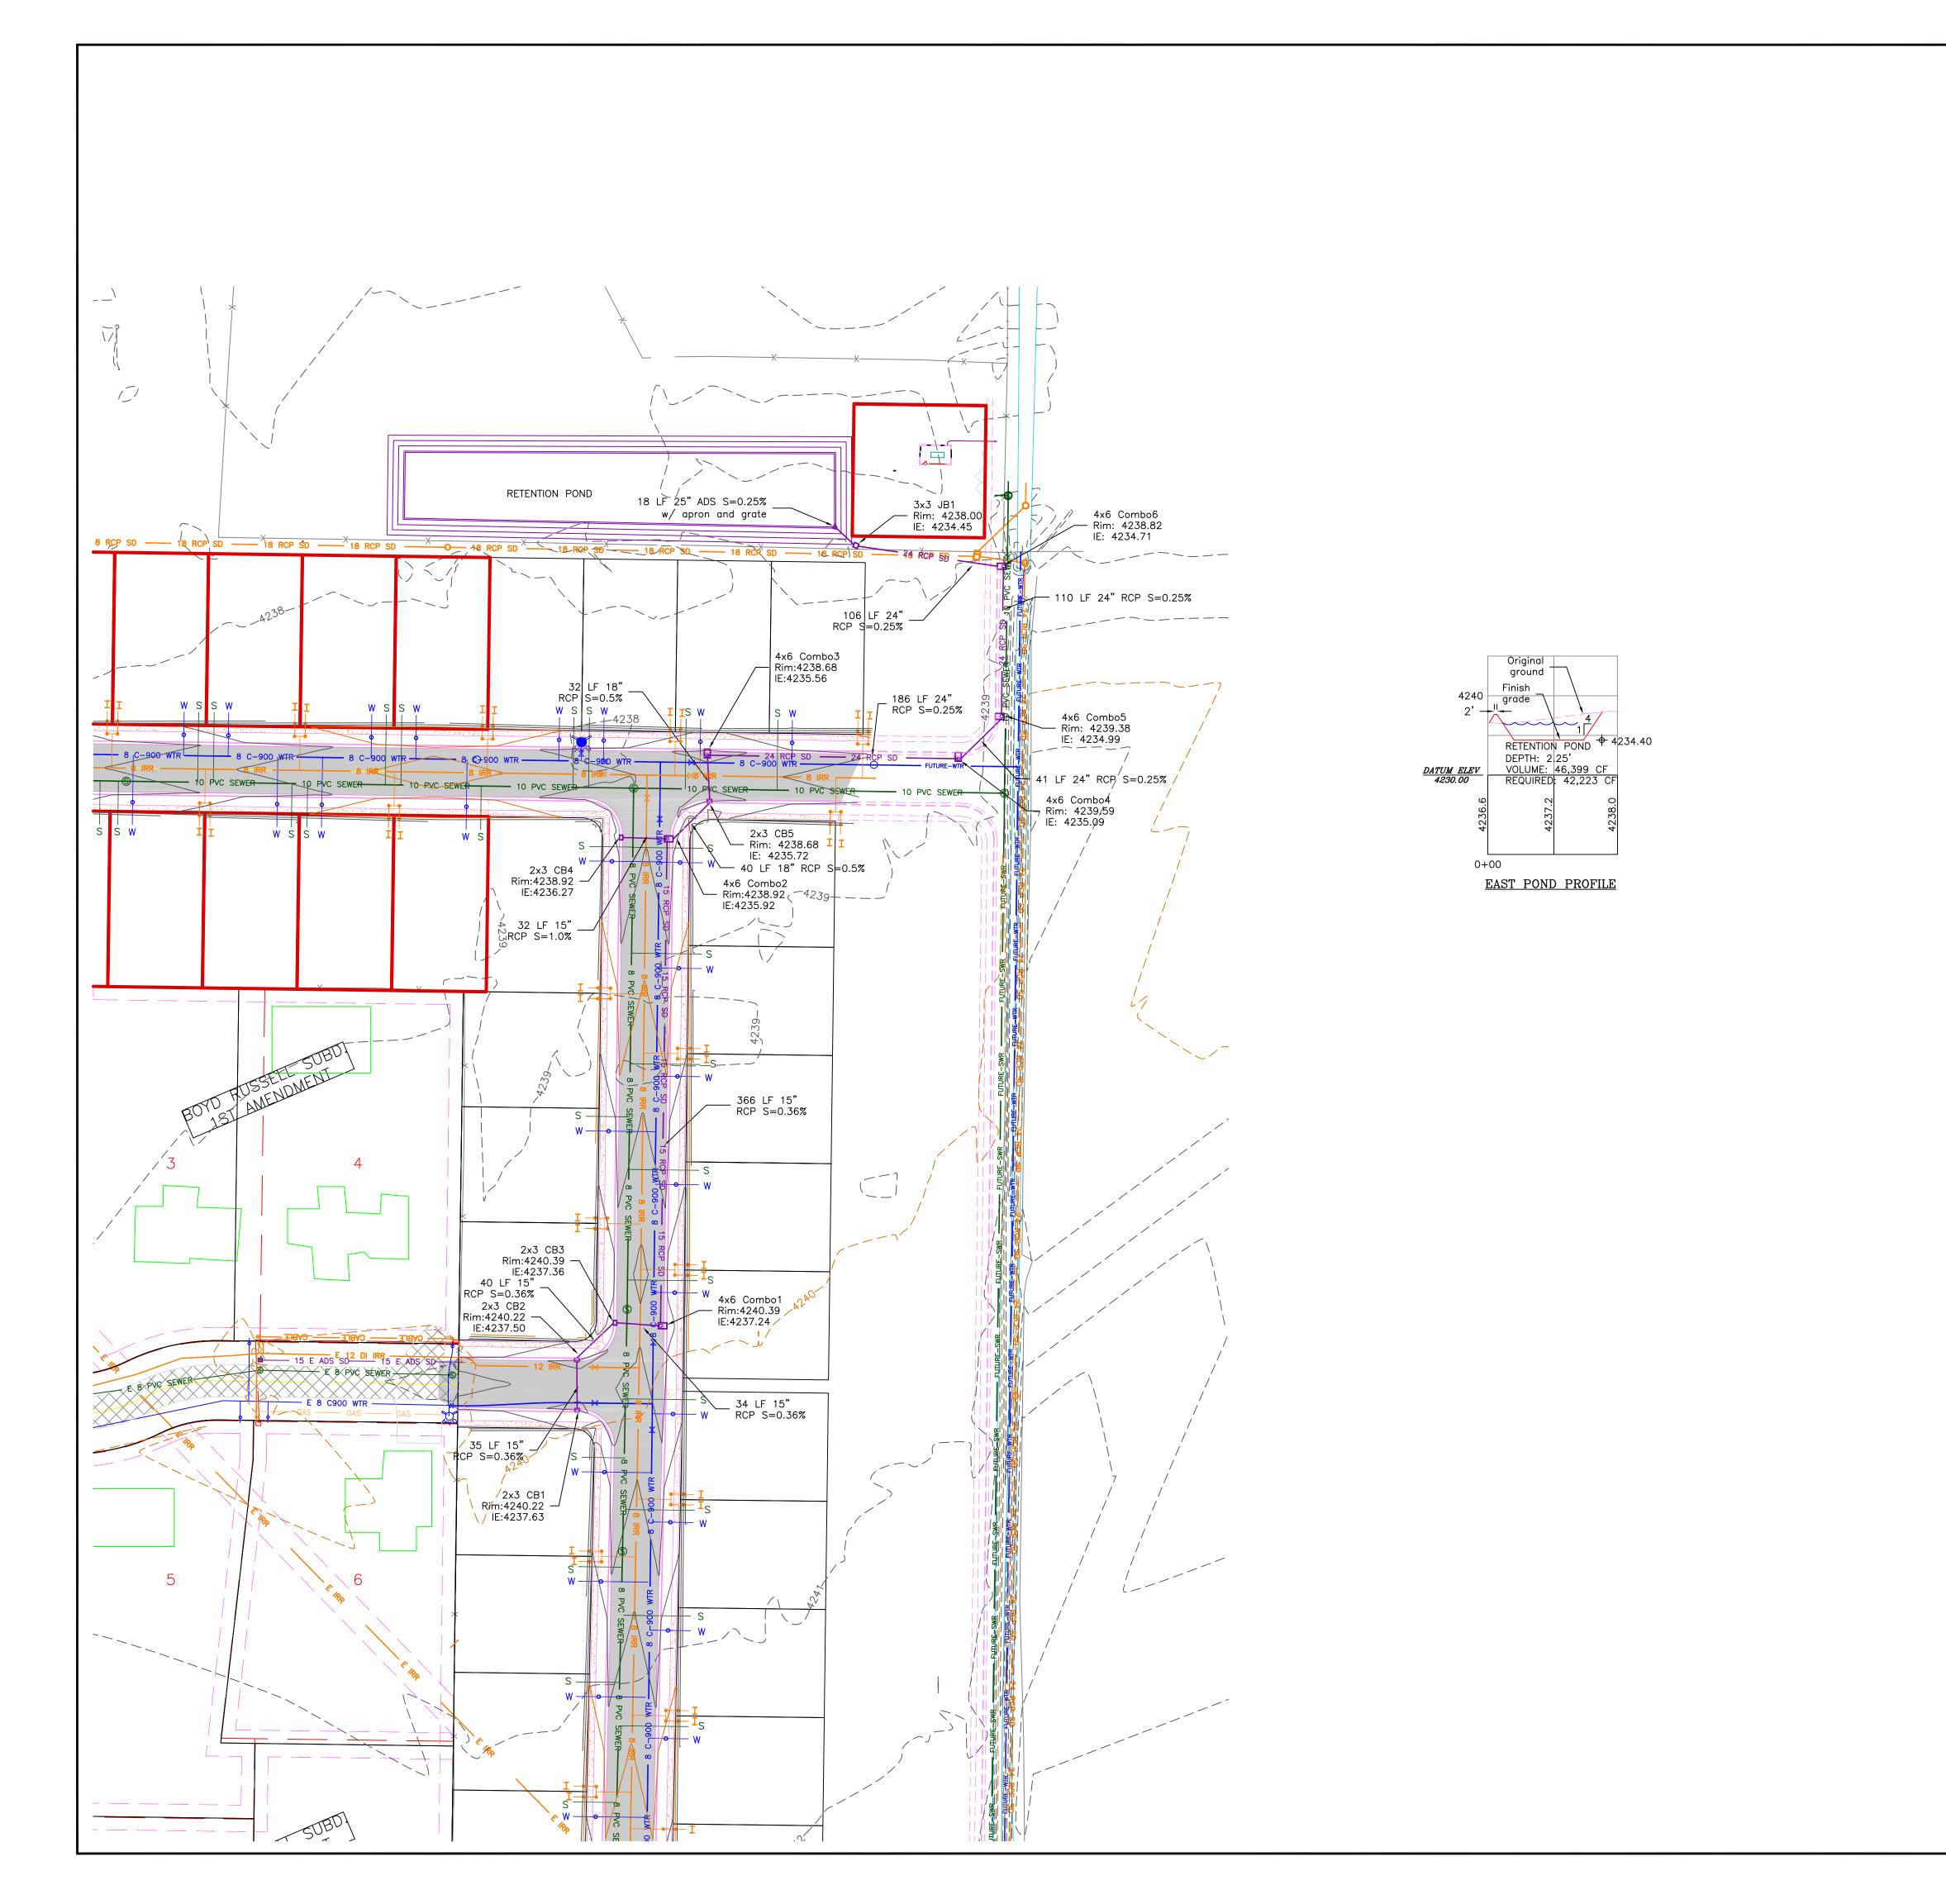


## TAYLOR LANDING PHASE 1A/2

# A CLUSTER SUBDIVISION PART OF THE NORTH HALF OF SECTION 28, TOWNSHIP 6

NORTH, RANGE 2 WEST, SALT LAKE BASELINE AND MERIDIAN WEBER COUNTY, TAYLOR, UTAH

EAST GRADING/ DRAINAGE PLAN

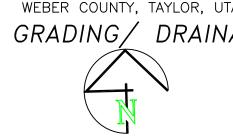

SCALE: 1"=60' (22x34 PLAN SET)

BOUNDARY LINE \_\_\_\_\_ LOT LINE CENTERLINE UTILITY EASEMENT LINE EXISTING FENCE E 8 C900 WTR EXISTING WATER AS NOTED 8 C-900 WTR — PROPOSED 8" PVC C-900 DR 18 WATER PROPOSED 1" CTS 200 PSI POLY WATER SERVICE

EXISTING SEWER AS NOTED 

EXISTING 12" DI IRRIGATION PROPOSED IRRIGATION SERVICE PER HOOPER


■■■ I IRRIGATION COMPANY (see PI-10 hooper irrigation, double service unless otherwise noted) ———— 15 E ADS SD———— EXISTING STORM SYSTEM ——— 15 RCP SD ———— PROPOSED STORM SYSTEM AS NOTED


— — — — — — EXISTING MAJOR CONTOUR (5') ——————— EXISTING MINOR CONTOUR (1') EXISTING ASPHALT


> PROPOSED ASPHALT PROPOSED CONCRETE






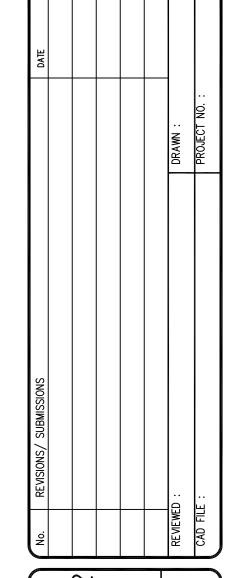

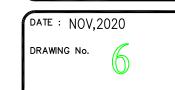

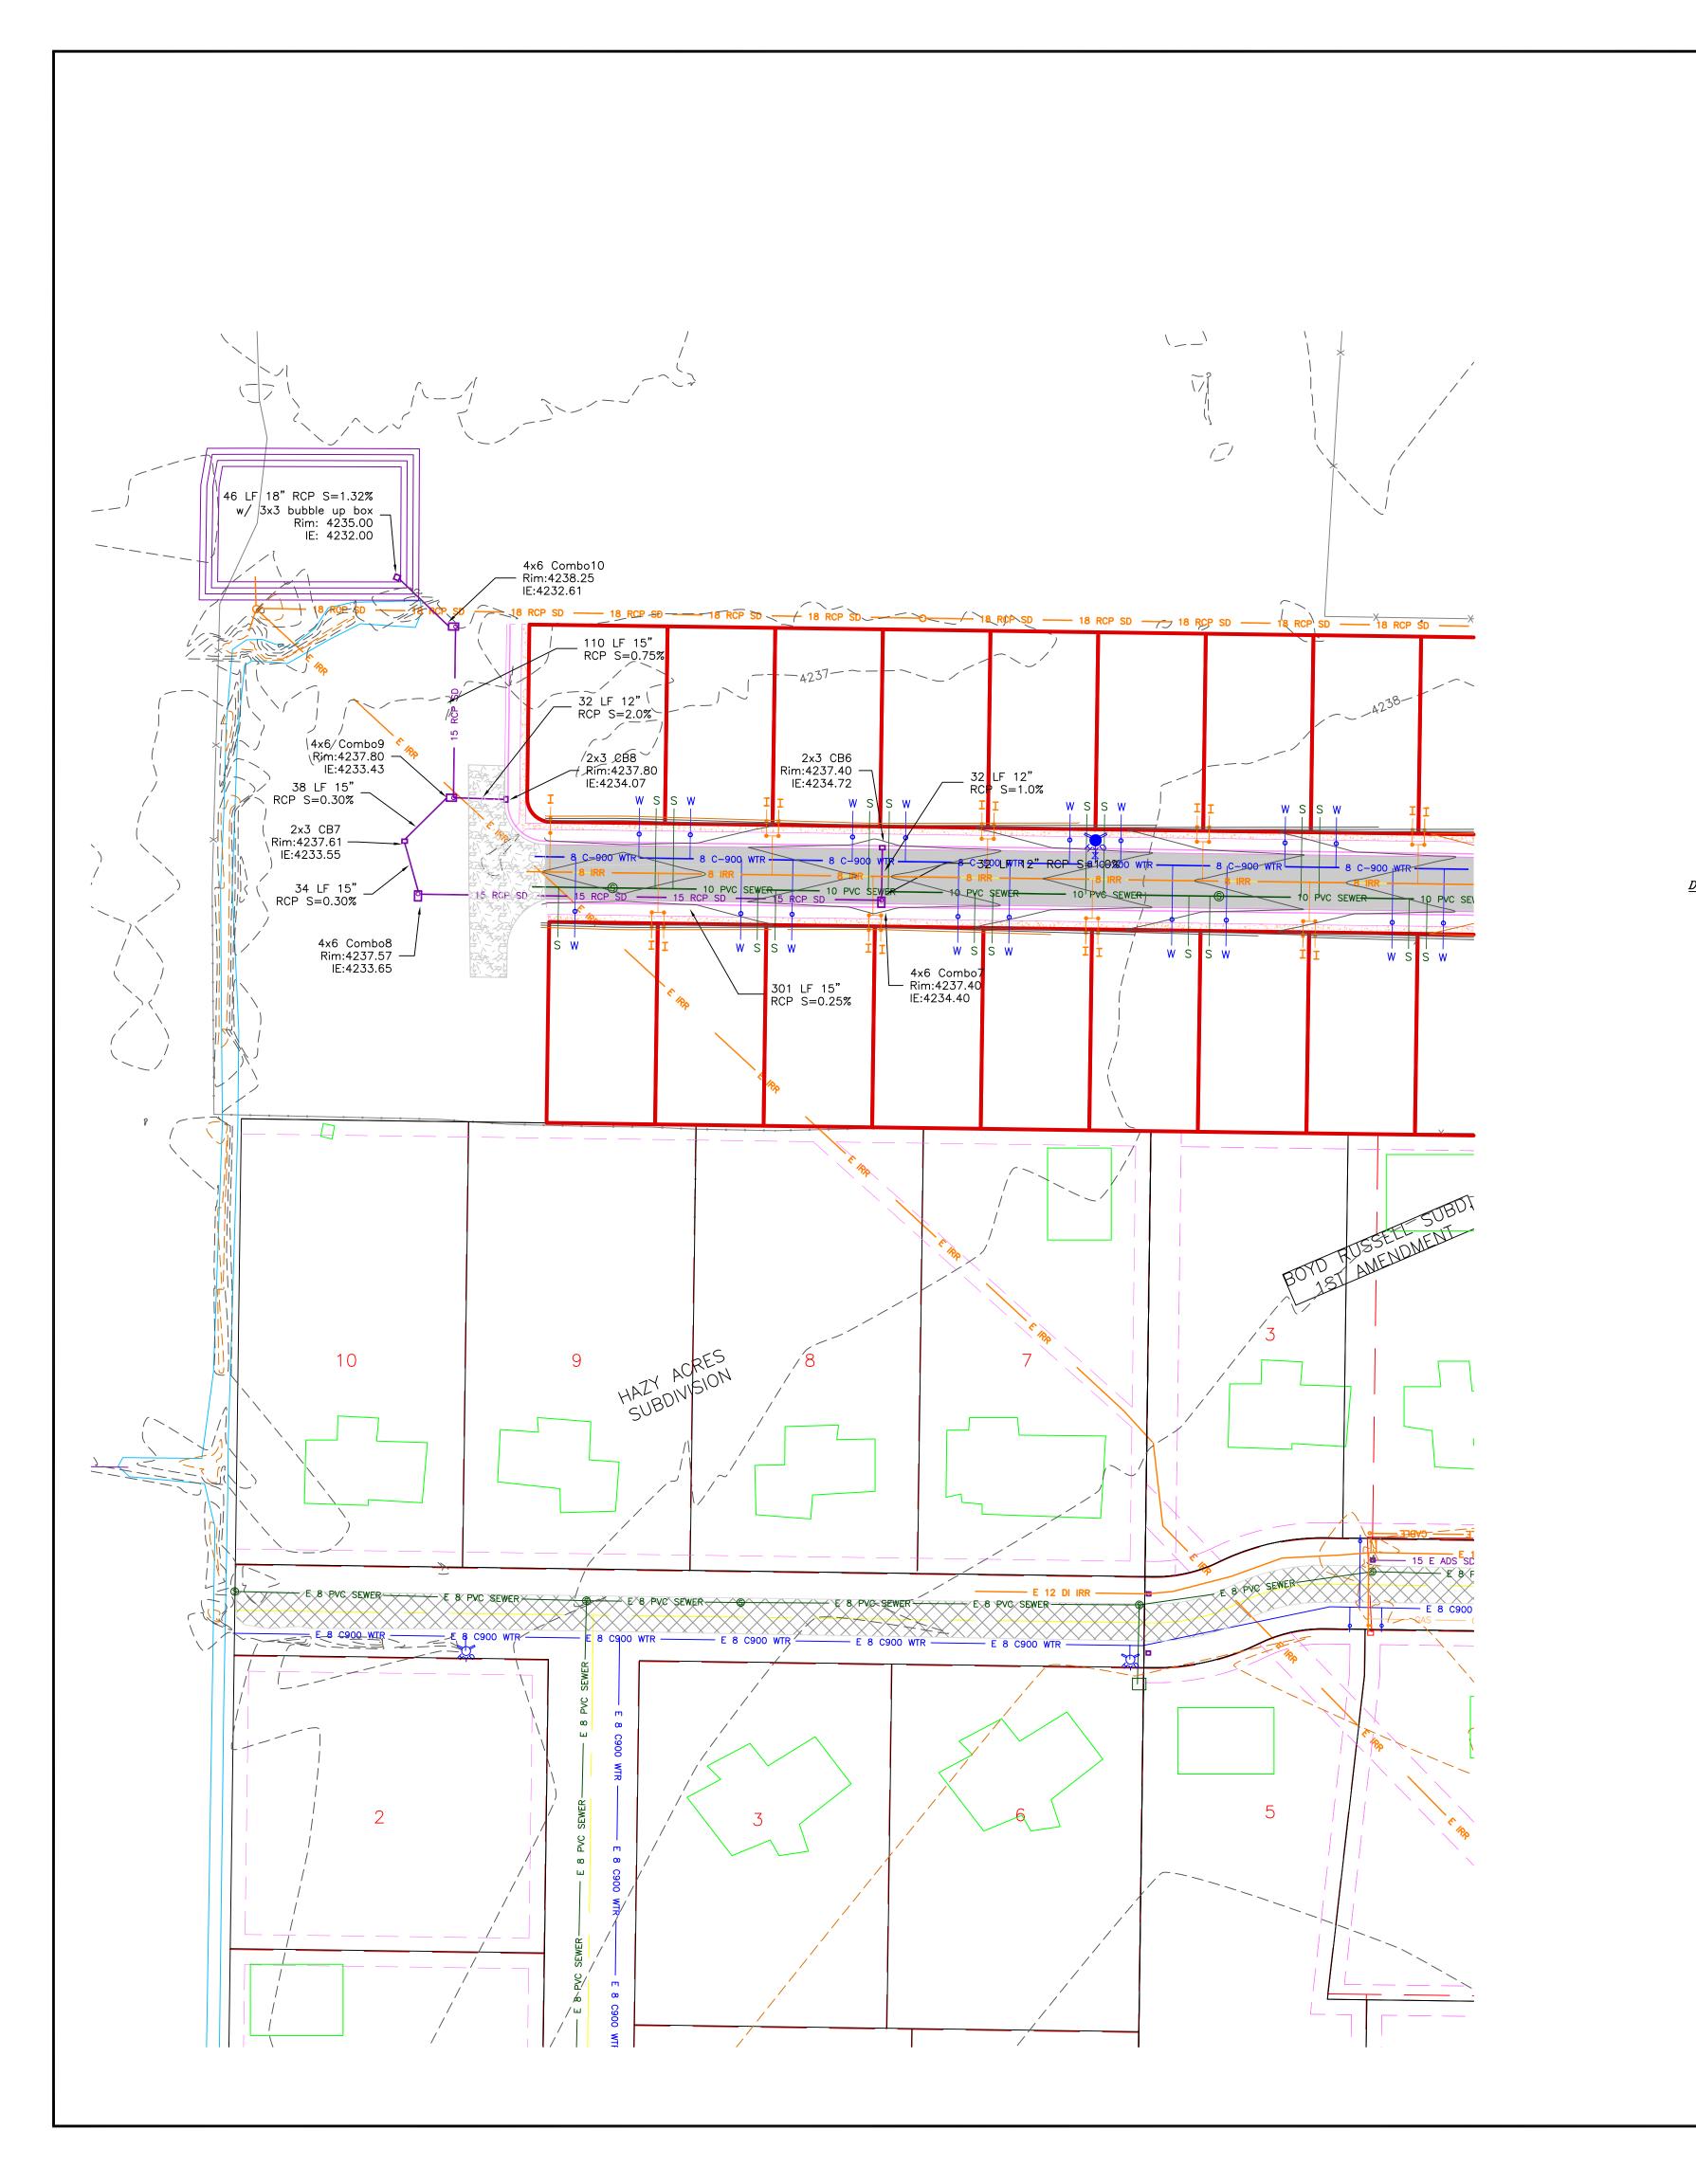

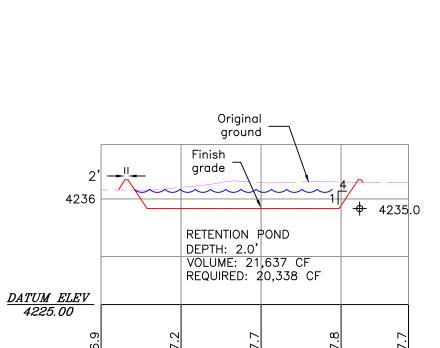

1+00

WEST POND PROFILE

## TAYLOR LANDING PHASE 1A/2

# A CLUSTER SUBDIVISION PART OF THE NORTH HALF OF SECTION 28, TOWNSHIP 6

NORTH, RANGE 2 WEST,
SALT LAKE BASELINE AND MERIDIAN
WEBER COUNTY, TAYLOR, UTAH

WEST GRADING DRAINAGE PLAN



0 30 60 120 SCALE: 1"=60' (22x34 PLAN SET)

BOUNDARY LINE
LOT LINE
CENTERLINE
UTILITY EASEMENT LINE
EXISTING FENCE
EXISTING WATER AS NOTED
PROPOSED 8" PVC C-900 DR 18 WATER
PROPOSED 1" CTS 200 PSI POLY WATER SERVICE
EXISTING SEWER AS NOTED

PROPOSED 8" PVC C-900 DR18 IRRIGATION MAIN

12 IRR

PROPOSED 12" PVC C-909 DR18 IRRIGATION MAIN

PROPOSED IRRIGATION SERVICE PER HOOPER

IRRIGATION COMPANY (see PI-10 hooper irrigation, double service unless otherwise noted)

EXISTING ASPHALT

PROPOSED ASPHALT


CONTOUR (5')

CONTOUR (1')


ALT

HALT

PROPOSED CONCRETE

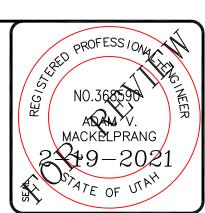




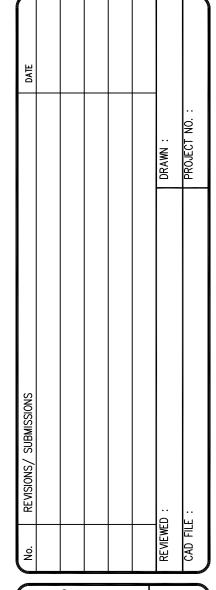



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A CLUSTER SUBDIVISION


WEST GRADING/ DRAINAGE PLAN


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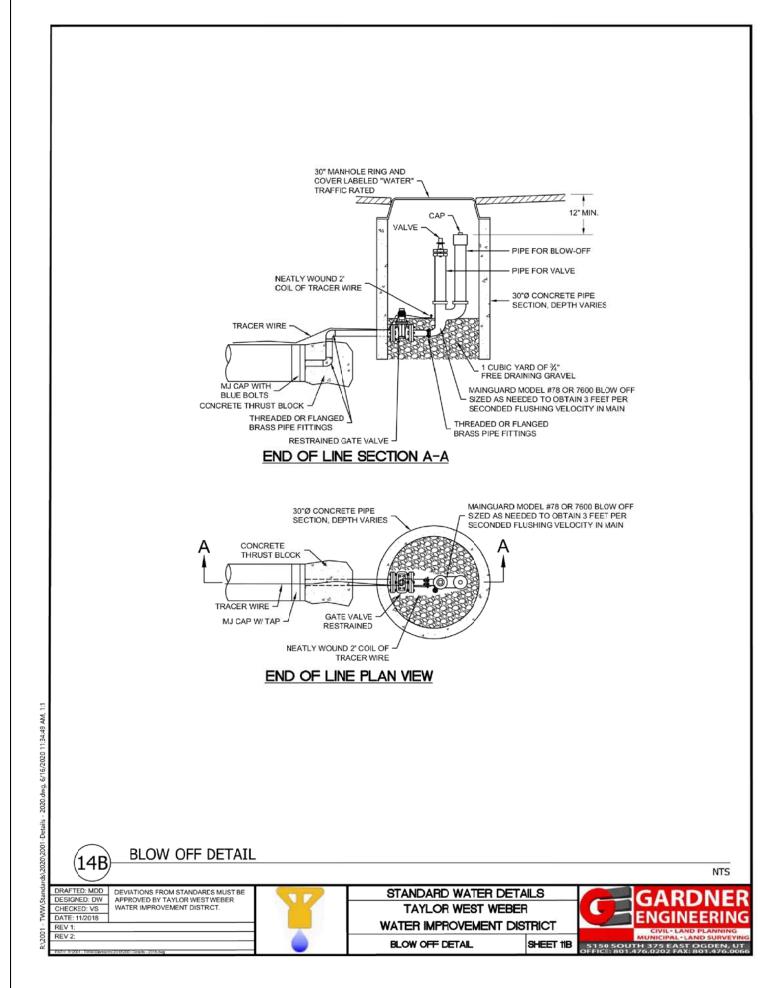


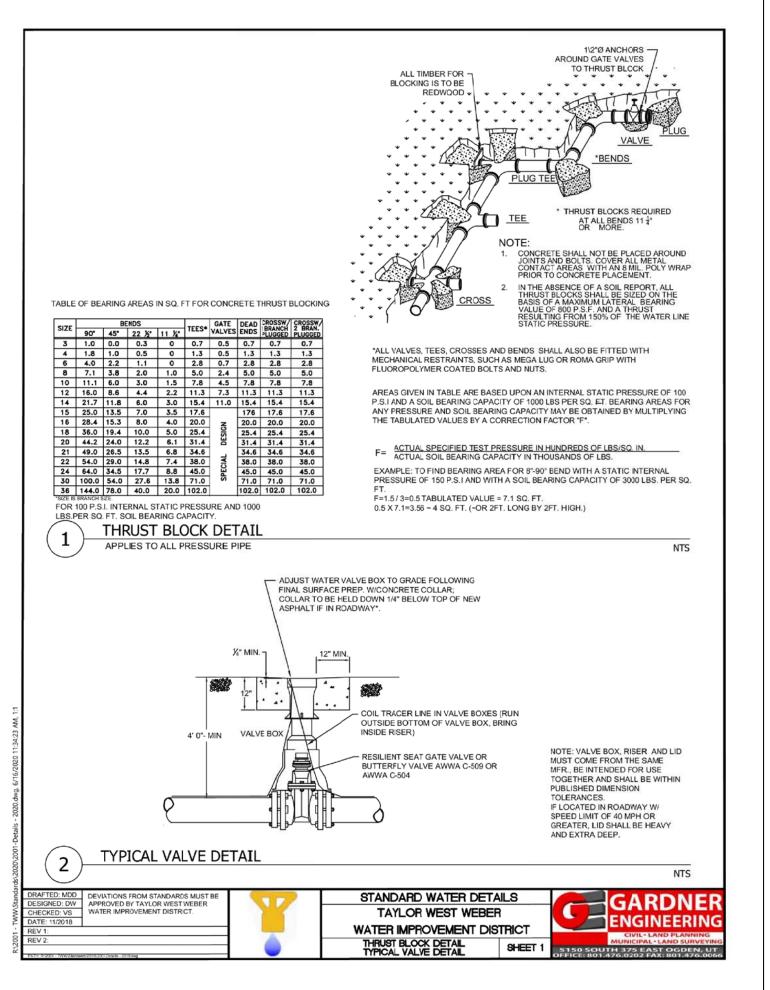


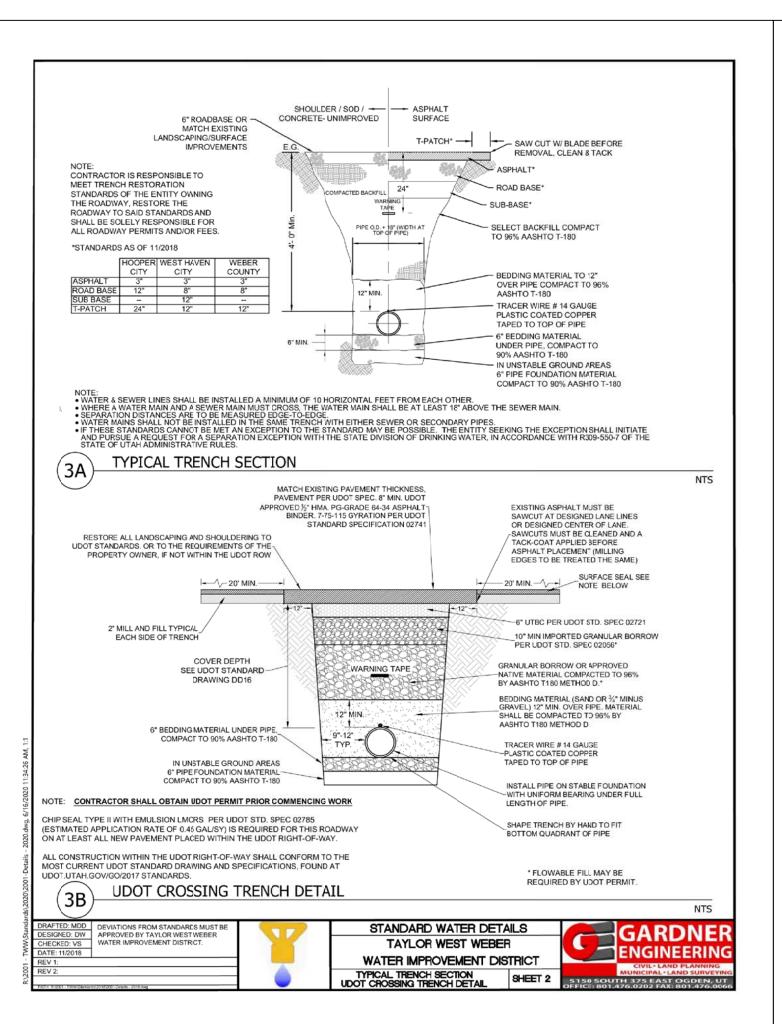


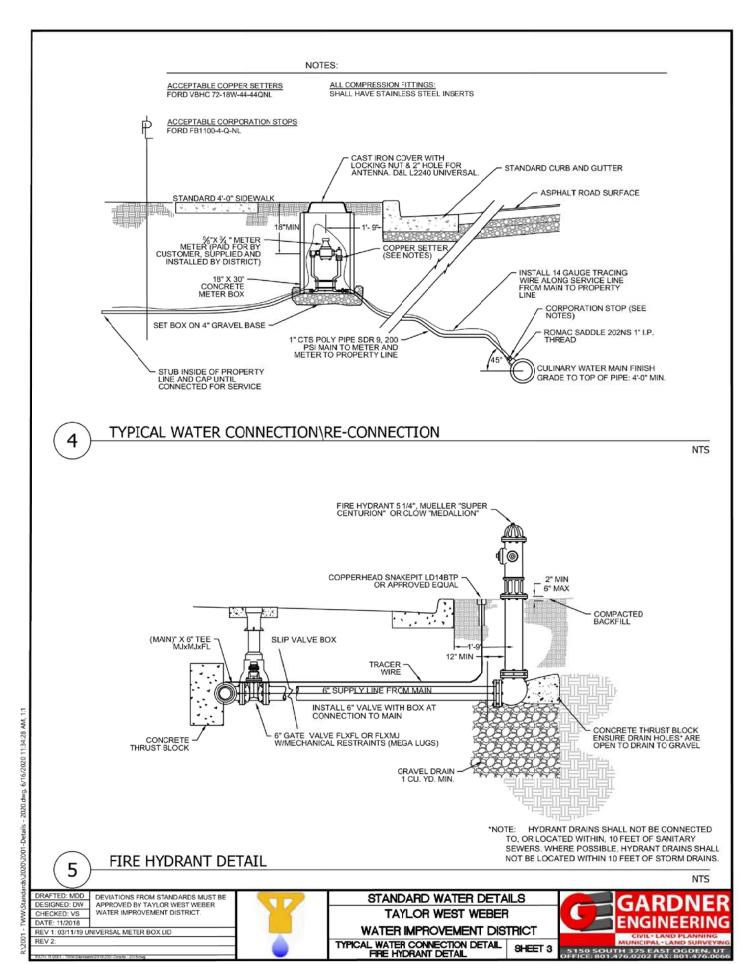


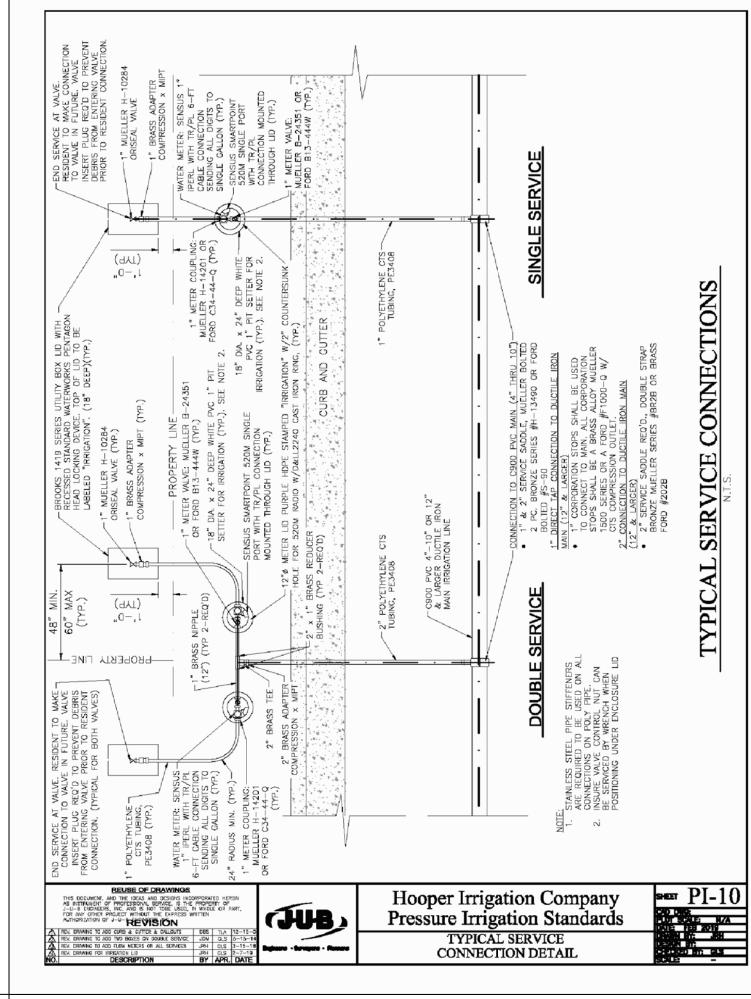

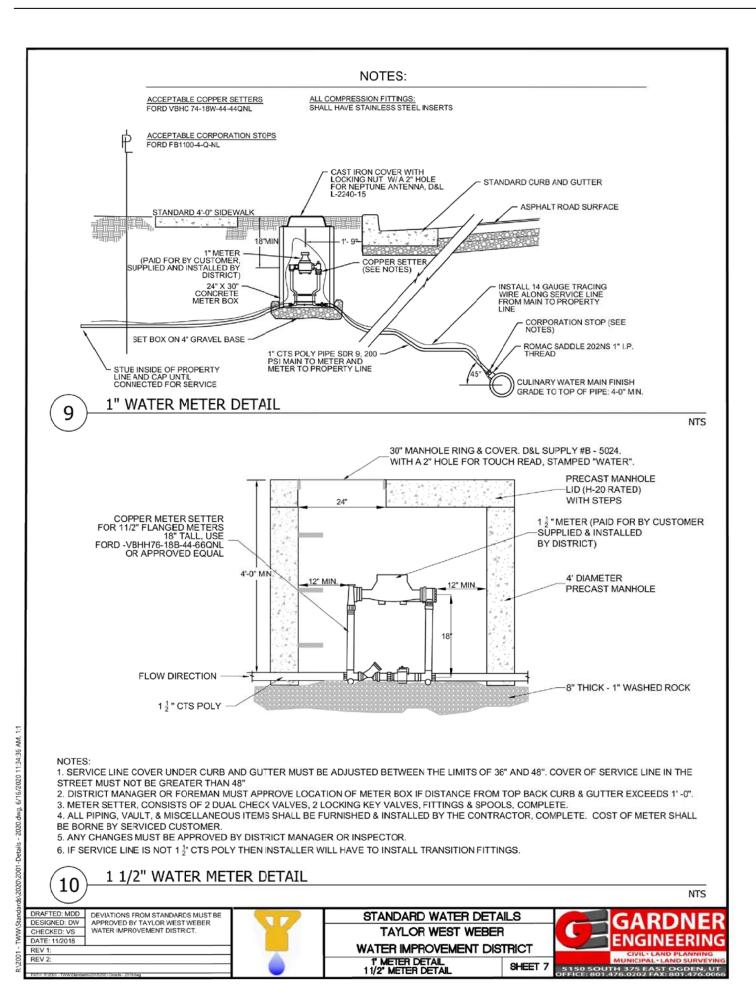

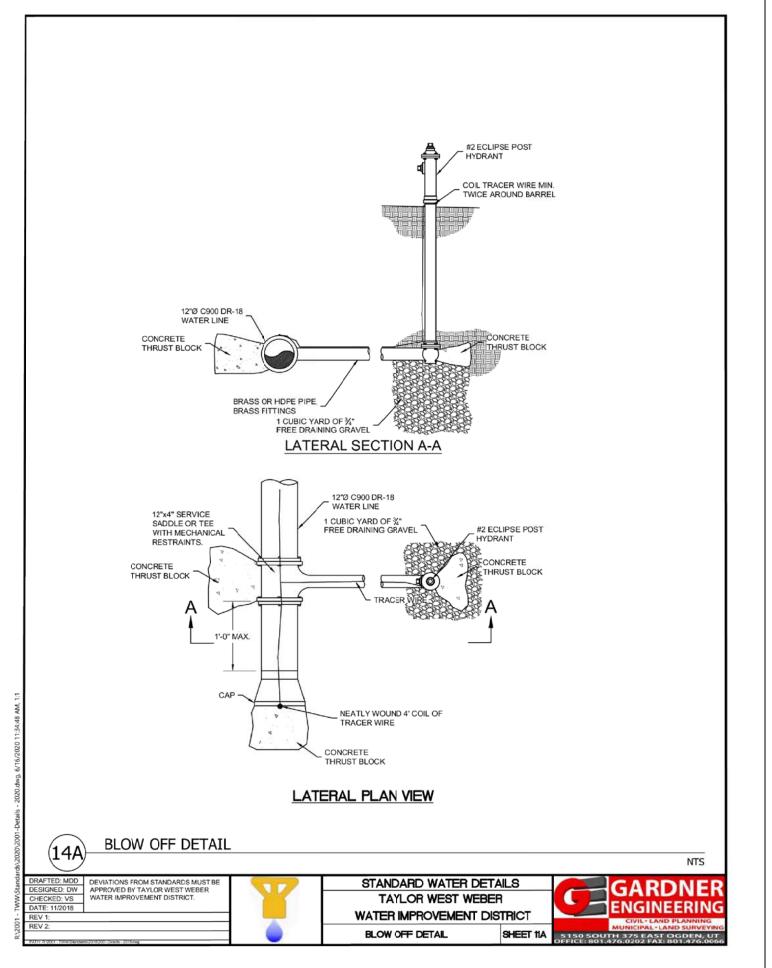

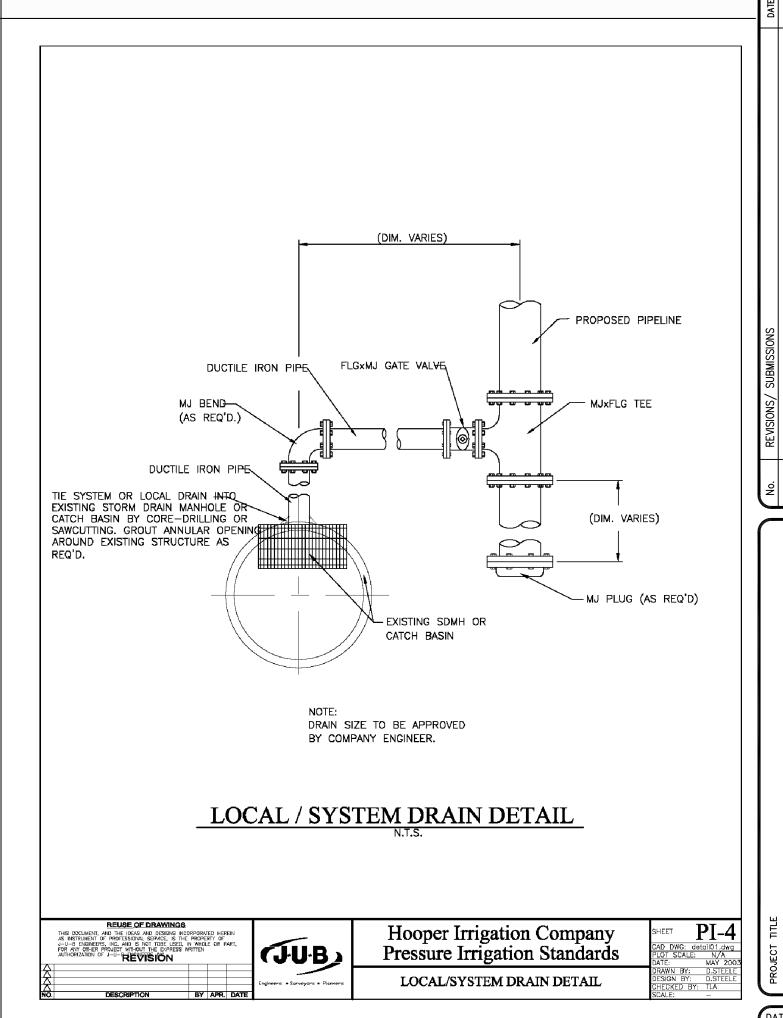

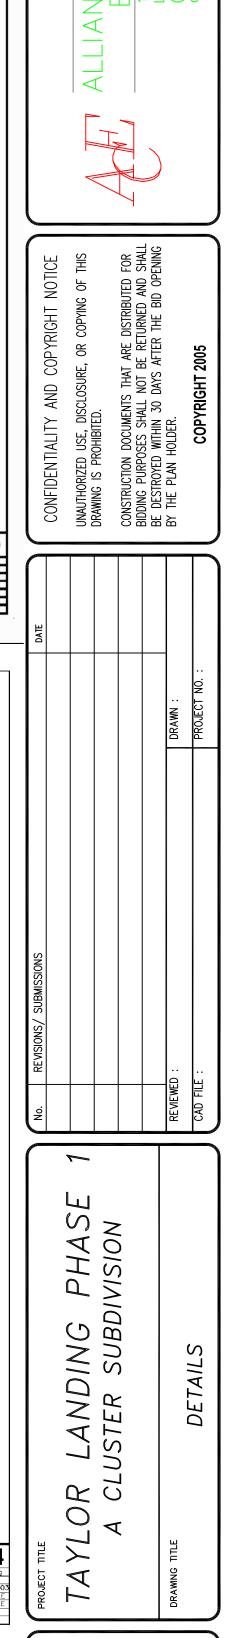

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