OGDEN CITY WHEELER CREEK DIVERSION CONSTRUCTION PLANS

STATE OF UTAH PROJECT LOCATION

OGDEN CANYON, SR39 & PINEVIEW RESERVOIR


ISSUE DATE: AUGUST 2, 2018


LEGEND

MAJOR HIGHWAYCOUNTY LINE

NOT TO SCALE

VICINITY MAP

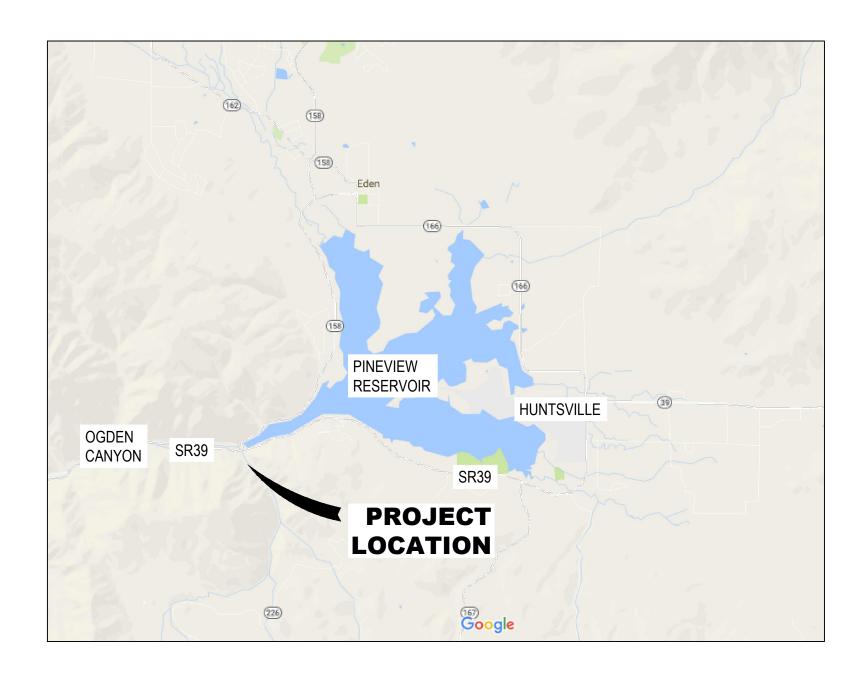

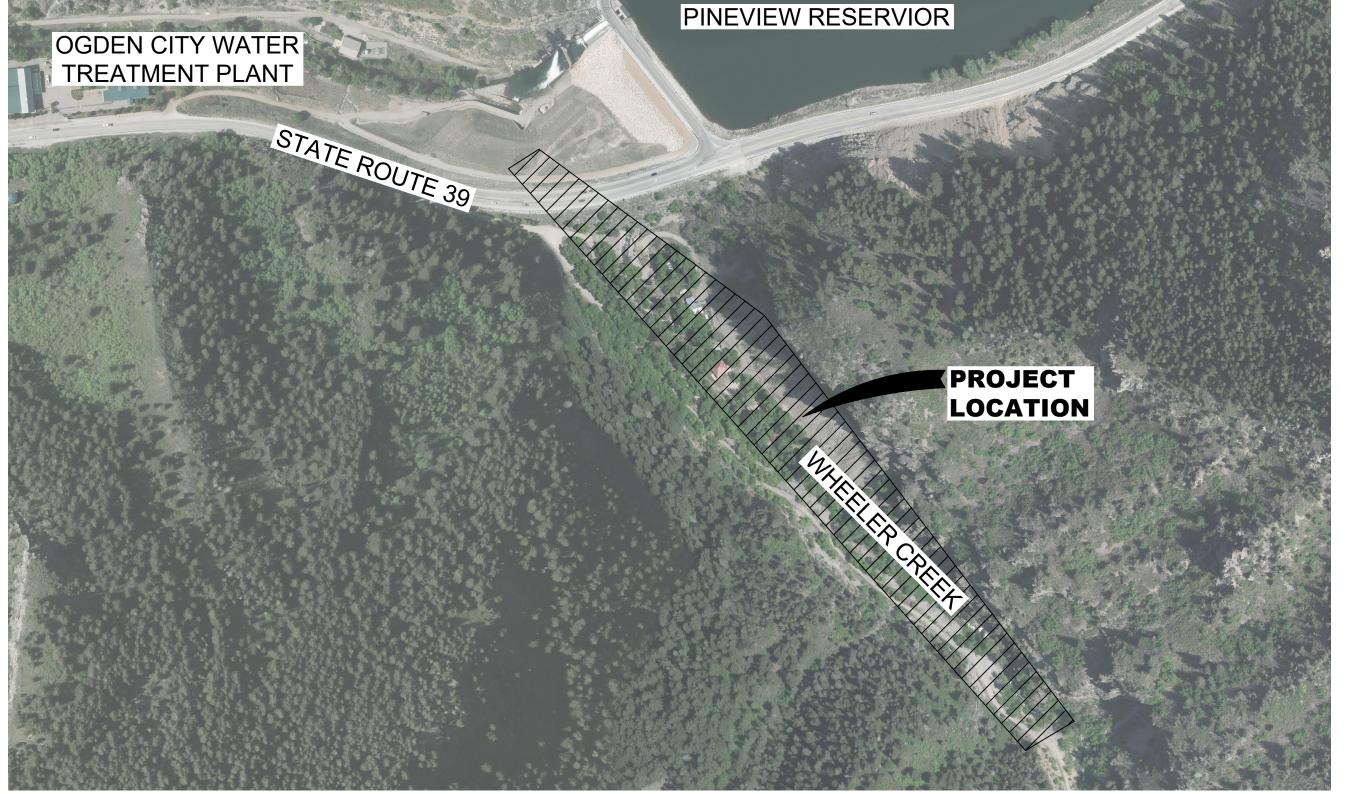

WHEELER CREEK
DIVERSION
PROJECT VICINITY MAP

CIVIL SHEET INDEX

SHEET	SHEET NUMBER	SHEET TITLE
1	G101	TITLE SHEET
2	G102	NOTES, LEGEND, AND ABBREVIATIONS
3	CS101	EXISTING CONDITIONS & DEMOLITION
4	CU101	UTILITY DESIGN
5	CG101	ACCESS ROAD GRADING
6	CG102	DIVERSION BUILDING SITE PLAN
7	CG201	GRADING SECTION VIEWS
8	CG501	RETAINING WALL SECTIONS
9	CG502	RETAINING WALL DETAILS
10	CG503	DIVERSION STRUCTURE DETAILS
11	LS101	LANDSCAPING

STRUCTURAL SHEET INDEX

SHEET	SHEET NUMBER	SHEET TITLE
12	A101	FLOOR PLAN
13	A201	ARCHITECTURAL ELEVATIONS
14	A202	BUILDING ELEVATIONS
15	A301	ARCHITECTURAL SECTIONS
16	S101	FOOTING PLAN
17	S102	FOUNDATION PLAN
18	S103	BRACED WALL PLAN
19	S104	ROOF FRAMING PLAN
20	S501	STRUCTURAL DETAILS
21	S502	STRUCTURAL DETAILS


APPROVED


FOR CONSTRUCTION

CRS ENGINEERS
Answers to Infrastructure®

4246 S Riverboat Rd, Ste 200 | Salt Lake City, UT 84123 | P: 801.359.5565 | www.crsengineers.com

OGDEN CITY
WHEELER CREEK DIVERSION
TITLE SHEET

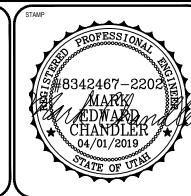

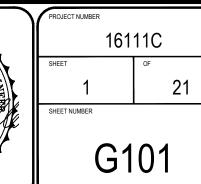

SR39 & PINEVIEW RESERVOIR

THE CONTRACTOR SHALL CAREFULLY READ ALL OF THE NOTES AND SPECIFICATIONS. THE CONTRACTOR SHALL BE SATISFIED AS TO THEIR TRUE MEANING AND INTENT AND SHALL BE RESPONSIBLE FOR COMPLYING WITH

- ALL IMPROVEMENTS SHALL BE CONSTRUCTED IN STRICT ACCORDANCE WITH ALL JURISDICTIONAL AUTHORITIES.
- CONTRACTOR SHALL COMPLY WITH THE STANDARDS INDICATED ABOVE AND WITHIN THE CONSTRUCTION DOCUMENTS. THE CONTRACTOR SHALL NOTIFY ALL AGENCIES, OWNERS, ENGINEERS, AND UTILITY COMPANIES 5 DAYS PRIOR TO A PRE-CONSTRUCTION MEETING:

OWNER:

CITY ENGINEER 2549 WASHINGTON BLVD. **OGDEN, UT 84078** PHONE: (801) 629-8971 CONTACT: JUSTIN ANDERSON, P.E.

OGDEN CITY

ENGINEER

CRS ENGINEERS 4246 S RIVERBOAT RD, STE 200 SALT LAKE CITY, UTAH 84123 PHONE: (801) 359-5565 FAX: (801) 359-4272 CONTACT: M. CHANDLER. PE

- 3) IT IS INTENDED THAT THESE PLANS AND SPECIFICATIONS REQUIRE ALL LABOR AND MATERIALS NECESSARY AND PROPER FOR THE WORK CONTEMPLATED AND THAT THE WORK BE COMPLETED IN ACCORDANCE WITH THEIR TRUE INTENT AND PURPOSE. THE CONTRACTOR SHALL NOTIFY THE ENGINEER IMMEDIATELY REGARDING ANY DISCREPANCIES OR AMBIGUITIES WHICH MAY EXIST IN THE PLANS OR SPECIFICATIONS. THE ENGINEER'S INTERPRETATION THEREOF SHALL BE CONCLUSIVE.
- WHERE THE PLANS OR SPECIFICATIONS DESCRIBE PORTIONS OF THE WORK IN GENERAL TERMS BUT NOT IN COMPLETE DETAIL, IT IS UNDERSTOOD THAT ONLY THE BEST GENERAL PRACTICE IS TO PREVAIL AND THAT ONLY MATERIALS AND WORKMANSHIP OF THE FIRST QUALITY ARE TO BE USED.
- THE CONTRACTOR SHALL BE SKILLED AND REGULARLY ENGAGED IN THE GENERAL CLASS AND TYPE OF WORK CALLED FOR IN THE PROJECT PLANS AND SPECIFICATIONS. THEREFORE, THE OWNER IS RELYING UPON THE EXPERIENCE AND EXPERTISE OF THE CONTRACTOR, IT SHALL BE EXPECTED THAT PRICES PROVIDED WITHIN THE CONTRACT DOCUMENTS SHALL INCLUDE ALL LABOR AND MATERIALS NECESSARY AND PROPER FOR THE WORK CONTEMPLATED AND THAT THE WORK BE COMPLETED IN ACCORDANCE WITH THEIR TRUE INTENT AND PURPOSE.
- THE CONTRACTOR SHALL BE COMPETENT. KNOWLEDGEABLE. AND HAVE SPECIAL SKILLS ON THE NATURE, EXTENT, AND INHERENT CONDITIONS OF THE WORK TO BE PERFORMED. CONTRACTOR SHALL ALSO ACKNOWLEDGE THAT THERE ARE CERTAIN PECULIAR AND INHERENT CONDITIONS EXISTENT IN CONSTRUCTION OF PARTICULAR FACILITIES, WHICH MAY CREATE, DURING THE CONSTRUCTION PROGRAM, UNUSUAL OR PECULIAR SAFETY CONDITIONS, WHICH CONDITIONS COULD BE HAZARDOUS TO PERSONS, PROPERTY AND THE ENVIRONMENT. CONTRACTOR SHALL BE AWARE OF SUCH PECULIAR RISKS AND HAVE THE SKILL AND EXPERIENCE TO FORESEE AND TO ADOPT PROTECTIVE MEASURES TO ADEQUATELY AND SAFELY PERFORM THE CONSTRUCTION WORK WITH RESPECT TO SUCH HAZARDS.
- THE CONTRACTOR SHALL BE RESPONSIBLE FOR ALL PERMITS AND LICENSES REQUIRED FOR THE CONSTRUCTION AND COMPLETION OF THE PROJECT, AND SHALL PERFORM ALL WORK IN ACCORDANCE WITH THE REQUIREMENTS AND CONDITIONS OF ALL PERMITS AND APPROVALS APPLICABLE TO THIS PROJECT. THE CONTRACTOR SHALL ENSURE THAT THE NECESSARY RIGHTS-OF-WAY, EASEMENTS, AND/OR PERMITS ARE SECURED PRIOR TO CONSTRUCTION.
- CONTRACTOR SHALL OBTAIN AN ENCROACHMENT PERMIT WHERE APPLICABLE FOR ANY WORK DONE WITHIN RIGHTS-OF-WAY OR EASEMENTS FROM OGDEN, UT, US ARM CORP OF ENGINEERS AND UDOT, CONTRACTOR SHALL NOTIFY CITY, COUNTY, AND/OR STATE, 24 HOURS IN ADVANCE OF COMMENCING THE WORK, OR AS REQUIRED BY SAID PERMITS.
- THE CONTRACTOR SHALL, AT THE TIME OF BIDDING, AND, THROUGHOUT THE PERIOD OF THE CONTRACT, BE LICENSED IN THE STATE OF UTAH AND SHALL BE BONDABLE FOR AN AMOUNT EQUAL TO OR GREATER THAN THE AMOUNT BID AND TO DO THE TYPE OF WORK CONTEMPLATED IN THE PLANS AND SPECIFICATIONS.
- CONTRACTOR SHALL INSPECT THE SITE OF THE WORK PRIOR TO BIDDING TO SATISFY THEMSELVES BY PERSONAL EXAMINATION OR BY SUCH OTHER MEANS AS THEY MAY PREFER, OF THE LOCATION OF THE PROPOSED WORK, AND OF THE ACTUAL CONDITIONS OF, AND AT, THE SITE OF WORK. IF, DURING THE COURSE OF THEIR EXAMINATION, A BIDDER FINDS FACTS OR CONDITIONS WHICH APPEAR TO THEM TO BE IN CONFLICT WITH THE LETTER OR SPIRIT OF THE PROJECT PLANS AND SPECIFICATIONS, THEY SHALL CONTACT THE ENGINEER FOR ADDITIONAL INFORMATION AND EXPLANATION BEFORE SUBMITTING

THEIR BID. SUBMISSION OF A BID BY THE CONTRACTOR SHALL CONSTITUTE ACKNOWLEDGMENT THAT, IF AWARDED THE CONTRACT THEY HAVE RELIED AND ARE RELYING ON THEIR OWN EXAMINATION OF (1) THE SITE OF THE WORK, (2) ACCESS TO THE SITE, AND (3) ALL OTHER DATA AND MATTERS REQUISITE TO THE FULFILLMENT OF THE WORK AND ON THEIR OWN KNOWLEDGE OF EXISTING FACILITIES ON AND IN THE VICINITY OF THE SITE OF THE WORK TO BE CONSTRUCTED UNDER THIS CONTRACT. THE INFORMATION PROVIDED BY THE OWNER OR THE ENGINEER IS NOT INTENDED TO BE A SUBSTITUTE FOR, OR A SUPPLEMENT TO THE INDEPENDENT VERIFICATION BY THE CONTRACTOR TO THE EXTENT SUCH INDEPENDENT INVESTIGATION OF SITE CONDITIONS IS DEEMED NECESSARY OR DESIRABLE BY THE CONTRACTOR. CONTRACTOR SHALL ACKNOWLEDGE THAT THEY HAVE NOT RELIED SOLELY UPON OWNER OR ENGINEER FURNISHED INFORMATION REGARDING SITE CONDITIONS IN PREPARING AND SUBMITTING THEIR BID.

- 11) THE CONTRACTOR SHALL PROVIDE ALL LIGHTS, BARRICADES, SIGNS, FLAGMEN OR OTHER DEVICES NECESSARY FOR PUBLIC SAFETY.
- 12) THE CONTRACTOR SHALL BE RESPONSIBLE TO PROVIDE ALL WATER, POWER, SANITARY FACILITIES AND TELEPHONE SERVICES AS REQUIRED FOR THE CONTRACTORS USE DURING CONSTRUCTION.
- 13) THE CONTRACTOR SHALL BE HELD RESPONSIBLE FOR ANY FIELD CHANGES MADE WITHOUT PRIOR WRITTEN AUTHORIZATION FROM THE OWNER AND/OR ENGINEER.
- 14) THE CONTRACTOR SHALL EXERCISE DUE CAUTION AND SHALL CAREFULLY PRESERVE BENCH MARKS, CONTROL POINTS, SECTION CORNERS, REFERENCE POINTS AND ALL SURVEY STAKES, AND SHALL BEAR ALL EXPENSES FOR REPLACEMENT AND/OR ERRORS CAUSED BY UNNECESSARY LOSS OR DISTURBANCE.
- 15) THE CONTRACTOR AGREES THAT:
 - A) THEY SHALL BE RESPONSIBLE TO CLEAN THE JOB SITE AT THE END OF EACH DAY.
 - B) THEY SHALL BE RESPONSIBLE TO REMOVE AND DISPOSE OF ALL TRASH, SCRAP AND UNUSED MATERIAL AT THEIR OWN EXPENSE IN A TIMELY MANNER.
 - C) THEY SHALL BE RESPONSIBLE TO MAINTAIN THE SITE IN A NEAT, SAFE AND ORDERLY MANNER AT ALL TIMES.
 - D) THEY SHALL BE RESPONSIBLE TO KEEP MATERIALS, EQUIPMENT, AND TRASH OUT OF THE WAY OF OTHER CONTRACTORS SO AS NOT TO DELAY THE JOB. FAILURE TO DO SO WILL RESULT IN A DEDUCTION FOR THE COST OF CLEAN UP FROM THE FINAL PAYMENT.
 - E) THEY SHALL BE RESPONSIBLE FOR THEIR OWN SAFETY, TRAFFIC CONTROL, PERMITS, RETESTING AND RE-INSPECTIONS AT THEIR OWN EXPENSE
- 16) THE CONTRACTOR SHALL ASSUME SOLE AND COMPLETE RESPONSIBILITY FOR JOBSITE CONDITIONS DURING THE COURSE OF CONSTRUCTION OF THIS PROJECT, INCLUDING SAFETY OF ALL PERSONS AND PROPERTY. THIS REQUIREMENT SHALL APPLY CONTINUOUSLY AND NOT BE LIMITED TO NORMAL WORKING HOURS. THE CONTRACTOR SHALL DEFEND, INDEMNIFY AND HOLD THE OWNER AND ENGINEER HARMLESS FROM ANY AND ALL LIABILITY, REAL OR ALLEGED, IN CONNECTION WITH THE PERFORMANCE OF WORK ON THIS PROJECT, EXCEPTING FOR LIABILITY ARISING FROM THE SOLE AND GROSS NEGLIGENCE OF THE OWNER OR THE ENGINEER.
- 17) DUST CONTROL SHALL BE PROVIDED AT ALL TIMES. AT THE CONTRACTOR'S EXPENSE, TO MINIMIZE ANY DUST NUISANCE AND SHALL BE IN ACCORDANCE WITH THE REQUIREMENTS OF OGDEN CITY.
- 18) WHEN CONSTRUCTION STAKING IS REQUIRED THE CONTRACTOR SHALL NOTIFY THE ENGINEER/LAND SURVEYOR 1 WEEK IN ADVANCE OF THE NEED FOR STAKING. ANY STAKING REQUESTED BY THE CONTRACTOR OR THEIR SUBCONTRACTORS THAT IS ABOVE AND BEYOND STANDARD STAKING NEEDS, INCLUDING RE-STAKING WILL BE SUBJECT TO A CONTRACTOR CHANGE ORDER AND THE IMPACT COSTS OF WORK PERFORMED
- 19) FOR ALL WORK WITHIN PUBLIC RIGHTS-OF-WAYS OR EASEMENTS, THE CONTRACTOR SHALL PRESERVE THE INTEGRITY AND LOCATION OF ANY AND ALL PUBLIC UTILITIES AND PROVIDE THE NECESSARY CONSTRUCTION TRAFFIC CONTROL. CONTRACTOR SHALL, THROUGH THE ENCROACHMENT PERMIT PROCESS, VERIFY WITH THE NECESSARY REGULATORY AGENCIES, THE NEED FOR ANY TRAFFIC ROUTING PLAN. IF PLAN IS REQUIRED, CONTRACTOR SHALL PROVIDE PLAN AND RECEIVE PROPER APPROVALS PRIOR TO BEGINNING CONSTRUCTION.
- 20) THE CONTRACTOR SHALL BE RESPONSIBLE FOR ADEQUATELY SCHEDULING INSPECTION AND TESTING OF ALL FACILITIES CONSTRUCTED UNDER THIS CONTRACT. ALL TESTING SHALL CONFORM TO THE REGULATORY AGENCY'S STANDARD SPECIFICATIONS. ALL RE-TESTING AND/OR RE-INSPECTION SHALL BE PAID FOR BY THE CONTRACTOR.
- 21) IF EXISTING FEATURES NEED TO BE DISTURBED AND/OR REMOVED FOR THE PROPER PLACEMENT OF IMPROVEMENTS TO BE CONSTRUCTED BY THESE PLANS, THE CONTRACTOR SHALL BE RESPONSIBLE FOR PROTECTING EXISTING FEATURES FROM DAMAGE. COST OF REPLACING OR REPAIRING EXISTING FEATURES SHALL BE INCLUDED IN THE BID PRICE FOR ITEMS REQUIRING REMOVAL AND/OR REPLACEMENT.

- 22) THE CONTRACTOR SHALL MAINTAIN A NEATLY MARKED SET OF FULL-SIZE AS-BUILT DRAWINGS SHOWING THE FINAL LOCATION AND LAYOUT OF ALL FACILITIES. AS-BUILT DRAWINGS SHALL REFLECT CHANGE ORDERS, ACCOMMODATIONS, AND ADJUSTMENTS TO ALL IMPROVEMENTS CONSTRUCTED. WHERE NECESSARY, SUPPLEMENTAL DRAWINGS SHALL BE PREPARED AND SUBMITTED BY THE CONTRACTOR. PRIOR TO ACCEPTANCE OF THE PROJECT, THE CONTRACTOR SHALL DELIVER TO THE ENGINEER, ONE SET OF NEATLY MARKED AS-BUILT DRAWINGS SHOWING THE INFORMATION REQUIRED ABOVE. AS-BUILT DRAWINGS SHALL BE REVIEWED AND THE COMPLETE AS-BUILT DRAWING SET SHALL BE CURRENT WITH ALL CHANGES AND DEVIATIONS REDLINED AS A PRECONDITION TO THE FINAL PROGRESS PAYMENT APPROVAL AND/OR FINAL ACCEPTANCE.
- 23) WORK IN EASEMENT AND/OR RIGHTS-OF-WAY IS SUBJECT TO THE APPROVAL AND ACCEPTANCE OF THE REGULATORY AGENCY RESPONSIBLE FOR OPERATION AND/OR MAINTENANCE OF SAID EASEMENT AND/OR RIGHTS-OF-WAY.
- 24) NO ALLOWANCE WILL BE MADE FOR DISCREPANCIES OR OMISSIONS THAT CAN BE EASILY OBSERVED. VERIFY ALL EXISTING CONDITIONS BEFORE BIDDING, AND ANSWER ANY QUESTIONS BEFORE CONSTRUCTION.
- 25) FURNISH, MAINTAIN, AND RESTORE ALL MONUMENTS AND MONUMENT REFERENCE MARKS WITHIN THE PROJECT SITE. CONTACT THE CITY OR COUNTY SURVEYOR FOR MONUMENT LOCATIONS AND CONSTRUCTION DETAILS.
- 26) PROVIDE A CONSTRUCTION SCHEDULE IN ACCORDANCE WITH CITY, COUNTY, AND STATE REGULATIONS FOR WORKING IN THE PUBLIC WAY.
- 27) FURNISH ALL MATERIALS TO COMPLETE THE PROJECT. 28) TRAFFIC CONTROL IS TO CONFORM TO THE CURRENT MUTCD AND
- UDOT STANDARDS. 29) CONTRACTOR SHALL BE RESPONSIBLE FOR ANY DAMAGE TO ADJACENT SURFACE IMPROVEMENTS.
- 30) ALL EXISTING ASPHALT WILL BE SAW CUT IN NEAT STRAIGHT LINES BY THE CONTRACTOR PRIOR TO EXCAVATION.
- 31) STRIPING WILL BE PER THE PLANS AND/OR AS DIRECTED BY THE OWNER'S REPRESENTATIVE. STRIPING TO INCLUDE HANDICAP INSIGNIAS, SIGNS, CROSS-HATCHING, DIRECTION ARROWS, ETC. AS SHOWN OR AS DIRECTED.

GENERAL CLEARING AND GRADING NOTES:

- CONTRACTOR IS RESPONSIBLE FOR PREPARING AND SUBMITTING A STORM WATER POLLUTION PREVENTION PLAN (SWPPP) TO OWNER FOR APPROVAL PRIOR TO BEGINNING ANY CLEARING AND GRUBBING ACTIVITIES.
- CONTRACTOR IS TO AVOID ANY DISCHARGE OF SEDIMENT OR OTHER CONSTRUCTION MATERIALS INTO ANY PORTION OF THE CREEK CHANNEL
- 3. CLEARING, GRUBBING AND DISPOSAL OF VEGETATIVE MATERIAL NEEDS TO BE IN ACCORDANCE WITH STATE AND COUNTY REGULATIONS, WHICH APPLY TO SOLID WASTE.
- 4. CONTRACTOR SHALL PERFORM EARTHWORK IN ACCORDANCE WITH OGDEN CITY STANDARD SPECIFICATIONS AND CONSTRUCTION STANDARDS, EROSION, SEDIMENT, RE-VEGETATION REQUIREMENTS AND THE SWPP PLAN AS REQUIRED BY THE STATE OF UTAH, DEPARTMENT OF ENVIRONMENTAL QUALITY AND DIVISION OF AIR QUALITY.
- THE CONTRACTOR WILL PERFORM EARTHWORK IN ACCORDANCE WITH TECHNICAL SPECIFICATIONS OUTLINED IN THE CONSTRUCTION STANDARDS
- EROSION CONTROL AND SEDIMENT CONTROL PLANS (STORM WATER POLLUTION PREVENTION PLAN) TO BE INSTALLED WITHIN THE SAME WORKING DAY THE LAND DISTURBANCE OCCURS.
- DUST CONTROL BMP'S ARE TO BE ON SITE AND IMPLEMENTED AS SOON AS LAND DISTURBANCE OCCURS
- THE EXISTING TOPOGRAPHY SHOWN ON THESE PLANS IS BASED ON DRAWINGS AND A TOPOGRAPHIC SURVEY PERFORMED BY CRS ENGINEERS. IF THE EXISTING GRADE IS DIFFERENT FROM WHAT IS SHOWN ON THE GRADING PLAN, STOP WORK AND CONTACT CRS ENGINEERS. WORK IS TO REMAIN STOPPED UNTIL THE ENGINEER PROVIDES A WRITTEN NOTICE TO RESUME WORK.
- 9. THE CONTRACTOR IS RESPONSIBLE FOR MAINTAINING THE STREETS, STORM DRAINS, CHANNELS, DITCHES, AND SWALES FREE FROM DEBRIS SOIL, MUD, OR OTHER MATERIAL THAT WOULD CAUSE A PUBLIC SAFETY CONCERN OR VIOLATE ANY CITY, STATE, OR FEDERAL LAWS.
- 10. BMP'S ARE TO BE IN PLACE AND MAINTAINED UNTIL WRITTEN NOTIFICATION IS RECEIVED FROM OGDEN CITY.
- 11. NO DISTURBANCE WILL BE ALLOWED IN THE AREA SOUTH WEST OF THE EXISTING PATH. DUE TO THE EXISTENCE OF ENVIRONMENTALLY SENSITIVE VEGETATION. SEE ENVIRONMENT ASSESSMENT BY CRS DATED.
- 12. IF DISTURBANCE OCCURS OUTSIDE THE LIMITS OF DISTURBANCE, WORK WILL STOP AND REMAIN STOPPED UNTIL A WRITTEN RESPONSE IS RECEIVED FROM THE ENGINEER.
- 13. THE CONTRACTOR SHALL REMOVE ALL VEGETATION AND DELETERIOUS

MATERIALS FROM THE SITE UNLESS NOTED OTHERWISE

 NATURAL VEGETATION AND SOIL COVER SHALL NOT BE DISTURBED PRIOR TO ACTUAL CONSTRUCTION OF A REQUIRED FACILITY OR IMPROVEMENT. MASS CLEARING OF THE SITE IN ANTICIPATION OF CONSTRUCTION SHALL BE AVOIDED. CONSTRUCTION TRAFFIC SHALL BE LIMITED TO ONE APPROACH TO SITE. THE APPROACH SHALL BE DESIGNATED BY THE OWNER.

GENERAL UTILITY NOTES

- THE LOCATIONS OF UNDERGROUND FACILITIES SHOWN ON THESE PLANS ARE BASED ON FIELD SURVEYS AND LOCAL UTILITY COMPANY RECORDS. IT SHALL BE THE CONTRACTORS FULL RESPONSIBILITY TO CONTACT THE VARIOUS UTILITY COMPANIES TO LOCATE THEIR FACILITIES PRIOR TO PROCEEDING WITH CONSTRUCTION. NO ADDITIONAL COMPENSATION SHALL BE PAID TO THE CONTRACTOR FOR DAMAGE AND REPAIR TO THESE FACILITIES CAUSED BY CONTRACTORS WORK FORCE.
- START AT THE LOW END OF ALL GRAVITY FED LINES AND WORK UPHILL. FAILURE TO COMPLY WITH THIS NOTE SHALL RELEASE THE CIVIL ENGINEER OF ALL LIABILITY.
- CONTRACTOR SHALL LAYOUT AND POTHOLE FOR ALL POTENTIAL CONFLICTS WITH UTILITY LINES ON OR OFF SITE AS REQUIRED PRIOR TO ANY CONSTRUCTION.
- 4. STORM DRAIN SEE OGDEN CITY STANDARDS & SPECIFICATIONS FOR ALL DETAILS & SPECIFICATIONS GOVERNING THE CONSTRUCTION & INSPECTION OF THE STORM DRAIN & APPURTENANCES WITHIN THE PUBLIC RIGHT-OF-WAY AS SHOWN ON THIS PLAN. SEE THE DETAILS PROVIDED ON THIS SET OF DRAWINGS FOR ALL OTHER STORM DRAIN CONSTRUCTION. APWA STANDARDS WILL BE USED IN THE ABSENCE OF ANY STANDARDS AND DETAILS.
- ALL DIMENSIONS AND GRADES OF EXISTING STORM DRAIN PIPES, BOX CULVERTS, STRUCTURES, ETC. SHOWN ON THE PLANS SHALL BE VERIFIED BY THE CONTRACTOR PRIOR TO CONSTRUCTION. NOTIFY THE ENGINEER IF ANY DISCREPANCIES EXIST, PRIOR TO PROCEEDING WITH CONSTRUCTION FOR NECESSARY PLAN OR GRADE CHANGES. NO EXTRA COMPENSATION SHALL BE PAID TO THE CONTRACTOR FOR WORK HAVING TO BE REDONE DUE TO THE DIMENSIONS OR GRADES SHOWN INCORRECTLY ON THESE PLANS, IF SUCH NOTIFICATION HAS NOT BEEN GIVEN.
- THESE PLANS SHOW THE LOCATION OF POWER, NATURAL GAS, AND COMMUNICATIONS UTILITIES, BUT ARE NOT DESIGN DRAWINGS FOR THE RELOCATION OR REMOVAL OF EXISTING DRY UTILITIES, NOR FOR ANY NEW DRY UTILITY STUBS. CONTRACTOR IS TO SUBMIT SITE PLAN TO DRY UTILITIES FOR DESIGN OF SERVICE CONNECTIONS TO BUILDING. ACTUAL CONSTRUCTION OF SAID SERVICES TO BE DONE BY RESPECTIVE UTILITY PROVIDERS.
- VERIFY DEPTHS OF UTILITIES IN THE FIELD BY POT HOLING A MINIMUM OF 300 FEET AHEAD OF PIPELINE CONSTRUCTION TO AVOID CONFLICTS WITH DESIGNED PIPELINE GRADE AND ALIGNMENT. IF A CONFLICT ARISES RESULTING FROM THE CONTRACTOR'S NEGLIGENCE TO POTHOLE UTILITIES THE CONTRACTOR WILL BE REQUIRED TO RESOLVE THE CONFLICT WITHOUT ADDITIONAL COST OR CLAIM TO THE OWNER OR ENGINEER.
- ALL DIMENSIONS, GRADES, AND UTILITY DESIGNS SHOWN ON THE PLANS SHALL BE VERIFIED BY THE CONTRACTOR PRIOR TO CONSTRUCTION. NOTIFY THE ENGINEER IF ANY DISCREPANCIES EXIST, PRIOR TO PROCEEDING WITH CONSTRUCTION FOR NECESSARY PLAN OR GRADE CHANGES. NO EXTRA COMPENSATION SHALL BE PAID TO THE CONTRACTOR FOR WORK HAVING TO BE REDONE DUE TO THE DIMENSIONS OR GRADES SHOWN INCORRECTLY ON THESE PLANS, IF SUCH NOTIFICATION HAS NOT BEEN GIVEN.
- NO CHANGE IN DESIGN LOCATION OR GRADE WILL BE MADE BY THE CONTRACTOR WITHOUT THE WRITTEN APPROVAL OF THE PROJECT ENGINEER.
- 10. ALL EXISTING MANHOLES, WATER VALVES, CLEAN OUTS, ETC., ARE TO BE RAISED OR LOWERED TO GRADE.

ABBREVIATIONS

APPROXIMATE

APPROX	APPROXIMATE	LIIV.	LOWERSHIT
ASTM	AMERICAN SOCIETY FOR	LP	LOW POINT
7.01101	TESTING AND MATERIALS	MAX	MAXIMUM
		MEG	MATCH EXISTING GRADE
ANSI	AMERICAN NATIONAL	MIN	MINIMUM
	STANDARDS INSTITUTE		
APWA	AMERICAN PUBLIC WORKS	MJ	MECHANICAL JOINT
	ASSOCIATION	N	NORTH
AWWA	AMERICAN WATER WORKS	N/A	NOT APPLICABLE
	ASSOCIATION	NIC	NOT IN CONTACT
DOW		NO	NUMBER
BOW	BOTTOM OF WALL	NTS	NOT TO SCALE
BF	BLIND FLANGE	OC	ON CENTER
BLDG	BUILDING		
С	CHORD LENGTH	OD	OUTSIDE DIAMETER
C TO C	CENTER TO CENTER	OSHA	OCCUPATIONAL SAFETY
CB	CHORD BEARING		& HEALTH ADMINISTRATION
		PE	PLAIN END
CI	CAST IRON	PG	PAGE
CL	CLASS	PI	POINT OF INTERSECTION
CLR	CLEAR	PJDI	PUSH-ON JOINT
CMP	CORRUGATED METAL PIPE	PJDI	
CO	CLEANOUT		DUCTILE IRON
CONC	CONCRETE	PSF	POUNDS PER FOOT
DI	DUCTILE IRON	PSI	POUNDS PER SQUARE
			INCH
DIM	DIMENSION	PUE	PUBLIC UTILITY
Е	EAST	102	EASEMENT
EA	EDGE OF ASPHALT	D) (C	
EG	EXISTING GRADE	PVC	POLYVINYL CHLORIDE
EL	ELEVATION	RCP	REINFORCED CONCRETE
ELEV	ELEVATION		PIPE
		R	RADIUS
EP	EDGE OF PAVEMENT	RT	RIGHT
EW	EACH WAY	RJ	RESTRAINED JOINT
EX	EXISTING	S	SOUTH
FG	FINISH GRADE		
FH	FIRE HYDRANT	SEC	SECTION
FL	FLOWLINE	SS	SANITARY SEWER
FLG	FLANGE	STA	STATION
FT.	FEET	Τ	TOP
		TB	THRUST BLOCK
HDPE	HIGH DENSITY	TBA	TO BE ABANDONED
	POLYETHYLENE PIPE	TBC	TOP BACK CURB
HORIZ	HORIZONTAL	TOC	TOP OF CONCRETE
HP	HIGH POINT		
ID	INSIDE DIAMETER	TOW	TOP OF WALL
IE	INVERT ELEVATION	TYP	TYPICAL
INV	INVERT	UDOT	UTAH DEPARTMENT OF
			TRANSPORTATION
IR	IRON ROD	VERT	VERTICAL
IRR	IRRIGATION	W	WATER
LT	LEFT	W	
L	LENGTH		WEST
LBS	POUNDS	W/	WITH
L.F.	LINEAR FEET	WWF	WELDED WIRE FABRIC

LINEAR


APPROVED


FOR CONSTRUCTION

D. ANDERSON, PE THE ABOVE SCALE BAR DOES NOT MEASURE 1-INCH N LENGTH, DO NOT USE THIS DRAWING FOR SCALING M. CHANDLER, PE PURPOSES. DIMENSIONS AND MEASUREMENTS SPECIFIED IN THE DRAWING TAKE PRECEDENCE TO C. ALLEN. PE SCALED MEASUREMENTS. D. ZOLLINGER THE INFORMATION CONTAINED IN THIS DRAWING IS THE PROPERTY OF CRS ENGINEERS AND IS NOT TO BE REPRODUCED, MODIFIED OR USED FOR ANY OTHE AS SHOWN PROJECT OR EXTENSION OF THIS PROJECT EXCEPT B AGREEMENT WITH CRS ENGINEERS. AUGUST 2, 2018


CRS ENGINEERS D Answers to Infrastructure® 4246 S Riverboat Rd, Ste 200 | Salt Lake City, UT 84123 | P: 801.359.5565 | www.crsengineers.com


OGDEN CITY WHEELER CREEK DIVERSION NOTES. LEGEND. AND ABBREVIATIONS

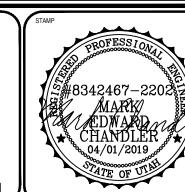


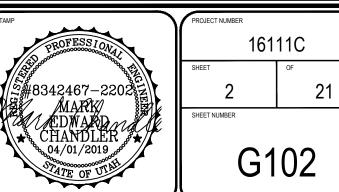


SR39 & PINEVIEW RESERVOIR

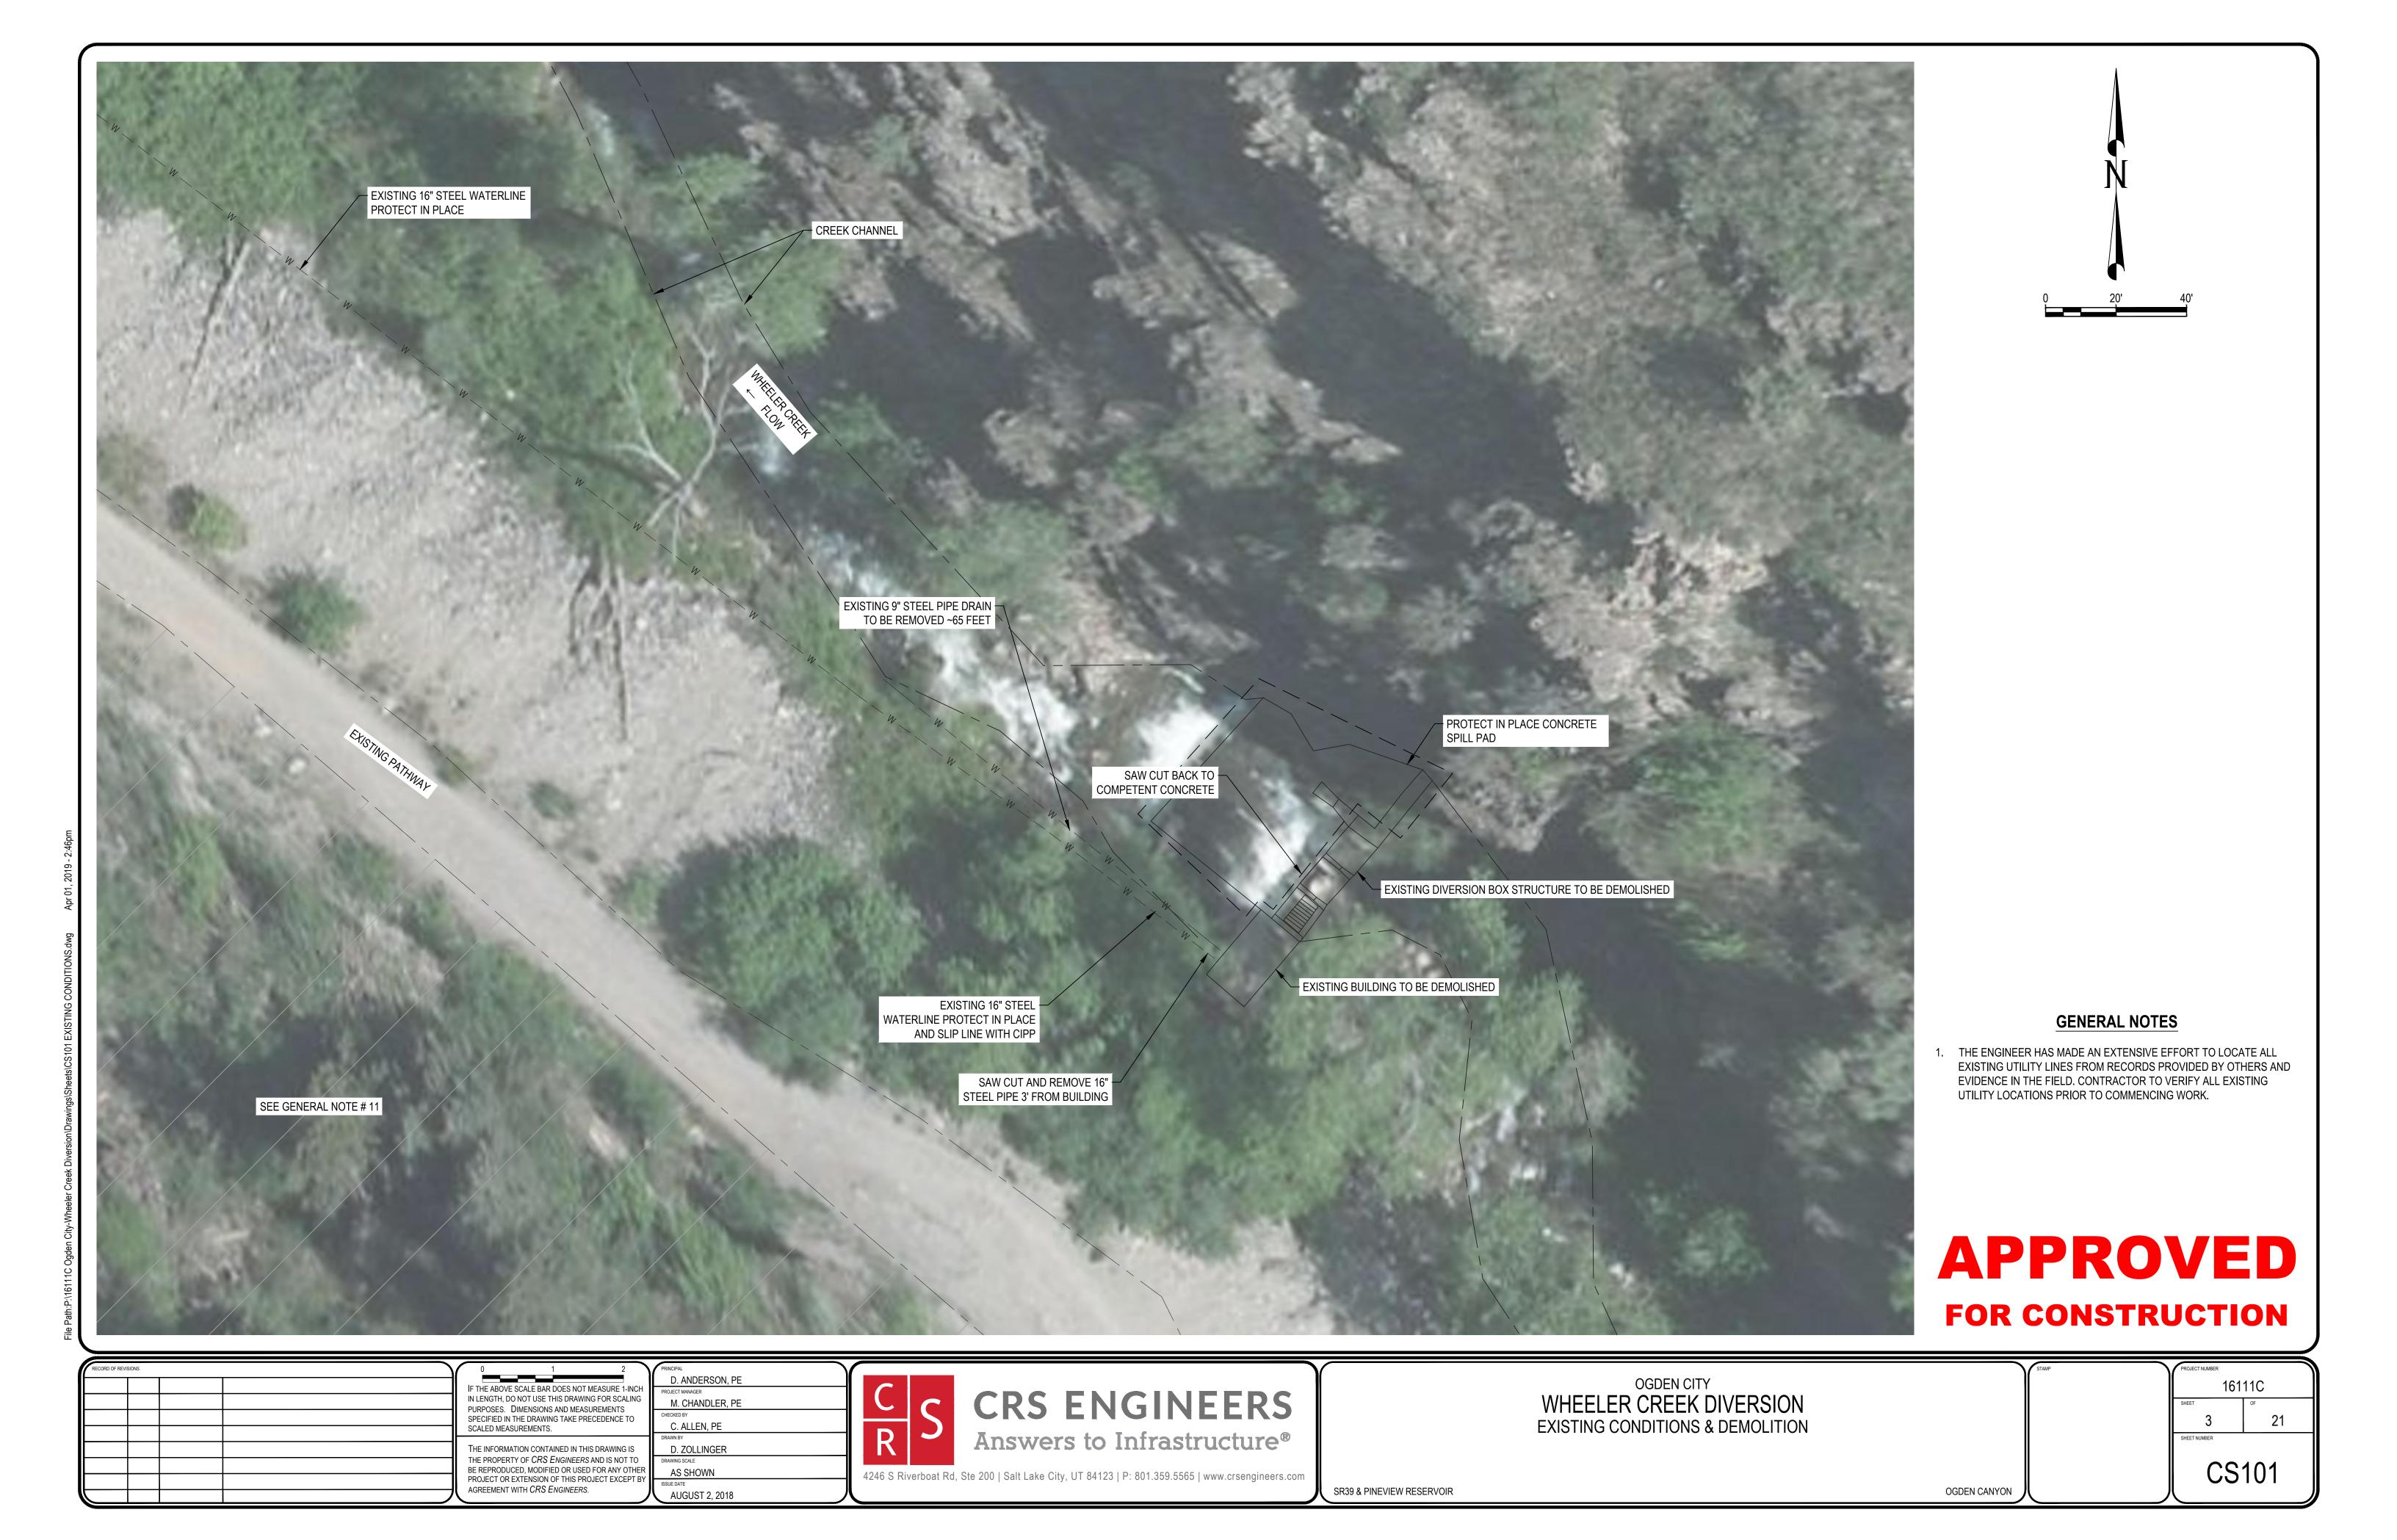

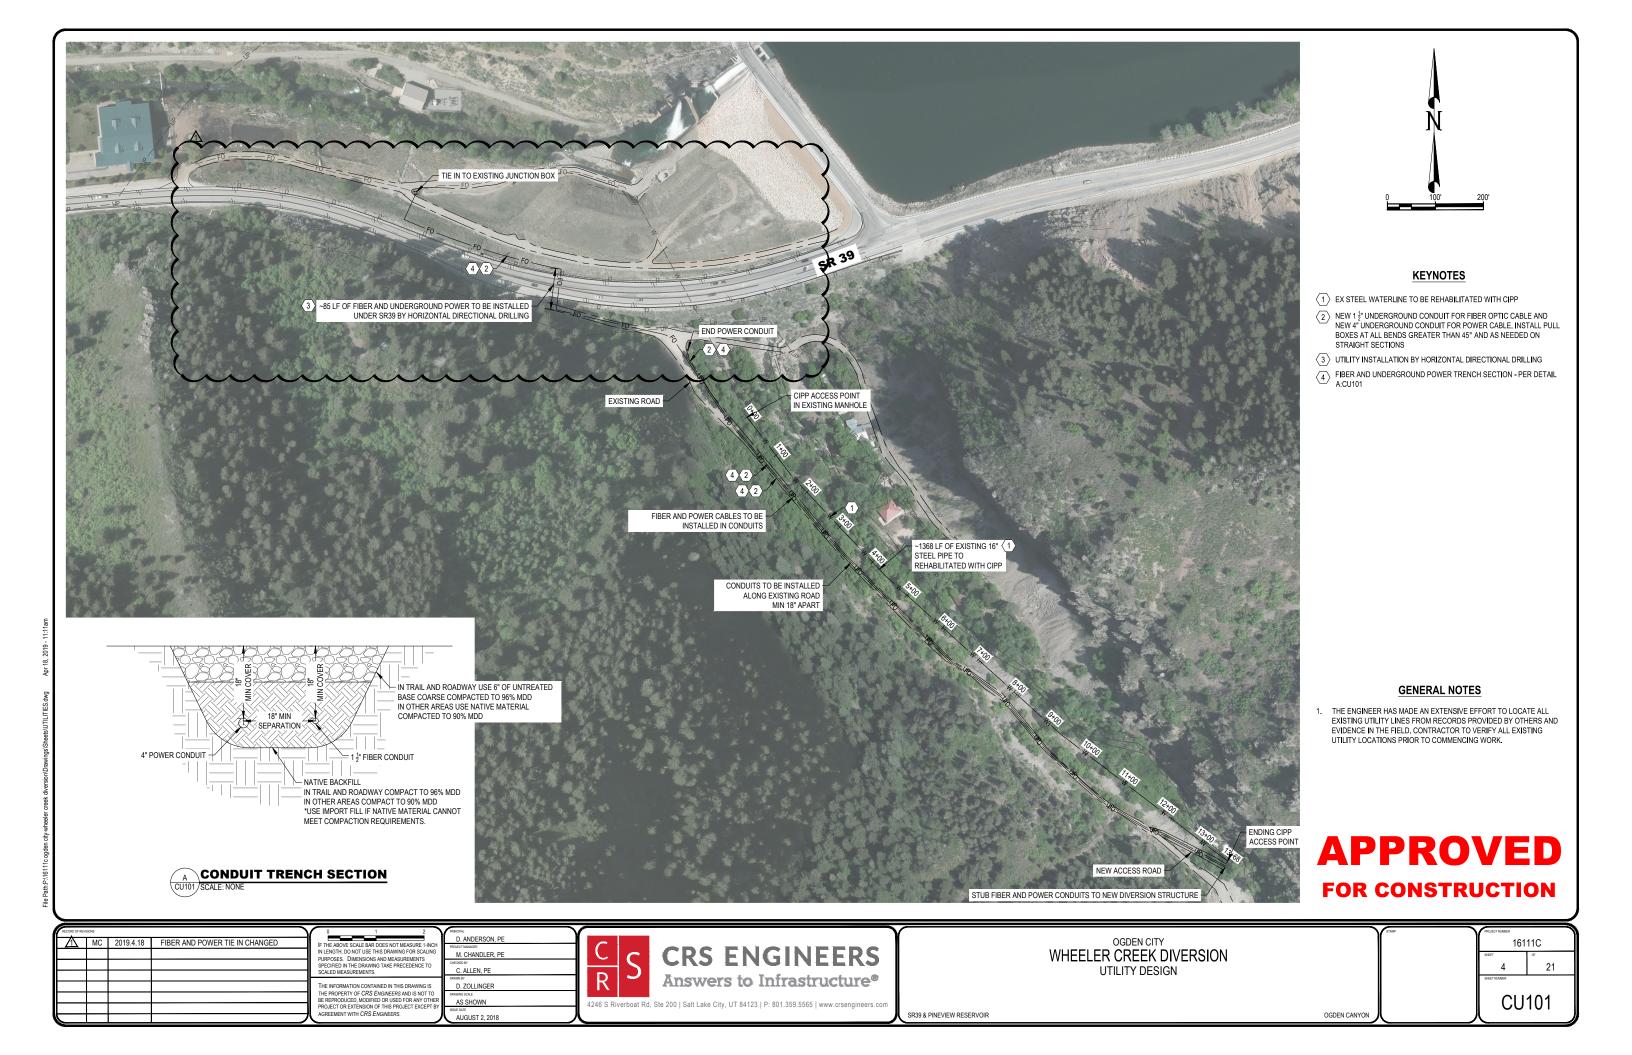

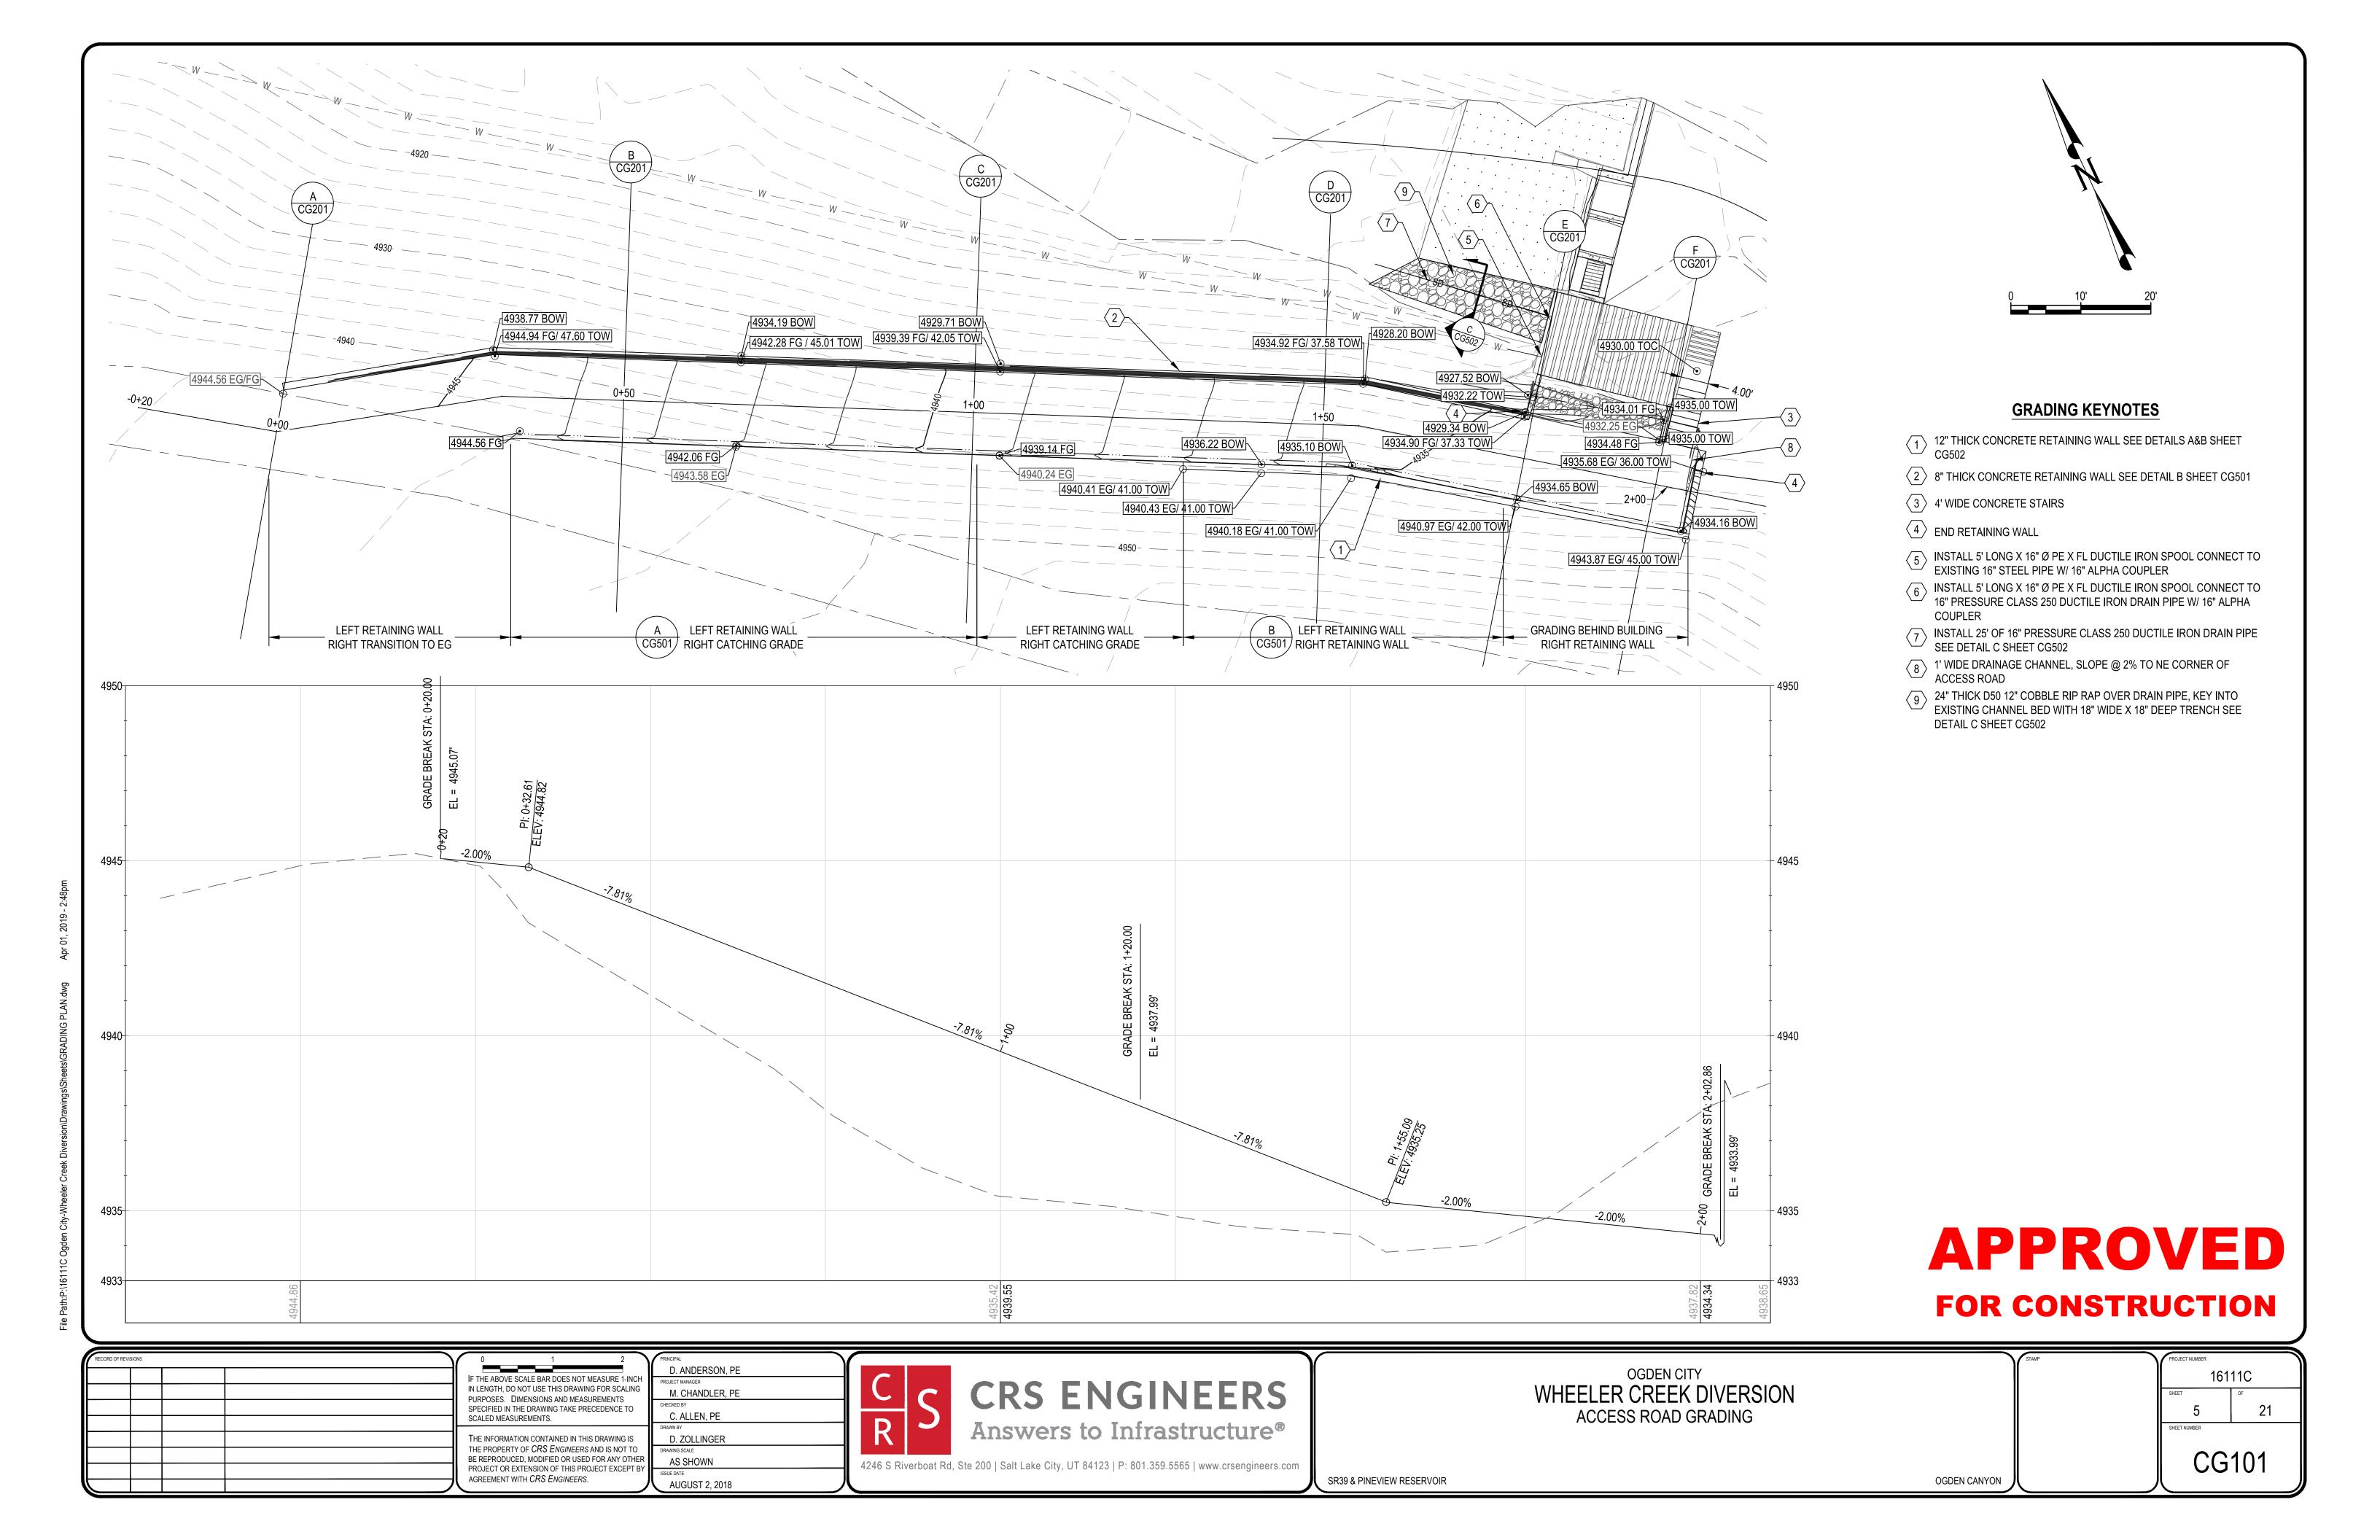

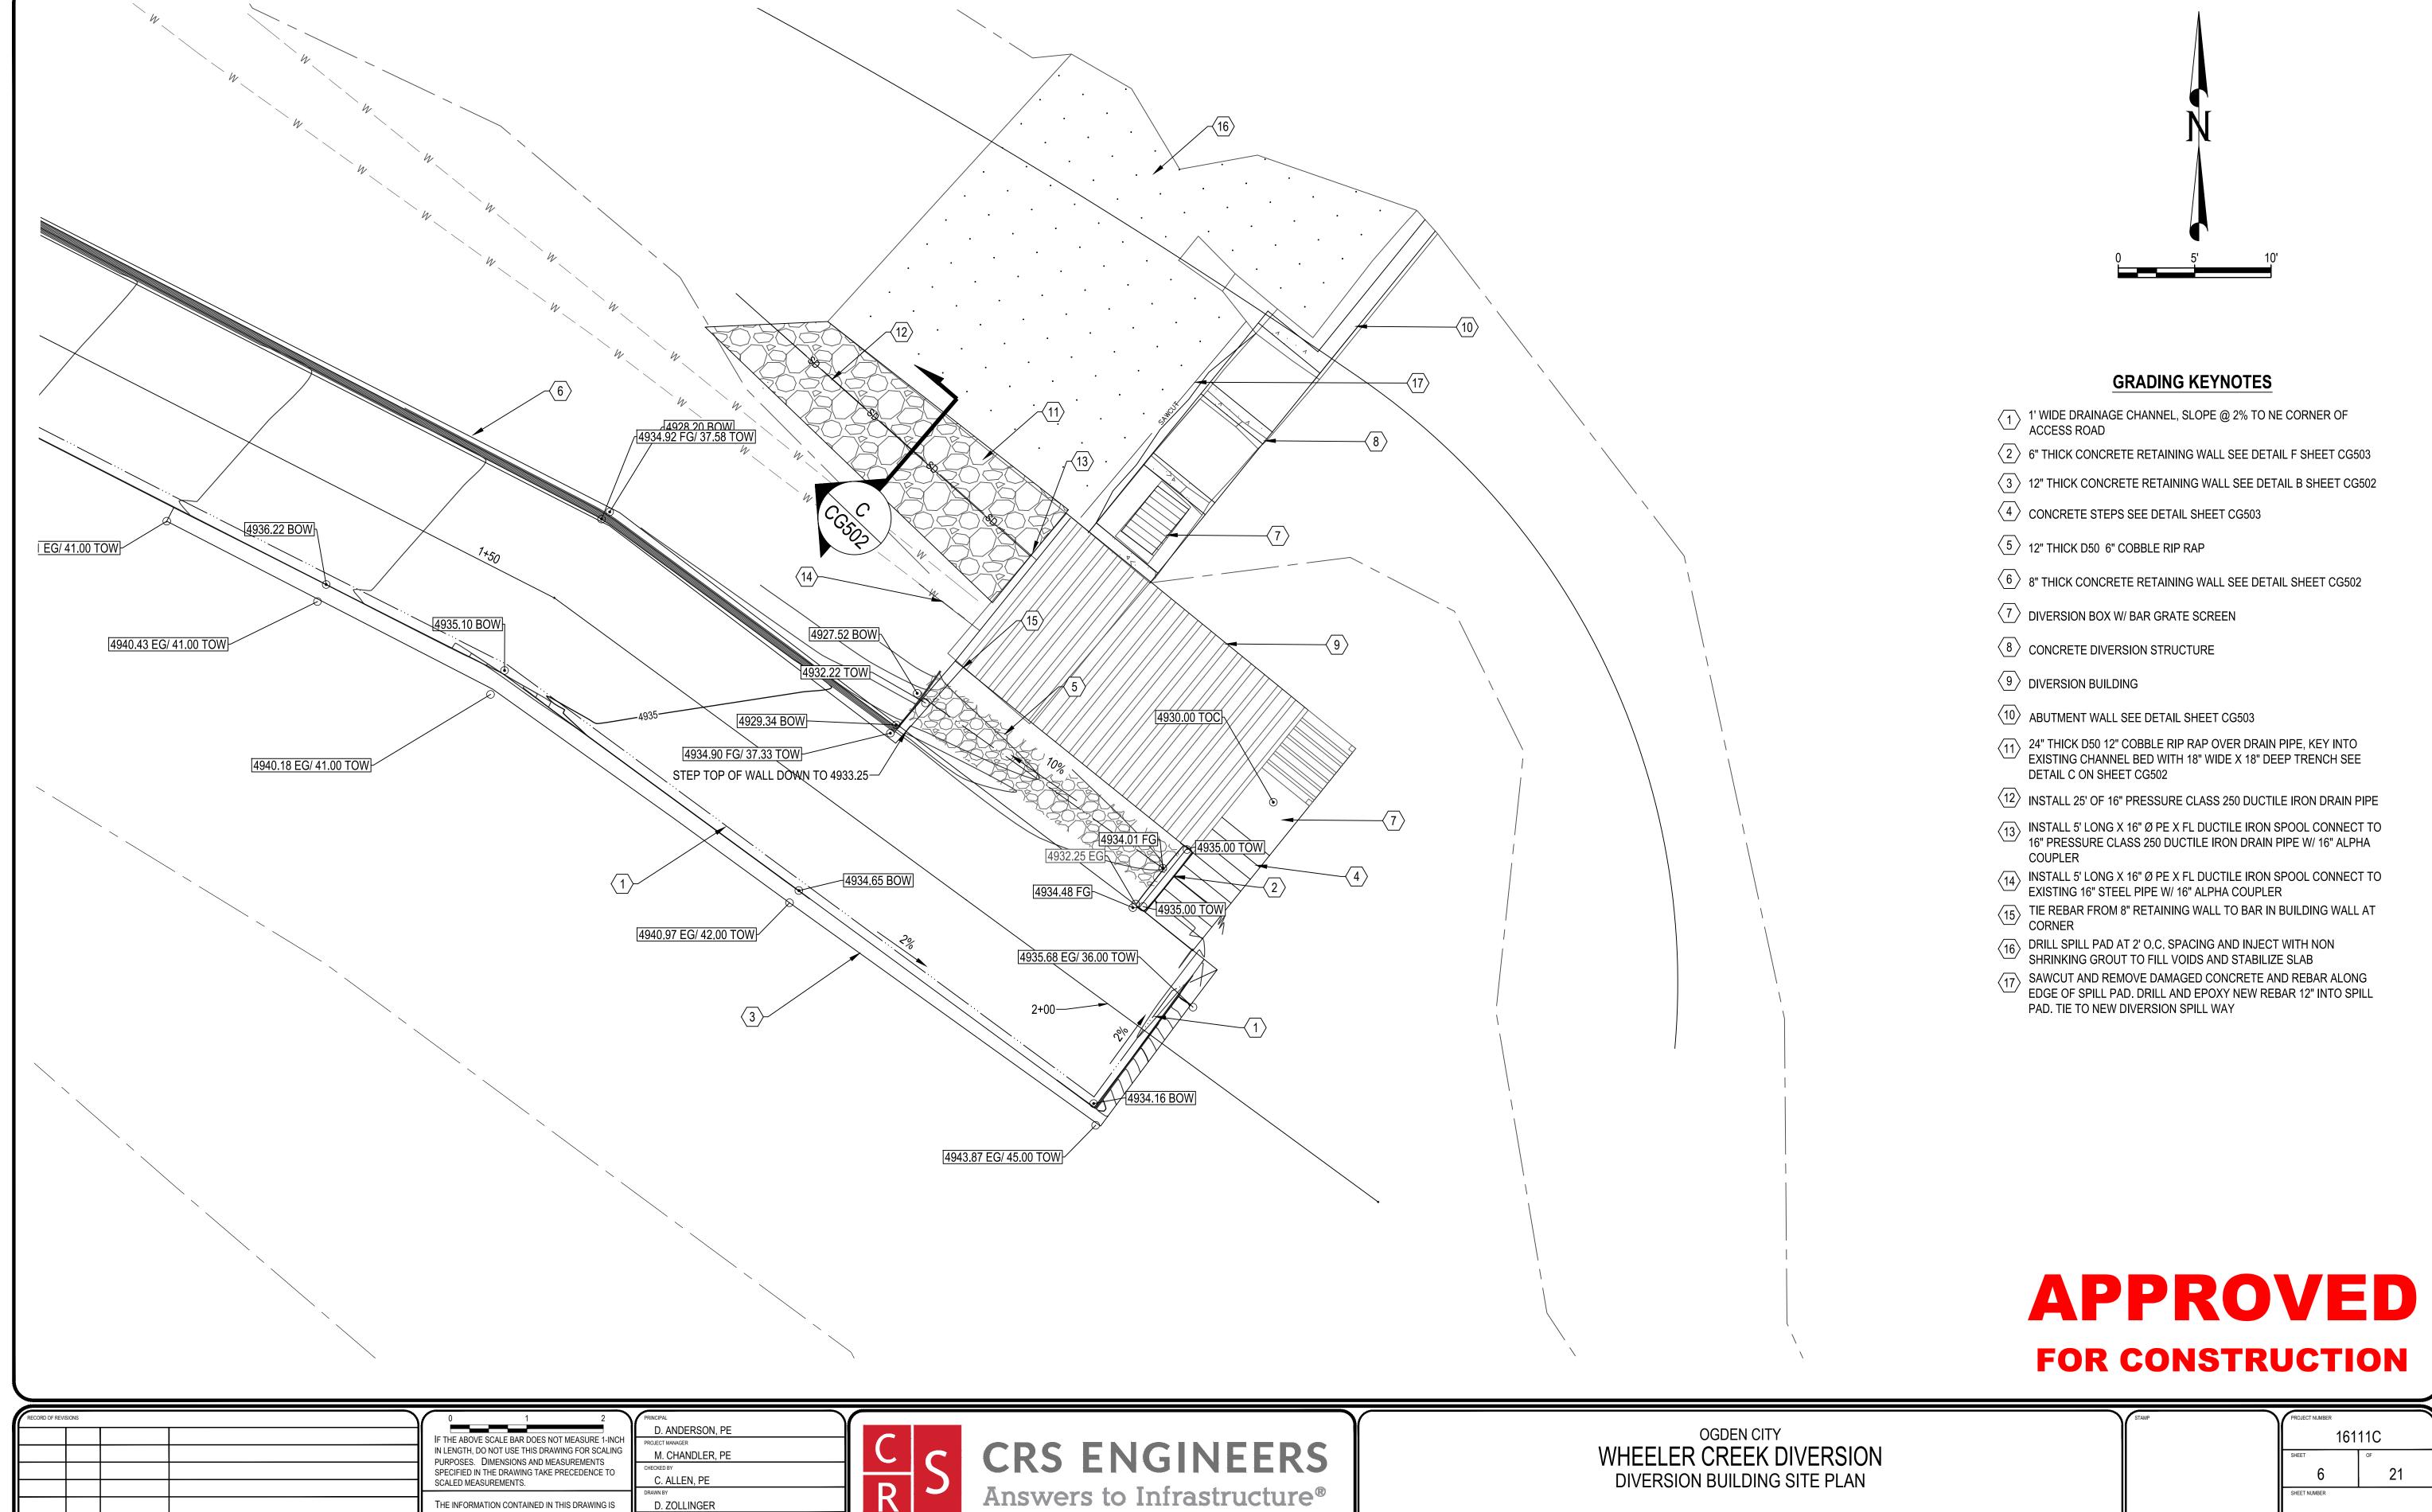

4246 S Riverboat Rd, Ste 200 | Salt Lake City, UT 84123 | P: 801.359.5565 | www.crsengineers.com

SR39 & PINEVIEW RESERVOIR

THE PROPERTY OF CRS ENGINEERS AND IS NOT TO

BE REPRODUCED, MODIFIED OR USED FOR ANY OTHER

PROJECT OR EXTENSION OF THIS PROJECT EXCEPT BY

AGREEMENT WITH CRS ENGINEERS.

AS SHOWN


AUGUST 2, 2018


OGDEN CANYON

CG102

SECTION VIEW 1


CG201 SCALE: 1:10

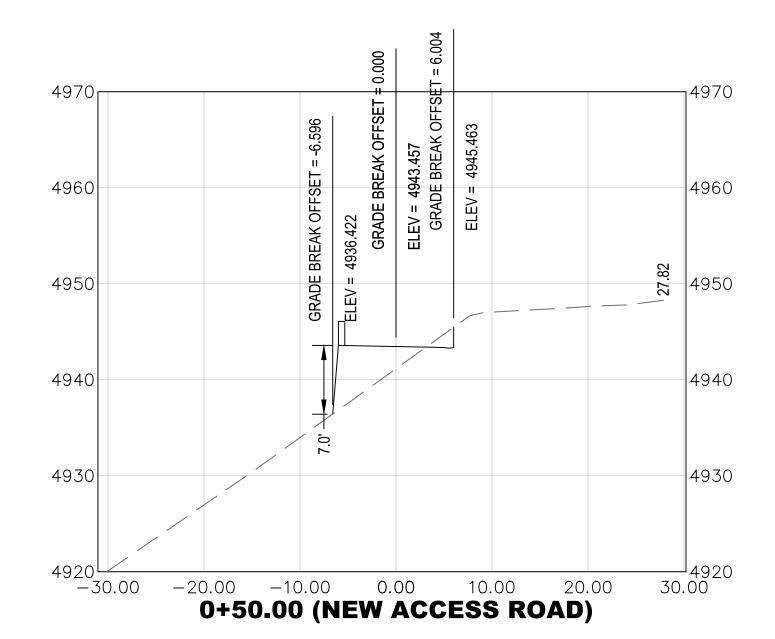


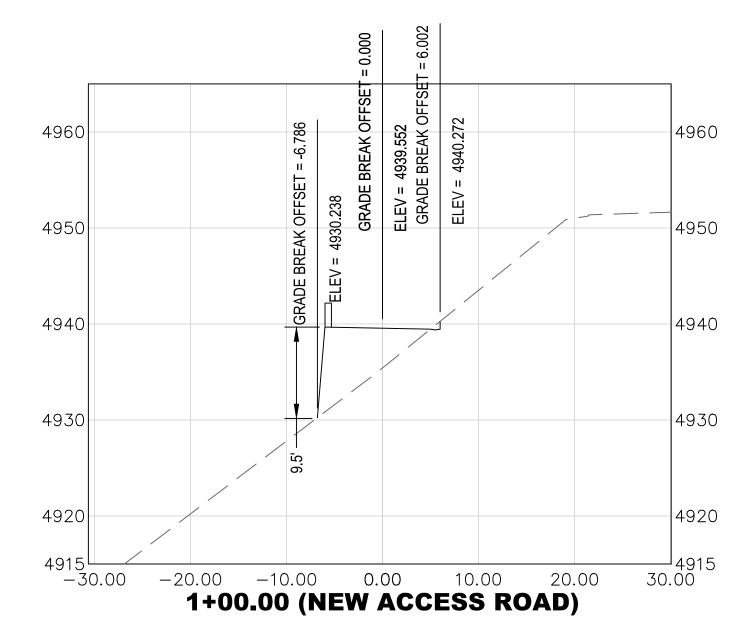






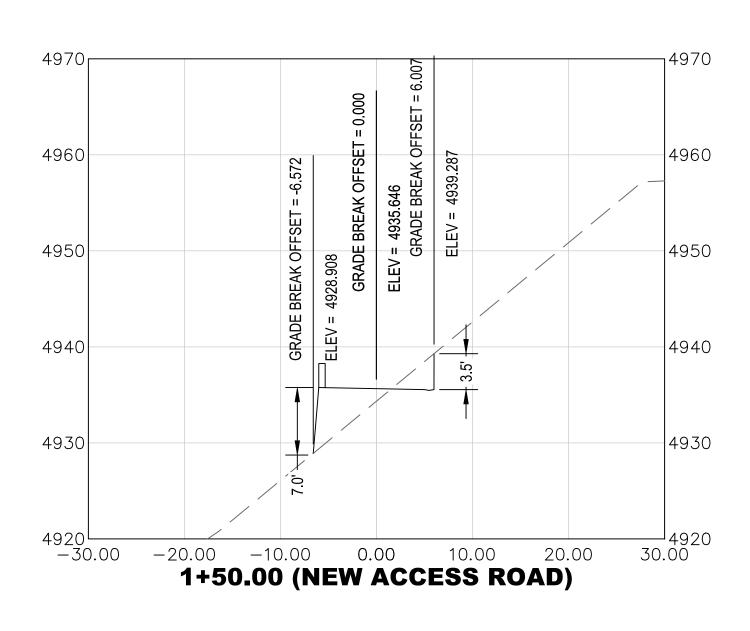


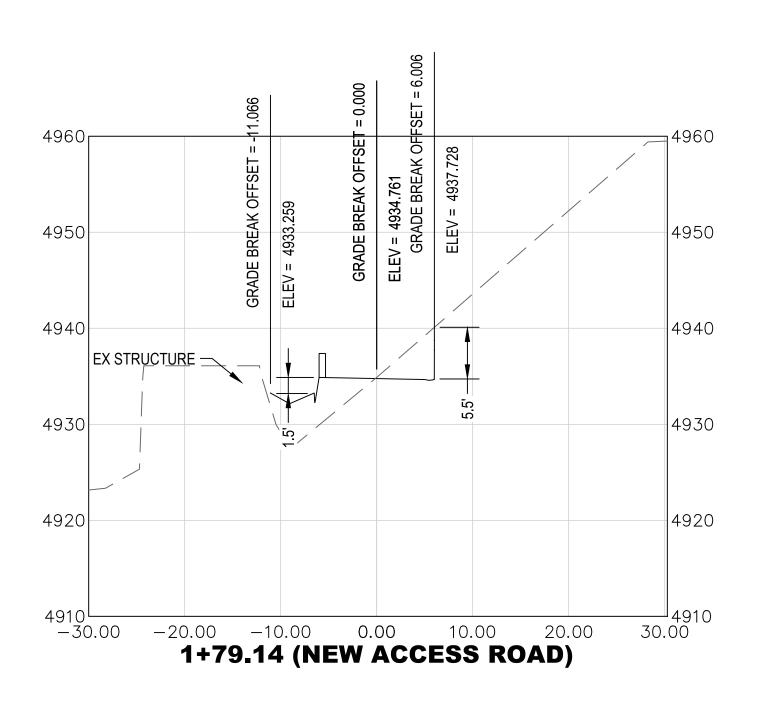

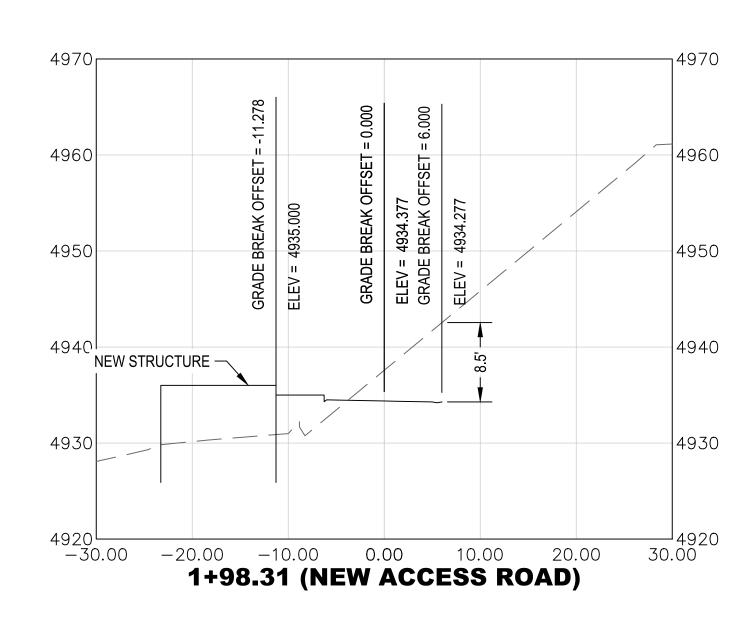

SECTION VIEW 4 **SECTION VIEW 5**




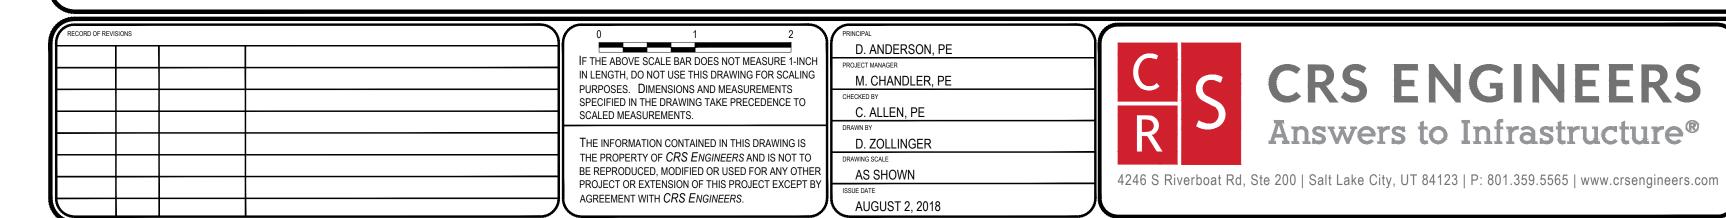



OGDEN CITY WHEELER CREEK DIVERSION **GRADING SECTION VIEWS**


16111C CG201


SR39 & PINEVIEW RESERVOIR

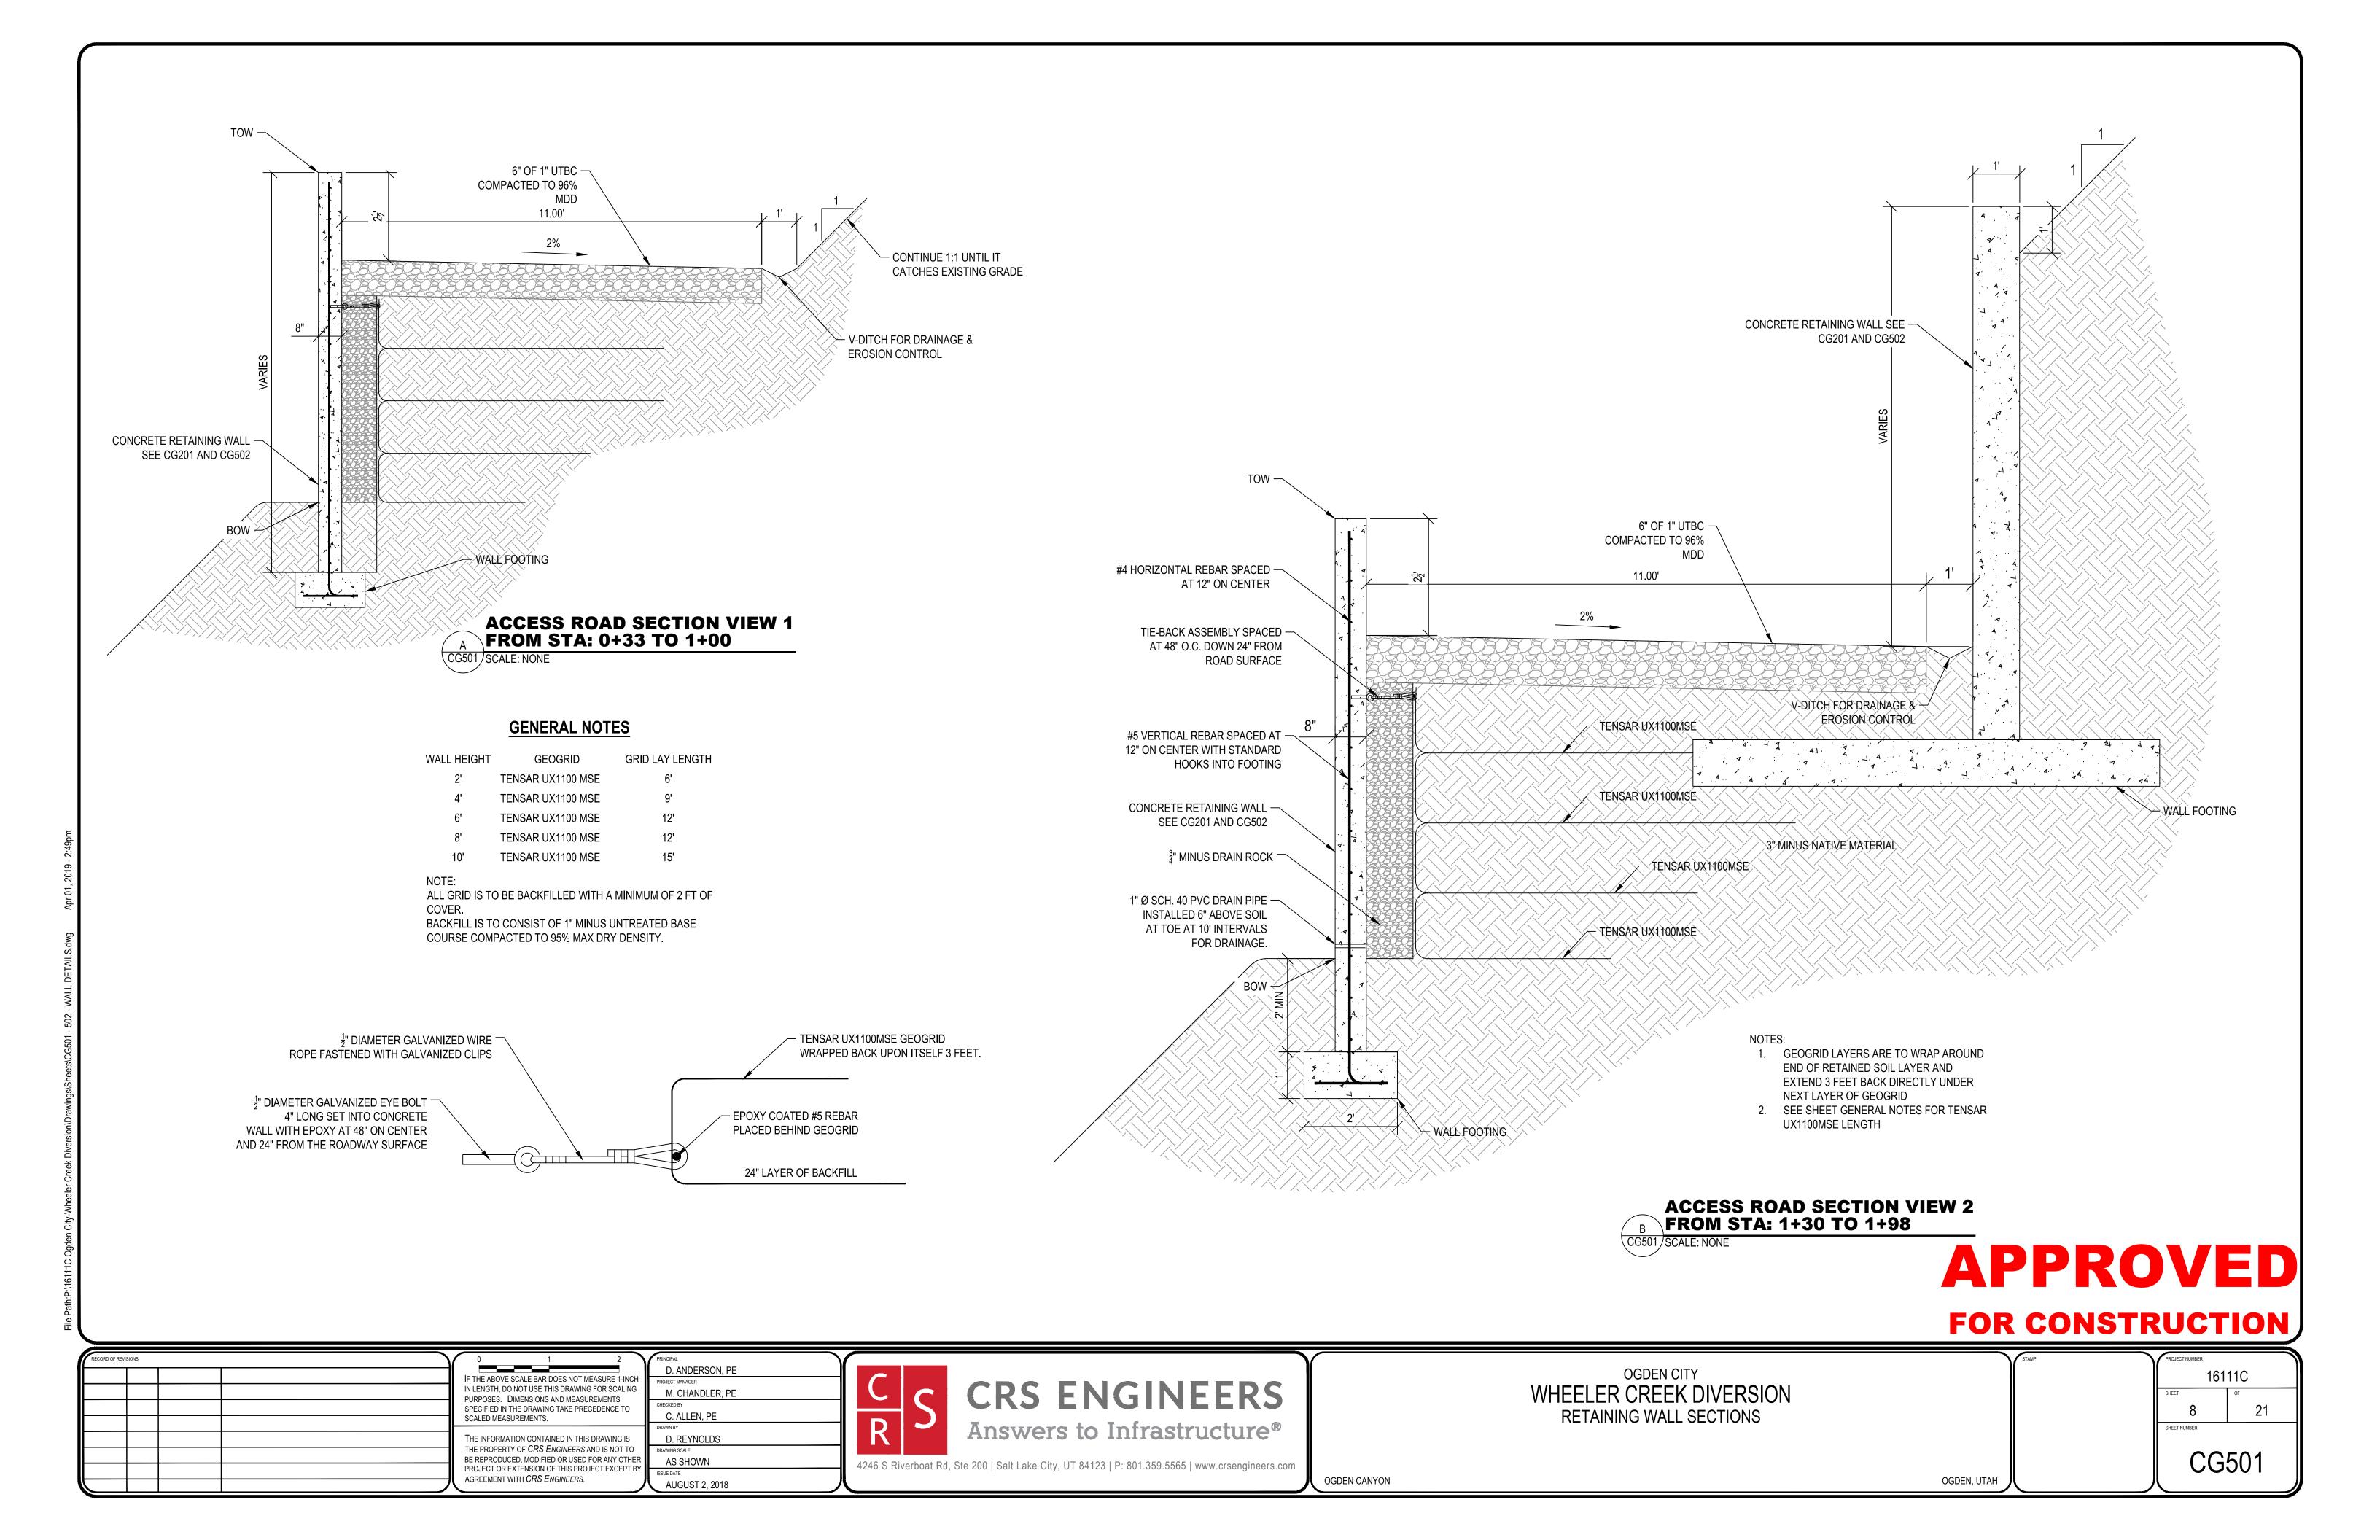

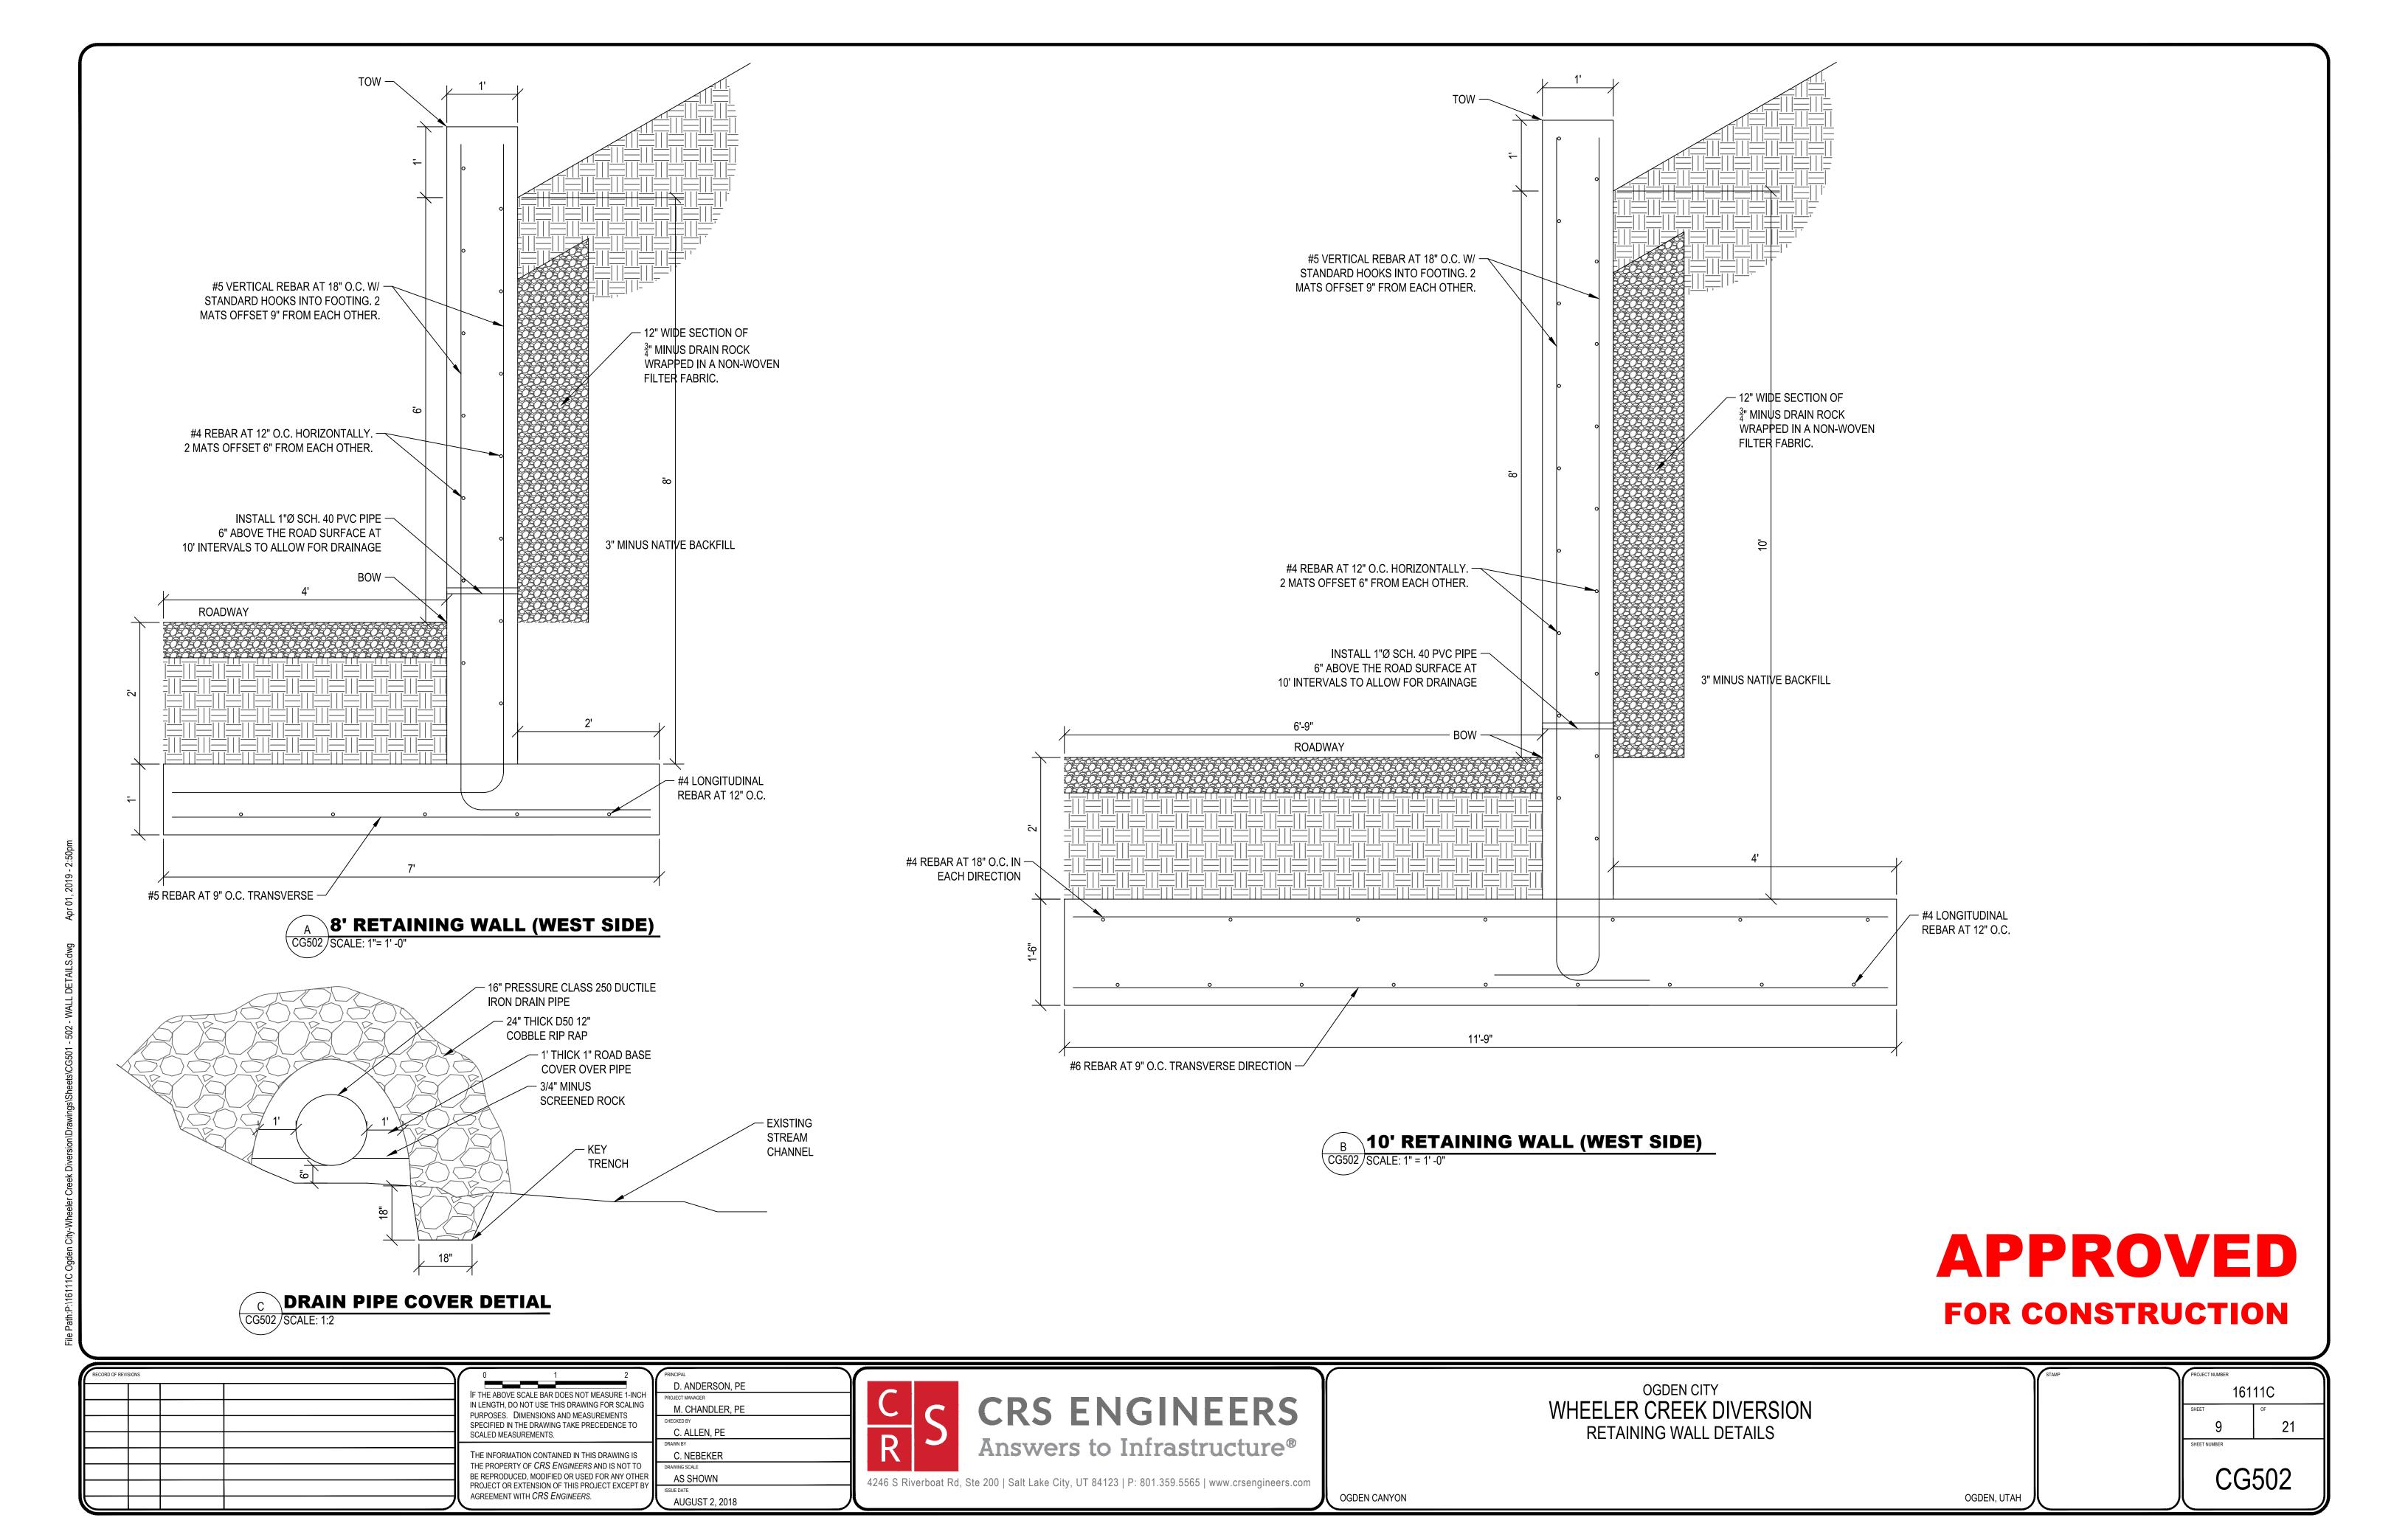

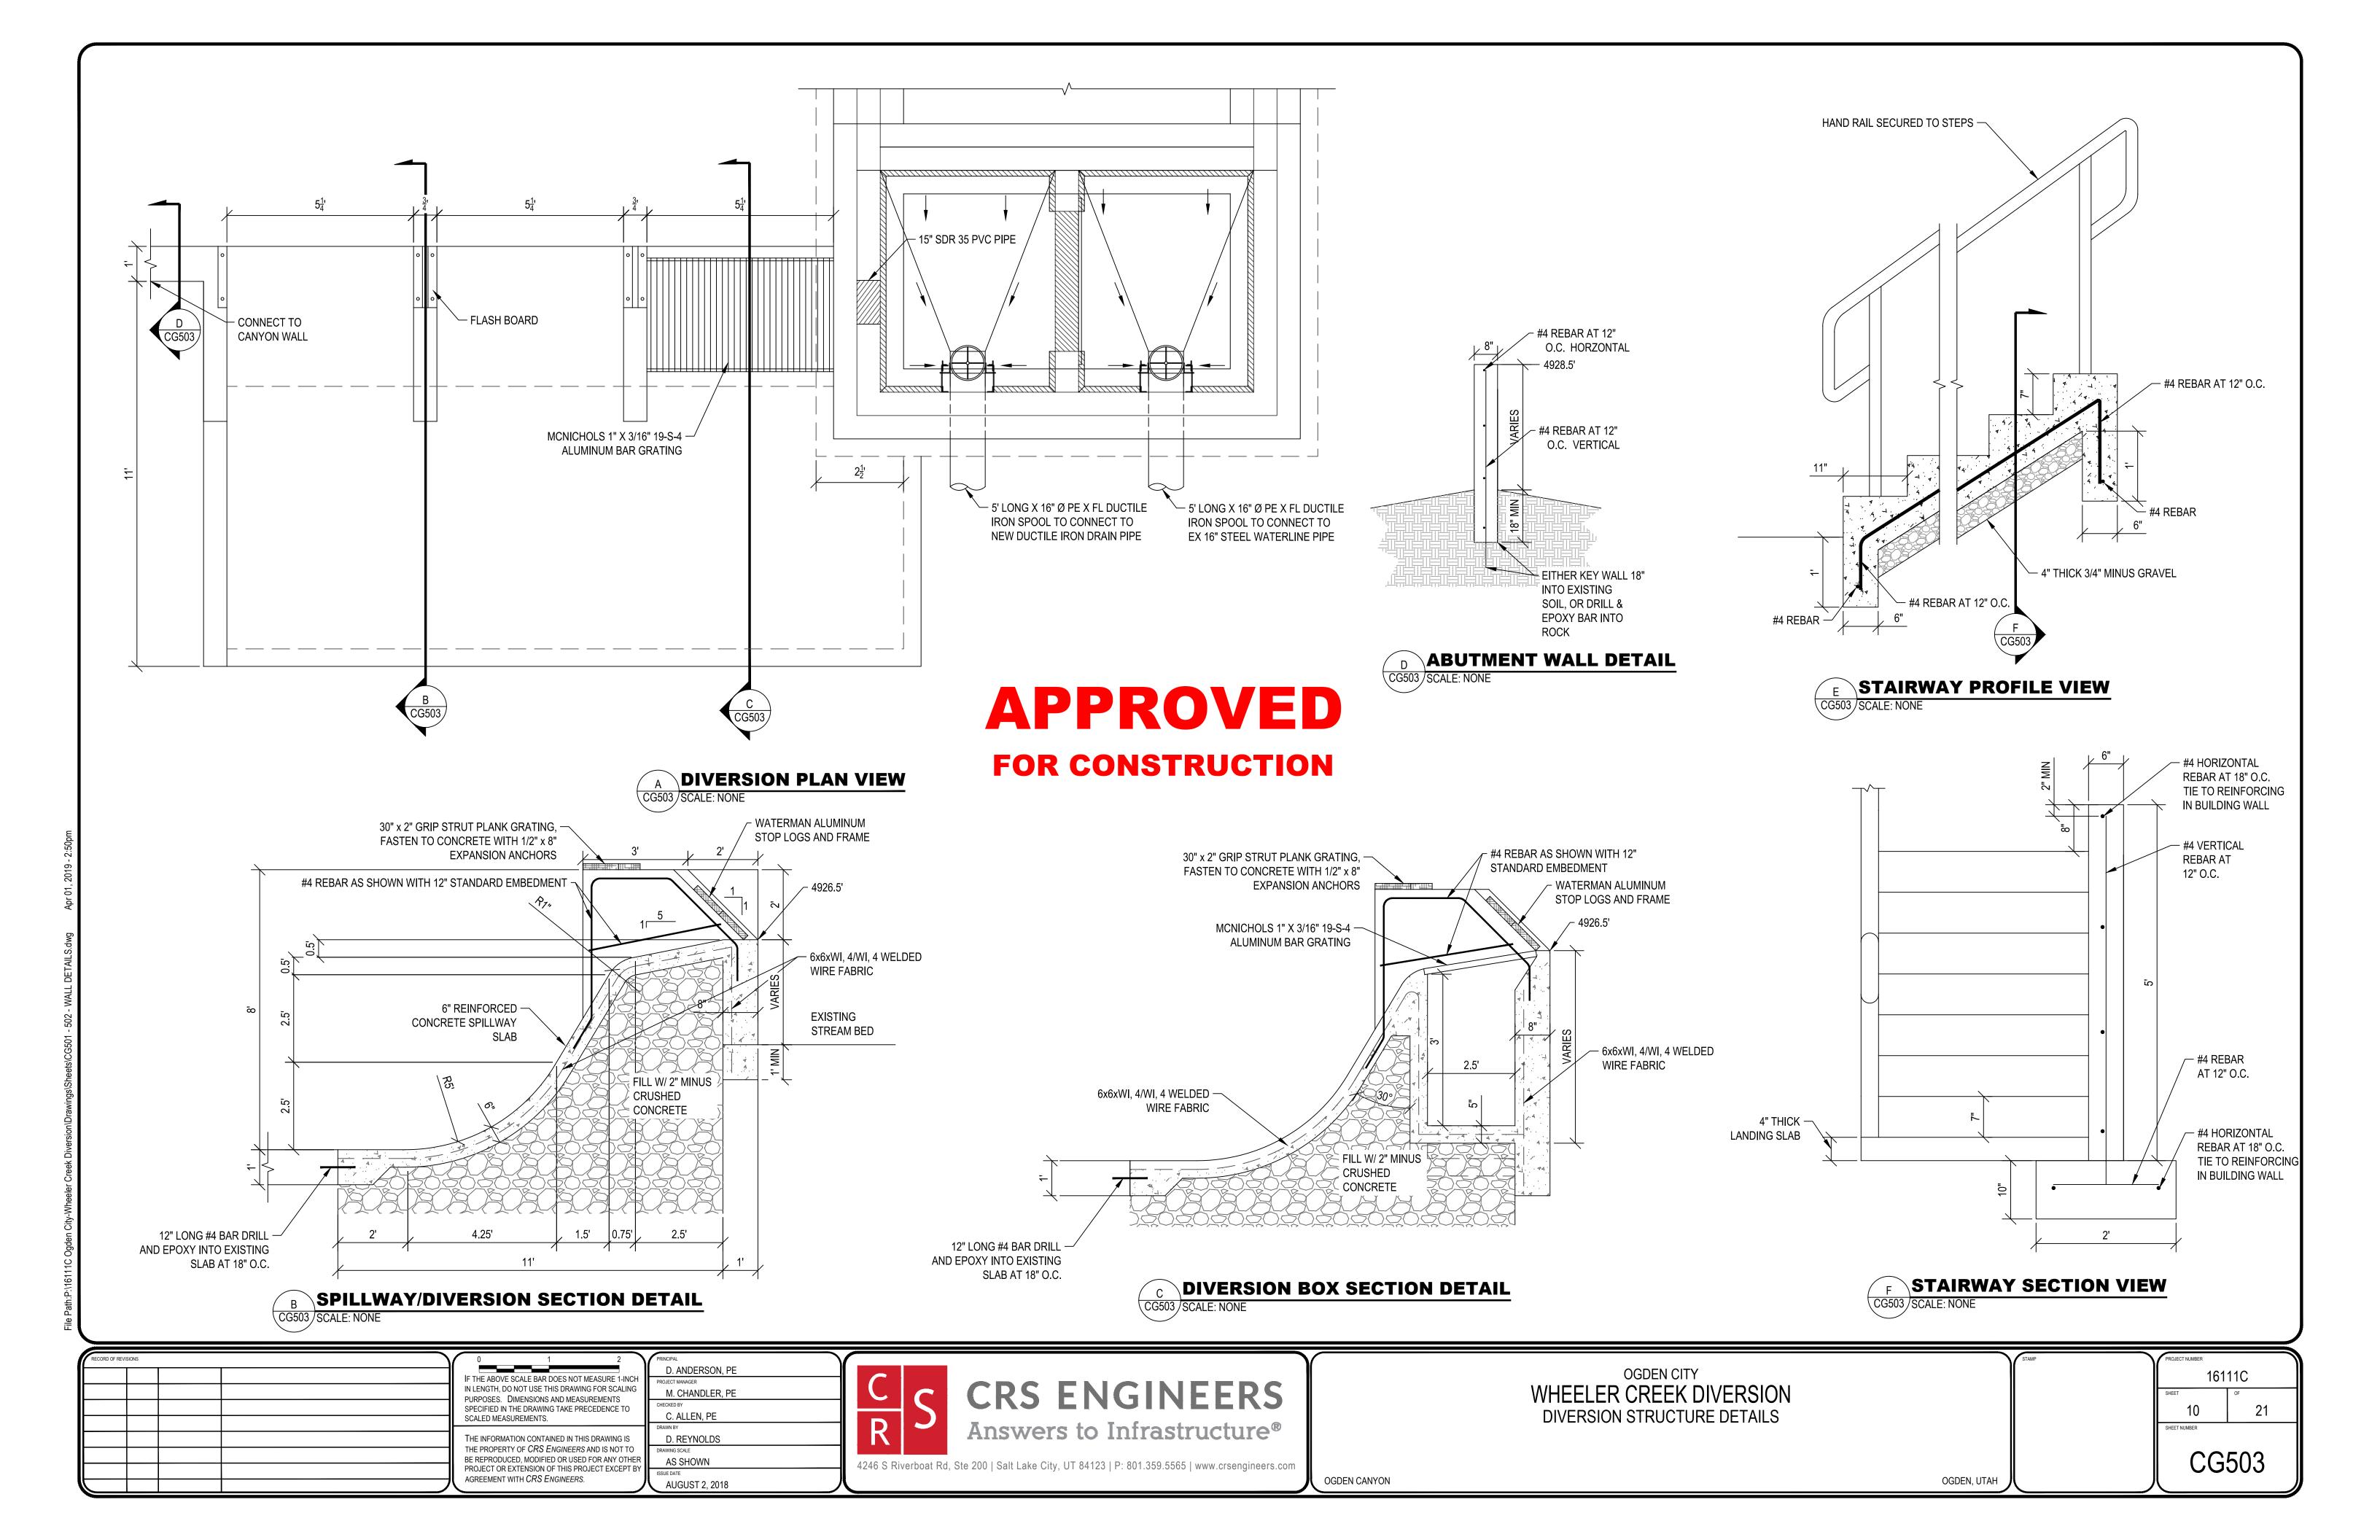

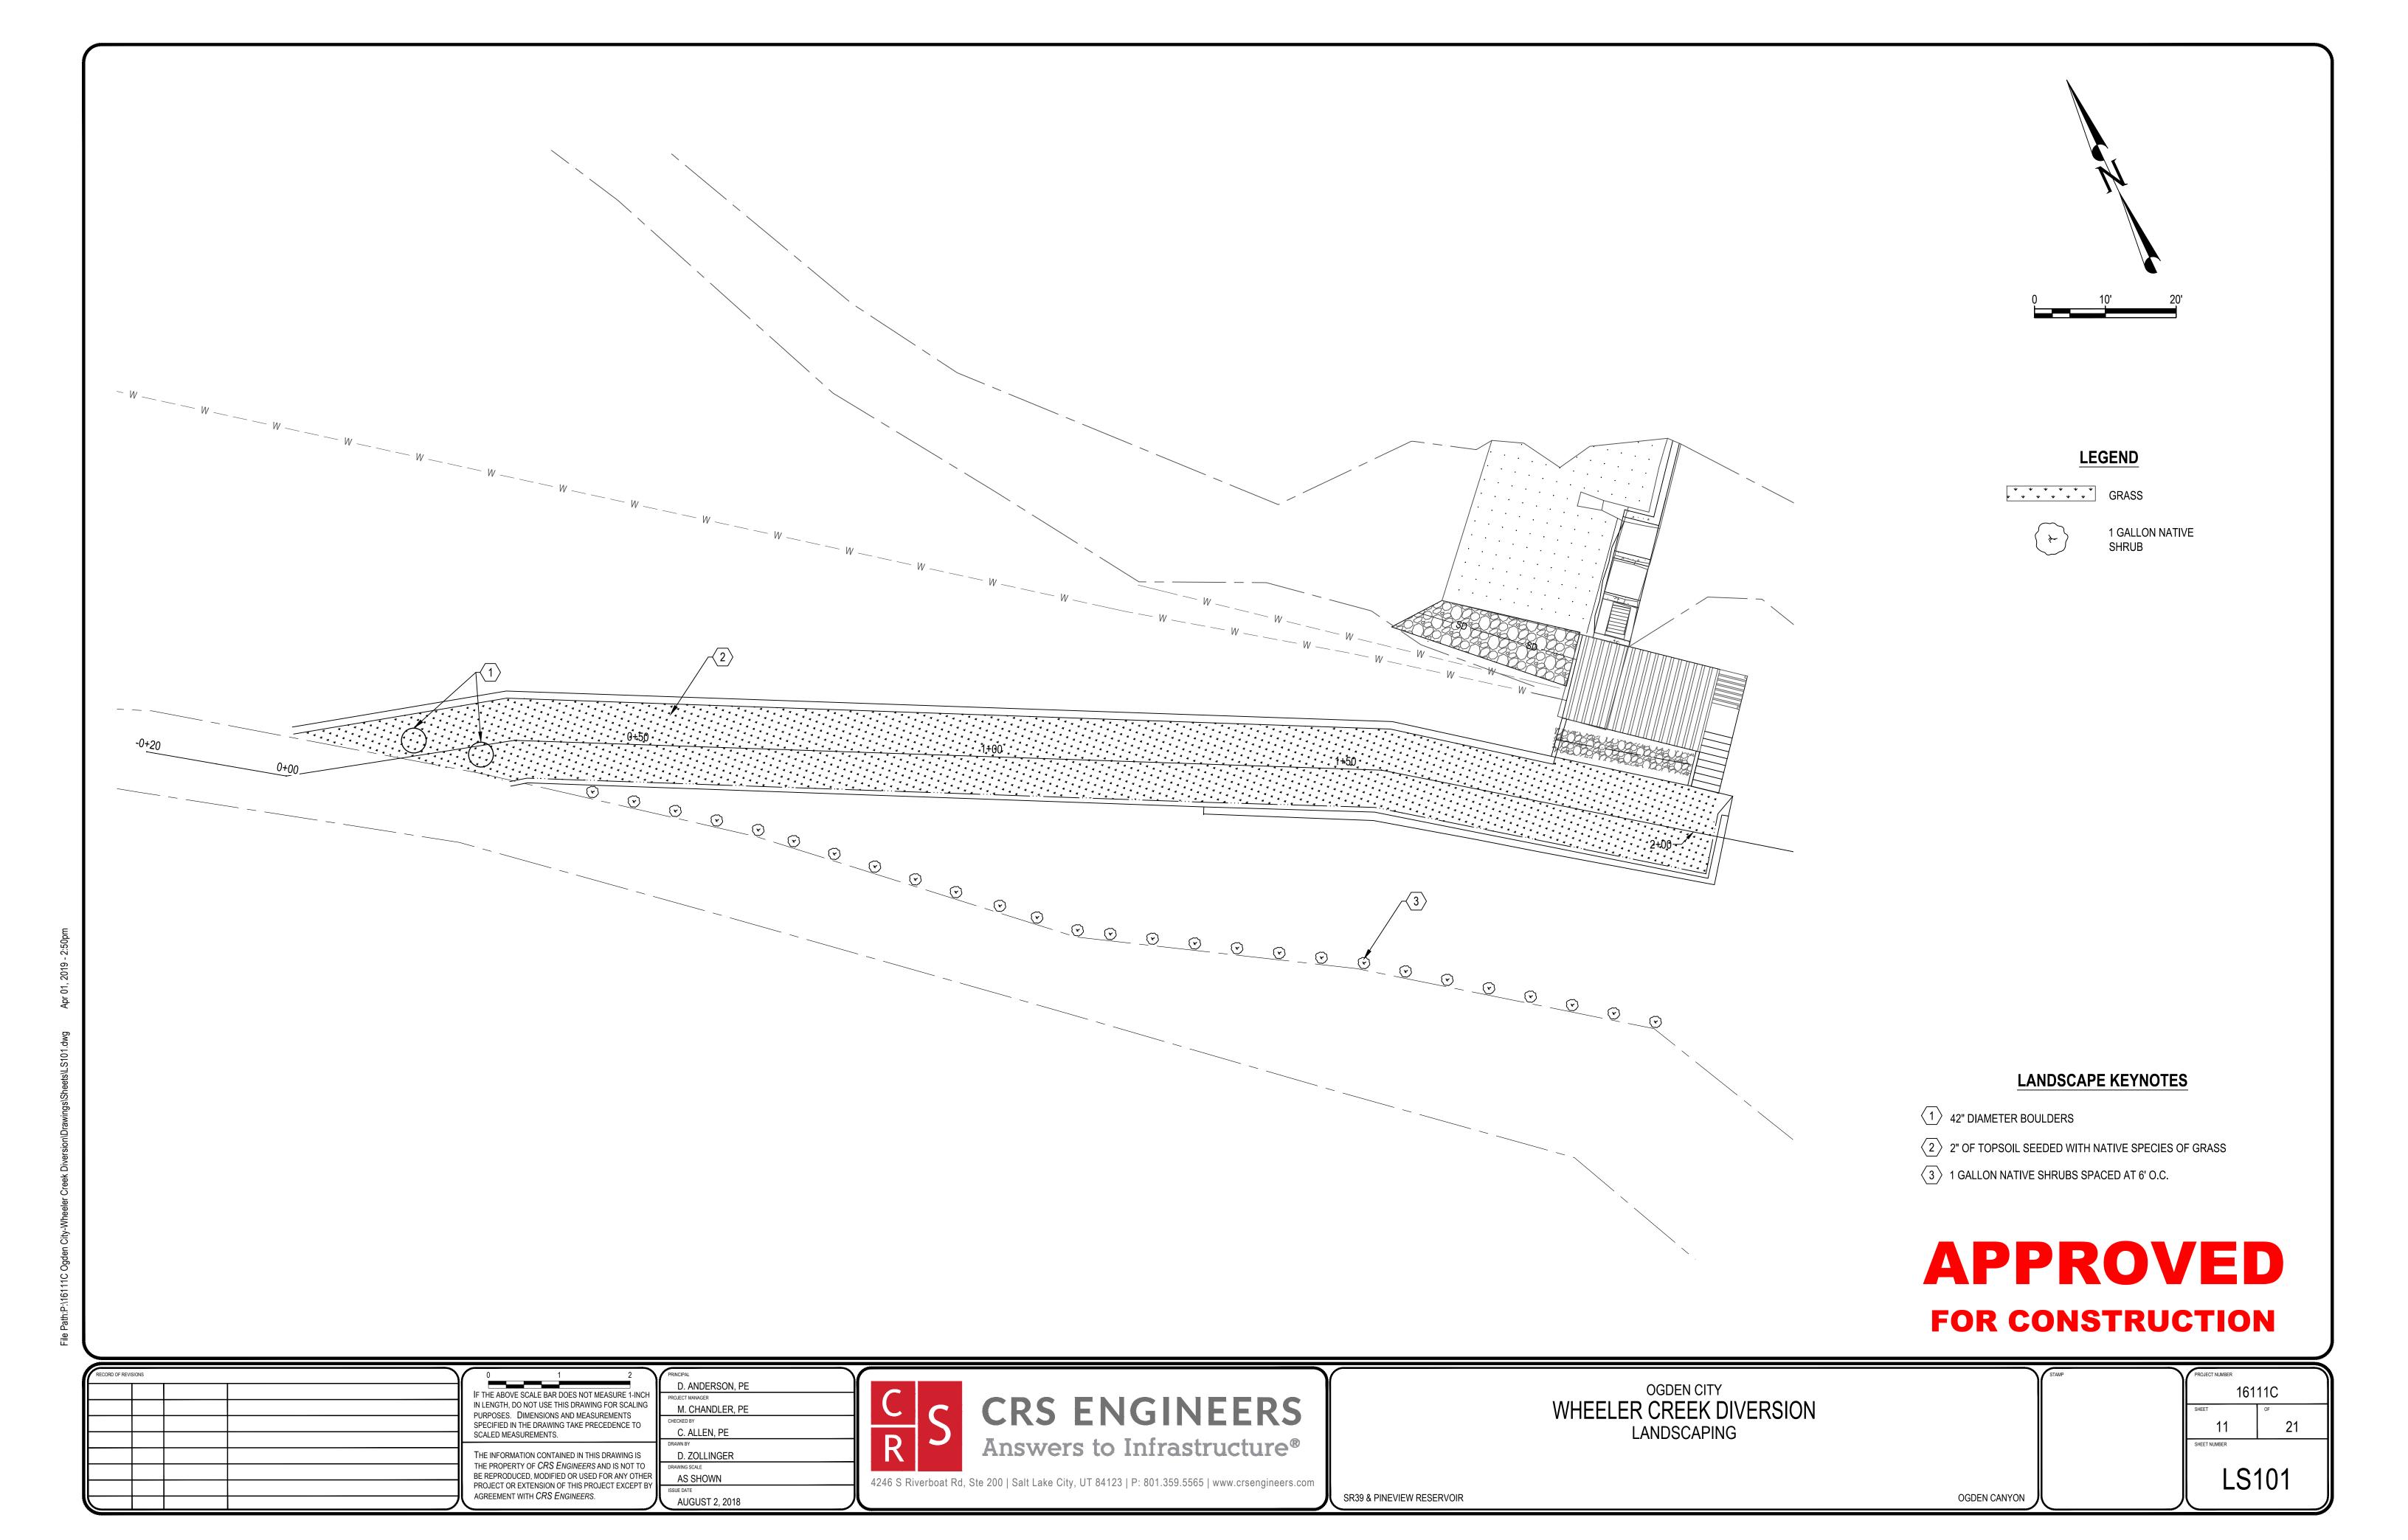

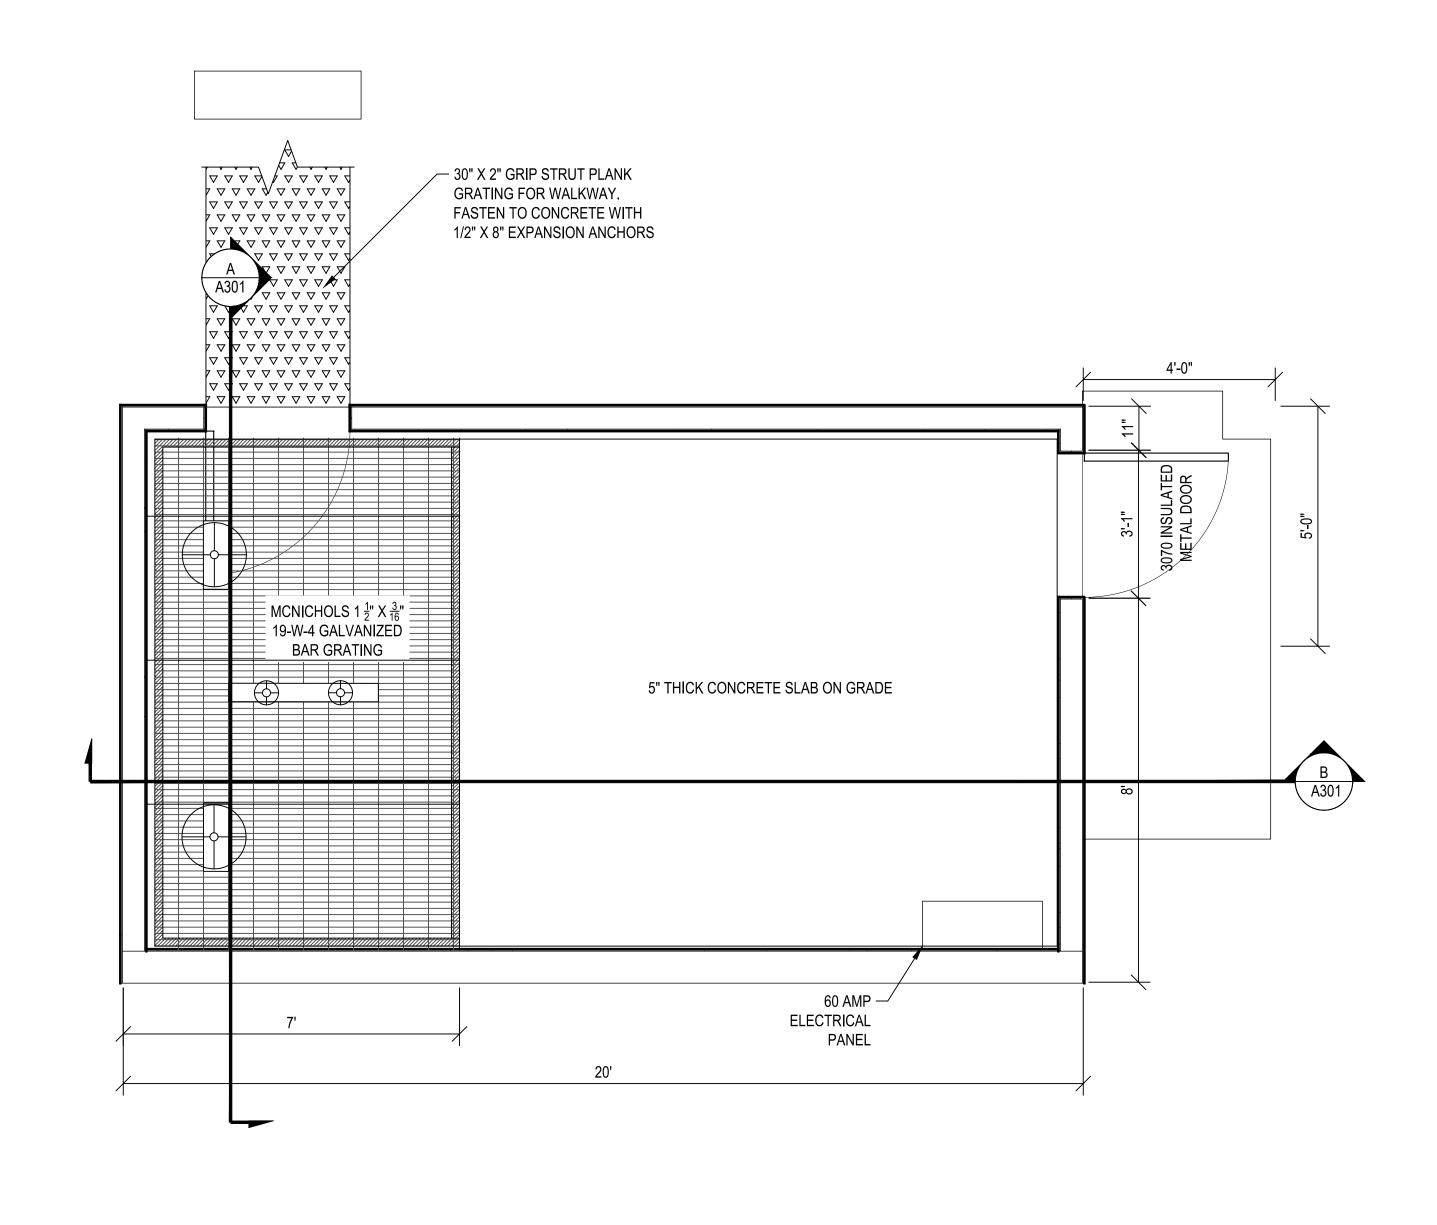

FOR CONSTRUCTION

OGDEN, UTAH

FLOOR PLAN A101 SCALE: 1/2" = 1'-0"

M. HIRST

M. CHANDLER

M. PORTER

K. ACHTER

AS SHOWN

AUGUST 2, 2018

IF THE ABOVE SCALE BAR DOES NOT MEASURE 1-INCH

IN LENGTH, DO NOT USE THIS DRAWING FOR SCALING

PURPOSES. DIMENSIONS AND MEASUREMENTS

SCALED MEASUREMENTS.

SPECIFIED IN THE DRAWING TAKE PRECEDENCE TO

THE INFORMATION CONTAINED IN THIS DRAWING IS

THE PROPERTY OF CRS ENGINEERS AND IS NOT TO


BE REPRODUCED, MODIFIED OR USED FOR ANY OTHER


PROJECT OR EXTENSION OF THIS PROJECT EXCEPT BY AGREEMENT WITH CRS ENGINEERS.

	CRS ENGINEERS
R	Answers to Infrastructure®

OGDEN CITY WHEELER CREEK DIVERSION FLOOR PLAN

16111C 12 A101

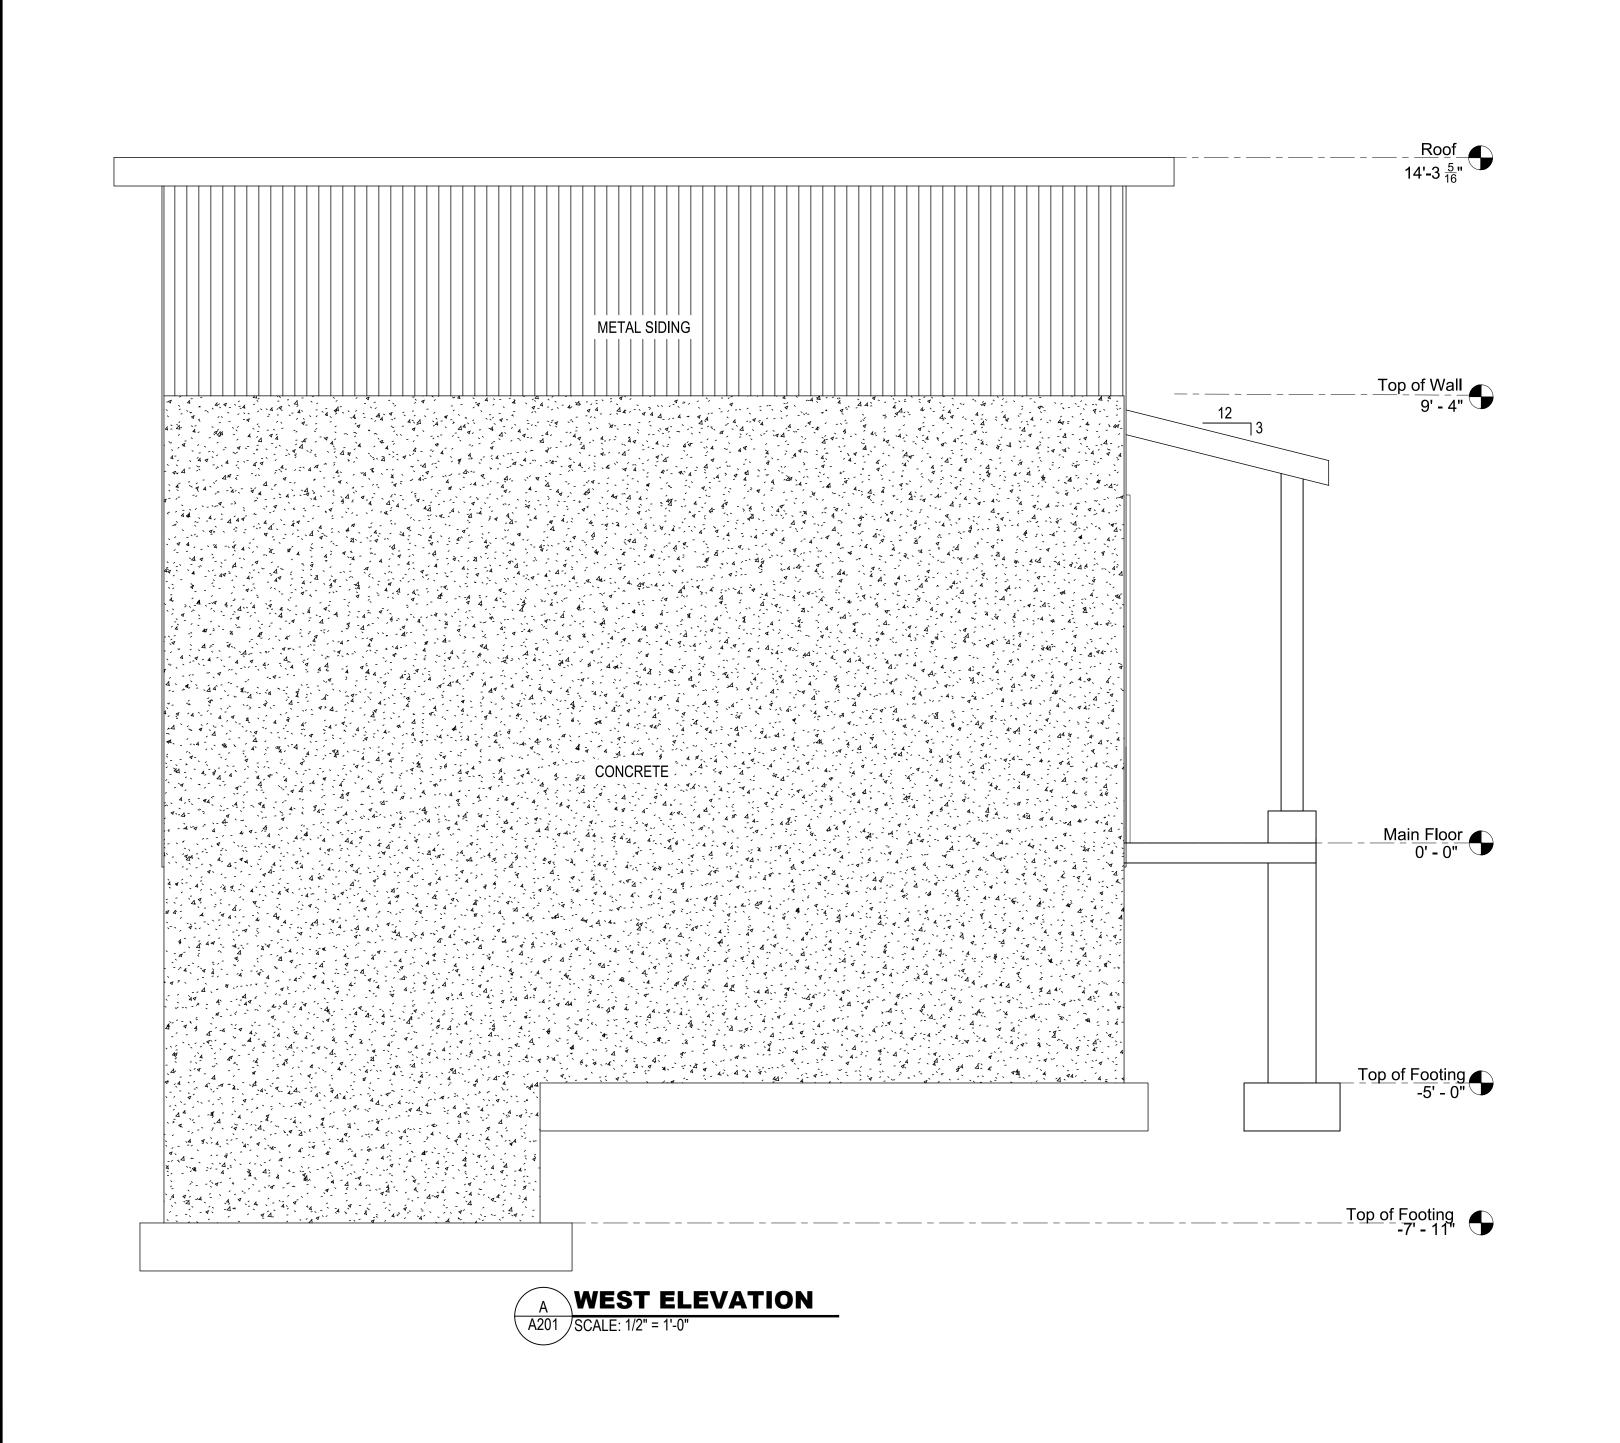

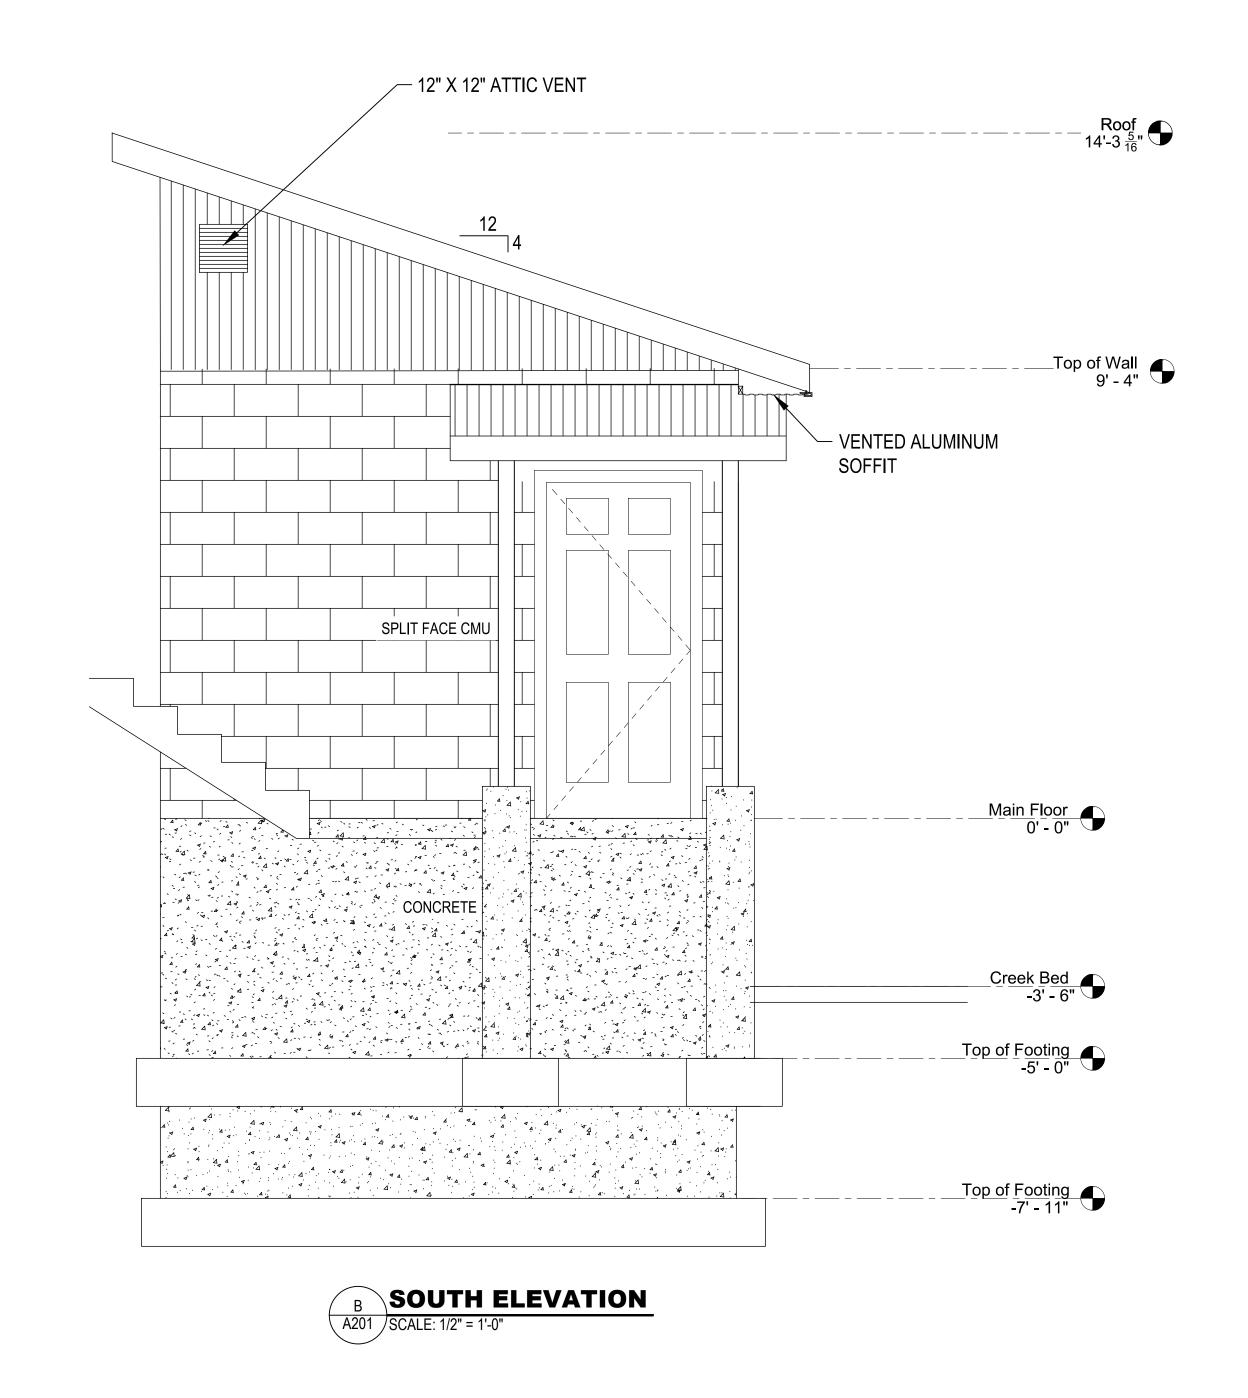

FOR CONSTRUCTION

OGDEN, UTAH




16111C


SHEET OF

13 21


SHEET NUMBER


A202

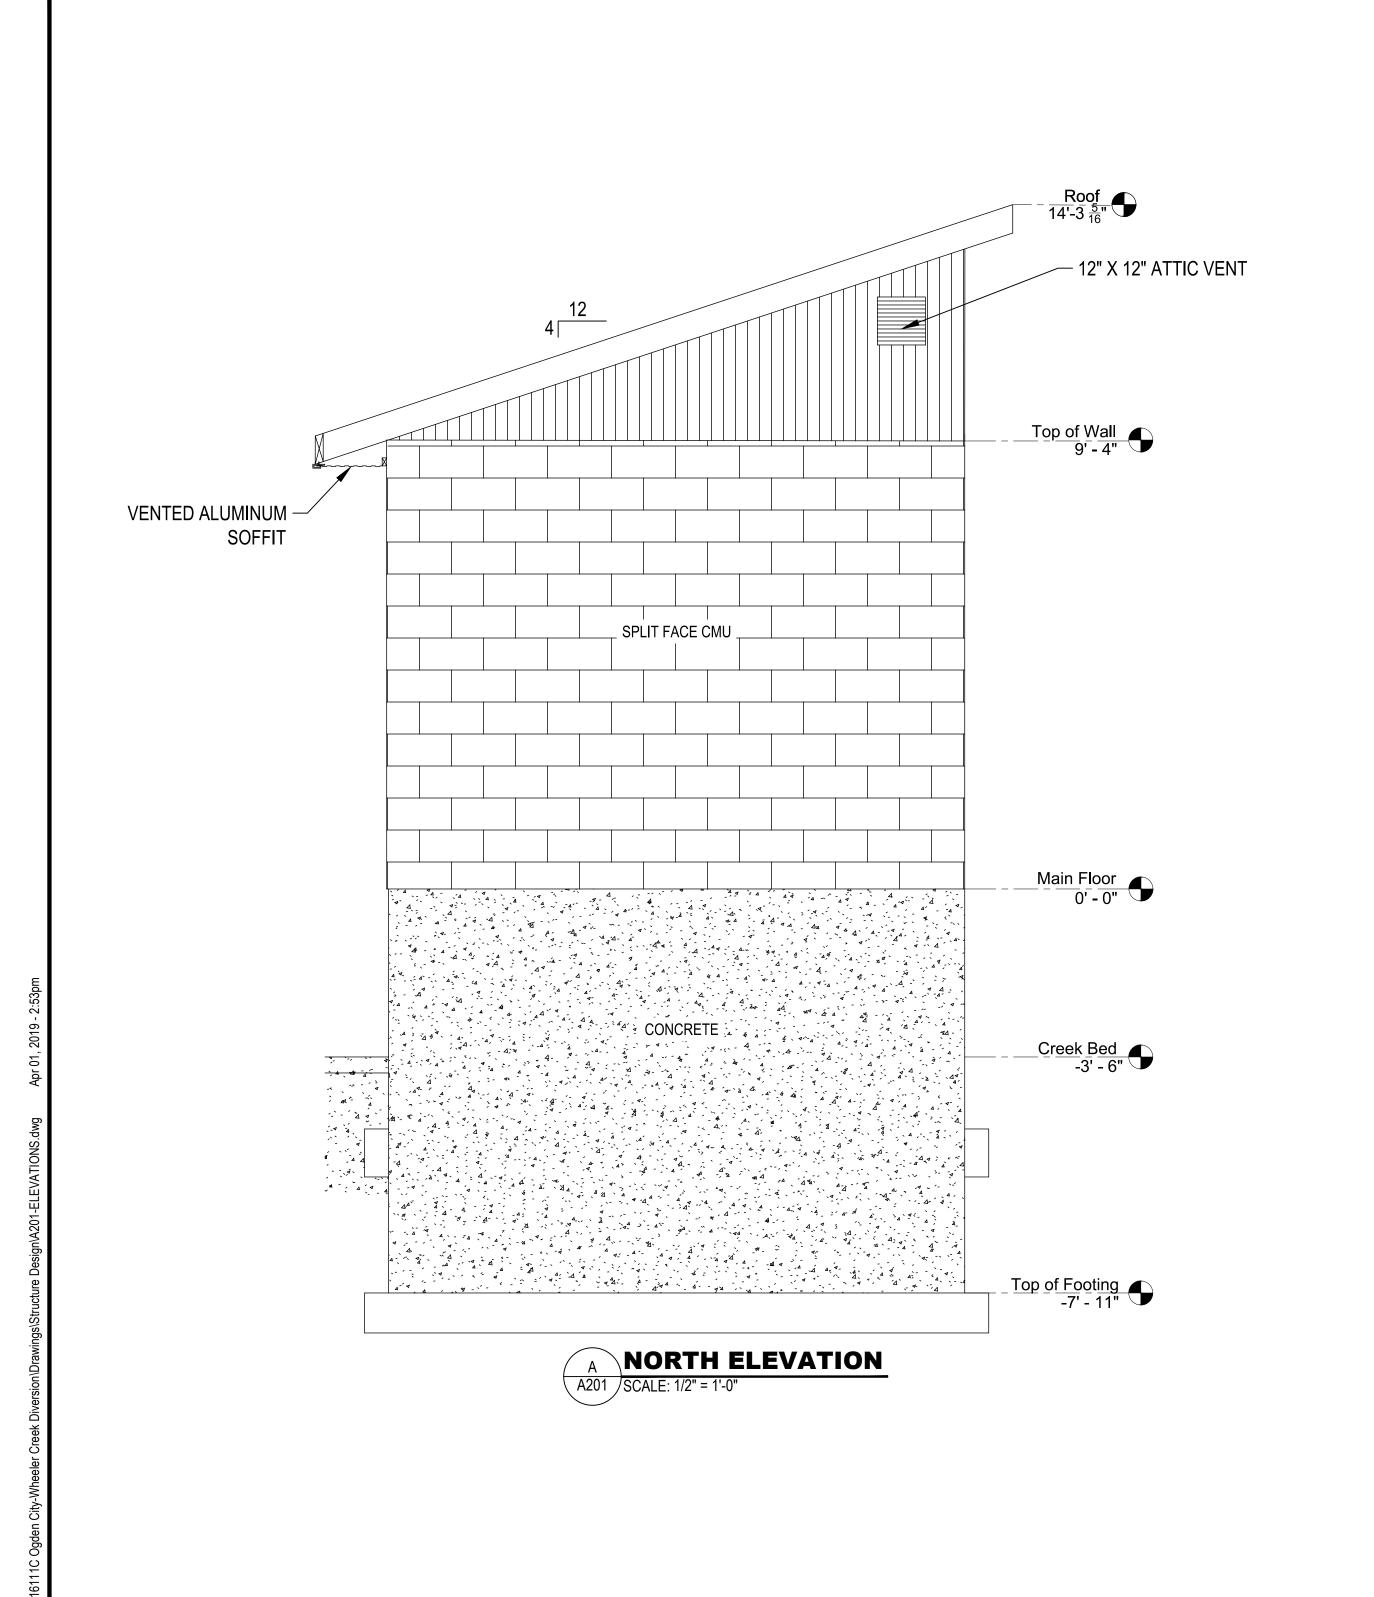

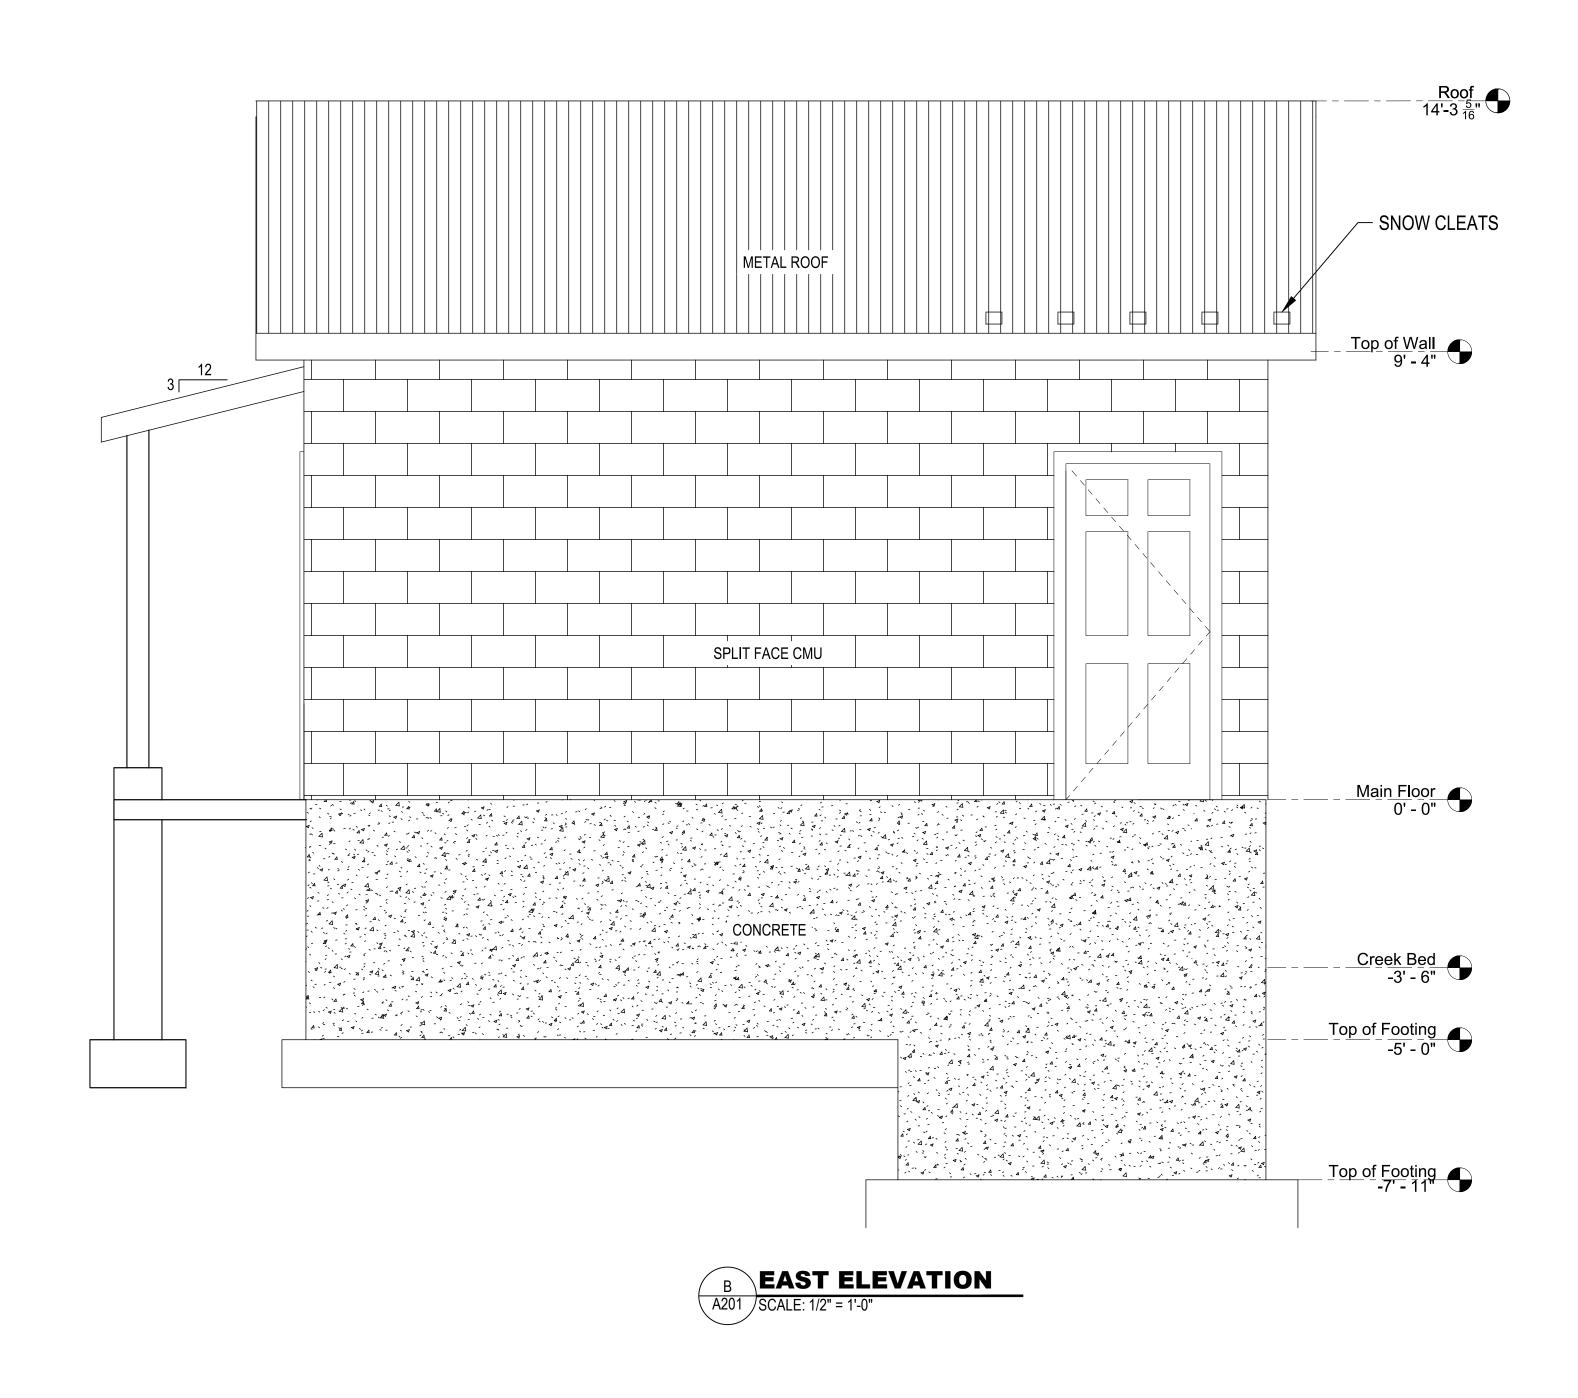

FOR CONSTRUCTION

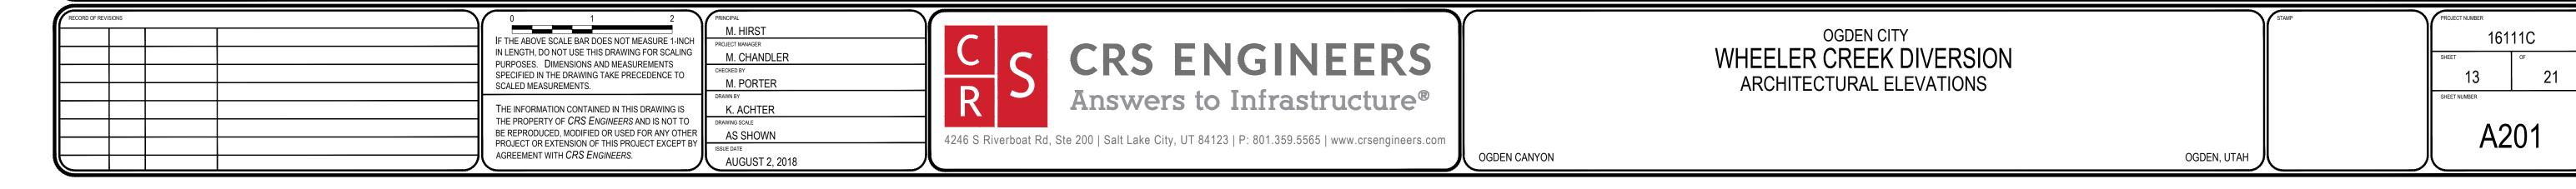

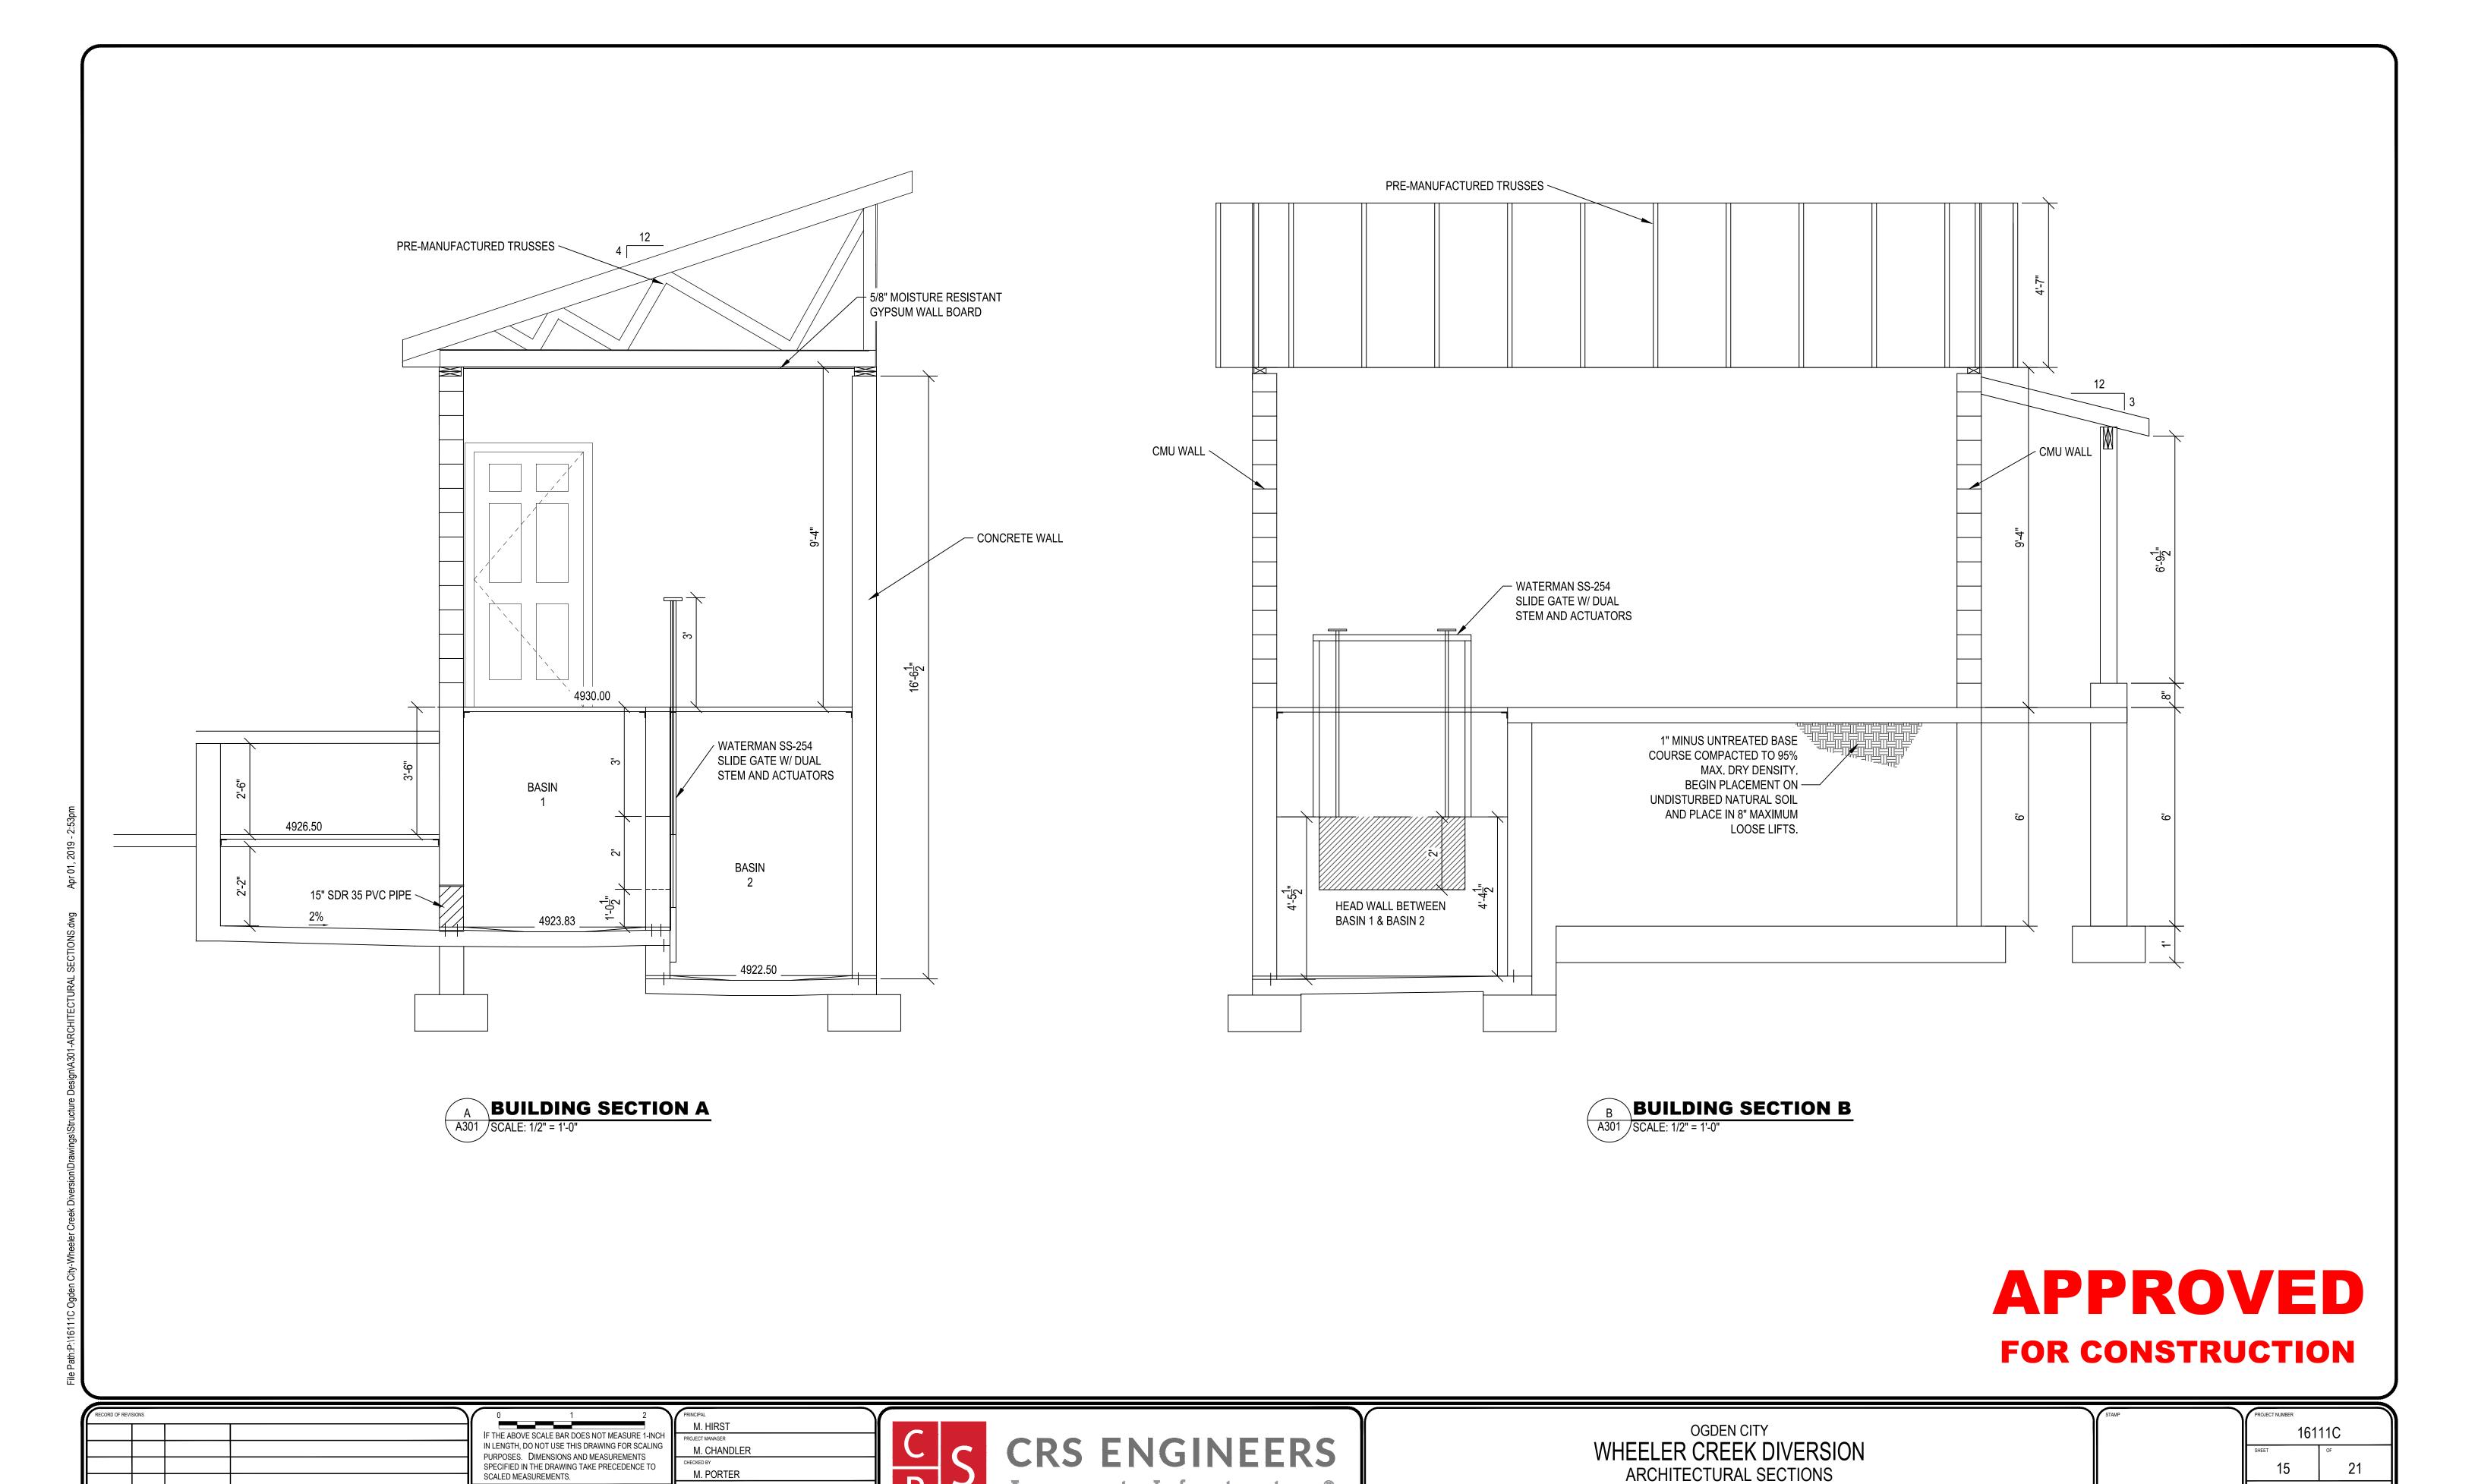

Answers to Infrastructure®

OGDEN CANYON

4246 S Riverboat Rd, Ste 200 | Salt Lake City, UT 84123 | P: 801.359.5565 | www.crsengineers.com

A301

OGDEN, UTAH


THE INFORMATION CONTAINED IN THIS DRAWING IS THE PROPERTY OF *CRS ENGINEERS* AND IS NOT TO


BE REPRODUCED, MODIFIED OR USED FOR ANY OTHER PROJECT OR EXTENSION OF THIS PROJECT EXCEPT BY AGREEMENT WITH CRS ENGINEERS.


K. ACHTER

AS SHOWN


AUGUST 2, 2018

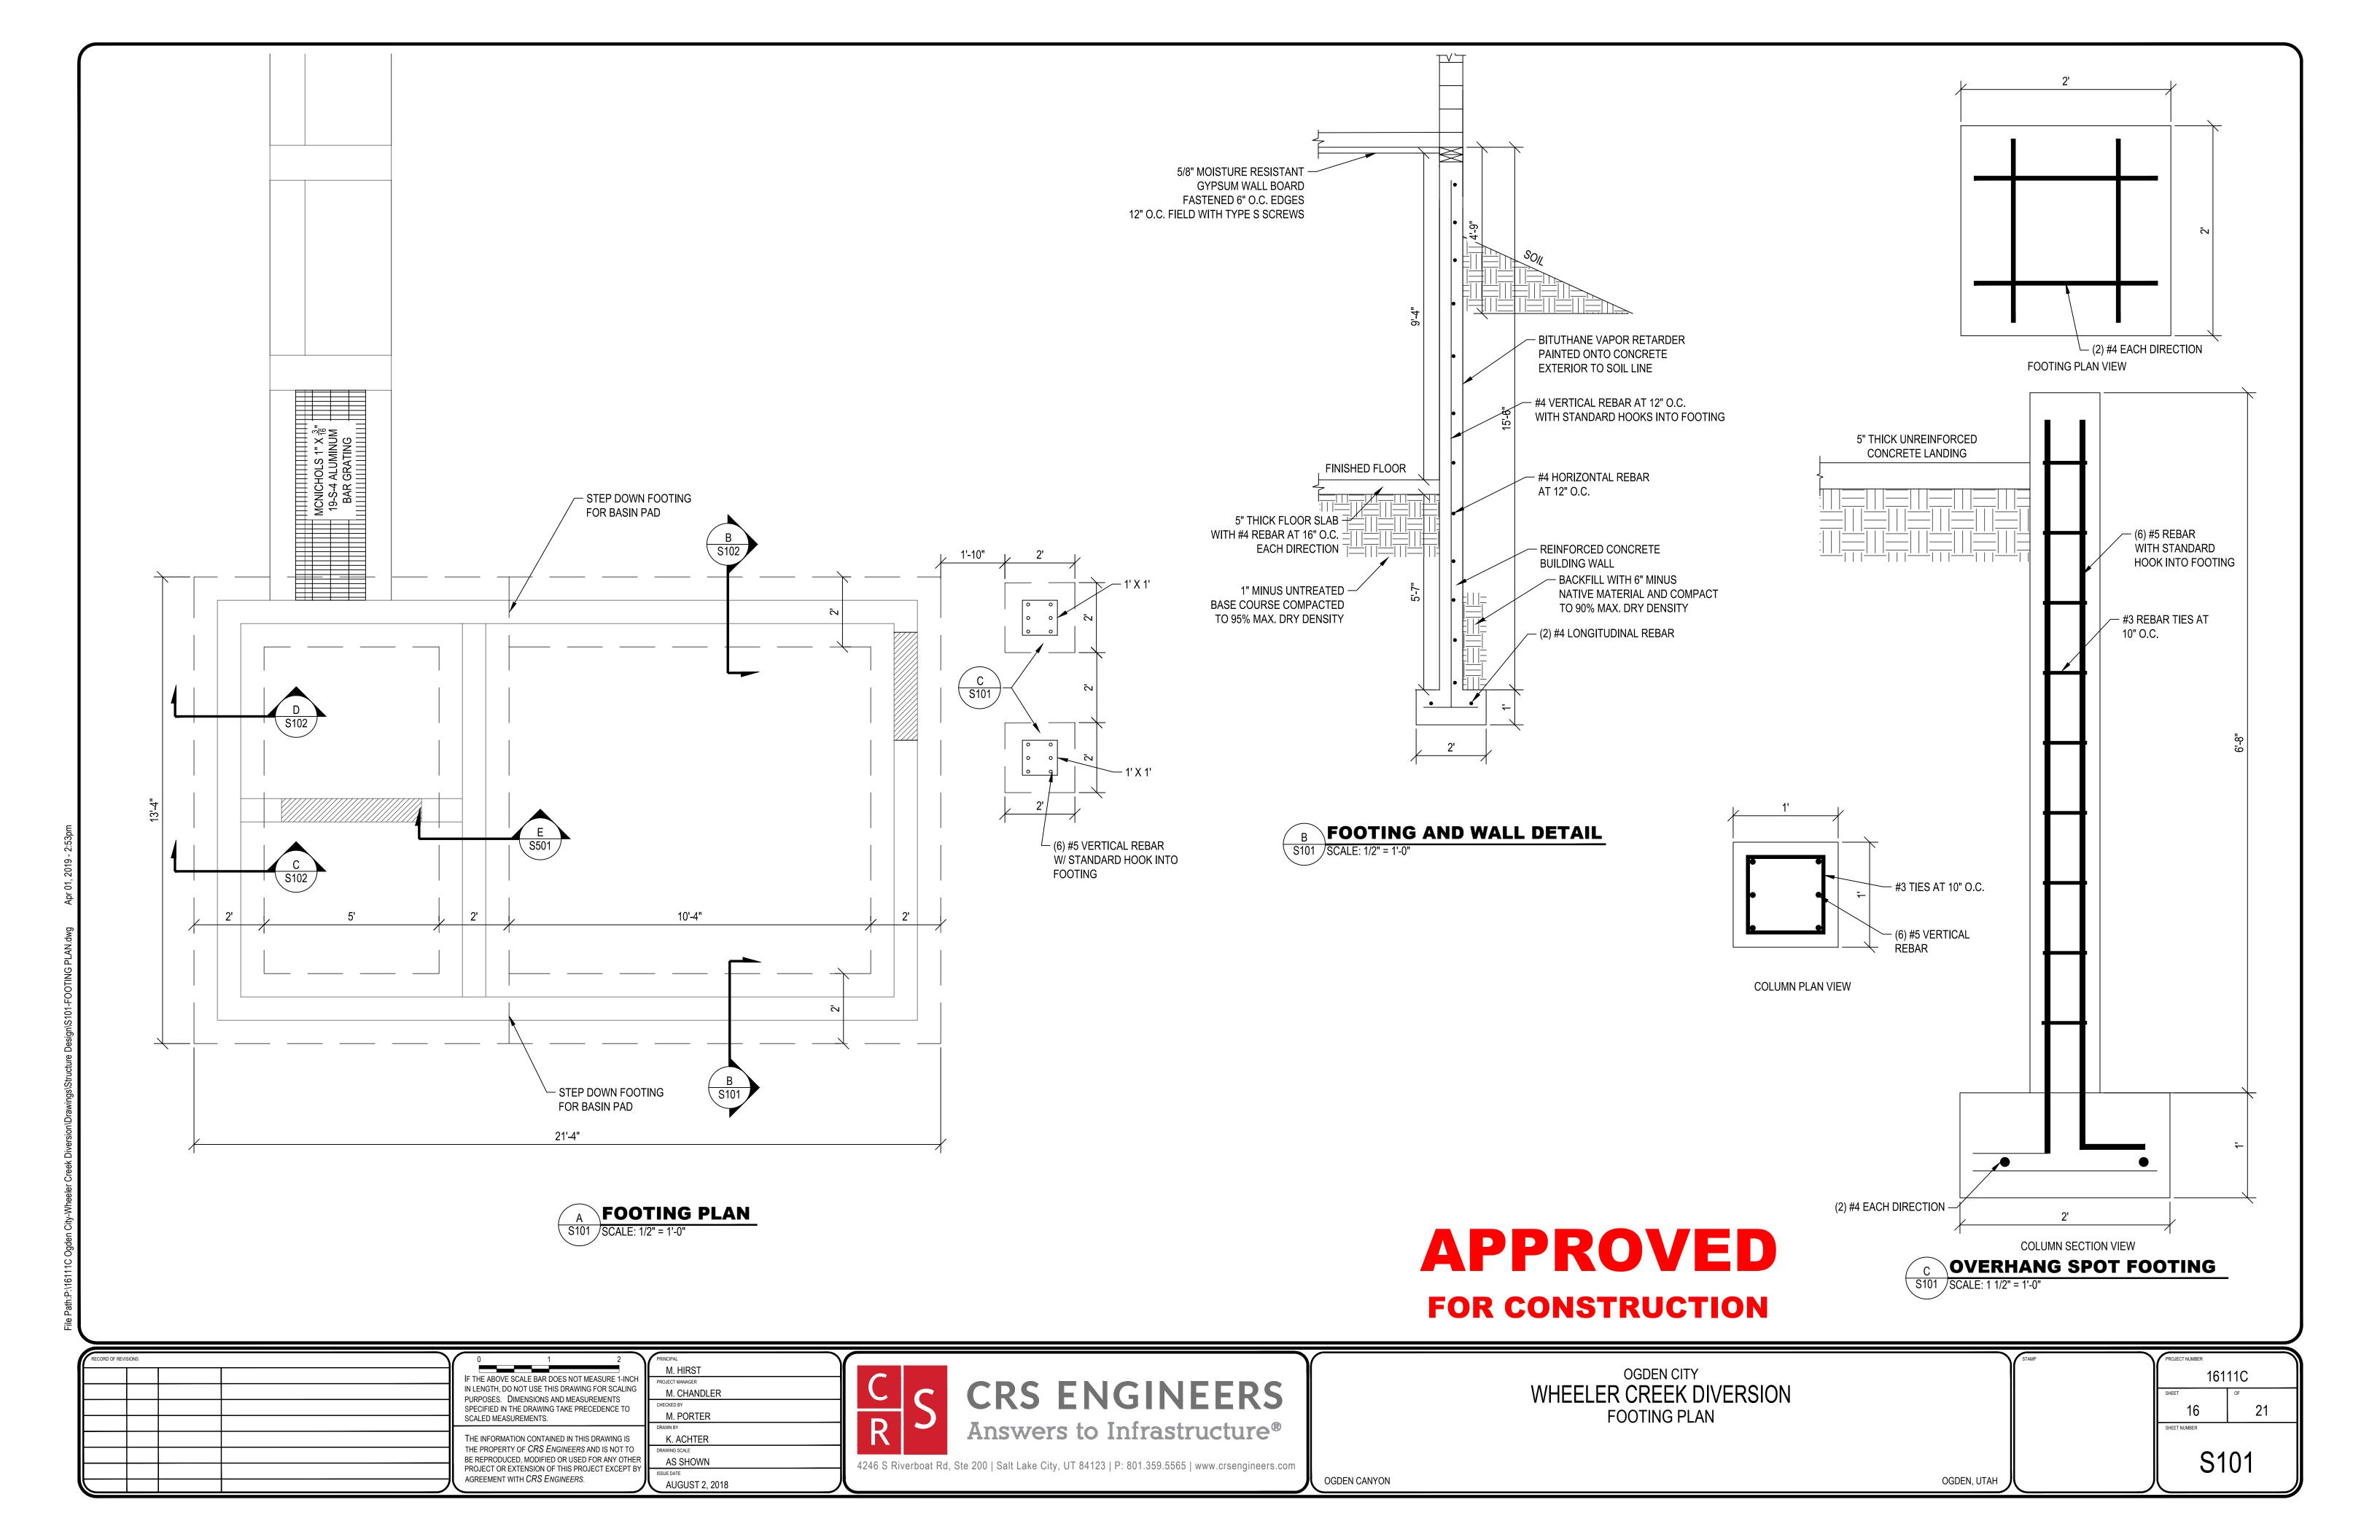

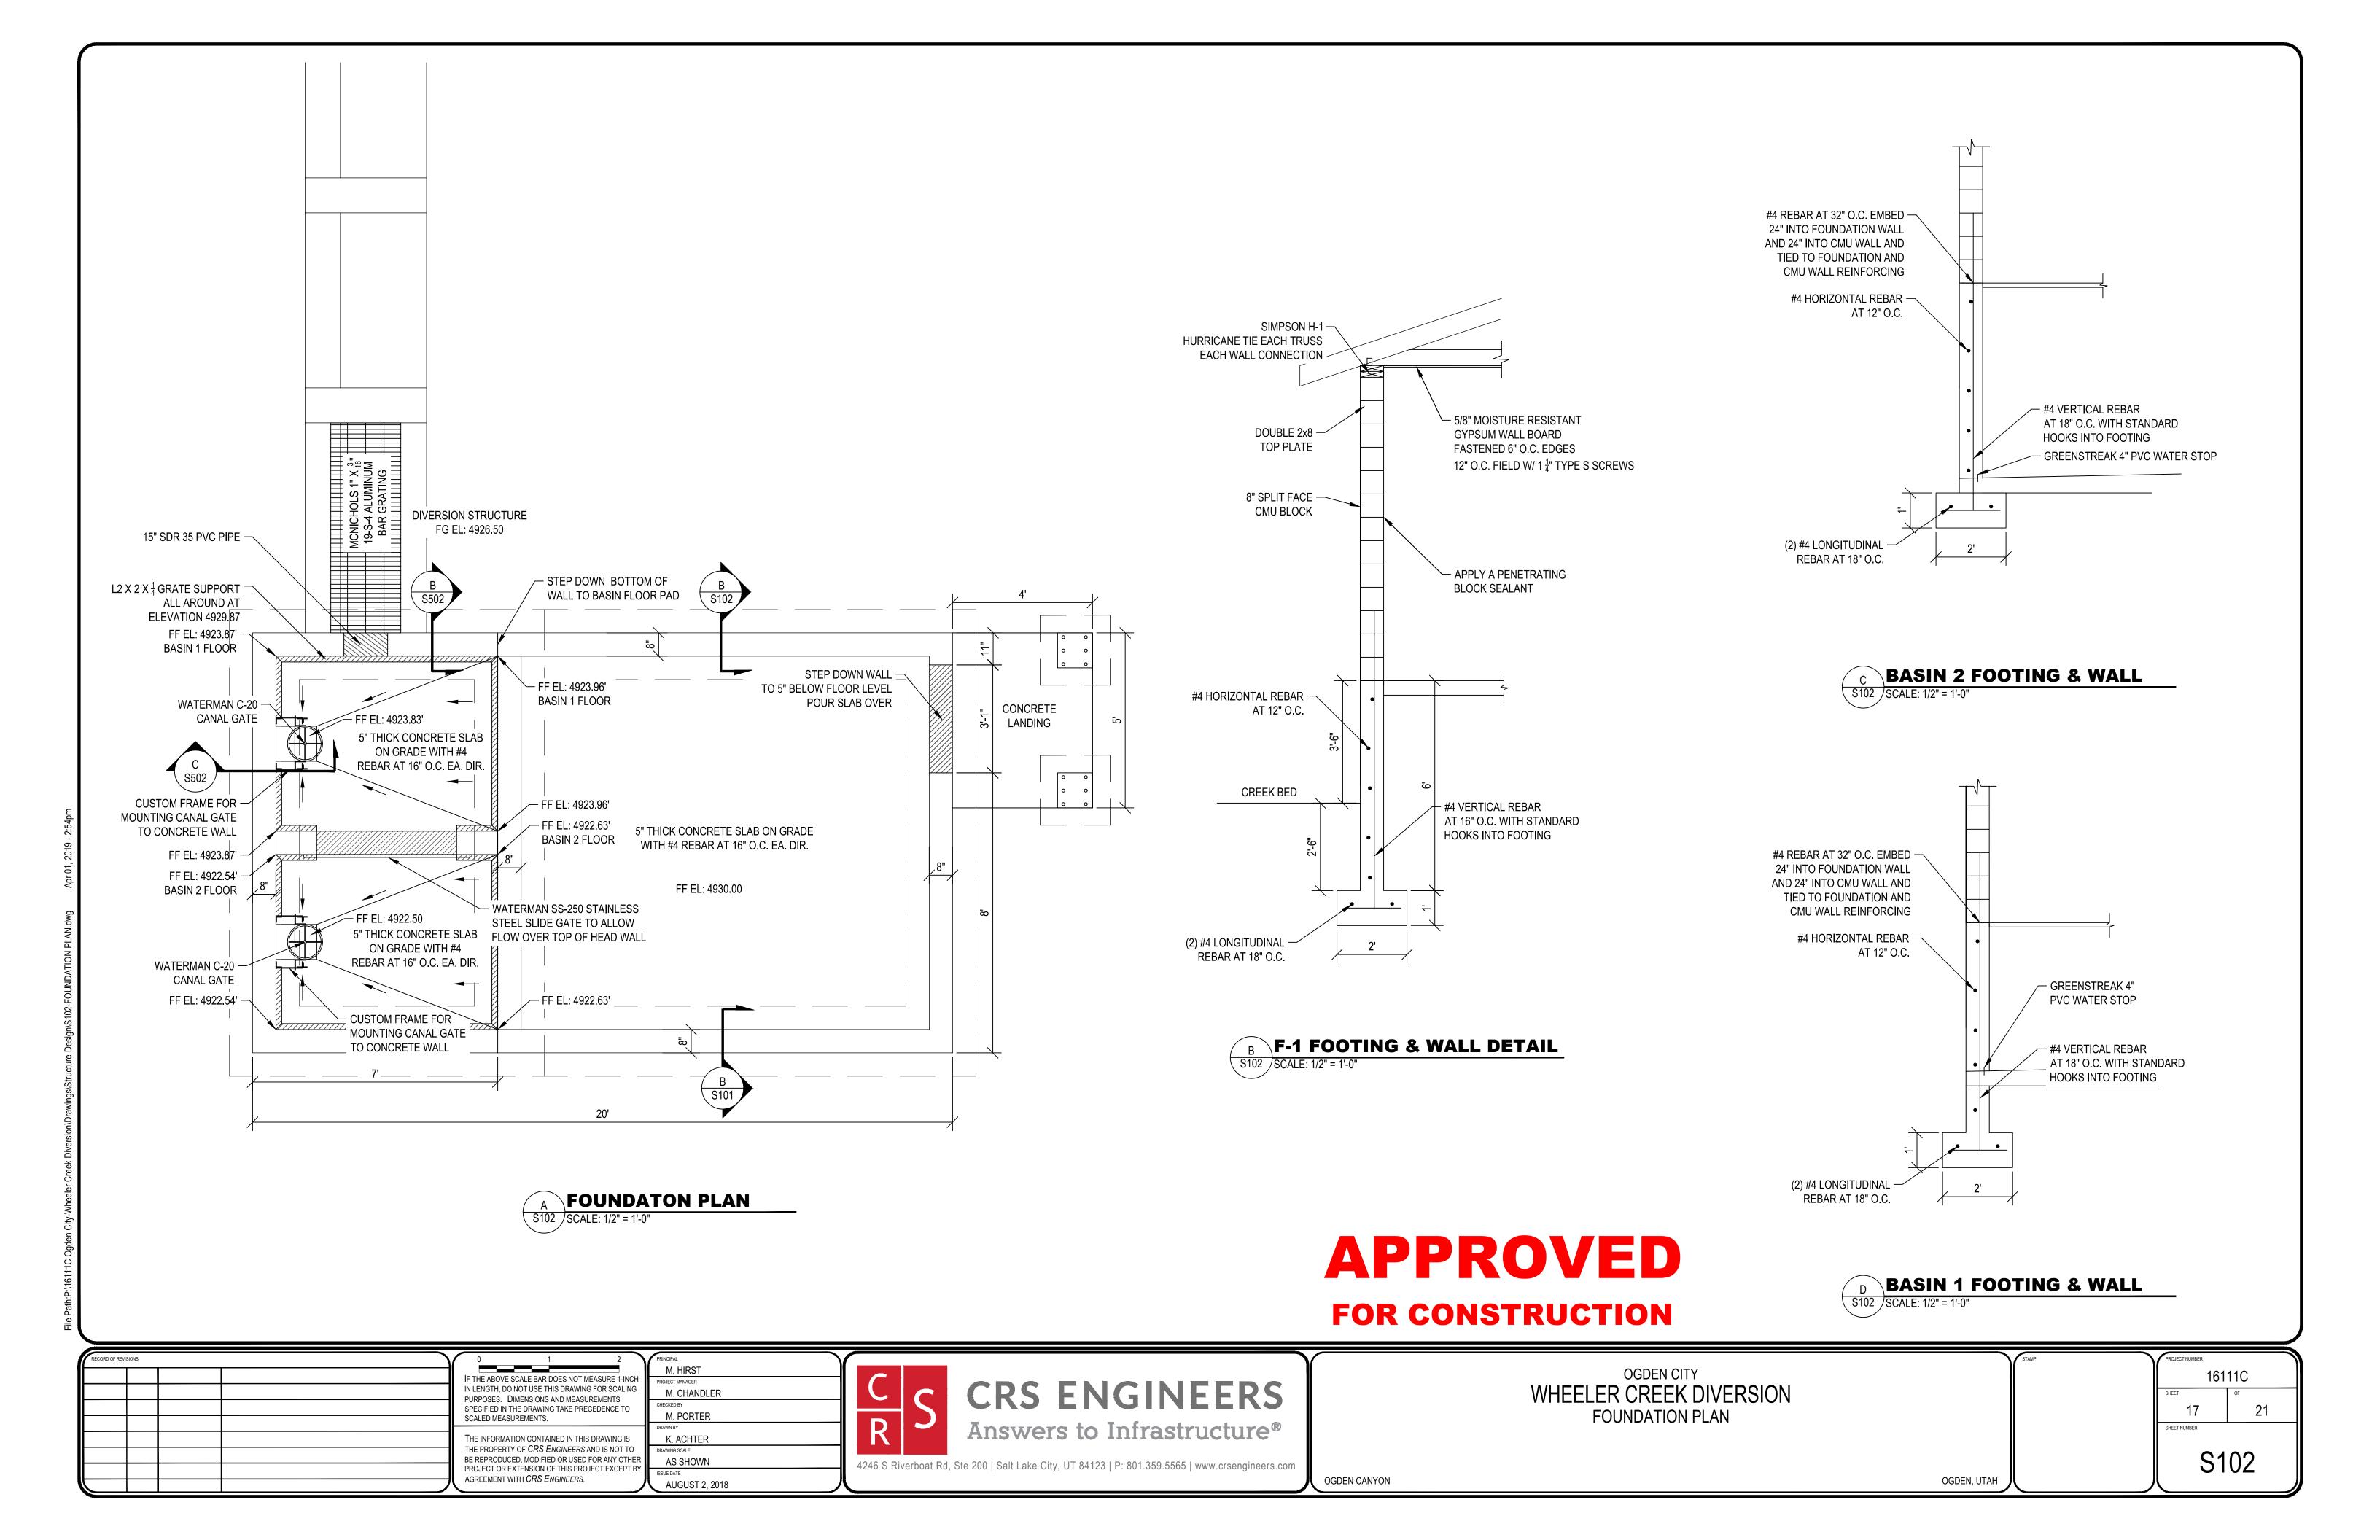

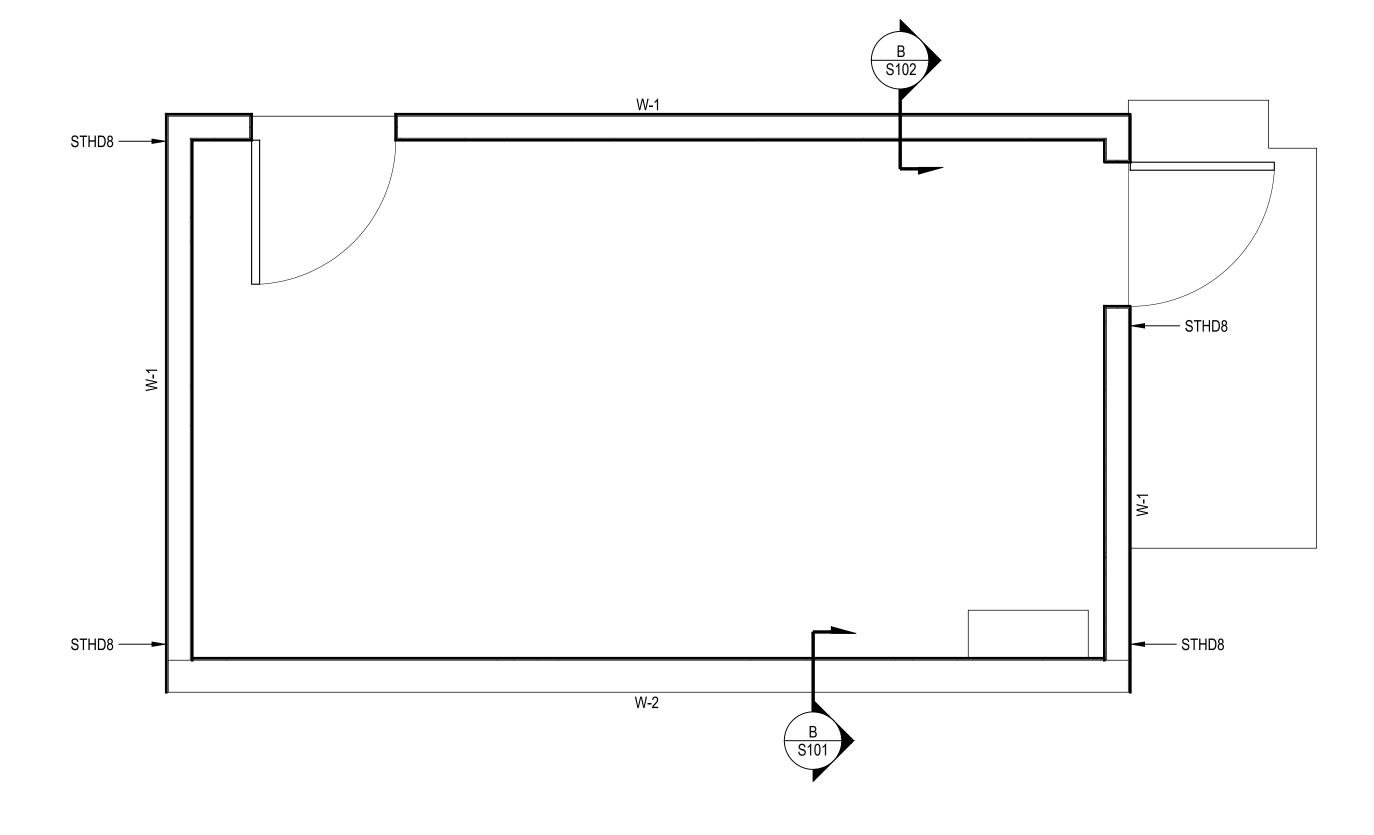

BRACED WALL SCHEDULE				
W-1	REINFORCED CMU WALL WITH #4 VERTICAL REBAR AT 32" O.C. AND #4 HORIZONTAL REBAR AT 48" O.C GROUT ALL CELLS CONTAINING REINFORCEMENT			
W-2	REINFORCED CONCRETE WALL WITH #5 VERTICAL REBAR AT 12" O.C. AND #4 HORIZIONTAL REBAR AT 12"O.C.			

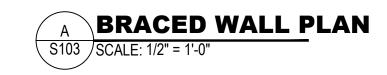

FOR CONSTRUCTION

RECORD OF REV	ISIONS	0 1 2	PRINCIPAL			\mathbf{Y}
		TE THE ADOVE SCALE DAD DOES NOT MEASURE 1 INCH	M. HIRST			
		IF THE ABOVE SCALE BAR DOES NOT MEASURE 1-INCH IN LENGTH, DO NOT USE THIS DRAWING FOR SCALING PURPOSES. DIMENSIONS AND MEASUREMENTS	PROJECT MANAGER M. CHANDLER			CRS ENGINEERS
		SPECIFIED IN THE DRAWING TAKE PRECEDENCE TO	CHECKED BY			CIVS FIAGILITE IVS
		SCALED MEASUREMENTS.	M. PORTER			
			DRAWN BY			Answers to Infrastructure®
		THE INFORMATION CONTAINED IN THIS DRAWING IS	K. ACHTER			Allowers to Illitustracture
		THE PROPERTY OF CRS ENGINEERS AND IS NOT TO	DRAWING SCALE			
		BE REPRODUCED, MODIFIED OR USED FOR ANY OTHER		4246 S Riv	verhoat Rd	Ste 200 Salt Lake City, UT 84123 P: 801.359.5565 www.crsengineers.com
		PROJECT OR EXTENSION OF THIS PROJECT EXCEPT BY	ISSUE DATE	4240 O KIV	rerboat ita,	ote 200 Out Earle Oity, 01 04120 1 : 001.000.0000 www.oroengineers.com
		AGREEMENT WITH CRS ENGINEERS.	AUGUST 2, 2018	<u> </u>		

OGDEN CITY
WHEELER CREEK DIVERSION
BRACED WALL PLAN

16111C

SHEET OF


18 21

SHEET NUMBER

\$103


OGDEN CANYON

OGDEN, UTAH

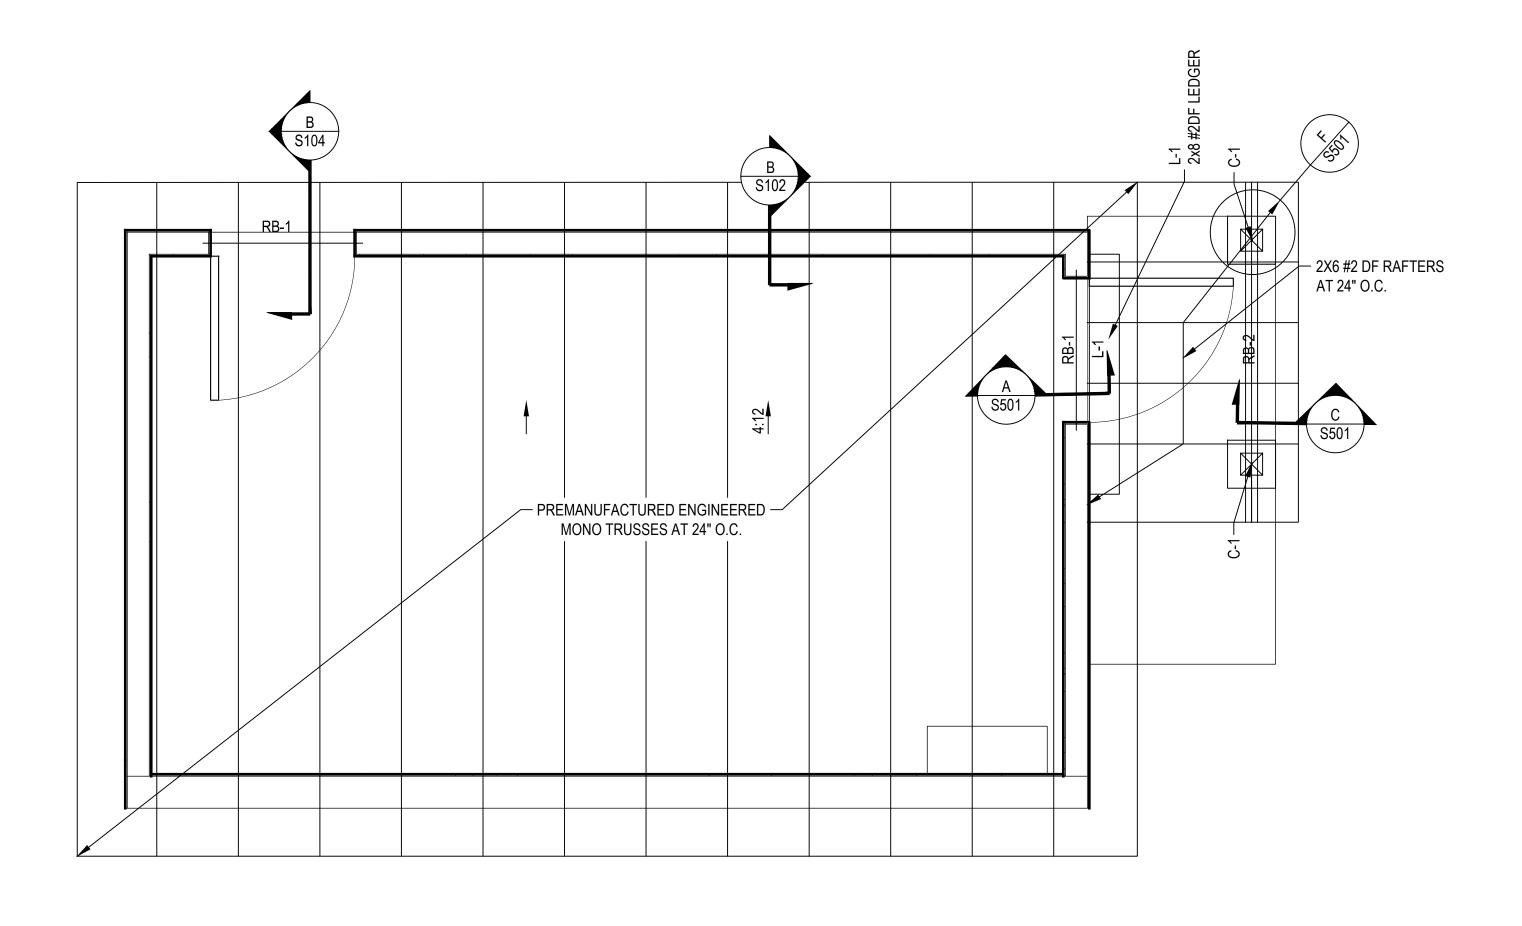

BEAM SCHEDULE			
RB-1	MASONRY LINTEL		
RB-2	(2) 2x8 #2DF		
L-1	2x8 #2DF LEDGER		

COLUMN SCHEDULE				
C-1	6X6 #2DF			

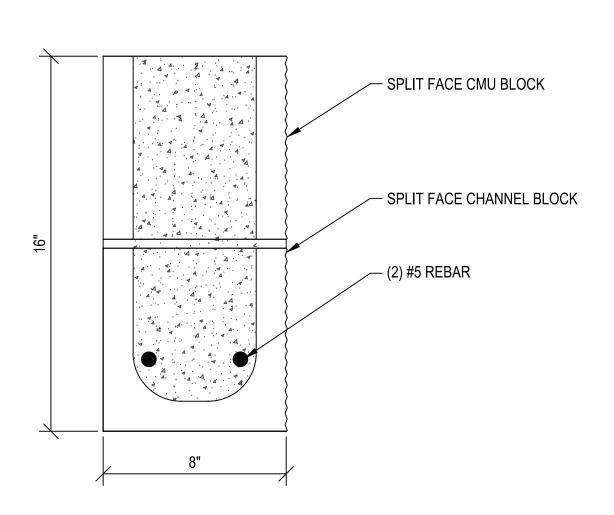



A ROOF FRAMING PLAN
S104 | SCALE: 1/2" = 1'-0"

APPROVED

FOR CONSTRUCTION

RECORD OF REVISIONS	0 1 2	PRINCIPAL		
	IF THE ABOVE SCALE BAR DOES NOT MEASURE 1-INCH IN LENGTH, DO NOT USE THIS DRAWING FOR SCALING PURPOSES. DIMENSIONS AND MEASUREMENTS SPECIFIED IN THE DRAWING TAKE PRECEDENCE TO SCALED MEASUREMENTS.	M. HIRST PROJECT MANAGER M. CHANDLER CHECKED BY M. PORTER	$\frac{C}{S}$	CRS ENGINEERS
	THE INFORMATION CONTAINED IN THIS DRAWING IS THE PROPERTY OF <i>CRS ENGINEERS</i> AND IS NOT TO BE REPRODUCED, MODIFIED OR USED FOR ANY OTHER PROJECT OR EXTENSION OF THIS PROJECT EXCEPT BY AGREEMENT WITH <i>CRS ENGINEERS</i> .		4246 S Riverboat Rd,	Answers to Infrastructure® Ste 200 Salt Lake City, UT 84123 P: 801.359.5565 www.crsengineers.com

OGDEN CITY
WHEELER CREEK DIVERSION
ROOF FRAMING PLAN

16111C

SHEET OF

19 21


SHEET NUMBER


\$104


OGDEN CANYON

OGDEN, UTAH


FOR CONSTRUCTION

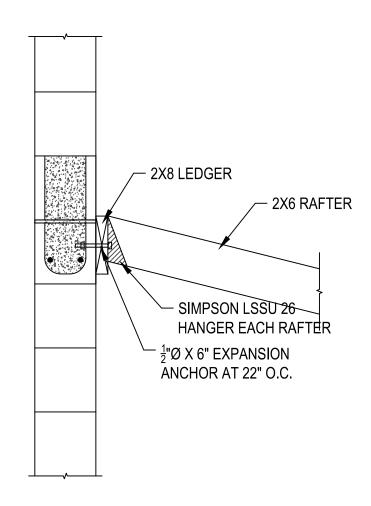

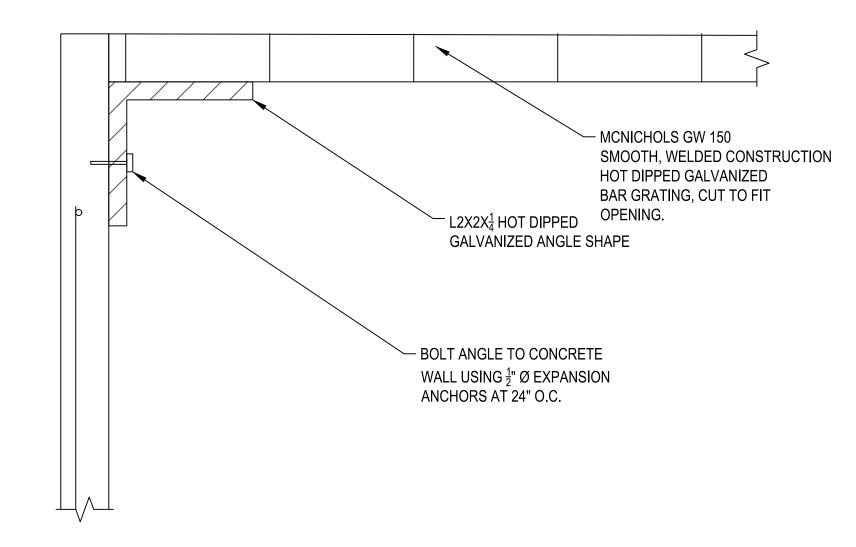

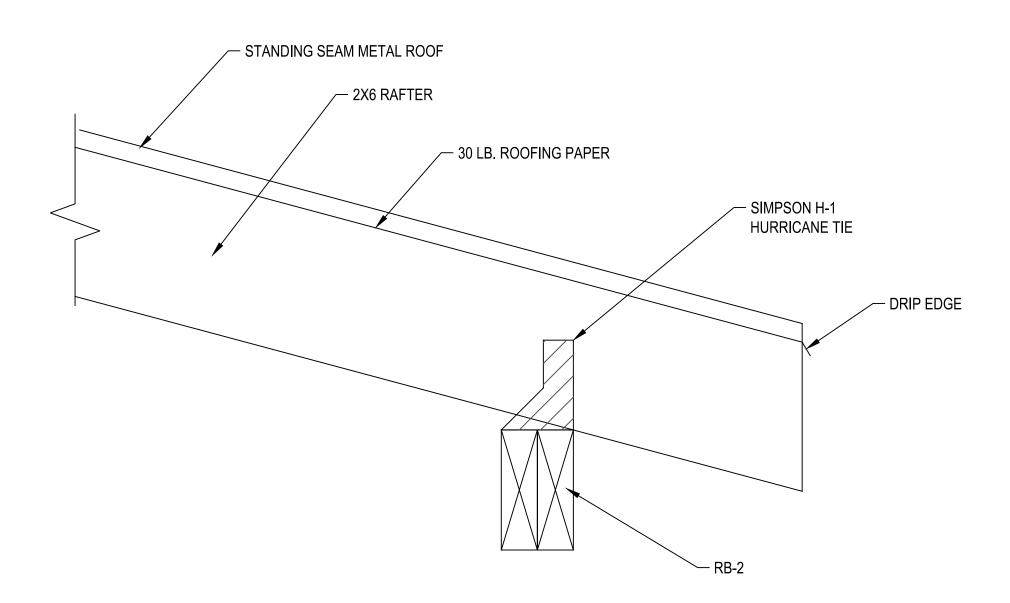


A LEDGER CONNECTION DETAIL S502 | SCALE: 1" = 1'-0"

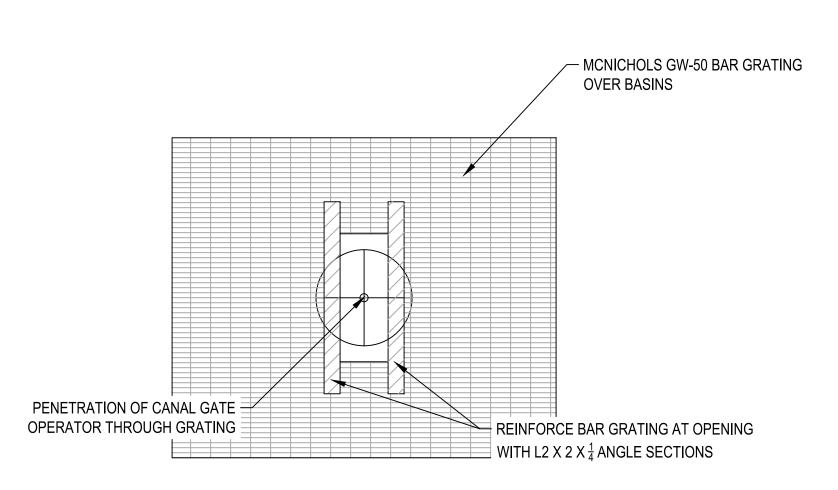


BAR GRATE CONNECTION DETAIL

S501 SCALE: 3/4" = 1' -0"

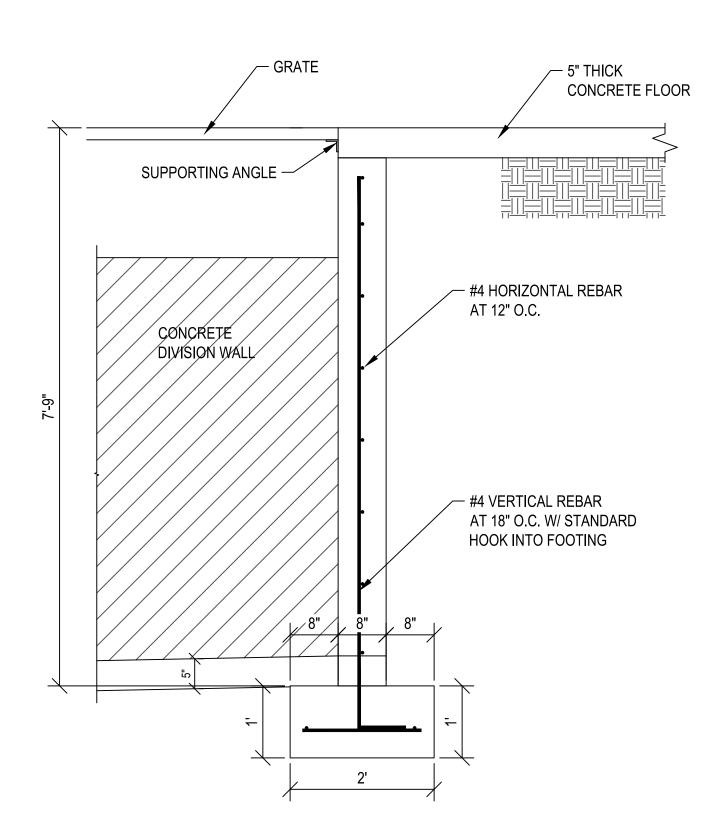

C RAFTER TO BEAM CONNECTION
S501 SCALE: 1-1/2" = 1'-0"

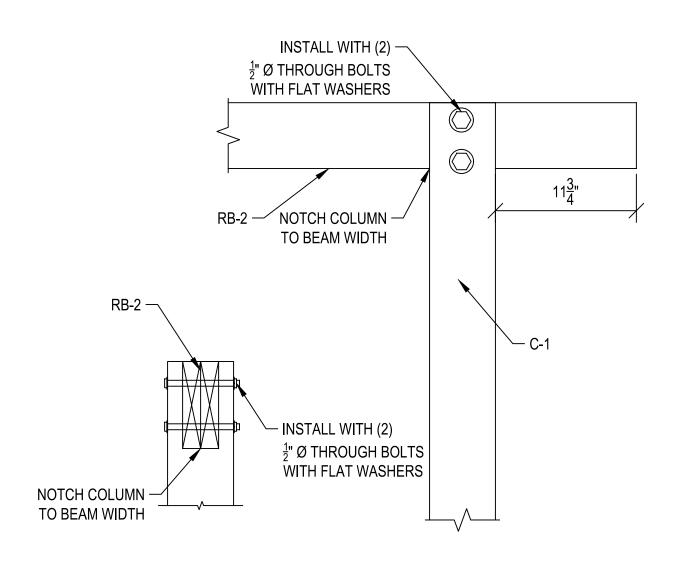

D GRATE PENETRATION DETAIL
S502 SCALE: 1" = 1'-0"




F BEAM TO COLUMN CONNECTION
S501 | SCALE: 1-1/2" = 1'-0"

RECORD OF REVISIONS	0 1 2	PRINCIPAL
	IF THE ABOVE SCALE BAR DOES NOT MEASURE 1-INCH IN LENGTH, DO NOT USE THIS DRAWING FOR SCALING PURPOSES. DIMENSIONS AND MEASUREMENTS SPECIFIED IN THE DRAWING TAKE PRECEDENCE TO SCALED MEASUREMENTS.	M. HIRST PROJECT MANAGER M. CHANDLER CHECKED BY M. PORTER
	THE INFORMATION CONTAINED IN THIS DRAWING IS THE PROPERTY OF CRS ENGINEERS AND IS NOT TO BE REPRODUCED, MODIFIED OR USED FOR ANY OTHER	DRAWN BY K. ACHTER DRAWING SCALE
	PROJECT OR EXTENSION OF THIS PROJECT EXCEPT BY AGREEMENT WITH CRS ENGINEERS.	



OGDEN CITY
WHEELER CREEK DIVERSION
STRUCTURAL DETAILS

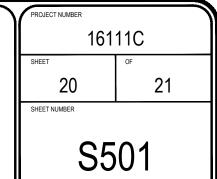

OGDEN CANYON

OGDEN, UTAH

