# Verizon SAL - EDEN

# SITE INFORMATION

APPLICANT: VERIZON WIRELESS 9656 SOUTH PROSPERITY ROAD WEST JORDAN, UTAH 84088

SITE ADDRESS: 4964 NORTH POWDER MOUNTAIN ROAD EDEN. UTAH 84310

LATITUDE AND LONGITUDE: N 41'20'19.78", W 111'48'58.76"

**ZONING JURISDICTION:** 

WEBER COUNTY

### PROJECT DESCRIPTION:

This is an existing unmanned communications facility, vzw is proposing to add their antennas to the existing lattice tower outdoor equipment and a generator

### TYPE OF CONSTRUCTION:

OUTDOOR EQUIPMENT AND GENERATOR, WITH ANTENNAS UPON A LATTICE TOWER

### HANDICAP REQUIREMENTS:

FACILITY IS UNMANNED AND NOT FOR HUMAN HABITATION, HANDICAP ACCESS REQUIREMENTS  $\underline{\text{DO}}$  NOT APPLY

### POWER COMPANY:

ROCKY MOUNTAIN POWER, 1-888-221-7070

# **LOCATION MAP**



# DO NOT SCALE DRAWINGS

CONTRACTOR SHALL VERIFY ALL PLANS, AND EXISTING DIMENSIONS, AND CONDITIONS ON THE JOB SITE, AND SHALL IMMEDIATELY NOTIFY THE ENGINEER IN WRITING OF ANY DISCREPANCIES BEFORE PROCEEDING WITH THE WORK OR BE RESPONSIBLE FOR SAME

# CONTACT INFORMATION

SITE ACQUISITION:
TECHNOLOGY ASSOCIATES EC, INC
7896 SOUTH HIGHLAND DRIVE, SUITE 200
COTTONWOOD HEIGHTS, UTAH 84121
CONTACT: DAKOTA HAWKS
PHONE: 801-651-4769

# DRIVING DIRECTIONS

FROM THE VZW WEST JORDAN OFFICES, TAKE I-15 NORTH FOR 50± MILES TO 12TH STREET EXIT #344 IN OGDEN. TURN RIGHT AND GO EAST ON 12TH STREET FOR 4.75 MILES AT WHICH POINT 12TH STREET TURNS INTO OGDEN CANYON ROAD, CONTINUE EAST FOR ANOTHER 6 MILES UNTIL YOU REACH S.R. 158 (ROAD JUST EAST OF THE DAM). TURN LEFT AND GO NORTH ON S.R. 158 (CONTINUING STRAIGHT THROUGH THE MAVERICK INTERSECTION) FOR 7.75 MILES TO THE EXISTING DIRT ROAD ON THE RIGHT (SOUTH) SIDE OF THE ROAD AT 41'20'56.63"/111'49'08.87". FOLLOW THE DIRT ROAD SOUTH TO THE EXISTING TOWERS.

### APPROVALS

VERIZON WIRELESS REPRESENTATIVE:

VERIZON WIRELESS RF ENGINEER:

TAEC SITE ACQUISITION:

TAEC CONSTRUCTION MANAGER:

SITE OWNER:

# **DRAWING INDEX**

DRAWING INDEX					
SHEET NO.	SHEET TITLE	R E V	REV DATE		
T100	TITLE SHEET, VICINITY MAP, GENERAL SITE INFORMATION	0			
SURV	SITE SURVEY	0			
C100	OVERALL SITE PLAN	0			
C101	ENLARGED SITE PLAN	0			
C200	SITE ELEVATIONS	0			



UNDERGROUND SERVICE ALERT, CALL 'BLUE STAKES OF UTAH' @ 811 OR 1-800-662-4111

THREE WORKING DAYS BEFORE YOU DIG







UTAH MARKET OFFICE 7896 SOUTH HIGHLAND DRIVE, SUITE 200 COTTONWOOD HEIGHTS, UTAH 84121

CORPORATE OFFICE

3115 SOUTH MELROSE DRIVE, SUITE #110 CARLSBAD, CALIFORNIA 92010

DRAWN BY: JAY C
CHECKED BY: DAKOTA H


0	04.09.2018	ZONING DRAWINGS
REV	DATE	DESCRIPTION

SAL - EDEN
SE SEC 15, T7N, R1E
4964 NORTH POWDER MOUNTAIN ROAD
EDEN, UTAH 84310
- SITE CO-LOCATION --

SHEET TITLE
TITLE SHEET
VICINITY MAP
GENERAL INFORMATION

SHEET NUMBE

T100

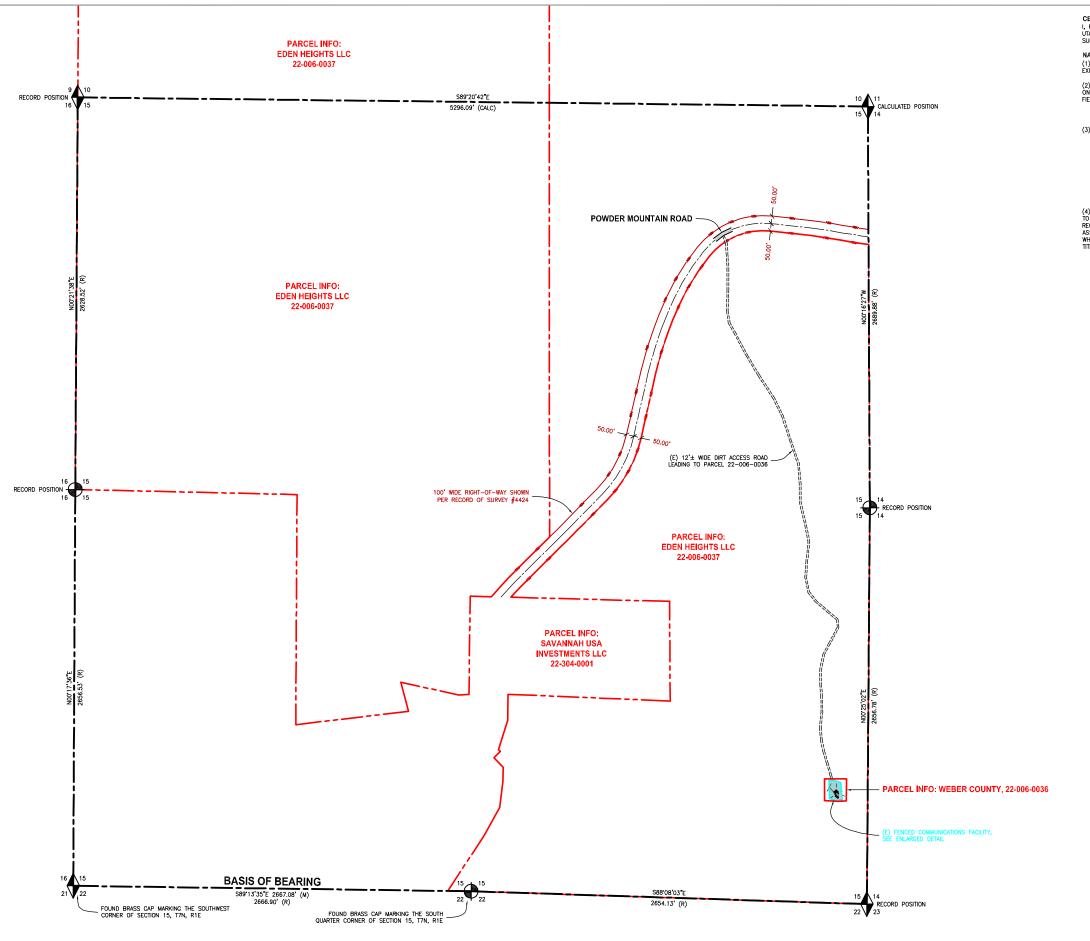

CERTIFICATE OF SURVEY:

1, RICHARD W. MILLER, PROFESSIONAL LAND SURVEYOR, STATE OF UTHAL, LICENSE NUMBER 155641, CERTIFY THAT I HAVE SUPERVISED A SURVEY ON THE GROUND AS SHOWN HEREON:

NARRATIVE:
(1) THE PURPOSE OF THIS SURVEY WAS TO AS—BUILT SURVEY AN EXISTING WIRELESS COMMUNICATIONS FACILITY.

(2) THE BASIS OF BEARING USED FOR THIS SURVEY IS AS SHOWN ON THIS PLAT, FROM FOUND MONUMENTS AS LOCATED IN THE FIELD.

(M) = MEASURED DISTANCE. (R) = RECORDED DISTANCE.

- (3) REFERENCE PLATS:
  (A) U.S.G.S. 7-1/2 MINUTE QUADRANGLE 'HUNTSVILLE,
- (A) U.S.G.S. 7-1/2 MINUTE QUADRANGLE 'HUNTSVILLE, UTAH', DATED 1991.
   (B) WEBER COUNTY AREA REFERENCE PLAT FOR TOWNSHIP 7 NORTH, RANGE 1 EAST, DATED 11-07-1995.
   (C) WEBER COUNTY OWNERSHIP PLATS FOR SECTIONS 9 THRU 16 OF T7N, R1E.
   (D) RECORD OF SURVEY #4424, PERFORMED BY BASELINE SURVEYING FOR EDEN HEIGHTS LLC, DATED 03.02.2010.

(4) AT COMPLETION OF THIS SURVEY NO TITLE HAD BEEN ISSUED TO MILLER ASSOCIATES BY TECHNOLOGY ASSOCIATES, PER THEIR REQUEST, THE SURVEY HAS BEEN FORWARDED. MILLER ASSOCIATES ASSUMES NO LUBILITY FOR ITEMS NOT SUPPLIED WHICH MAY, OR MAY NOT AFFECT THE SITE. ON DELIVERY OF A TITLE REPORT PERTINENT ITEMS WILL BE ADDED.

CENTER OF THE (E) TOWER STATE PLANE COORDINATES - NAD 83 (FT NORTHING=3647330.28, EASTING=1553553.4 GEODETIC COORDINATES - NAD 83 LATITUDE = N 41'20'19.78" LONGITUDE = W 111'48'58.76"

> STATE OF UTAH, NORTH ZONE TOP OF TOWER = 60.65' OR 6120.00' A.M.S.L.

TOP OF ANTENNA SET #1 = 59.00' BOTTOM OF ANTENNA SET #1 = 55.95' TOP OF ANTENNA SET #2=53.00' BOTTOM OF ANTENNA SET #2=49.95'

TOP OF MICROWAVE #1 = 27.80'BOTTOM OF MICROWAVE #1 = 21.30'

TOP OF CONCRETE = 0.00' A.G.L. OR 6059.35' A.M.S.L. (NAVD88)





UTAH MARKET OFFICE 380 WEST LAWNDALE DRIVE SALT LAKE CITY, UTAH 84115

NORTHWEST REGIONAL OFFICE 4800 SW MEADOWS ROAD, SUITE 300 LAKE OSWEGO, OREGON 97035


SURVEY PREPARED BY:

# MILLER ASSOCIATES INC.

3225 W. CALIFORNIA AVE., SUITE 101 SALT LAKE CITY, UTAH 84104 PHONE: 801-975-1083 FAX: 801-975-1081

DRAWN BY: CHECKED BY:		JAY (	
		RICHARD M	
$\dashv$			
$\dashv$			
0	10.02.2009	SITE SURVEY	
REV	DATE	DESCRIPTION	



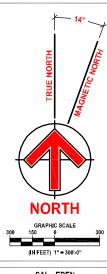

SAL - EDEN SE SEC 15, T7N, R1E 4964 NORTH POWDER MOUNTAIN ROAD EDEN, UTAH 84310 -- SITE CO-LOCATION -

> SHEET TITLE SITE SURVEY

SHEET NUMBER **SURV** 

### **ASAC INFORMATION SHEET 91:003**

# INFORMATION REGARDING SURVEY DATA SUBMITTED TO THE FAA

FAA Order 8260.19c requires proponents of certain proposed construction (located beneath instrument procedures) provide the FAA with a site survey and/or letter, from a licensed land surveyor, which certifies the site coordinates and the surface elevation at the site. On October 15, 1992, the FAA started using the North American Datum of 1983 (NAD-83), and therefore all site coordinates should be based on NAD-83. The FAA requires that the survey letter contain an accuracy statement that meets accuracy tolerances required by the FAA. The most requested tolerances are +/- 50 feet in the horizontal and +/- 20 feet in the vertical (2-C). When the site coordinates and/or site elevation can be certified to a greater accuracy than requested by the FAA, please do so.

In order to avoid FAA processing delays, the original site survey or certifying letter should be attached to the 7460 when it is filed at the FAA's regional office. It must be signed and sealed by the licensed land surveyor having performed or supervised the survey.

The FAA accuracy codes and a sample accuracy statement are listed below.

# **ACCURACY CODES:**

	HORIZONTAL	VEI	RTICAL
Code	Tolerance	Code	Tolerance
1	+/ <b>-</b> 20 ft	$\overline{A}$	+/-3 ft
2	+/ <b>-</b> 50 ft	В	+/ <b>-</b> 10 ft
3	+/ <b>-</b> 100 ft	C	+/ <b>-</b> 20 ft
4	+/ <b>-</b> 250 ft	D	+/ <b>-</b> 50 ft
5	+/ <b>-</b> 500 ft	E	+/ <b>-</b> 125 ft
6	+/ <b>-</b> 1000 ft	F	+/ <b>-</b> 250 ft
7	+/ <b>-</b> 1/2 NM	G	+/ <b>-</b> 500 ft
8	+/ <b>-</b> 1 NM	Н	+/ <b>-</b> 1000 ft
9	Unknown	I	Unknown

Date: OCTOBER 2, 2009

Re: SAL - EDEN

SE 1/4 OF SECTION 15, TOWNSHIP 7 NORTH, RANGE 1 EAST, SALT LAKE MERIDIAN

I certify that the latitude of N 41°20′19.78″, and the longitude of W 111°48′58.76″, are accurate to within 15 feet horizontally and the site elevation of 6059.35 feet, AMSL (American Mean Sea Level), is accurate to within +/- 3 feet vertically. With an existing structure height of 60.65 feet AGL, the overall height is 6120 feet AMSL. The horizontal datum (coordinates) are in terms of the North American Datum of 1983 (NAD-83) and are expressed as degrees, minutes and seconds, to the nearest (tenth/hundredth) of a second. The vertical datum (heights) are in terms of the (NAVD88) and are determined to the nearest foot.

Top of Tower = 60.65' A.G.L. or 6120' A.M.S.L. (Highest Point)

Top of Antenna Set #1 = 59.00' A.G.L.

Bottom of Antenna Set #1 = 55.95' A.G.L.

Top of Antenna Set #2 = 53.00' A.G.L.


Bottom of Antenna Set #2 = 49.95' A.G.L.

Top of Microwave = 27.80' A.G.L.

Bottom of Microwave = 21.30' A.G.L.

Top of Concrete = 0.00' A.G.L. or 6059.35' A.M.S.L.



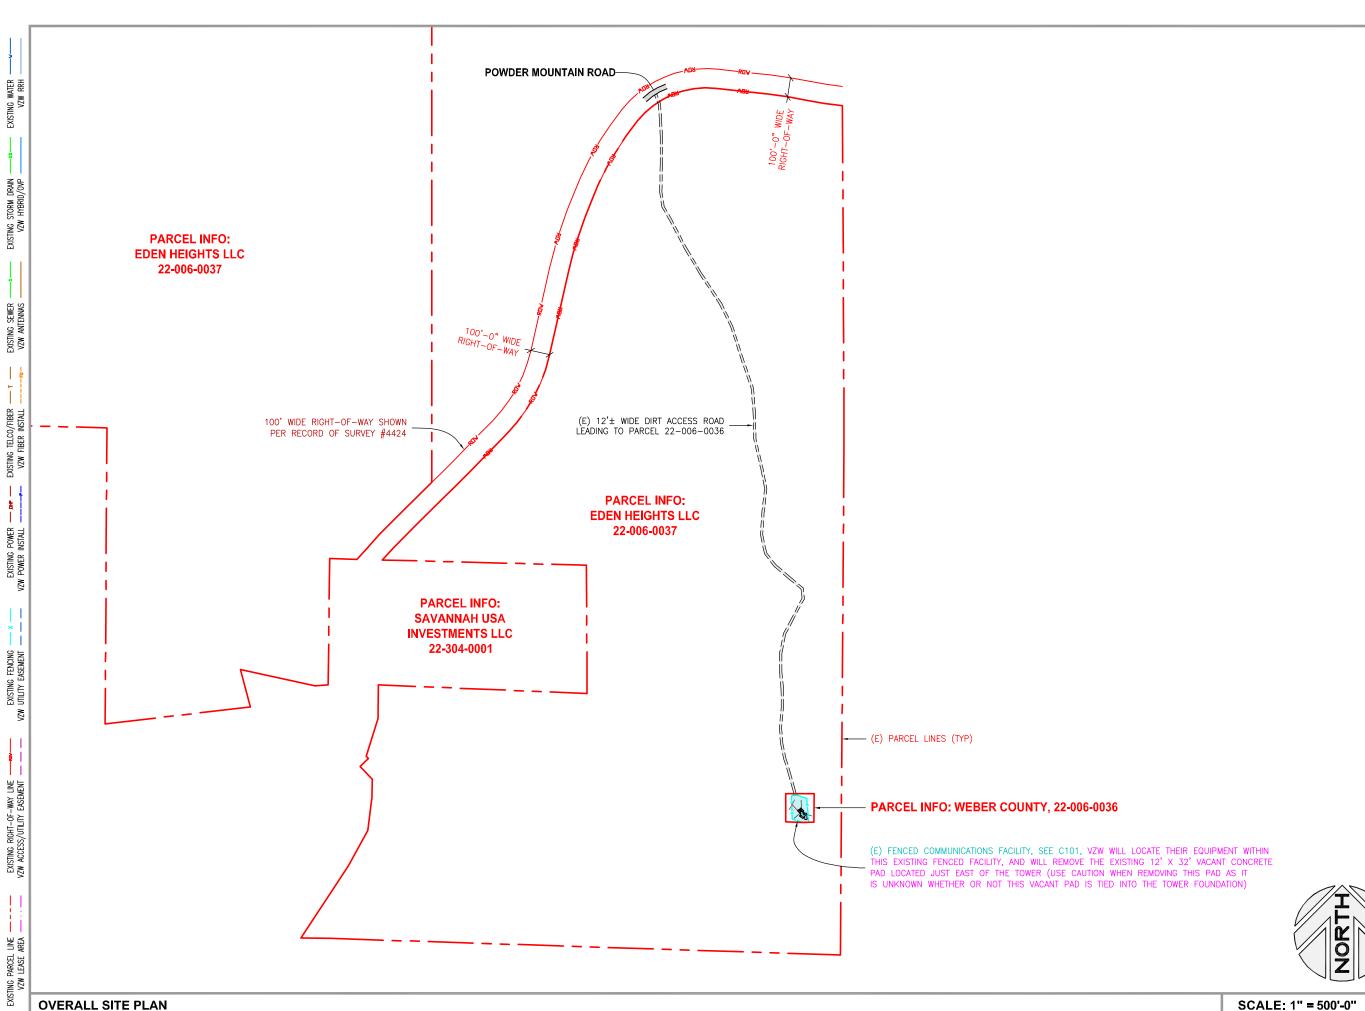





UTAH MARKET OFFICE 7896 SOUTH HIGHLAND DRIVE, SUITE 200 COTTONWOOD HEIGHTS, UTAH 84121

CORPORATE OFFICE 3115 SOUTH MELROSE DRIVE, SUITE #110 CARLSBAD, CALIFORNIA 92010

DRAWN BY: DAKOTA H CHECKED BY:




SAL - EDEN SE SEC 15, T7N, R1E 4964 NORTH POWDER MOUNTAIN ROAD **EDEN, UTAH 84310** - SITE CO-LOCATION --

SHEET TITLE

**OVERALL SITE PLAN** 

C100

SCALE: 1" = 500'-0"

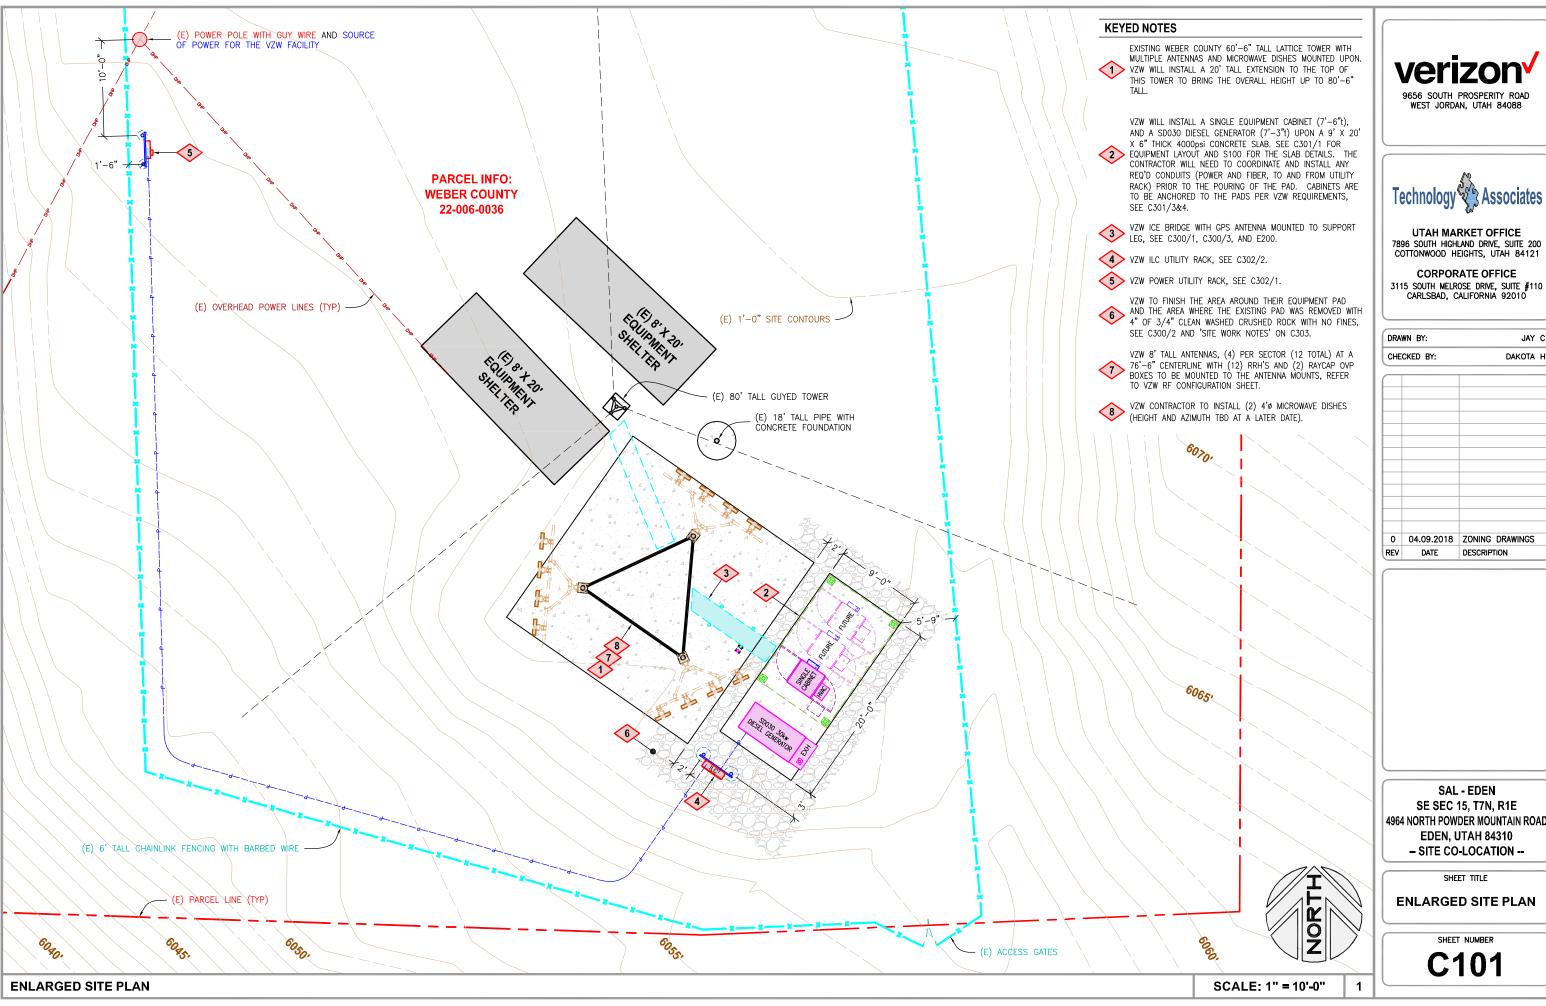






7896 SOUTH HIGHLAND DRIVE, SUITE 200

CORPORATE OFFICE

DAKOTA H

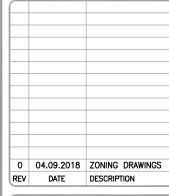

SAL - EDEN SE SEC 15, T7N, R1E 4964 NORTH POWDER MOUNTAIN ROAD **EDEN, UTAH 84310** - SITE CO-LOCATION --

**ENLARGED SITE PLAN** 

C101



2 EXISTING 11' TALL OMNI ANTENNA AT A 65'-2"± CENTERLINE.

**KEYED NOTES** 

EXISTING 20' TALL OMNI ANTENNA AT A 59'-7"± CENTERLINE.

EXISTING 3' TALL PANEL ANTENNAS, (1) SET IS AT A 57'-0" CENTERLINE, (1) SET IS AT A 51'-6" CENTERLINE.

EXISTING WEBER COUNTY 60'-6" TALL LATTICE

1 DISHES MOUNTED UPON. VZW WILL INSTALL A 20' TALL EXTENSION TO THE TOP OF THIS TOWER TO BRING THE OVERALL HEIGHT UP TO 80'-6" TALL.

TOWER WITH MULTIPLE ANTENNAS AND MICROWAVE

5 EXISTING 3'Ø MICROWAVE DISH AT A 37'-3" CENTERLINE.

6 EXISTING 8'Ø MICROWAVE DISH AT A 24'-3" CENTERLINE.


> (7'-6"t), AND A SD030 DIESEL GENERATOR (7'-3"t)UPON Á 9' X 20' X 6" THICK 4000psi CONCRETE SLAB. SEE C301/1 FOR EQUIPMENT LAYOUT AND S100 FOR THE SLAB DETAILS. THE CONTRACTOR WILL NEED TO COORDINATE AND INSTALL ANY REQ'D CONDUITS (POWER AND FIBER, TO AND FROM UTILITY RACK) PRIOR TO THE POURING OF THE PAD. CABINETS ARE TO BE ANCHORED TO THE PADS PER VZW REQUIREMENTS, SEE C301/3&4.


VZW WILL INSTALL A SINGLE EQUIPMENT CABINET


VZW 8' TALL ANTENNAS, (4) PER SECTOR (12 TOTAL) AT A 76'-6" CENTERLINE WITH (12) RRH'S 8 AND (2) RAYCAP OVP BOXES TO BE MOUNTED TO THE ANTENNA MOUNTS, REFER TO VZW RF CONFIGURATION SHEET.

VZW CONTRACTOR TO INSTALL (2) 4'Ø MICROWAVE 9 DISHES (HEIGHT AND AZIMUTH TBD AT A LATER

VZW CONTRACTOR TO INSTALL THE 6' TALL LIGHTNING ROD AS SUPPLIED BY TOWER MANUFACTURER.

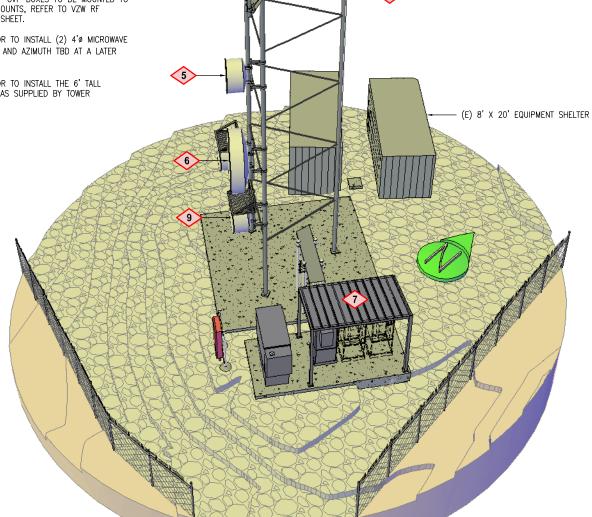

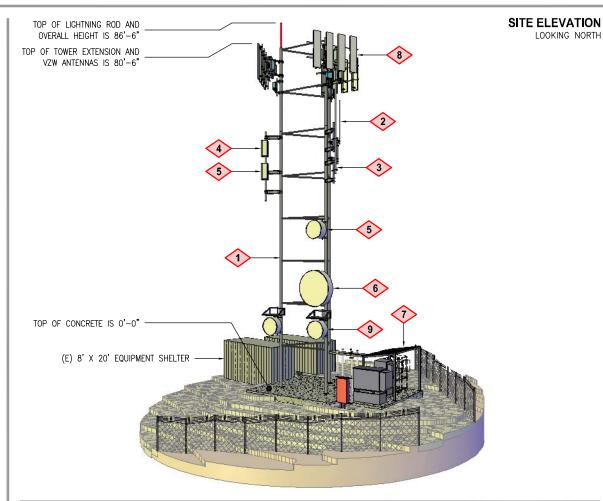

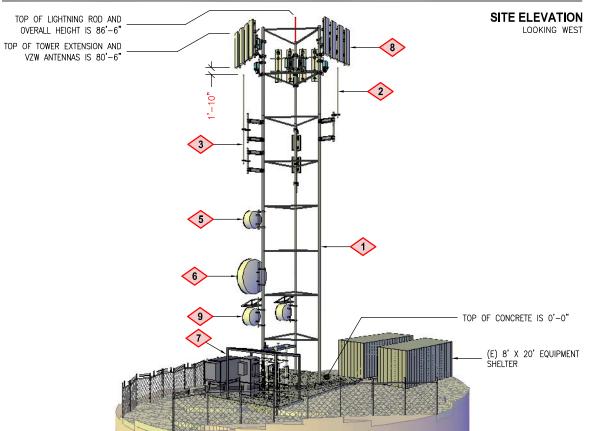




WEST JORDAN, UTAH 84088



**UTAH MARKET OFFICE** 7896 SOUTH HIGHLAND DRIVE, SUITE 200 COTTONWOOD HEIGHTS, UTAH 84121

CORPORATE OFFICE 3115 SOUTH MELROSE DRIVE, SUITE #110 CARLSBAD, CALIFORNIA 92010"

DRAWN BY: CHECKED BY: DAKOTA H

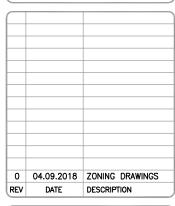

SAL - EDEN SE SEC 15, T7N, R1E 4964 NORTH POWDER MOUNTAIN ROAD **EDEN, UTAH 84310** - SITE CO-LOCATION --

SHEET TITLE

SITE ELEVATIONS

**C200** 

SITE ELEVATION NORTHWEST VIEW

EXISTING RIGHT-OF-WAY LINE ZW ACCESS/UTILITY EASEMENT