


Kevin & Collette Parkinson - Barn

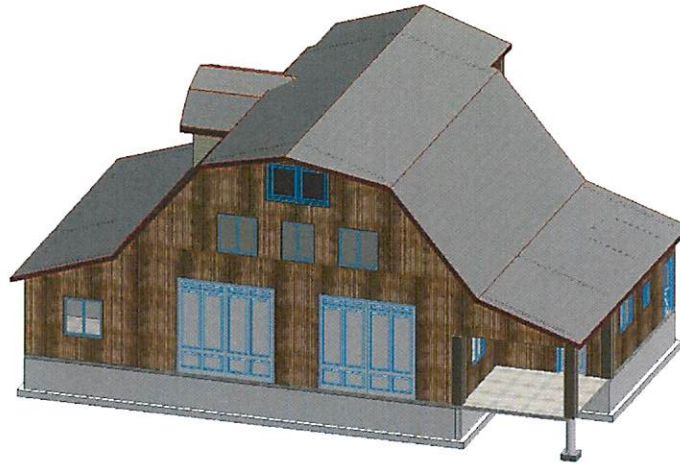

SHEET INDEX	
ID	Name
A-1	COVER SHEET
A-2	Footing Plan
A-3	Foundation Plan
A-4	1st FLOOR PLAN
A-5	1st Floor Structural
A-6	2nd Floor
A-7	2nd Floor Structural
A-8	FLOOR JOISTS
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A-11	ELEVATIONS
A-12	SECTION 1
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A-14	Site Plan
A-15	DETAILS

Brett Kearl
P.E.

Kevin &
Collette
Parkinson

6523 N
NorthFork
Road
Liberty UT

2 Generic Axonometry
SCALE: 1/4" = 1'-0"



GENERAL NOTES:

I. CONCRETE, FOOTINGS, AND FOUNDATIONS:

1. ALL CONCRETE SHALL BE CAST IN PLACE AND SHALL BE FINISHED TO THE FINISH SURFACE UNLESS OTHERWISE NOTED.

2. ALL CONCRETE SHALL BE CAST TO THE FINISH SURFACE UNLESS OTHERWISE NOTED.

3. ALL CONCRETE SHALL BE CAST TO THE FINISH SURFACE UNLESS OTHERWISE NOTED.

4. ALL CONCRETE SHALL BE CAST TO THE FINISH SURFACE UNLESS OTHERWISE NOTED.

5. ALL CONCRETE SHALL BE CAST TO THE FINISH SURFACE UNLESS OTHERWISE NOTED.

6. ALL CONCRETE SHALL BE CAST TO THE FINISH SURFACE UNLESS OTHERWISE NOTED.

7. ALL CONCRETE SHALL BE CAST TO THE FINISH SURFACE UNLESS OTHERWISE NOTED.

8. ALL CONCRETE SHALL BE CAST TO THE FINISH SURFACE UNLESS OTHERWISE NOTED.

9. ALL CONCRETE SHALL BE CAST TO THE FINISH SURFACE UNLESS OTHERWISE NOTED.

10. ALL CONCRETE SHALL BE CAST TO THE FINISH SURFACE UNLESS OTHERWISE NOTED.

II. WOOD FRAMING:

1. ALL WOOD FRAMING SHALL BE PERFORMED IN ACCORDANCE WITH THE LATEST EDITIONS OF THE INTERNATIONAL RESIDENTIAL CODE BOOK (IRC) AND THE INTERNATIONAL BUILDING CODE (IBC).

2. ALL WOOD FRAMING SHALL BE PERFORMED IN ACCORDANCE WITH THE LATEST EDITIONS OF THE INTERNATIONAL RESIDENTIAL CODE BOOK (IRC) AND THE INTERNATIONAL BUILDING CODE (IBC).

3. ALL WOOD FRAMING SHALL BE PERFORMED IN ACCORDANCE WITH THE LATEST EDITIONS OF THE INTERNATIONAL RESIDENTIAL CODE BOOK (IRC) AND THE INTERNATIONAL BUILDING CODE (IBC).

4. ALL WOOD FRAMING SHALL BE PERFORMED IN ACCORDANCE WITH THE LATEST EDITIONS OF THE INTERNATIONAL RESIDENTIAL CODE BOOK (IRC) AND THE INTERNATIONAL BUILDING CODE (IBC).

5. ALL WOOD FRAMING SHALL BE PERFORMED IN ACCORDANCE WITH THE LATEST EDITIONS OF THE INTERNATIONAL RESIDENTIAL CODE BOOK (IRC) AND THE INTERNATIONAL BUILDING CODE (IBC).

IV. STRUCTURAL STEEL:

1. ALL STRUCTURAL STEEL SHALL BE PERFORMED IN ACCORDANCE WITH THE LATEST EDITIONS OF THE AISC STEEL CONSTRUCTION MANUAL (SCM) AND THE AISC DESIGN GUIDE (DG).

2. ALL STRUCTURAL STEEL SHALL BE PERFORMED IN ACCORDANCE WITH THE LATEST EDITIONS OF THE AISC STEEL CONSTRUCTION MANUAL (SCM) AND THE AISC DESIGN GUIDE (DG).

3. ALL STRUCTURAL STEEL SHALL BE PERFORMED IN ACCORDANCE WITH THE LATEST EDITIONS OF THE AISC STEEL CONSTRUCTION MANUAL (SCM) AND THE AISC DESIGN GUIDE (DG).

4. ALL STRUCTURAL STEEL SHALL BE PERFORMED IN ACCORDANCE WITH THE LATEST EDITIONS OF THE AISC STEEL CONSTRUCTION MANUAL (SCM) AND THE AISC DESIGN GUIDE (DG).

5. ALL STRUCTURAL STEEL SHALL BE PERFORMED IN ACCORDANCE WITH THE LATEST EDITIONS OF THE AISC STEEL CONSTRUCTION MANUAL (SCM) AND THE AISC DESIGN GUIDE (DG).

X. FIRE PROTECTION NOTES:

1. ALL FIRE PROTECTION SHALL BE PERFORMED IN ACCORDANCE WITH THE LATEST EDITIONS OF THE NFPA 909, FIRE PROTECTION OF STRUCTURES.

2. ALL FIRE PROTECTION SHALL BE PERFORMED IN ACCORDANCE WITH THE LATEST EDITIONS OF THE NFPA 909, FIRE PROTECTION OF STRUCTURES.

3. ALL FIRE PROTECTION SHALL BE PERFORMED IN ACCORDANCE WITH THE LATEST EDITIONS OF THE NFPA 909, FIRE PROTECTION OF STRUCTURES.

4. ALL FIRE PROTECTION SHALL BE PERFORMED IN ACCORDANCE WITH THE LATEST EDITIONS OF THE NFPA 909, FIRE PROTECTION OF STRUCTURES.

5. ALL FIRE PROTECTION SHALL BE PERFORMED IN ACCORDANCE WITH THE LATEST EDITIONS OF THE NFPA 909, FIRE PROTECTION OF STRUCTURES.

XI. MECHANICAL GENERAL NOTES:

1. ALL MECHANICAL SYSTEMS SHALL BE PERFORMED IN ACCORDANCE WITH THE LATEST EDITIONS OF THE INTERNATIONAL MECHANICAL CODE (IMC).

2. ALL MECHANICAL SYSTEMS SHALL BE PERFORMED IN ACCORDANCE WITH THE LATEST EDITIONS OF THE INTERNATIONAL MECHANICAL CODE (IMC).

3. ALL MECHANICAL SYSTEMS SHALL BE PERFORMED IN ACCORDANCE WITH THE LATEST EDITIONS OF THE INTERNATIONAL MECHANICAL CODE (IMC).

4. ALL MECHANICAL SYSTEMS SHALL BE PERFORMED IN ACCORDANCE WITH THE LATEST EDITIONS OF THE INTERNATIONAL MECHANICAL CODE (IMC).

5. ALL MECHANICAL SYSTEMS SHALL BE PERFORMED IN ACCORDANCE WITH THE LATEST EDITIONS OF THE INTERNATIONAL MECHANICAL CODE (IMC).

XII. FIRE WARNING SYSTEM NOTES:

1. ALL FIRE WARNING SYSTEMS SHALL BE PERFORMED IN ACCORDANCE WITH THE LATEST EDITIONS OF THE NFPA 72, NATIONAL FIRE ALARM AND SIGNaling CODE.

2. ALL FIRE WARNING SYSTEMS SHALL BE PERFORMED IN ACCORDANCE WITH THE LATEST EDITIONS OF THE NFPA 72, NATIONAL FIRE ALARM AND SIGNaling CODE.

3. ALL FIRE WARNING SYSTEMS SHALL BE PERFORMED IN ACCORDANCE WITH THE LATEST EDITIONS OF THE NFPA 72, NATIONAL FIRE ALARM AND SIGNaling CODE.

4. ALL FIRE WARNING SYSTEMS SHALL BE PERFORMED IN ACCORDANCE WITH THE LATEST EDITIONS OF THE NFPA 72, NATIONAL FIRE ALARM AND SIGNaling CODE.

5. ALL FIRE WARNING SYSTEMS SHALL BE PERFORMED IN ACCORDANCE WITH THE LATEST EDITIONS OF THE NFPA 72, NATIONAL FIRE ALARM AND SIGNaling CODE.

XIII. STAIR & HANDRAIL NOTES:

1. ALL STAIR & HANDRAIL SYSTEMS SHALL BE PERFORMED IN ACCORDANCE WITH THE LATEST EDITIONS OF THE INTERNATIONAL BUILDING CODE (IBC).

2. ALL STAIR & HANDRAIL SYSTEMS SHALL BE PERFORMED IN ACCORDANCE WITH THE LATEST EDITIONS OF THE INTERNATIONAL BUILDING CODE (IBC).

3. ALL STAIR & HANDRAIL SYSTEMS SHALL BE PERFORMED IN ACCORDANCE WITH THE LATEST EDITIONS OF THE INTERNATIONAL BUILDING CODE (IBC).

4. ALL STAIR & HANDRAIL SYSTEMS SHALL BE PERFORMED IN ACCORDANCE WITH THE LATEST EDITIONS OF THE INTERNATIONAL BUILDING CODE (IBC).

5. ALL STAIR & HANDRAIL SYSTEMS SHALL BE PERFORMED IN ACCORDANCE WITH THE LATEST EDITIONS OF THE INTERNATIONAL BUILDING CODE (IBC).

III. PRE-FABRICATED WOOD TRUSSES:

1. ALL PRE-FABRICATED WOOD TRUSSES SHALL BE PERFORMED IN ACCORDANCE WITH THE LATEST EDITIONS OF THE INTERNATIONAL BUILDING CODE (IBC).

2. ALL PRE-FABRICATED WOOD TRUSSES SHALL BE PERFORMED IN ACCORDANCE WITH THE LATEST EDITIONS OF THE INTERNATIONAL BUILDING CODE (IBC).

3. ALL PRE-FABRICATED WOOD TRUSSES SHALL BE PERFORMED IN ACCORDANCE WITH THE LATEST EDITIONS OF THE INTERNATIONAL BUILDING CODE (IBC).

4. ALL PRE-FABRICATED WOOD TRUSSES SHALL BE PERFORMED IN ACCORDANCE WITH THE LATEST EDITIONS OF THE INTERNATIONAL BUILDING CODE (IBC).

5. ALL PRE-FABRICATED WOOD TRUSSES SHALL BE PERFORMED IN ACCORDANCE WITH THE LATEST EDITIONS OF THE INTERNATIONAL BUILDING CODE (IBC).

VI. SPECIAL NOTES:

1. ALL SPECIAL NOTES SHALL BE PERFORMED IN ACCORDANCE WITH THE LATEST EDITIONS OF THE INTERNATIONAL BUILDING CODE (IBC).

2. ALL SPECIAL NOTES SHALL BE PERFORMED IN ACCORDANCE WITH THE LATEST EDITIONS OF THE INTERNATIONAL BUILDING CODE (IBC).

3. ALL SPECIAL NOTES SHALL BE PERFORMED IN ACCORDANCE WITH THE LATEST EDITIONS OF THE INTERNATIONAL BUILDING CODE (IBC).

4. ALL SPECIAL NOTES SHALL BE PERFORMED IN ACCORDANCE WITH THE LATEST EDITIONS OF THE INTERNATIONAL BUILDING CODE (IBC).

5. ALL SPECIAL NOTES SHALL BE PERFORMED IN ACCORDANCE WITH THE LATEST EDITIONS OF THE INTERNATIONAL BUILDING CODE (IBC).

VII. EXCAVATION NOTES:

1. ALL EXCAVATION SHALL BE PERFORMED IN ACCORDANCE WITH THE LATEST EDITIONS OF THE INTERNATIONAL BUILDING CODE (IBC).

2. ALL EXCAVATION SHALL BE PERFORMED IN ACCORDANCE WITH THE LATEST EDITIONS OF THE INTERNATIONAL BUILDING CODE (IBC).

3. ALL EXCAVATION SHALL BE PERFORMED IN ACCORDANCE WITH THE LATEST EDITIONS OF THE INTERNATIONAL BUILDING CODE (IBC).

4. ALL EXCAVATION SHALL BE PERFORMED IN ACCORDANCE WITH THE LATEST EDITIONS OF THE INTERNATIONAL BUILDING CODE (IBC).

5. ALL EXCAVATION SHALL BE PERFORMED IN ACCORDANCE WITH THE LATEST EDITIONS OF THE INTERNATIONAL BUILDING CODE (IBC).

VIII. WINDOWS NOTES:

1. ALL WINDOWS SHALL BE PERFORMED IN ACCORDANCE WITH THE LATEST EDITIONS OF THE INTERNATIONAL BUILDING CODE (IBC).

2. ALL WINDOWS SHALL BE PERFORMED IN ACCORDANCE WITH THE LATEST EDITIONS OF THE INTERNATIONAL BUILDING CODE (IBC).

3. ALL WINDOWS SHALL BE PERFORMED IN ACCORDANCE WITH THE LATEST EDITIONS OF THE INTERNATIONAL BUILDING CODE (IBC).

4. ALL WINDOWS SHALL BE PERFORMED IN ACCORDANCE WITH THE LATEST EDITIONS OF THE INTERNATIONAL BUILDING CODE (IBC).

5. ALL WINDOWS SHALL BE PERFORMED IN ACCORDANCE WITH THE LATEST EDITIONS OF THE INTERNATIONAL BUILDING CODE (IBC).

IX. ATTIC VENTILATION NOTES:

1. ALL ATTIC VENTILATION SHALL BE PERFORMED IN ACCORDANCE WITH THE LATEST EDITIONS OF THE INTERNATIONAL BUILDING CODE (IBC).

2. ALL ATTIC VENTILATION SHALL BE PERFORMED IN ACCORDANCE WITH THE LATEST EDITIONS OF THE INTERNATIONAL BUILDING CODE (IBC).

3. ALL ATTIC VENTILATION SHALL BE PERFORMED IN ACCORDANCE WITH THE LATEST EDITIONS OF THE INTERNATIONAL BUILDING CODE (IBC).

4. ALL ATTIC VENTILATION SHALL BE PERFORMED IN ACCORDANCE WITH THE LATEST EDITIONS OF THE INTERNATIONAL BUILDING CODE (IBC).

5. ALL ATTIC VENTILATION SHALL BE PERFORMED IN ACCORDANCE WITH THE LATEST EDITIONS OF THE INTERNATIONAL BUILDING CODE (IBC).

GENERAL NOTES:

1. ALL GENERAL NOTES SHALL BE PERFORMED IN ACCORDANCE WITH THE LATEST EDITIONS OF THE INTERNATIONAL BUILDING CODE (IBC).

2. ALL GENERAL NOTES SHALL BE PERFORMED IN ACCORDANCE WITH THE LATEST EDITIONS OF THE INTERNATIONAL BUILDING CODE (IBC).

3. ALL GENERAL NOTES SHALL BE PERFORMED IN ACCORDANCE WITH THE LATEST EDITIONS OF THE INTERNATIONAL BUILDING CODE (IBC).

4. ALL GENERAL NOTES SHALL BE PERFORMED IN ACCORDANCE WITH THE LATEST EDITIONS OF THE INTERNATIONAL BUILDING CODE (IBC).

5. ALL GENERAL NOTES SHALL BE PERFORMED IN ACCORDANCE WITH THE LATEST EDITIONS OF THE INTERNATIONAL BUILDING CODE (IBC).

CONTRACTOR & OWNER SHALL VERIFY ALL DIMENSIONS, AREAS AND CONDITIONS. READ ALL NOTES AND BECOME THOROUGHLY FAMILIAR WITH THE DRAWINGS PRIOR TO CONSTRUCTION.

MARK	DATE	DESCRIPTION

PROJECT NO: Parkinson 1
DATE: 8/9/2018
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SHEET TITLE
COVER SHEET

A-1
SHEET 1 OF 15

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P.E.**

**Kevin &
Collette
Parkinson**

**6523 N
NorthFork
Road
Liberty UT**


MARK	DATE	DESCRIPTION

PROJECT NO: **Parkinson 1**
DATE: **8/9/2018**
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SHEET TITLE
Footings Plan

A-2
SHEET 2 OF 15

NOTE:
- Top of Footing to be
Min. 3'-6" Below Grade.
-All Footings to be F-3
(24"x10") unless noted
otherwise.

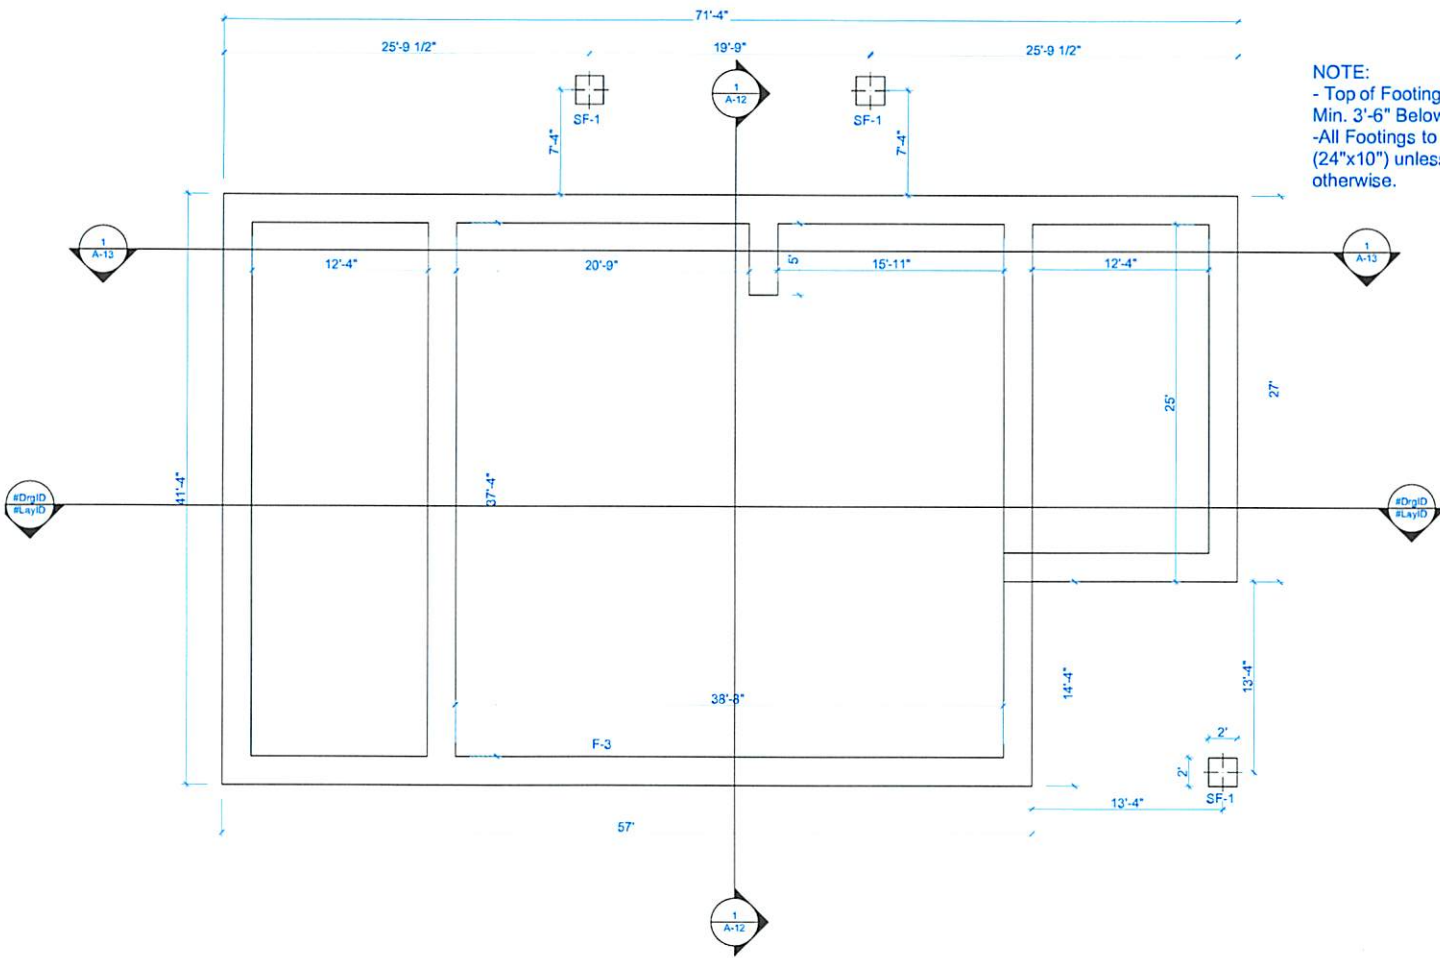

1 Footings
SCALE: 1/4" = 1'-0"

CONTRACTOR & OWNER SHALL VERIFY ALL DIMENSIONS, AREA, AND CONDITIONS. READ ALL NOTES AND BECOME THOROUGHLY FAMILIAR WITH THE DRAWINGS PRIOR TO CONSTRUCTION.


GENERAL NOTES
1. Construction shall be in accordance with the approved plans and specifications. The contractor shall be responsible for obtaining all necessary permits and approvals. The contractor shall be responsible for maintaining access to all adjacent properties and utilities. The contractor shall be responsible for protecting all existing structures and utilities. The contractor shall be responsible for maintaining the site in a safe and sanitary condition at all times. The contractor shall be responsible for removing all construction materials and equipment from the site upon completion of the project. The contractor shall be responsible for restoring the site to its original condition or better.

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Collette
Parkinson

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Liberty UT

METAL W/3/8" DIA CONNECTION STUDS			
NO.	DESCRIPTION	QUANTITY	REMARKS
1	3/8" DIA CONNECTION STUDS	12	
2	3/8" DIA CONNECTION STUDS	12	
3	3/8" DIA CONNECTION STUDS	12	
4	3/8" DIA CONNECTION STUDS	12	
5	3/8" DIA CONNECTION STUDS	12	
6	3/8" DIA CONNECTION STUDS	12	
7	3/8" DIA CONNECTION STUDS	12	
8	3/8" DIA CONNECTION STUDS	12	
9	3/8" DIA CONNECTION STUDS	12	
10	3/8" DIA CONNECTION STUDS	12	
11	3/8" DIA CONNECTION STUDS	12	
12	3/8" DIA CONNECTION STUDS	12	

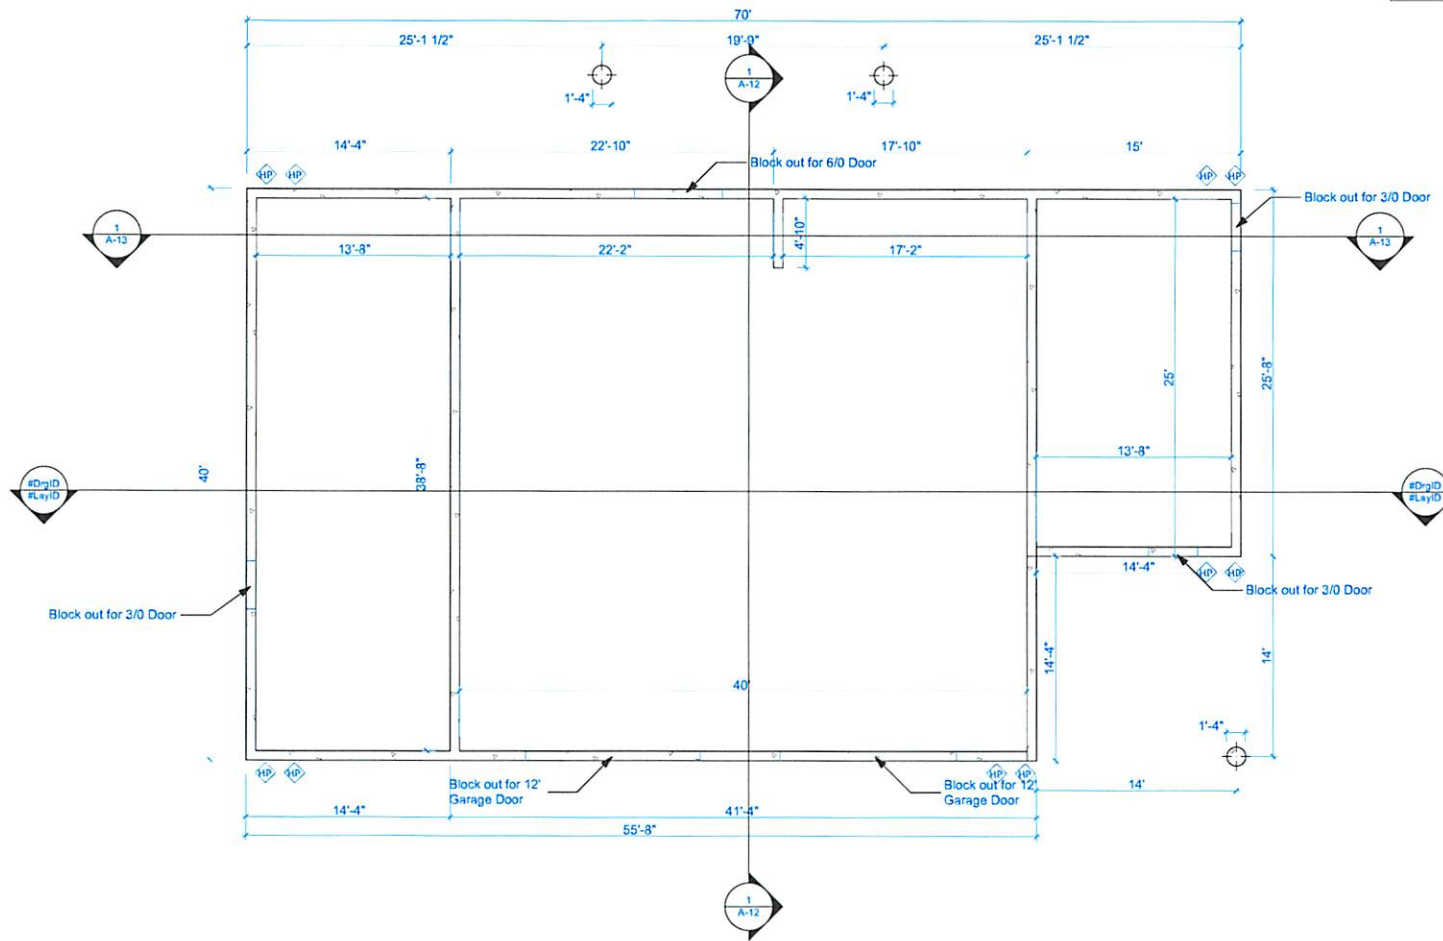

1 Foundation
SCALE: 1/4" = 1'-0"

CONTRACTOR & OWNER SHALL VERIFY ALL DIMENSIONS, AREAS, AND CONDITIONS. READ ALL NOTES AND BECOME THOROUGHLY FAMILIAR WITH THE DRAWINGS PRIOR TO CONSTRUCTION.

GENERAL NOTES:
1. CONTRACTOR SHALL VERIFY ALL DIMENSIONS, AREAS, AND CONDITIONS. READ ALL NOTES AND BECOME THOROUGHLY FAMILIAR WITH THE DRAWINGS PRIOR TO CONSTRUCTION.

MARK	DATE	DESCRIPTION

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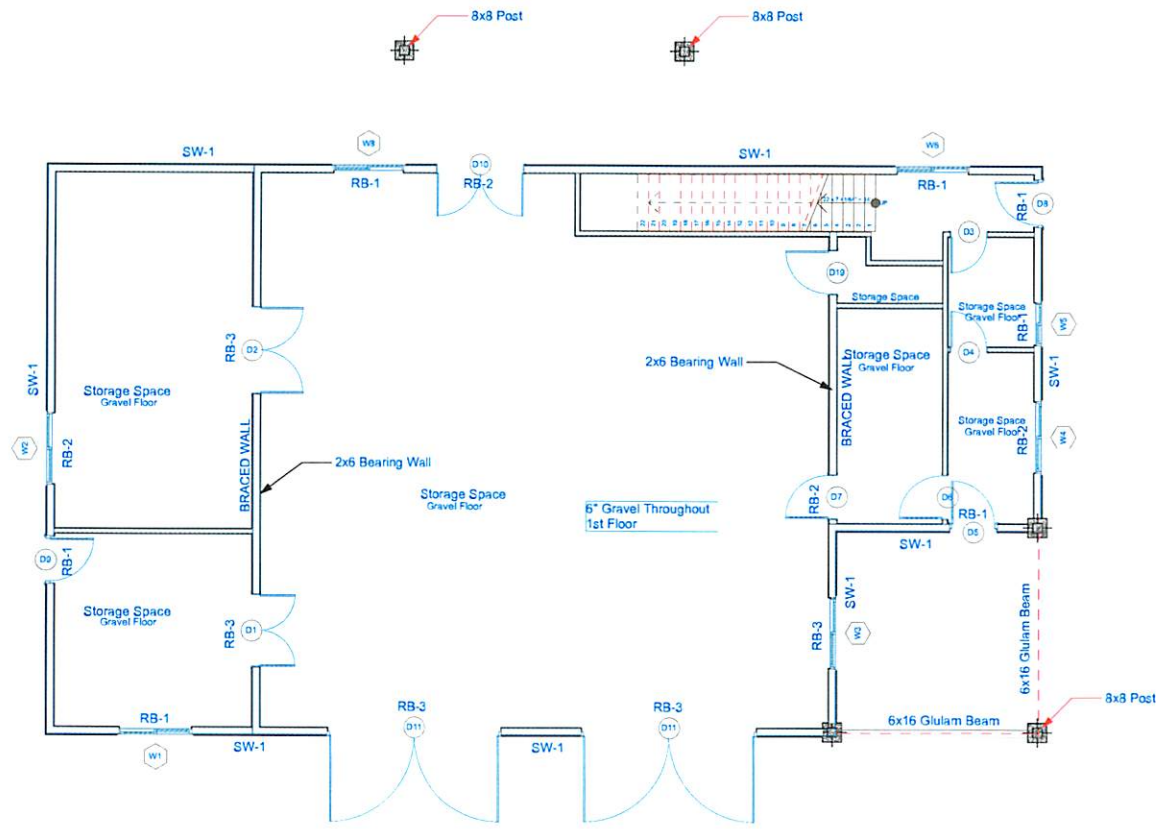
SHEET TITLE
Foundation Plan

A-3
SHEET 3 OF 15

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C:\Users\Brett\Desktop\Brett Side Work\Kevin P Barn\Kevin P Barn Empty.ph

WOOD DIMENSIONS TABLE		
NO.	DESCRIPTION	THICKNESS
1	2x6	1 1/2"
2	2x8	1 1/2"
3	2x10	1 1/2"
4	2x12	1 1/2"
5	4x12	1 1/2"
6	6x16	1 1/2"
7	8x8	8"
8	8x10	10"
9	8x12	12"
103	8x200	200"



NOTE: 12'X12' GARAGE DOORS TO BE FOUND AT...
 WWW.REALCARRAGEDOORS.COM
 COORDINATE WITH OWNER FOR MODEL AND FEATURES.

1 1st FLOOR Structural
 SCALE: 1/4" = 1'-0"



CONTRACTOR & OWNER SHALL VERIFY CONDITIONS. READ ALL NOTES AND BECOME THOROUGHLY FAMILIAR WITH THE DRAWINGS PRIOR TO CONSTRUCTION.

GENERAL NOTES
 1. CONDITIONS WILL BE AS SHOWN UNLESS OTHERWISE NOTED.
 2. ALL DIMENSIONS ARE TO FACE UNLESS OTHERWISE NOTED.
 3. ALL MATERIALS SHALL BE AS SHOWN UNLESS OTHERWISE NOTED.
 4. ALL WORK SHALL BE IN ACCORDANCE WITH THE LATEST EDITIONS OF THE U.S. BUILDING CODE AND ALL APPLICABLE LOCAL ORDINANCES.
 5. THE CONTRACTOR SHALL BE RESPONSIBLE FOR OBTAINING ALL NECESSARY PERMITS AND APPROVALS FROM THE LOCAL AUTHORITIES.
 6. THE CONTRACTOR SHALL BE RESPONSIBLE FOR PROTECTING ALL EXISTING UTILITIES AND STRUCTURES.
 7. THE CONTRACTOR SHALL BE RESPONSIBLE FOR MAINTAINING ACCESS TO ALL ADJACENT PROPERTIES.
 8. THE CONTRACTOR SHALL BE RESPONSIBLE FOR THE PROTECTION AND REPAIR OF ALL EXISTING UTILITIES AND STRUCTURES.
 9. THE CONTRACTOR SHALL BE RESPONSIBLE FOR THE PROTECTION AND REPAIR OF ALL EXISTING UTILITIES AND STRUCTURES.

Brett Kearl
 P.E.



Kevin & Collette
 Parkinson

6523 N
 NorthFork
 Road
 Liberty UT

MARK	DATE	DESCRIPTION

PROJECT NO: Parkinson 1
 DATE: 8/9/2018
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SHEET TITLE
 1st Floor
 Structural

A-5
 SHEET 5 OF 15

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Collette
Parkinson

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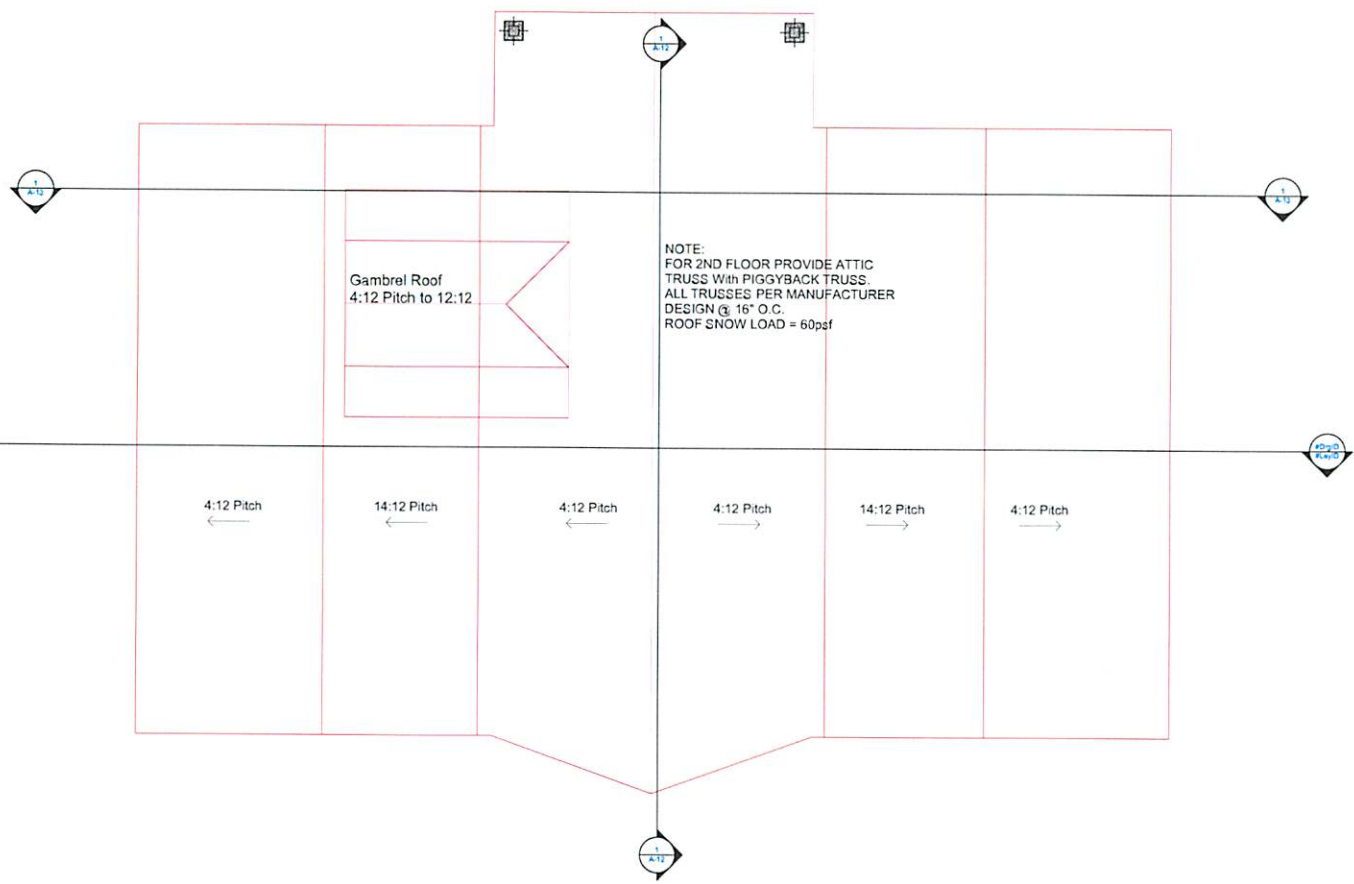
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SHEET TITLE
ROOF PLAN

A-9

SHEET 9 OF 15




1 Roof
 SCALE 1/4" = 1'-0"




CONTRACTOR & OWNER SHALL VERIFY ALL DIMENSIONING, AREA'S AND CONDITIONS. READ ALL NOTES AND BECOME THOROUGHLY FAMILIAR WITH THE DRAWINGS PRIOR TO CONSTRUCTION.

GENERAL NOTES
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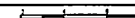
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② NORTH ELEVATION
SCALE 3/4" = 1'-0"

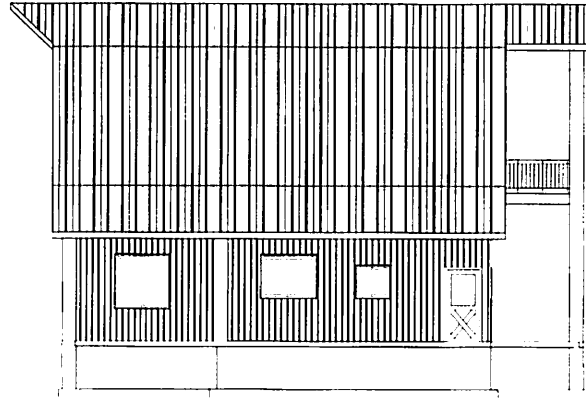

① WEST ELEVATION
SCALE 3/4" = 1'-0"

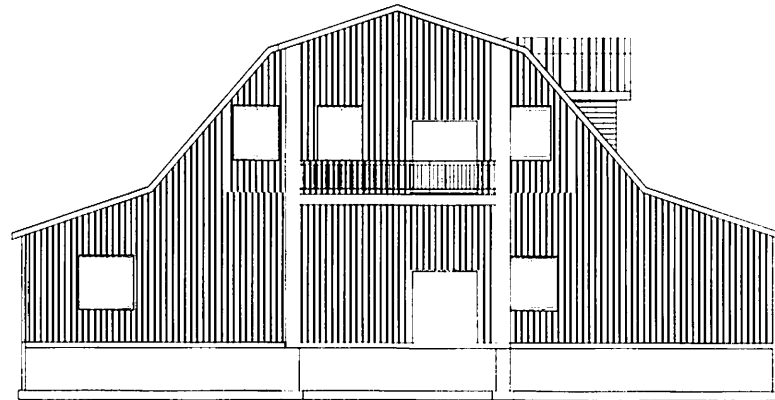

CONTRACTOR & OWNER SHALL VERIFY ALL DIMENSIONS, AREAS, AND CONDITIONS. READ ALL NOTES AND BECOME THOROUGHLY FAMILIAR WITH THE DRAWING PRIOR TO CONSTRUCTION.

GENERAL NOTES

1. THE CONTRACTOR SHALL VERIFY ALL DIMENSIONS, AREAS, AND CONDITIONS. READ ALL NOTES AND BECOME THOROUGHLY FAMILIAR WITH THE DRAWING PRIOR TO CONSTRUCTION.

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MARK	DATE	DESCRIPTION


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SHEET TITLE
ELEVATIONS



A-10

SHEET 10 OF 15

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2 SOUTH ELEVATION
SCALE 3/4" = 1'-0"

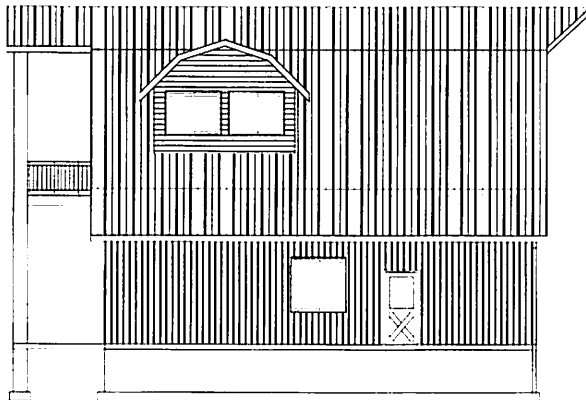

1 EAST ELEVATION
SCALE 3/4" = 1'-0"

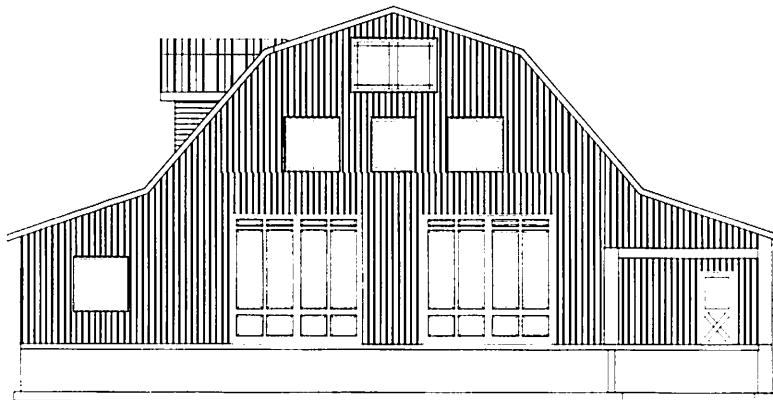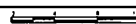

CONTRACTOR & OWNER SHALL VERIFY ALL DIMENSIONS, AREA, AND CONDITIONS. READ ALL NOTES AND BECOME THOROUGHLY FAMILIAR WITH THE DRAWINGS PRIOR TO CONSTRUCTION.

GENERAL NOTES
1. THE CONTRACTOR SHALL VERIFY ALL DIMENSIONS, AREA, AND CONDITIONS. READ ALL NOTES AND BECOME THOROUGHLY FAMILIAR WITH THE DRAWINGS PRIOR TO CONSTRUCTION.

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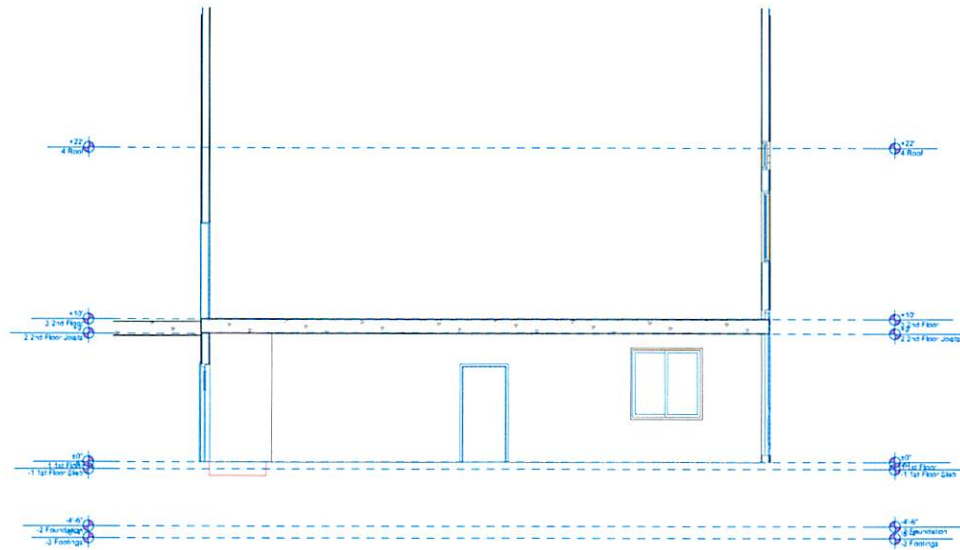
MARK	DATE	DESCRIPTION

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DATE 8/9/2018
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SHEET TITLE
ELEVATIONS

A-11
SHEET 11 OF 15

C:\Users\Brett\Desktop\Brett_Sds_Work\Kevin P. Bum\Kevin P. Bum_Enrty.dwg



1 SECTION
SCALE 1/4" = 1'-0"



Brett Kearl
P.E.



Kevin &
Collette
Parkinson

6523 N
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DATE	BY	DESCRIPTION
		PRELIMINARY

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SHEET TITLE
SECTION 1

A-12
SHEET 12 OF 15

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Kevin &
Collette
Parkinson

6523 N
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Liberty UT

DATE	BY	REVISION

PROJECT NO: Parkinson 1
DATE: 8/9/2018
DRAWN BY: Brett Kearl P.E.
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SHEET TITLE
DETAILS

A-15
SHEET 15 OF 15

DOOR SCHEDULE						
ID	TYPE	W	HT	THK	MATL	NOTES
D1	---	5'	6'-8"	0-1 1/4"	---	---
D2	---	6'	6'-8"	0-1 1/4"	---	---
D3	---	2'-4"	6'-8"	0-1 1/4"	---	---
D4	---	2'-4"	6'-8"	0-1 1/4"	---	---
D5	---	3'	6'-8"	0-1 1/4"	---	---
D6	---	3'	6'-8"	0-1 1/4"	---	---
D7	---	3'	6'-8"	0-1 1/4"	---	---
D8	---	3'	6'-8"	0-1 1/4"	---	---
D9	---	3'	6'-8"	0-1 1/4"	---	---
D10	---	6'	6'-8"	0-1 1/4"	---	---
D11	---	12'	12'	0-1 1/4"	---	---
D12	---	6'	6'-8"	0-1 1/4"	---	---
D13	---	3'	6'-8"	0-1 1/4"	---	---
D14	---	3'	6'-8"	0-1 1/4"	---	---

1 Door Schedule

WINDOW SCHEDULE				
ID	SIZE	TYPE	NOTES	
	WIDTH HEIGHT			
W1	5' 0" 8' 0"	---	---	---
W2	5' 0" 8' 0"	---	---	---
W3	5' 0" 8' 0"	---	---	---
W4	5' 0" 4' 0"	---	---	---
W5	3' 0" 2' 0"	---	---	---
W6	5' 0" 8' 0"	---	---	---
W7	5' 0" 8' 0"	---	---	---
W8	5' 0" 8' 0"	---	---	---
W9	4' 0" 8' 0"	---	---	---
W10	5' 0" 4' 0"	---	---	---
W11	5' 0" 8' 0"	---	---	---
W12	4' 0" 8' 0"	---	---	---
W13	4' 0" 8' 0"	---	---	---
W14	4' 0" 8' 0"	---	---	---

2 Window Schedule

CONCRETE FOOTING SCHEDULE											
NO.	TYPE	WALL	FOOTING	WALL THICKNESS	FOOTING THICKNESS	FOOTING WIDTH	FOOTING DEPTH	FOOTING AREA	FOOTING PERIMETER	FOOTING VOLUME	FOOTING WEIGHT
1	---	---	---	---	---	---	---	---	---	---	---
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METAL WALL SHEATHING SCHEDULE			
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WOOD SHIMMER SCHEDULE			
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