


- Legend**
(Note: All items may not appear on drawing)
- San. Sewer Manhole
 - Water Manhole
 - Storm Drain Manhole
 - Electrical Manhole
 - Catch Basins
 - Exist. Fire Hydrant
 - Fire Hydrant
 - Exist. Water Valve
 - Water Valve
 - Sanitary Sewer
 - Gullinary Water
 - Gas Line
 - Irrigation Line
 - Storm Drain
 - Telephone Line
 - Secondary Waterline
 - Power Line
 - Fire Line
 - Land Drain
 - Power pole
 - Power pole w/guy
 - Light Pole
 - Fence
 - Flowline of ditch
 - Overhead Power line
 - Corrugated Metal Pipe
 - Concrete Pipe
 - Reinforced Concrete Pipe
 - Ductile Iron
 - Polyvinyl Chloride
 - Top of Asphalt
 - Edge of Asphalt
 - Centerline
 - Flowline
 - Finish Floor
 - Top of Curb
 - Top of Wall
 - Top of Walk
 - Top of Concrete
 - Natural Ground
 - Finish Contour
 - Exist. Contour
 - Finish Grade
 - Exist. Grade
 - Ridge Line
 - Direction of Flow
 - Existing Asphalt
 - New Asphalt
 - Heavy Duty Asphalt
 - Concrete
 - Open Face
 - Curb & Gutter

Turnaround at Boundary Between Phase 6 and Phase 7

<p>GREAT BASIN ENGINEERING 5746 SOUTH 1475 EAST, SUITE 200, SALT LAKE CITY, UTAH 84143 WWW.GREATBASINENGINEERING.COM</p>	<p>Ph. 6 Turnaround Exhibit</p> <p>The Chalets at Ski Lake No. 6</p> <p><small>A part of the Southwest 1/4 of Section 13, a part of the Northeast 1/4 of Section 23, and a part of the Northwest 1/4 of Section 24, 1/4 of Section 23, and a part of the Northwest 1/4 of Section 24,</small></p>
	<p>Jan, 2012</p> <p>SHEET NO.</p> <p>2a-T</p> <p><small>96N120 Waterline</small></p>

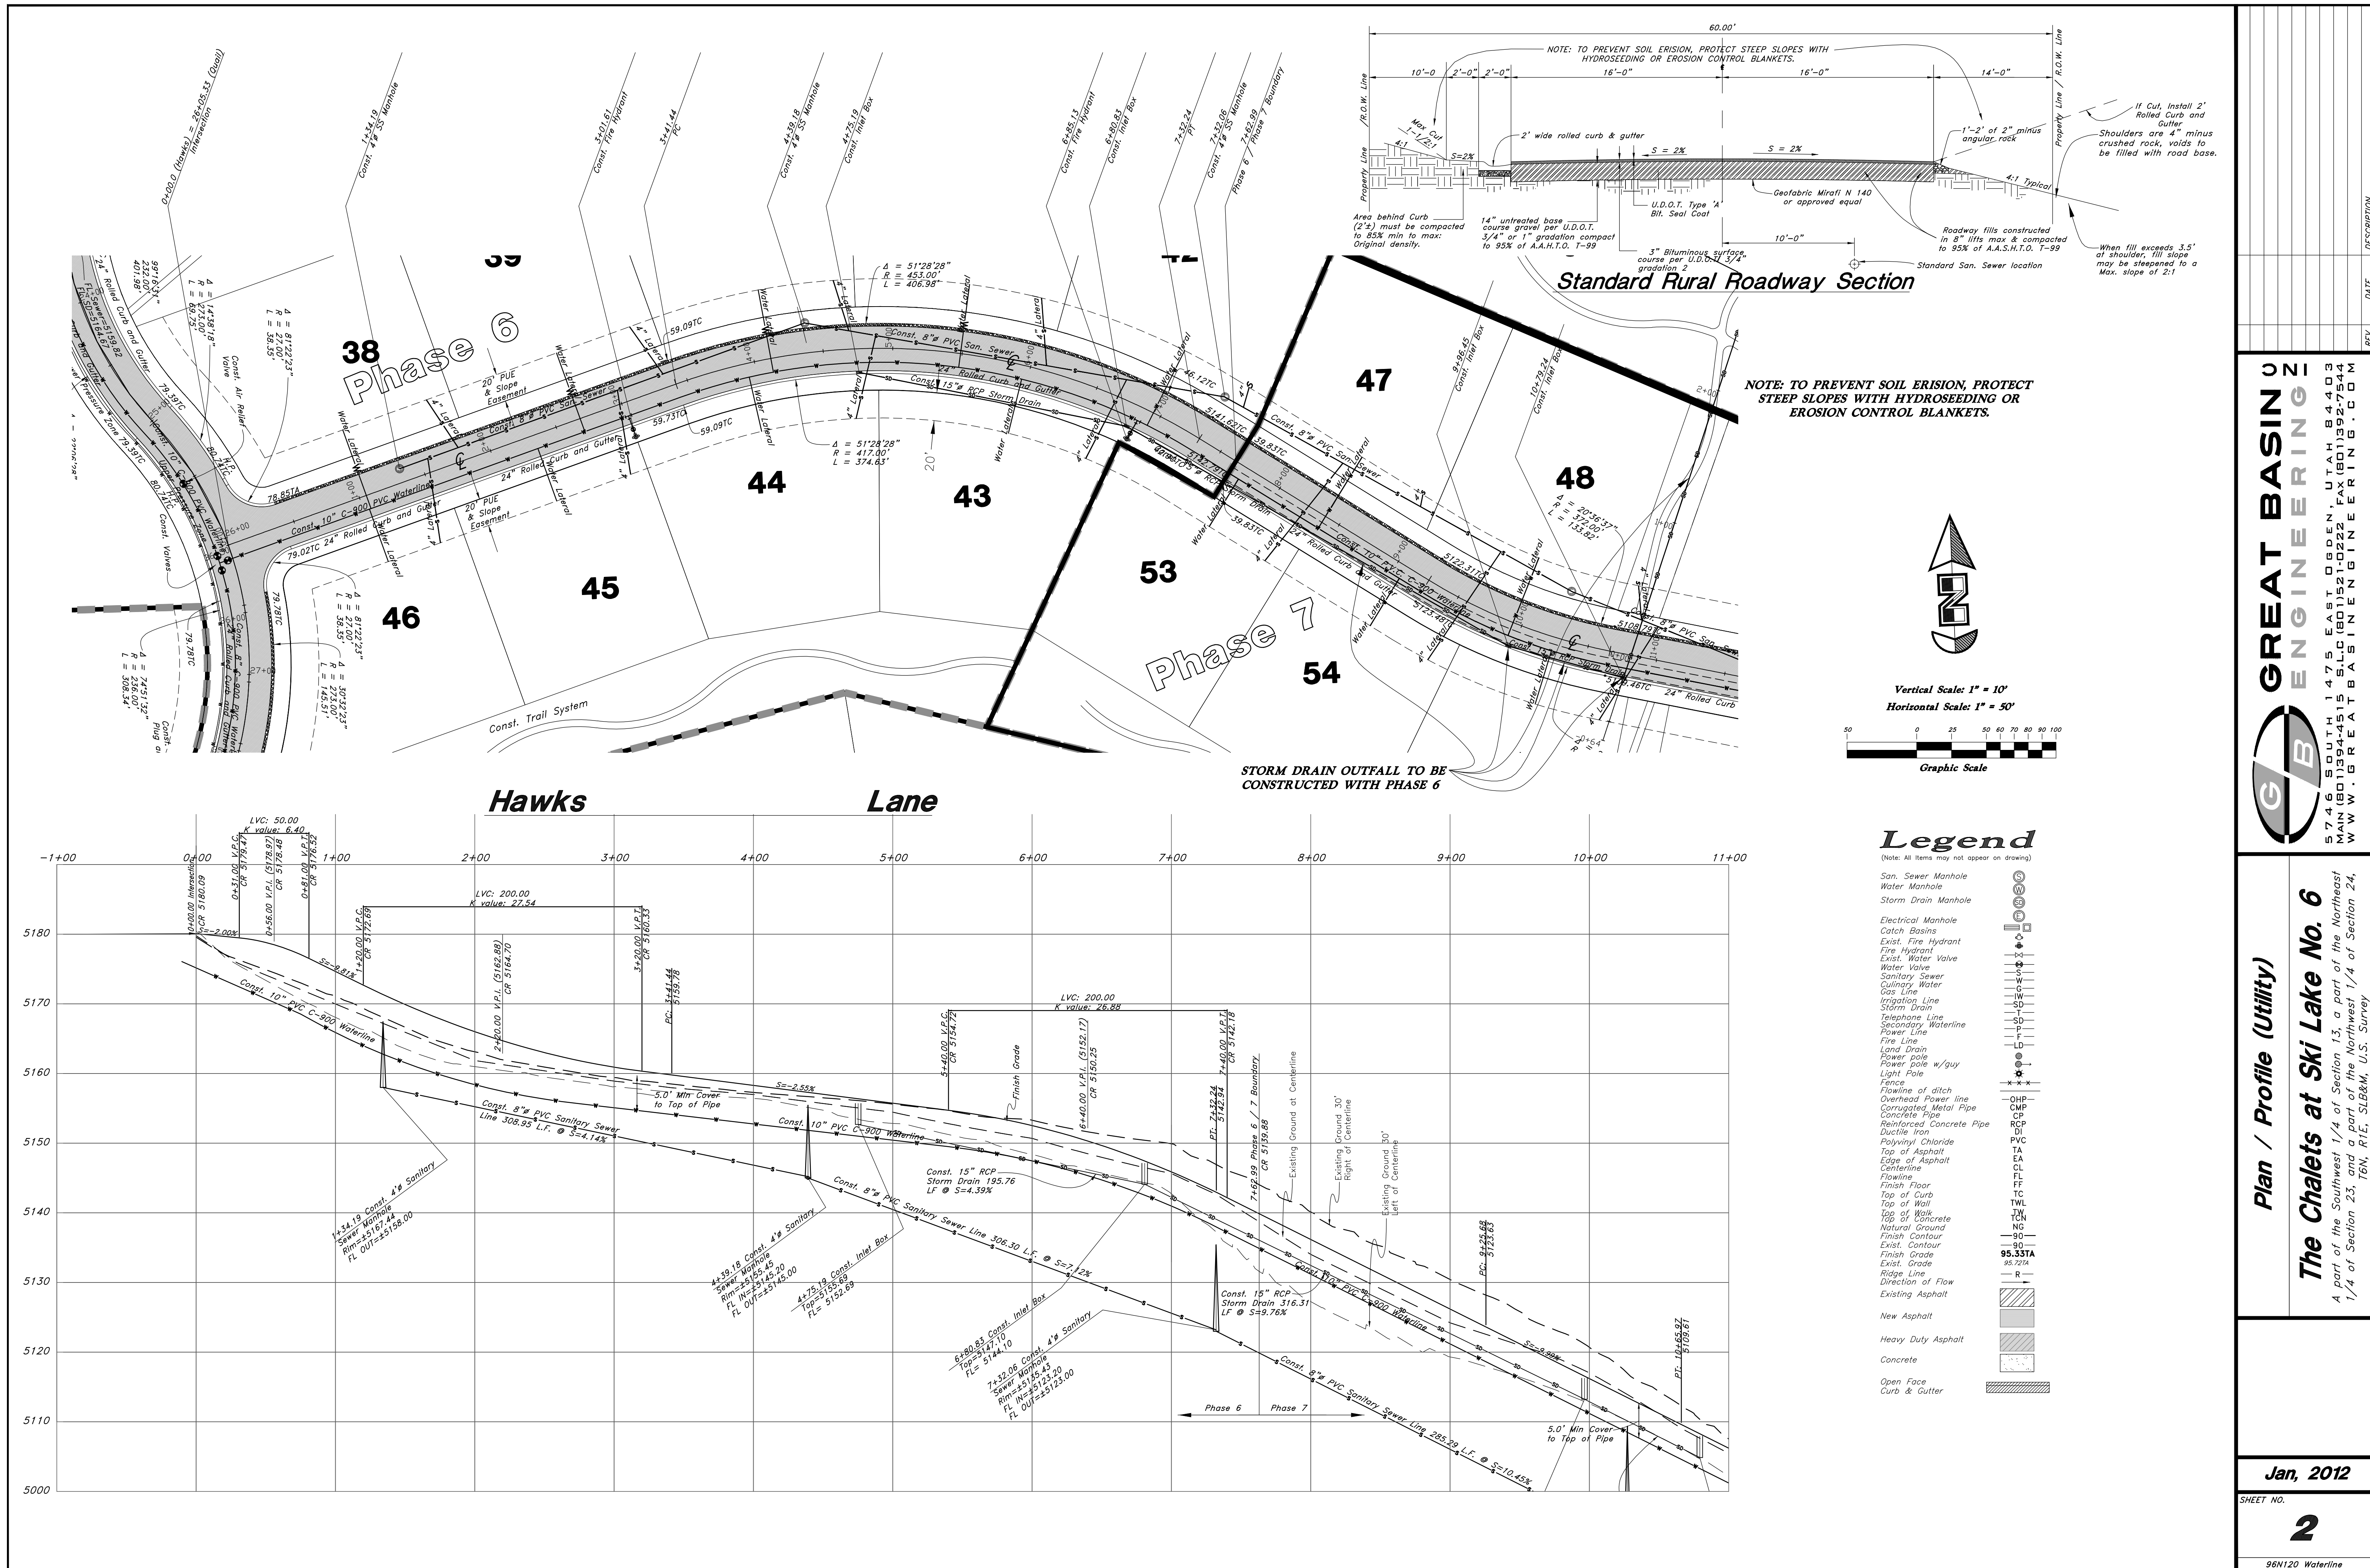

GREAT BASIN ENGINEERING


5746 SOUTH 1475 EAST, OGDEN, UTAH 84403
 4044 15th Street, Salt Lake City, Utah 84143
 WWW.GREATBASINENGINEERING.COM

Plan / Profile (Utility)


The Chalets at Ski Lake No. 6

A part of the Southwest 1/4 of Section 13, a part of the Northeast 1/4 of Section 23, and a part of the Northwest 1/4 of Section 24, 1/4 of Section 23, and a part of the Northwest 1/4 of Section 24,

W:\96n120 - Chalets\dwg\Phase 6\96n120 ph6 PP1-12.dwg, 12/13/2012 8:20:58 AM, ryanb,

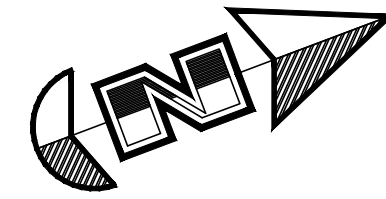


Vertical Scale: 1" = 10'
Horizontal Scale: 1" = 50'

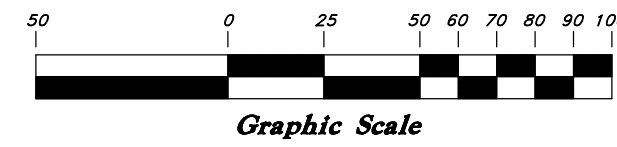

Legend

(Note: All items may not appear on drawing)


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- Finish Grade
- Exist. Grade
- Ridge Line
- Direction of Flow
- Existing Asphalt
- New Asphalt
- Heavy Duty Asphalt
- Concrete
- Open Face
- Curb & Gutter

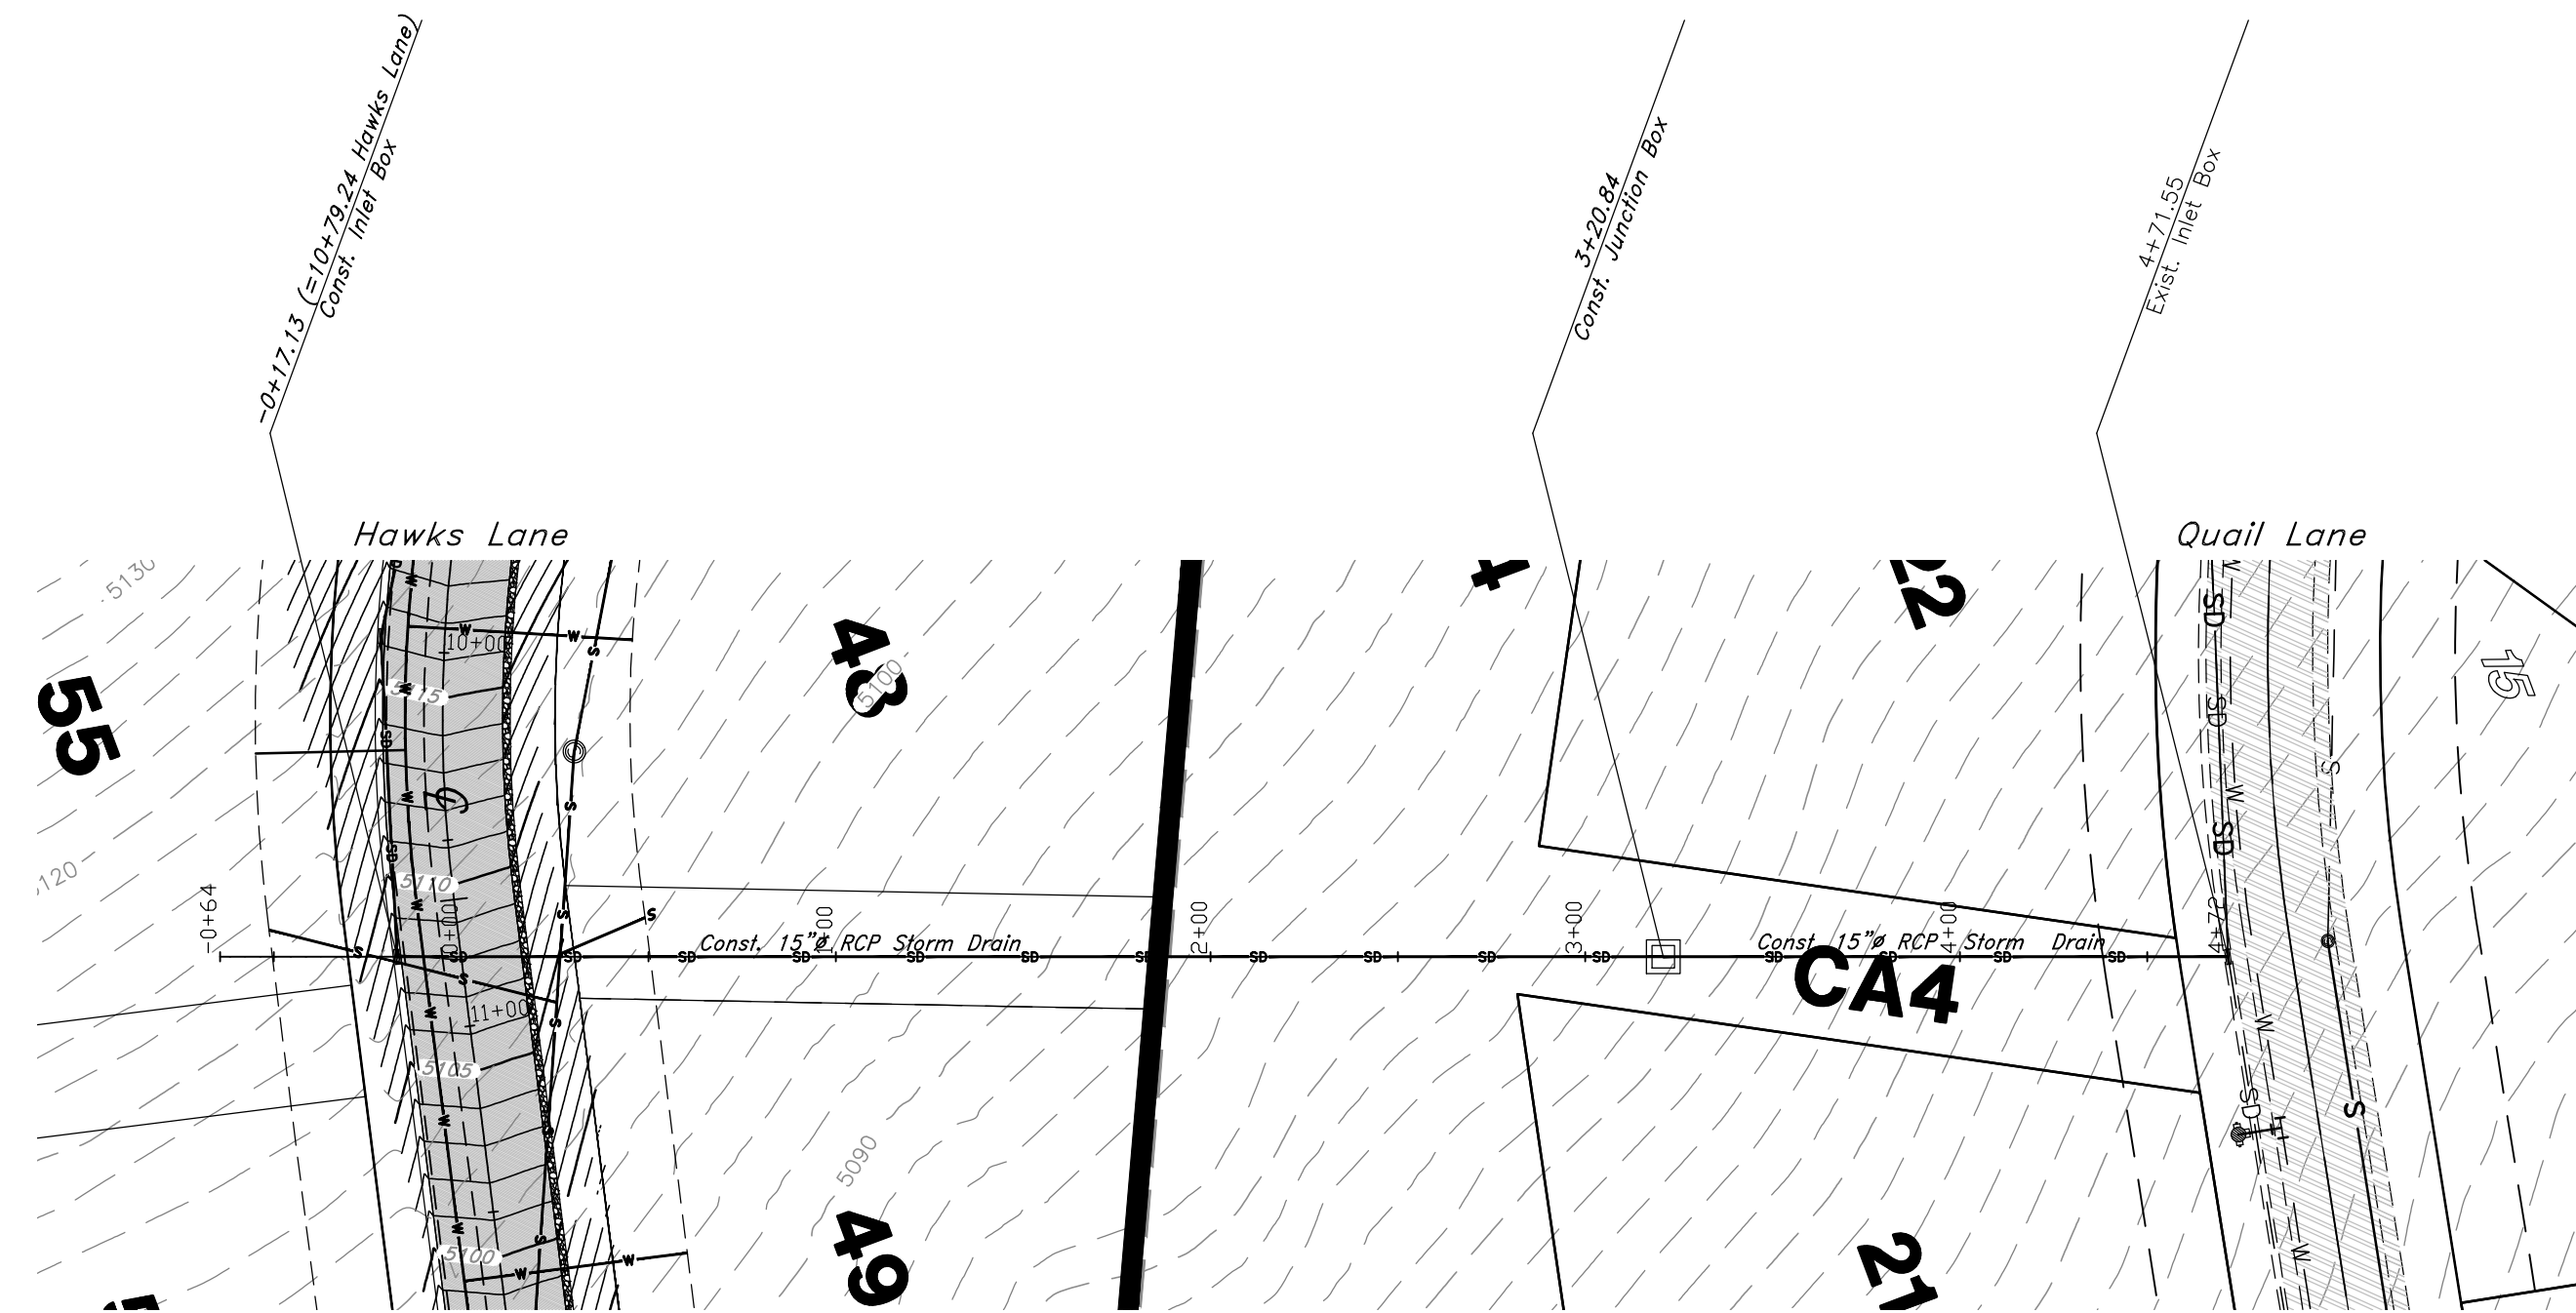

Benchmark: Monument at
Intersection of Quail Lane and
Meadow Lark Lane
Elevation: 5022.34

NOTE: TO PREVENT SOIL EROSION, PROTECT
STEEP SLOPES WITH HYDROSEEDING OR
EROSION CONTROL BLANKETS.

Storm Drain Outfall

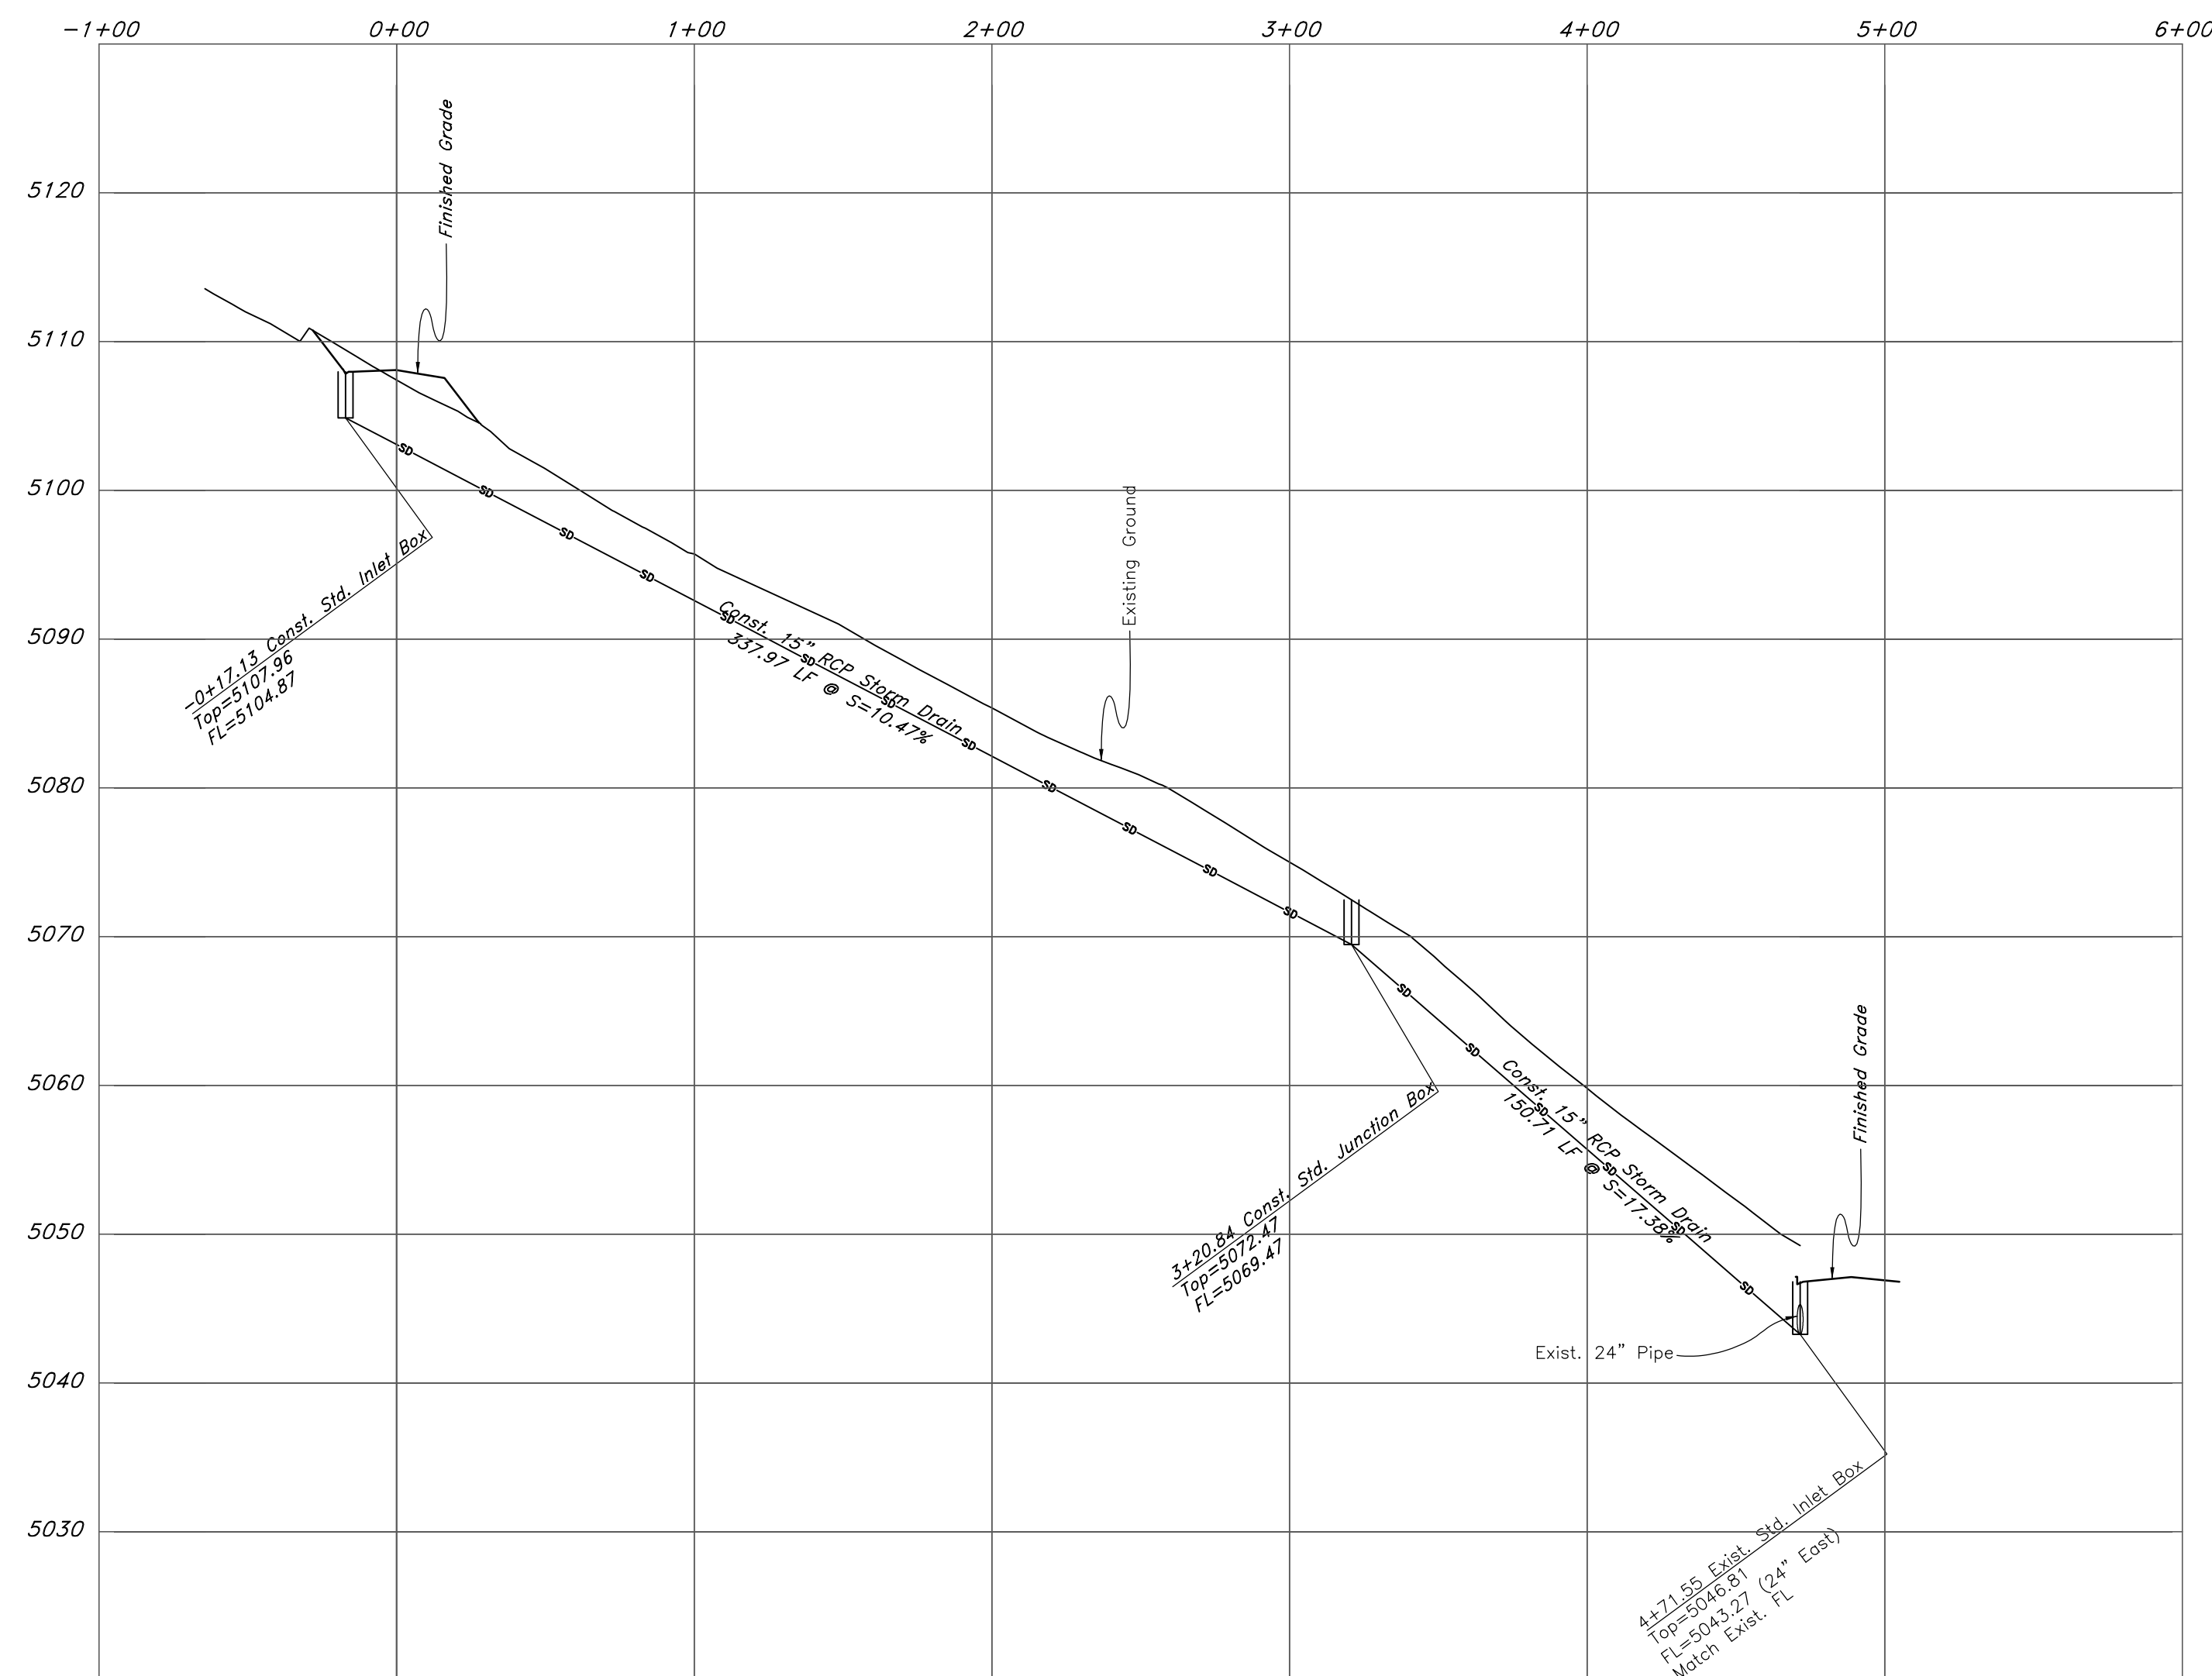

REV	DATE	DESCRIPTION

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Storm Drain Outfall

The Chalets at Ski Lake No. 6

A part of the Southwest 1/4 of Section 13, a part of the Northeast 1/4 of Section 23, and a part of the Northwest 1/4 of Section 24, T6N, R1E, S18&M, U.S. Survey

Jan, 2012

SHEET NO.
2b