
VICINITY MAP **BOUNDARY DESCRIPTION** NOT TO SCALE THE RIDGE TOWNHOMES PHASE 3 A PART OF THE NORTHEAST QUARTER OF SECTION 27, TOWNSHIP 7 NORTH, RANGE 1 EAST OF THE SALT LAKE BASE AND MERIDIAN. MORE PARTICULARLY DESCRIBED AS FOLLOWS: BEGINNING AT THE NORTHEASTERLY MOST CORNER OF THE RIDGE TOWNHOMES PHASE 1 BEING LOCATED SOUTH A PLANNED RESIDENTIAL UNIT DEVELOPMENT (P.R.U.D) 89°09'42" EAST 1091.39 FEET ALONG THE NORTH LINE OF SAID NORTHEAST QUARTER AND SOUTH 0°00'00" EAST 131.97 FEET FROM THE NORTHWEST CORNER OF SAID NORTHEAST QUARTER: RUNNING THENCE SOUTH 85°41'53" EAST PART OF THE NORTHEAST 1/4 OF SECTION 27 501.78 FEET TO THE EXTENSION OF THE SOUTHERLY BOUNDARY OF ELKHORN SUBDIVISION, PHASE 2, LOTS 24 THROUGH 28 AMENDED: THENCE ALONG SAID BOUNDARY LINE AND ITS EXTENSION SOUTH 89°07'48" EAST 256.48 FEET T7N, R1E, SLB & M, US SURVEY TO THE WESTERLY BOUNDARY OF EAGLES LANDING AT WOLF CREEK SUBDIVISION PHASE 1; THENCE ALONG SAID BOUNDARY ALONG THE ARC OF A CURVE TO THE LEFT 54.77 FEET, HAVING A RADIUS OF 40.00 FEET, A CENTRAL WEBER COUNTY, UTAH ANGLE OF 78°27'04", AND WHICH CHORD BEARS SOUTH 0°32'31" WEST 50.59 FEET; THENCE SOUTH 0°00'00" WEST 167.52 NORTHWEST CORNER OF NORTHEAST FEET; THENCE NORTH 90°00'00" WEST 329.11 FEET; THENCE ALONG THE ARC OF A CURVE TO THE RIGHT 48.42 FEET, QUARTER OF SECTION 27, SEPTEMBER 2016 HAVING A RADIUS OF 430.00 FEET, A CENTRAL ANGLE OF 6°27'06", AND WHICH CHORD BEARS NORTH 86°46'27" WEST T7N, R1E, SLB&M (WEBER CO. BRASS CAP - 1981, GOOD COND) HAVING A RADIUS OF 447.77 FEET, A CENTRAL ANGLE OF 8°01'11", AND WHICH CHORD BEARS NORTH 87' S89°09'42"E BASIS OF BEARING (STATE PLANE GRID BEARING PER WEBER COUNTY) 2656.14' MEASURED (2655.88 RECORD) BRASS CAP - 2007, GOOD COND) S89°09'42"E 1091.39' SITE BENCHMARK 5187.58 (ASSUMED) FEET TO THE BOUNDARY OF SAID RIDGE TOWNHOMES PHASE 1: THENCE ALONG SAID BOUNDARY NORTH 42°52'41 EAST 89.68 FEET TO THE POINT OF BEGINNING. CONTAINING 5.89 ACRES, MORE OR LESS. SURVEYOR'S CERTIFICATE KLINT H. WHITNEY, DO HEREBY CERTIFY THAT I AM A LICENSED PROFESSIONAL LAND SURVEYOR IN THE STATE OF UTAH , L=54.77, R=40.00 Δ=78°27'04" CH=S0° 32' 31"W 50.59' AND THAT I HOLD CERTIFICATE NO. 8227228 IN ACCORDANCE WITH TITLE 58. CHAPTER 22. OF THE PROFESSIONAL S85°41'53"E 501.78' ENGINEERS AND LAND SURVEYORS ACT: I FURTHER CERTIFY THAT BY AUTHORITY OF THE OWNERS I HAVE COMPLETED A SURVEY OF THE PROPERTY AS SHOWN AND DESCRIBED ON THIS PLAT IN ACCORDANCE WITH SECTION 17-23-20 AND HAVE VERIFIED ALL MEASUREMENTS: THAT THE REFERENCE MONUMENTS SHOWN HEREON ARE LOCATED AS INDICATED AND ARE S89°07'48"E 256.48' SUFFICIENT TO RETRACE OR REESTABLISH THIS PLAT; AND THAT THE INFORMATION SHOWN HEREIN IS SUFFICIENT TO **CLUB HOUSE** ACCURATELY ESTABLISH THE LATERAL BOUNDARIES OF THE HEREIN DESCRIBED TRACT OF REAL PROPERTY; AND THAT THIS PLAT OF: THE RIDGE TOWNHOMES PHASE 3 EAGLE CREST CT. THE RIDGE TOWNHOMES PH2 N WEBER COUNTY, UTAH HAS BEEN DRAWN CORRECTLY TO THE DESIGNATED SCALE AND IS A TRUE AND CORREC⁻ HE RIDGE TOWNHOMES PH REPRESENTATION OF THE HEREIN DESCRIBED LANDS INCLUDED IN SAID SUBDIVISION. BASED UPON DATA COMPILED FROM POOL RECORDS IN THE WEBER COUNTY RECORDERS OFFICE; I FURTHER CERTIFY THAT THE REQUIREMENTS OF ALL APPLICABLE N42°52'45"E N62°48'50"E STATUTES AND ORDINANCES OF WEBER COUNTY CONCERNING ZONING REQUIREMENTS REGARDING LOT MEASUREMENTS HAVE BEEN COMPLIED WITH. N12°55'59"W S89°13'42"E 26.79' S86°56'20"E 93.96' L=134.29, R=170.00 N22°36'29"E Δ=45°15'35" CH=S69° 45' 00"E 130.82' L=66.28. R=430.00 Δ=8°49'53" CH=S87° 57' 51"E 66.21 Klint H COMMON AREA "B" N3°20'54"E 102.35' 329.11 L=45.04, R=399.23 N87°37'13"E Δ=6°27'51" CH=S86° 46' 27"E 45.02' N90°00'00"E 102.35' SIGNED THIS L=61.66, R=400.00 329.11' KLINT H. WHITNEY, PLS NO. 8227228 -∆=8°49'53" CH=S87° 57' 51"E 61.59' AREA "C" MOOSE HOLLOW DRIVE S87°37'13"W 102.35 N90°00'00"W 329.11' OWNER'S DEDICATION L=55.14, R=230.00 Δ=13°44'12" CH=N85° 30' 41"W 55.01' L=62.67, R=447.77 L=48.42, R=430.00 Δ=8°01'11" CH=N87° 33' 29"W 62.62' Δ=6°27'06" CH=N86° 46' 27"W 48.39' RIDGE UTAH DEVELOPMENT CORPORATION (RUDC) AS OWNER OF THE TRACT OF LAND DESCRIBED HEREON, AND AS DECLARANT OF THAT CERTAIN PROJECT KNOWN AS THE RIDGE TOWNHOMES PHASE 3. HEREBY DEDICATES TO PUBLIC USE ALL THOSE PARTS OR PORTIONS OF SAID TRACT OF LAND DESIGNATED AS PUBLIC STREETS, THE SAME EDEN VALLEY DEVELOPMENT LLC 22-282-0001 TO BE USED AS PUBLIC THOROUGHFARES, RUDC FURTHER DEDICATES AND RESERVES UNTO ITSELF, INCLUDING ITS GRANTEES. SUCCESSORS AND ASSIGNS. A RIGHT-OF-WAY TO BE USED IN COMMON WITH ALL OTHERS WITHIN SAID PROJECT (AND THOSE ADJOINING PROJECTS OR SUBDIVISIONS THAT MAY BE SUBDIVIDED BY SAID COMMON AREA "A" OWNER/DECLARANT, ITS SUCCESSORS OR ASSIGNS) ON, OVER AND ACROSS ALL THOSE PORTIONS OR PARTS OF SAID TRACT OF LAND DESIGNATED ON SAID PLAT AS PRIVATE STREETS AS ACCESS TO THE INDIVIDUAL LOTS/UNIT, TO LEGEND BE MAINTAINED BY THE RIDGE TOWNHOMES ASSOCIATION, WHICH SHALL BE GOVERNED IN ACCORDANCE WITH THE UTAH COMMUNITY ASSOCIATION ACT AND WHOSE MEMBERSHIP SHALL CONSIST OF THE OWNERS OF SAID **FUTURE DEVELOPMENT** LOTS/UNITS, THEIR GRANTEES, SUCCESSORS, OR ASSIGNS. RUDC ALSO GRANTS AND CONVEYS TO THE RIDGE TOWNHOMES ASSOCIATION ALL THOSE PARTS OR PORTIONS OF SAID TRACT OF LAND DESIGNATED AS COMMON WEBER COUNTY MONUMENT AS NOTED AREAS TO BE USED FOR RECREATIONAL AND OPEN SPACE PURPOSES FOR THE BENEFIT OF EACH RIDGE RIDGE UTAH DEVELOPMENT CORPORATION SET 24" REBAR AND CAP TOWNHOMES ASSOCIATION MEMBER IN COMMON WITH ALL OTHERS IN THE PROJECT. REMAINDER PARCEL MARKED GARDNER ENGINEERING 22-281-0003 RUDC GRANTS AND DEDICATES TO WEBER COUNTY A PERPETUAL EASEMENT ON AND OVER THE COMMON AREAS TO STREET MONUMENT GUARANTEE TO WEBER COUNTY THAT THE COMMON AREAS REMAIN OPEN AND UNDEVELOPED EXCEPT FOR APPROVED RECREATIONAL, PARKING AND OPEN SPACE PURPOSES. RUDC ALSO GRANTS AND DEDICATES TO WEBER SECTION LINE COUNTY A PERPETUAL EASEMENT FOR PROVIDING AND MAINTAINING CONSTRUCTION CUT AND/OR FILL SLOPES, FUTURE DEVELOPMENT LATERAL SUPPORT AND/OR PROPER DRAINAGE ADJACENT TO THE PUBLIC RIGHT-OF-WAY LOCATED WITHIN THE CENTERLINE RIGHT-OF-WAY LINE RUDC GRANTS AND DEDICATES A PERPETUAL RIGHT AND EASEMENT FOR PUBLIC UTILITY PURPOSES OVER, UPON NARRATIVE PROPERTY BOUNDARY ADDRESS TABLE __ _ _ _ BUILDING TIES A. STORM WATER DETENTION PONDS, DRAINAGE EASEMENTS AND CANAL MAINTENANCE EASEMENT THE SAME TO THE PURPOSE OF THIS SURVEY WAS TO CREATE A P.R.U.D SUBDIVISION PLAT BE USED FOR THE INSTALLATION MAINTENANCE AND OPERATION OF PUBLIC UTILITY SERVICE LINES, STORM AS SHOWN AND DESCRIBED HEREON. THE SURVEY WAS ORDERED BY JOHN | UNIT 502 DRAINAGE FACILITIES, IRRIGATION CANALS OR FOR THE PERPETUAL PRESERVATION OF WATER CHANNELS IN THEIR L. LEWIS. THE CONTROL USED TO ESTABLISH THE BOUNDARY WAS THE \mid UNIT 503 NATURAL STATE WHICHEVER IS APPLICABLE AS MAY BE AUTHORIZED BY THE GOVERNING AUTHORITY, WITH NO EXISTING WEBER COUNTY SURVEY MONUMENTATION SURROUNDING BUILDINGS OR STRUCTURES BEING ERECTED WITHIN SUCH EASEMENTS. SECTION 27, TOWNSHIP 7 NORTH, RANGE 1 EAST OF THE SALT LAKE BASE | UNIT 504 AND MERIDIAN. THE BASIS OF BEARING IS THE NORTH LINE OF THE | UNIT 601 B. PRIVATE OWNERSHIP WILL BE DEFINED AS ANYTHING WITHIN THE FOOTPRINT OF THE INDIVIDUAL LOTS/UNITS LIMITED COMMON AREA NORTHEAST QUARTER OF SAID SECTION WHICH BEARS SOUTH 89°09'42" UNIT 602 AS SHOWN ON SHEET 3. EAST 2656.14 FEET, WEBER COUNTY, NAD 83, STATE PLANE GRID BEARING. **DUSTY SHIPP** UNIT 603 C. LIMITED COMMON AREA TO BE EXCLUDED FROM PUBLIC UTILITY EASEMENT DEDICATION. **COMMON AREA** UNIT 604 SITE SUMMARY RIDGE UTAH DEVELOPMENT CORPORATION A GEOTECHNICAL INVESTIGATION WAS COMPLETED FOR THIS SUBDIVISION UNIT 702 TOTAL AREA = 5.90 ACBY GEO-STRATA, JOB NUMBER 924-001 DECEMBER 3, 2013. A COPY OF THIS SIGNED THIS ____ DAY OF ____ BUILDING COVERAGE = 0.55 ACREPORT IS AVAILABLE AT THEIR OFFICE (14425 SOUTH, CENTER POINT WAY, ERIC S. HOUSEHOLDER, OFFICER HARD SURFACE AREA = 0.28 ACUNIT 704 LANDSCAPE AREA = 3.92 ACScale in Feet DEDICATED ROAD AREA = 1.15 ACRIDGE TOWNHOMES ASSOCIATION 1" = 50' SIGNED THIS $_{---}$ DAY OF $_{-}$ WEBER COUNTY COMMISSION WEBER - MORGAN HEALTH WEBER COUNTY PLANNING WEBER COUNTY ATTORNEY WEBER COUNTY ENGINEER WEBER COUNTY SURVEYOR **ACKNOWLEDGEMENT** ERIC S. HOUSEHOLDER, OFFICER COMMISSION APPROVAL ACCEPTANCE DEPARTMENT I HAVE EXAMINED THE FINANCIAL GUARANTEE I HEREBY CERTIFY THAT THE REQUIRED PUBLIC I HEREBY CERTIFY THAT THE WEBER COUNTY STATE OF UTAH COUNTY RECORDER AND OTHER DOCUMENTS ASSOCIATED WITH IMPROVEMENT STANDARDS AND DRAWINGS FOR SURVEYOR'S OFFICE HAS REVIEWED THIS PLAT RIDGE UTAH DEVELOPMENT CORPORATION THIS IS TO CERTIFY THAT THIS SUBDIVISION WAS THIS IS TO CERTIFY THAT THIS SUBDIVISION I DO HEREBY CERTIFY THAT THE SOILS, THIS SUBDIVISION PLAT AND IN MY OPINION THIS SUBDIVISION CONFORM WITH COUNTY FOR MATHEMATICAL CORRECTNESS, SECTION COUNTY OF WEBER JOHN L. LEWIS PERCOLATION RATES, AND SITE CONDITION FOR DULY APPROVED BY THE WEBER COUNTY PLAT, THE DEDICATION OF STREETS AND OTHER THEY CONFORM WITH THE COUNTY ORDINANCE STANDARDS AND THE AMOUNT OF THE CORNER DATA, AND FOR HARMONY WITH LINES 3718 NORTH WOLF CREEK DRIVE THIS SUBDIVISION HAVE BEEN INVESTIGATED BY PLANNING COMMISSION. PUBLIC WAYS AND FINANCIAL GUARANTEE OF APPLICABLE THERETO AND NOW IN FORCE AND FINANCIAL GUARANTEE IS SUFFICIENT FOR THE AND MONUMENTS ON RECORD IN COUNTY 2016, PERSONALL EDEN, UTAH 84310 THIS OFFICE AND ARE APPROVED FOR ON-SITE PUBLIC IMPROVEMENTS ASSOCIATED WITH THIS APPEARED BEFORE ME ERIC S. HOUSEHOLDER. THE SIGNER OF FILED FOR AND RECORDED INSTALLATION OF THESE IMPROVEMENTS. OFFICES. THE APPROVAL OF THIS PLAT BY THE 801-430-1507 WASTEWATER DISPOSAL SYSTEMS. SUBDIVISION THEREON ARE HEREBY APPROVED THE ABOVE OWNER'S DEDICATION, WHO DULY ACKNOWLEDGED TO WEBER COUNTY SURVEYOR DOES NOT RELIEVE SEE RECORD OF SURVEY # 5332 AND ACCEPTED BY THE COMMISSIONERS OF ME HE SIGNED IT FREELY AND VOLUNTARILY AND FOR TH THE LICENSED LAND SURVEYOR WHO EXECUTED WEBER COUNTY, UTAH. THIS___DAY OF _____ 2016 PURPOSES THEREIN MENTIONED. THIS PLAT FROM THE RESPONSIBILITIES AND/OR RECORDS, PAGE __ SIGNED THIS___DAY OF ____ SIGNED THIS___DAY OF ____ LIABILITIES ASSOCIATED THEREWITH. SIGNED THIS____DAY OF ______, 2016. SIGNED THIS___DAY OF_ SIGNED THIS _____DAY OF ____ DIRECTOR WEBER-MORGAN HEALTH DEPARTMENT CHAIRMAN, WEBER COUNTY COMMISSION COUNTY ENGINEER COUNTY SURVEYOR COUNTY RECORDER COUNTY ATTORNEY CHAIRMAN, WEBER COUNTY PLANNING COMMISSION MUNICIPAL - LAND SURVEYING 5150 SOUTH 375 EAST OGDEN, UT OFFICE: 801.476.0202 FAX: 801.476.006 **NOTARY PUBLIC**

THE RIDGE TOWNHOMES

PHASE 3 - SUBDIVISION APPLICATION



LOCATION MAP

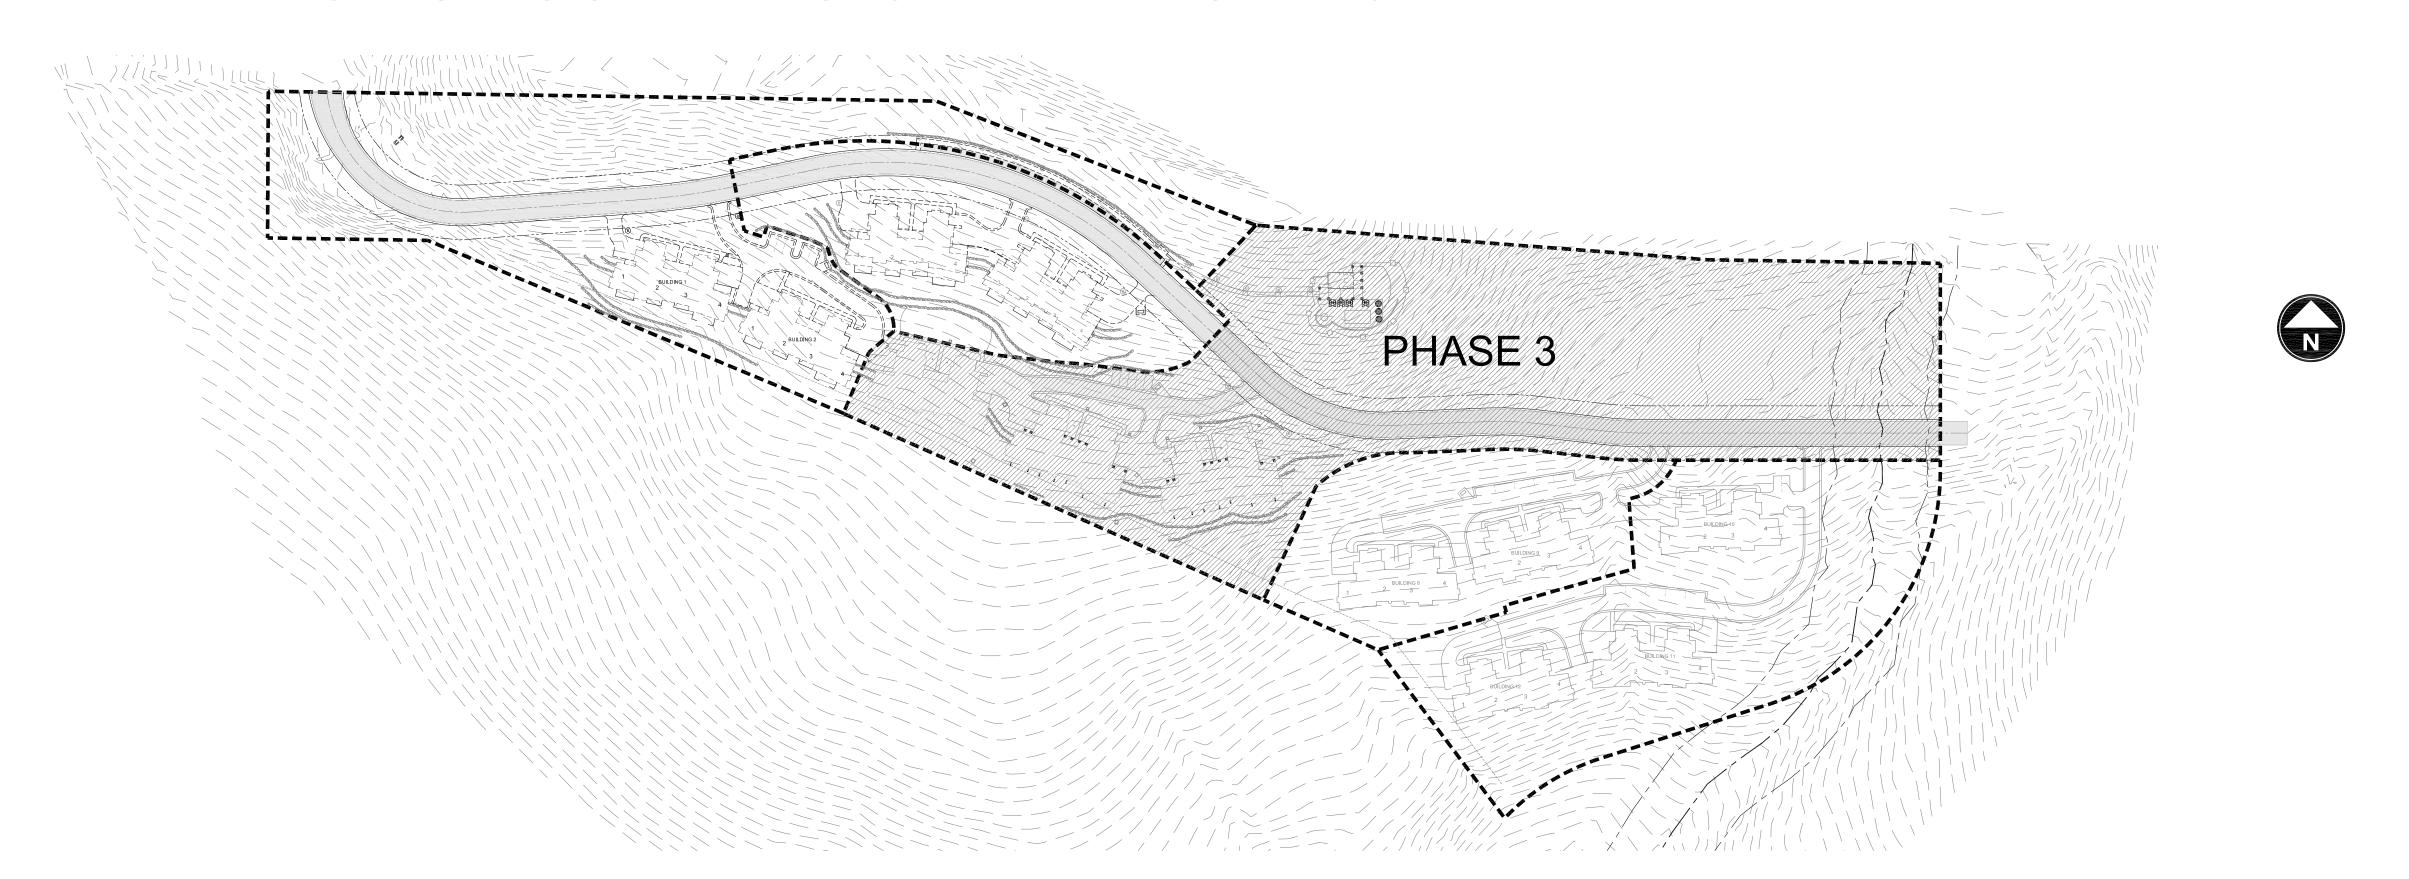




PREPARED FOR:

LEWIS HOMES, INC JOHN LEWIS 5577 EAST ELKHORN DRIVE EDEN, UTAH 84310 801.430.1507



801.583.1295

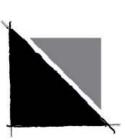

ARCHITECT: BERTOLDI ARCHITECTS RAY BERTOLDI 2726 HARRISON BLVD. OGDEN, UTAH 84403



GARDNER ENGINEERING



PROJECT MANAGEMENT: THE HOUSEHOLDER GROUP ERIC HOUSEHOLDER 2850 NORTH NORDIC VALLEY DRIVE **EDEN, UTAH 84310** 801.389.0040

CONSULTANTS:

LANDSCAPE ARCHITECT: LANGVARDT DESIGN GROUP 328 WEST 200 SOUTH SALT LAKE CITY, UTAH 84101

801.476.4330

ENGINEER:

TYLER NIELSEN 5150 SOUTH, 375 EAST OGDEN, UTAH 84405 801.476.0202



SHEET INDEX:

PLANNING	P1.0	OVERALL PHASING PLAN
	P1.1	SLOPE ANALYSIS
Ź	S1.1	SITE PLAN
PLA	S1.2	SITE PLAN
	S1.3	SITE DETAILS
	L1.1	LANDSCAPE PLAN

COVER SHEET

C1	PLAN AND PROFILE
C2	PLAN AND PROFILE
C3	GRADING PLAN
C4	BUILDING UTILITY PLAN
C5	DETAILS - 1
C6	DETAILS - 2

LANDSCAPE DETAILS

DETAILS - 3 SWPPP



Phase Three Subdivision Application WEBER COUNTY, UT



AUGUST 2016 PROJECT: DRAWN BY: **REVIEW BY:** VERSION: SUBDIVISION APP.

SHEET TITLE:

REVISIONS:

COVER SHEET

SHEET NUMBER:

1. PHASE BOUNDARIES ARE APPROXIMATE AND MAY BE ADJUSTED PER MARKET CONDITIONS OR INFRASTRUCTURE FEASIBILITY. ALL PHASE OF DEVELOPMENT WILL BE CONSTRUCTED TO PROVIDE MINIMUM STANDARDS FOR FIRE SAFETY AND INFRASTRUCTURE REQUIREMENTS.

PHASE DATA:
PHASE 1: 8 UNITS / 21 PARKING STALLS

PHASE 2: 8 UNITS / 36 PARKING STALLS

PHASE 3: 12 UNITS / 41 PARKING STALLS & POOL/SPA FACILITY

PHASE 4: 8 UNITS / 29 PARKING STALLS

PHASE 5: 12 UNITS / 42 PARKING STALLS

NOTE: PARKING STALL COUNTS INCLUDE PROPOSED GARAGE AND SURFACE STALLS FOR EACH PHASE

OVERALL DEVELOPMENT DATA:

-PROJECT AREA: 16.03 ACRES

-PROPOSED USES: 48 TOWNHOME UNITS (12 - 4 PLEX UNITS)


500 S.F. POOL HOUSE W/ POOL, SPA AND POOL DECK

-PARKING: 130 TOTAL
-68 GARAGE STALL

-68 DRIVEWAY SPACES
-34 GUEST AND POOL SURFACE STALLS

-OPEN SPACE: 10.11 AC. (63.10%)

Phase Three Subdivision Application WEBER COUNTY, UT

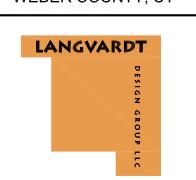

DATE:	AUGUST 2016
PROJECT:	.028
DRAWN BY:	MP
REVIEW BY:	EL
VERSION:	SUBDIVISION APP.
REVISIONS:	


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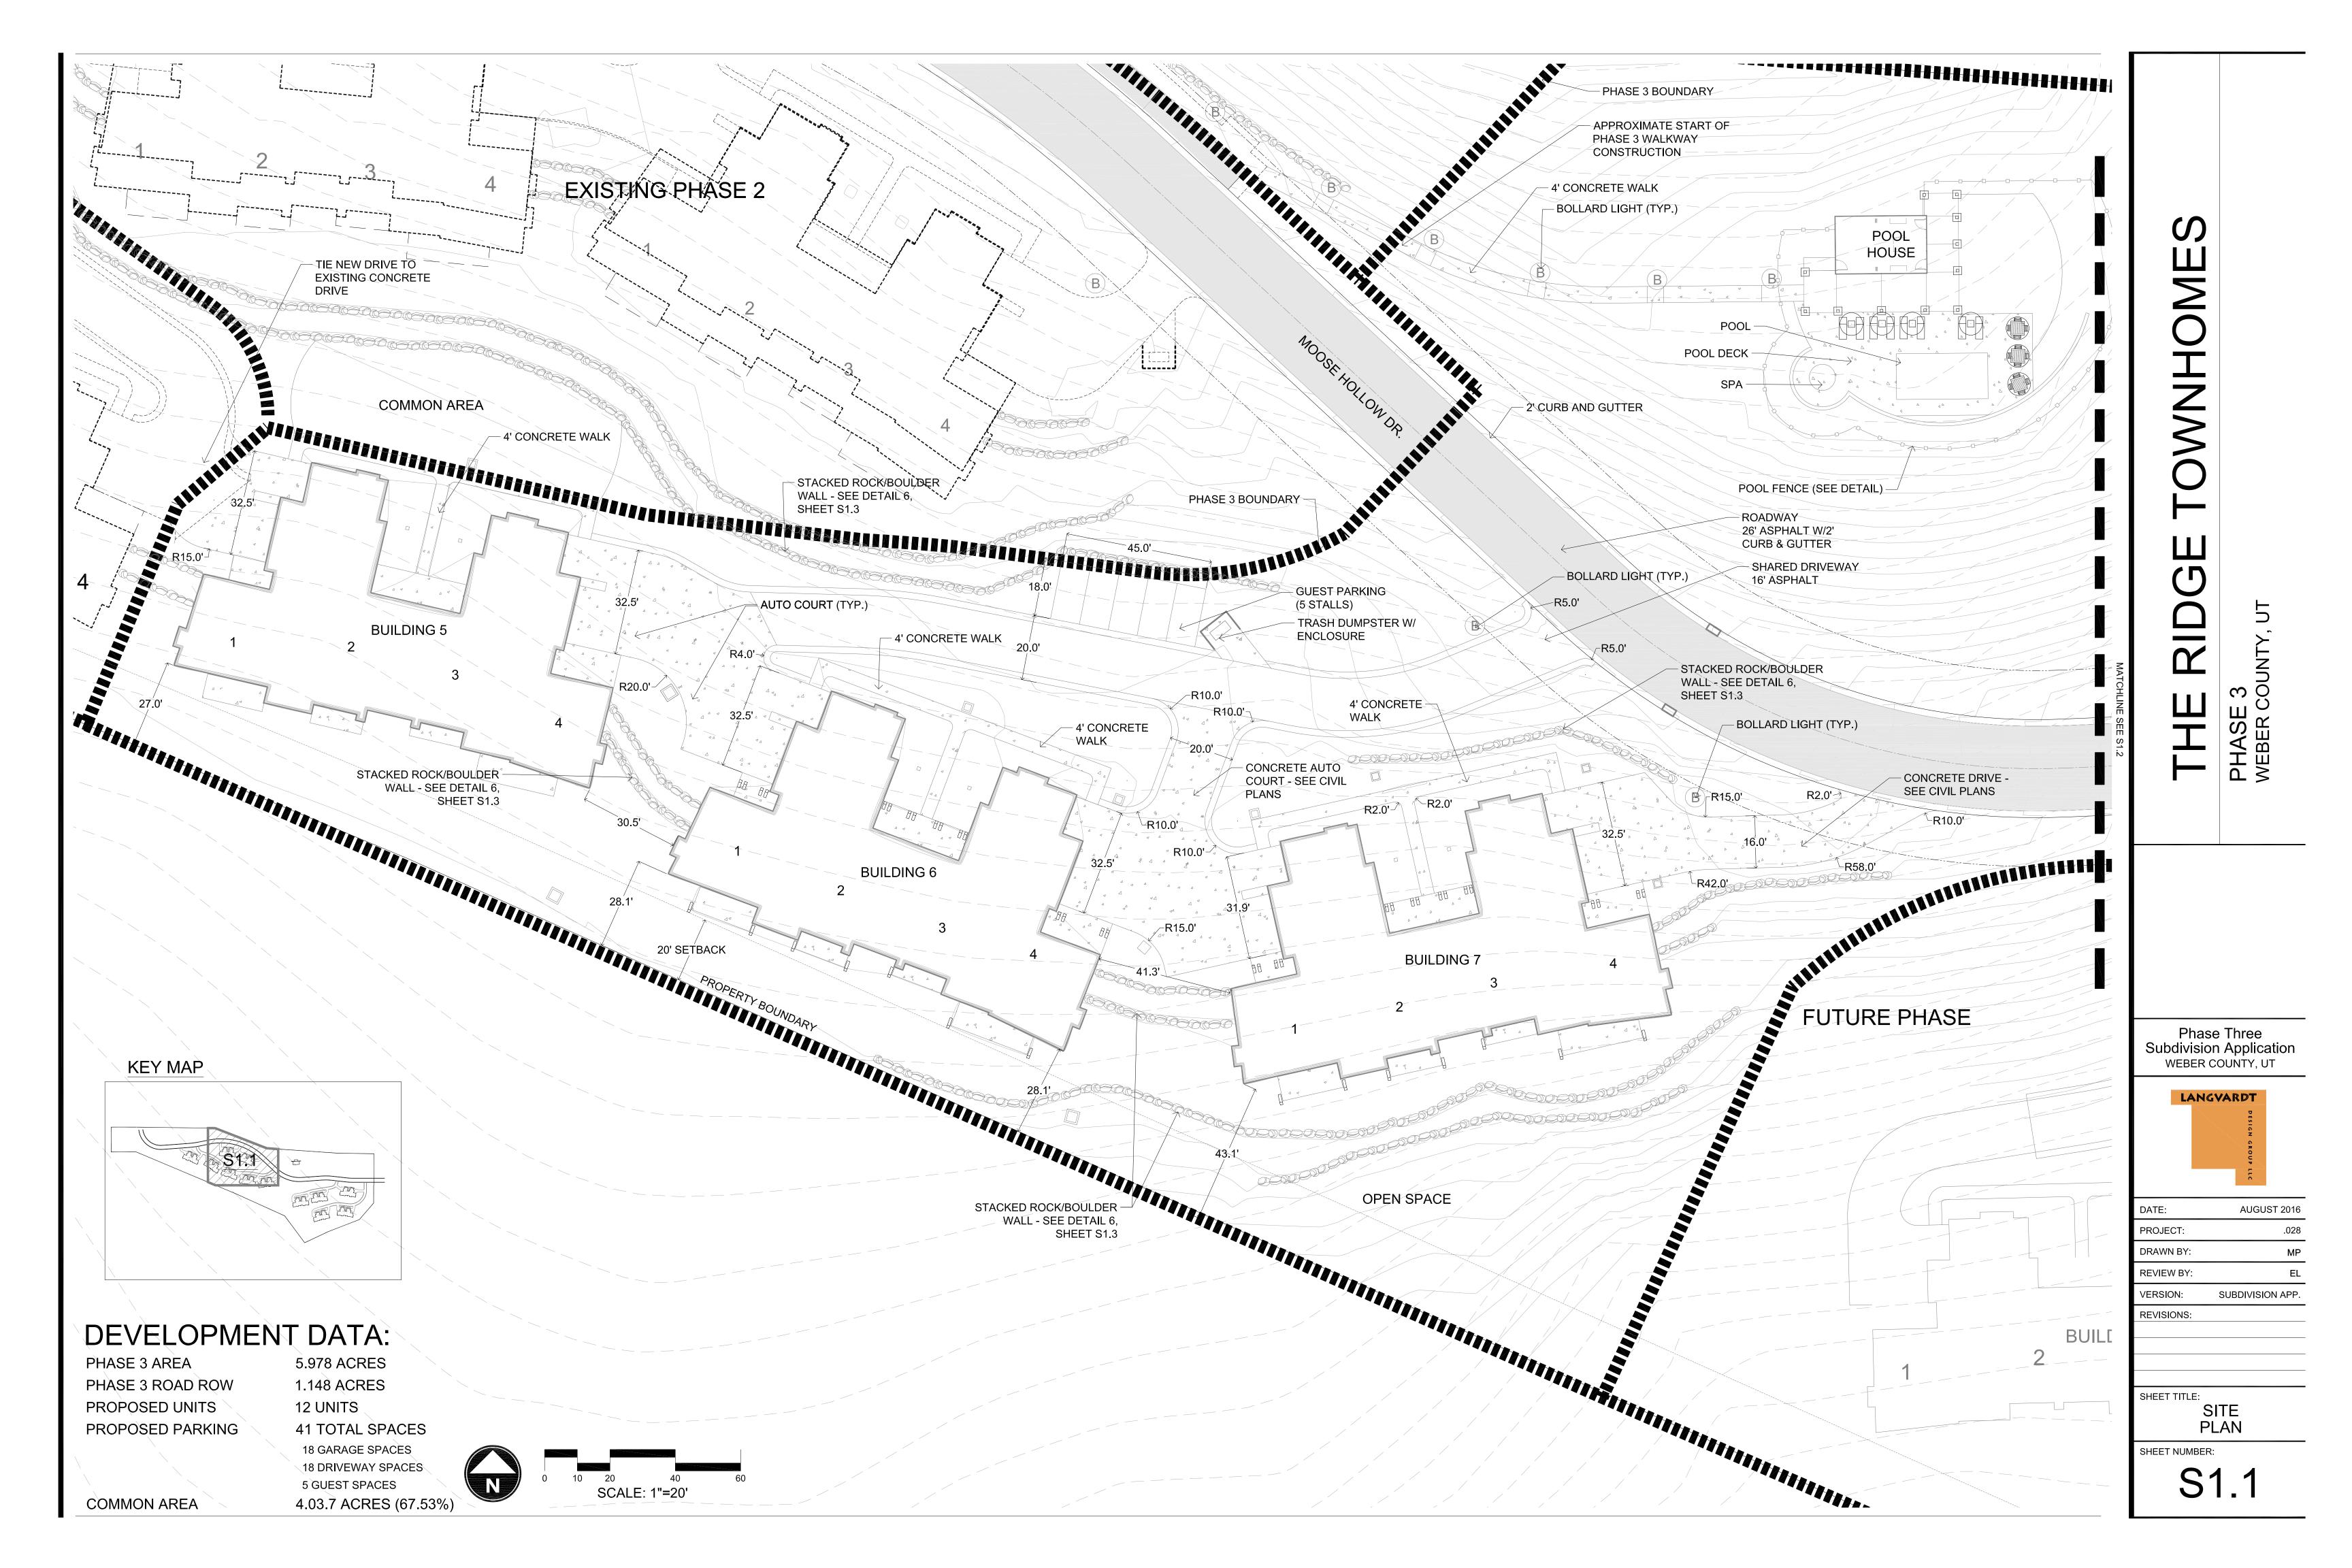
OVERALL


PHASING PLAN

SHEET NUMBER:

P1.0



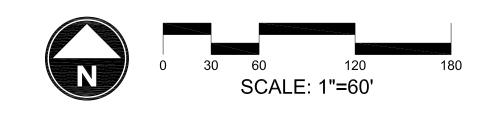

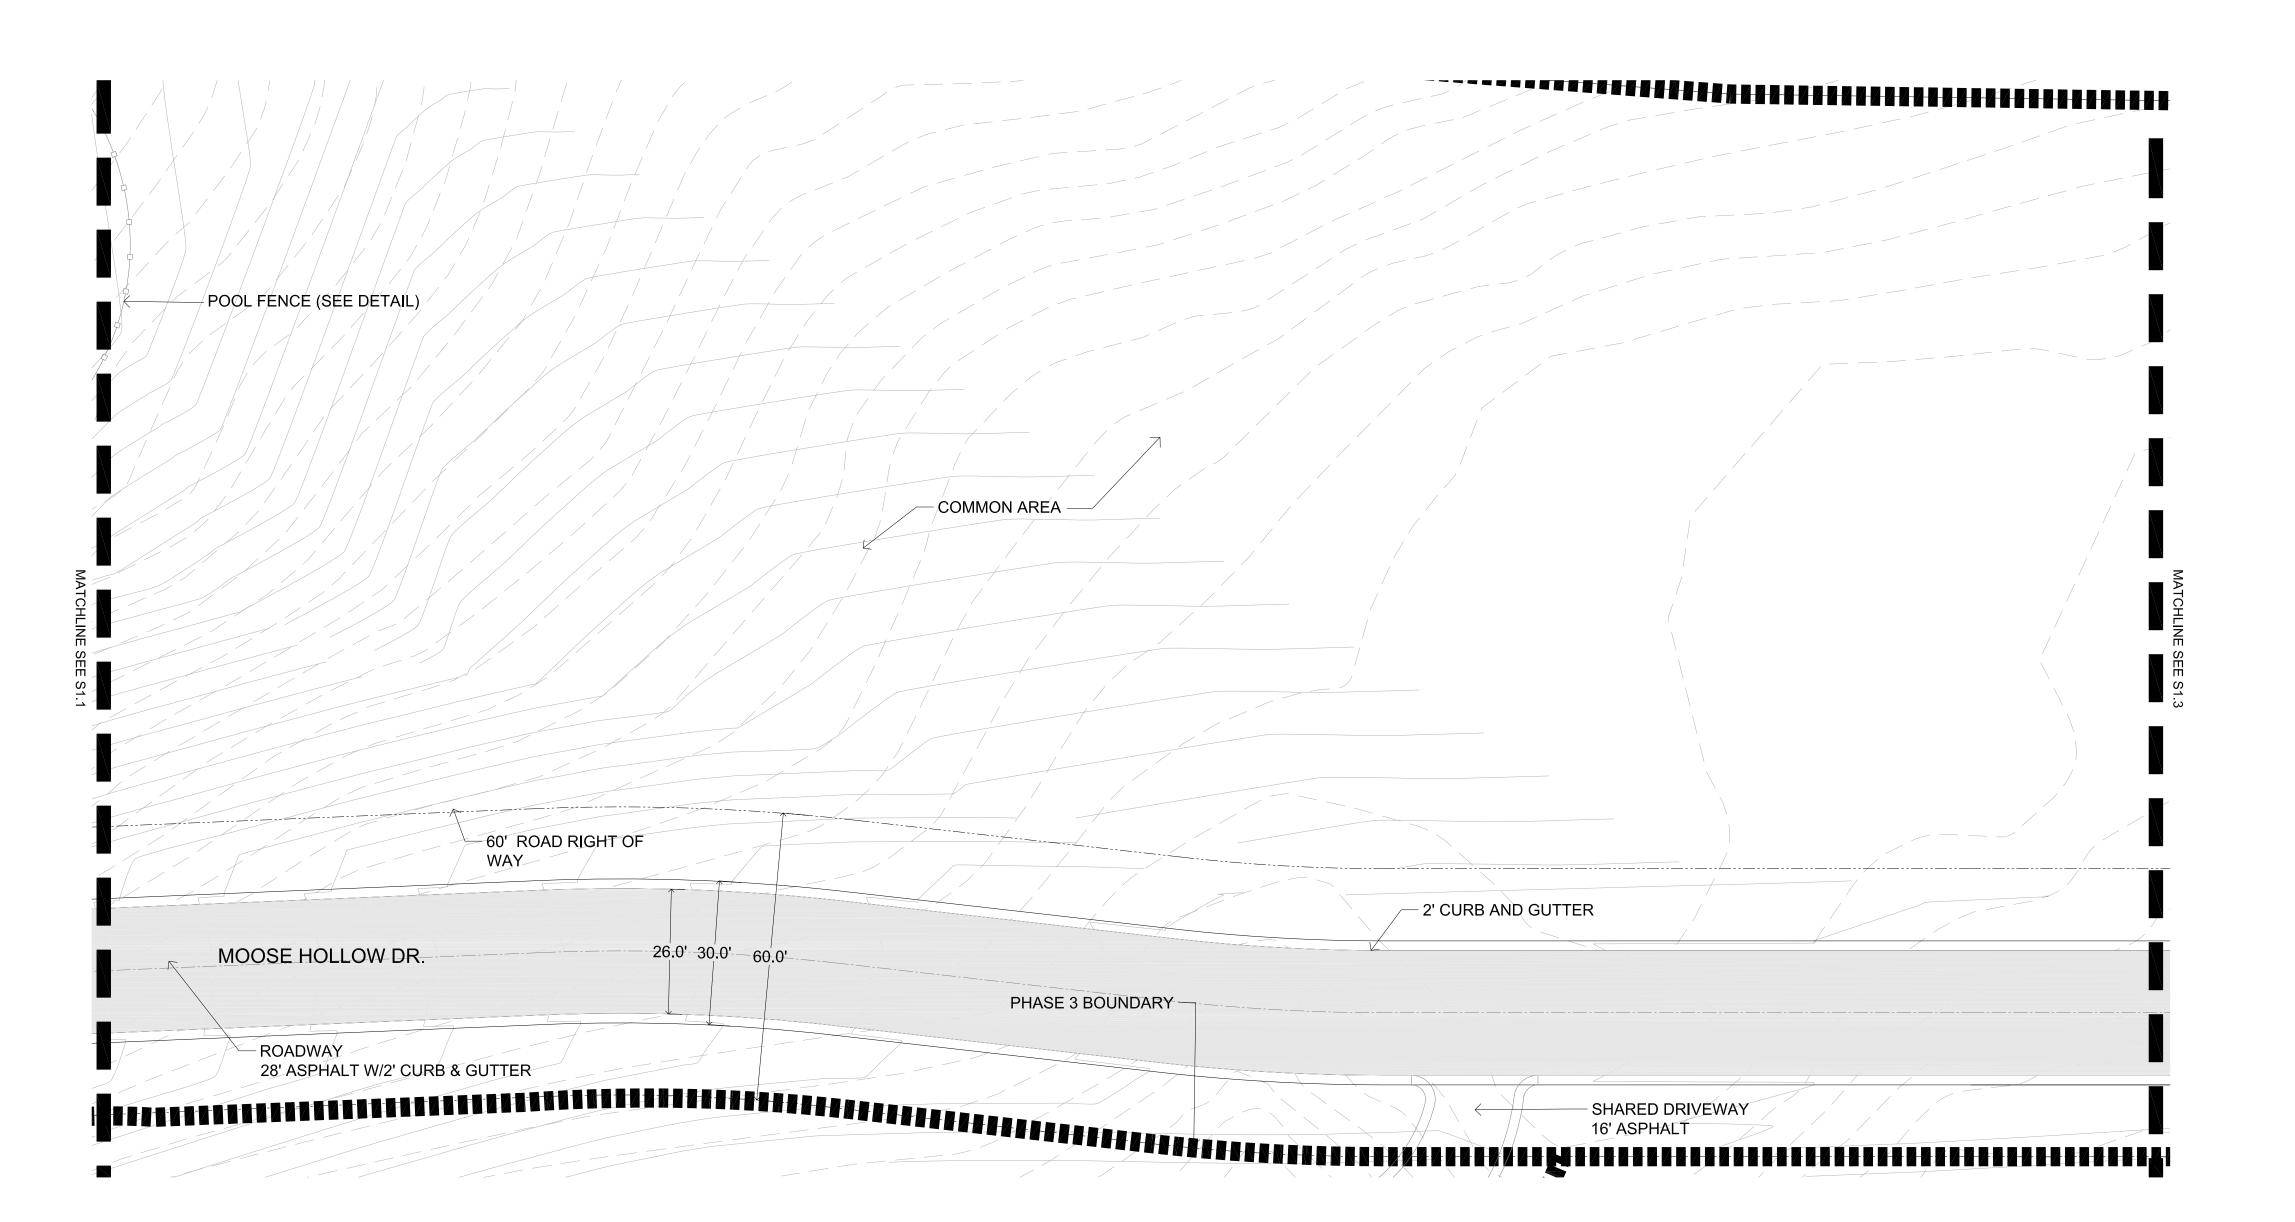

DEVELOPMENT DATA:

PHASE 3 AREA
PHASE 3 ROAD ROW
PROPOSED UNITS

5.978 ACRES 1.148 ACRES

PROPOSED UNITS 12 UNITS
PROPOSED PARKING 41 TOTAL

41 TOTAL SPACES

18 GARAGE SPACES


S

OWNHOME

18 GARAGE SPACES
18 DRIVEWAY SPACES
5 GUEST & POOL SPACES

COMMON AREA

4.03.7 ACRES (67.53%)

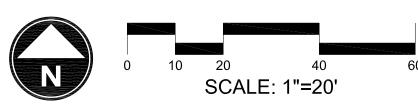

Phase Three Subdivision Application WEBER COUNTY, UT




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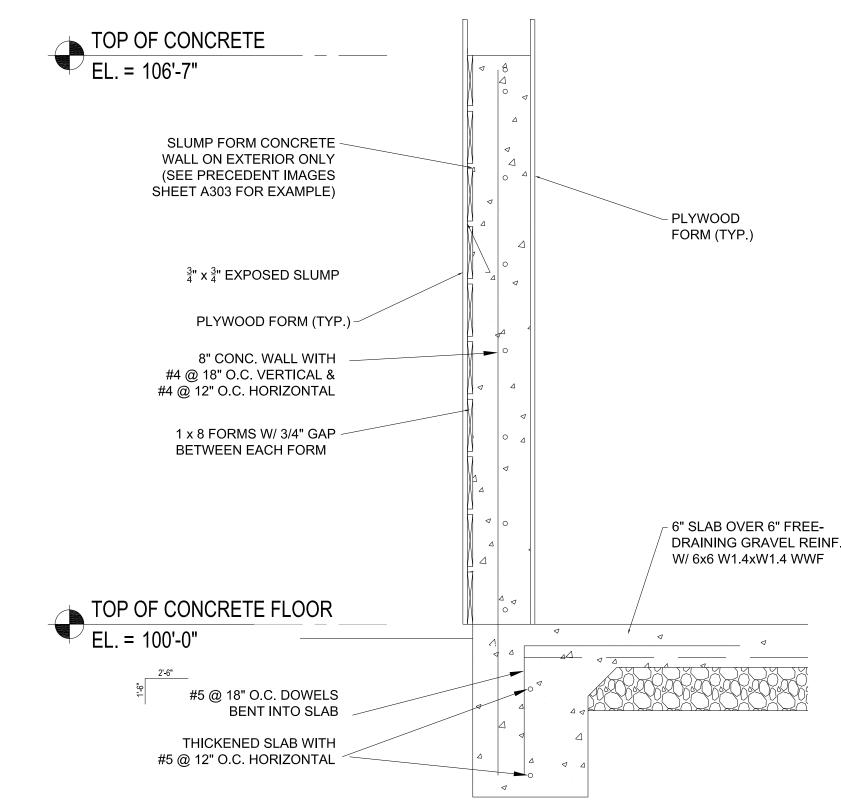
REVISIONS:

SHEET TITLE:
SITE
PLAN

SHEET NUMBER:

S1.2



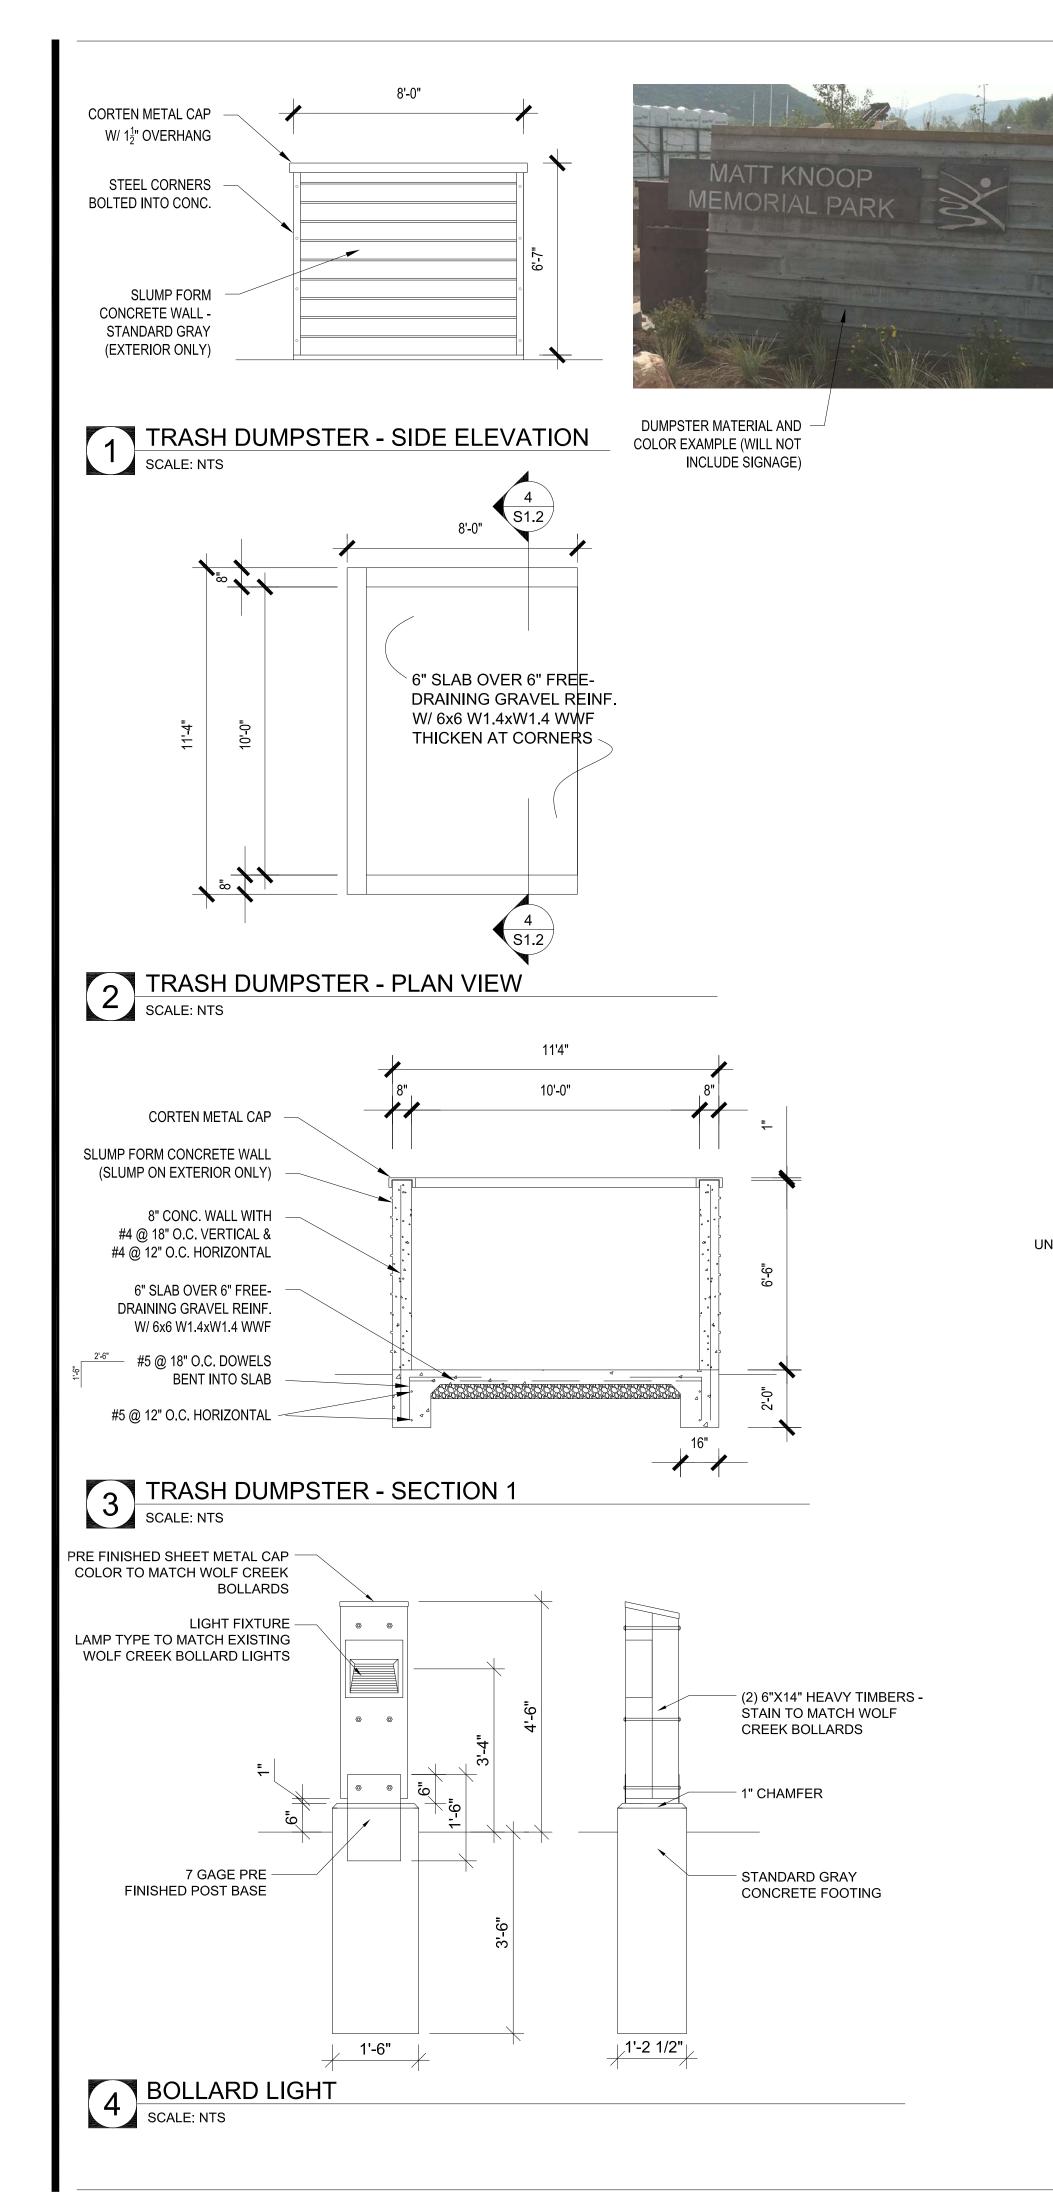

TRASH DUMPSTER - SLUMP FORM FRAMING DETAIL

SCALE: NTS

PLANTING AREA, SEE LANDSCAPE PLAN PLACE ADDITIONAL BOULDERS AROUND WALL AS NECESSARY TO PROVIDE A "NATURAL" TRANSITION TO THE SURROUNDING LANDSCAPE -MAXIMUM 4' HEIGHT* - BURY 1/3 OF ALL BOULDERS PLACED AT GROUND LEVEL MINIMUM 2.0% SLOPE COMPACTED OR UNDISTURBED SUBGRADE.

1. BOULDERS SHOULD GENERALLY RANGE FROM 2'-4' IN DIAMETER.LARGER BOULDERS SHALL BE PLACED AT BOTTOM OF WALL. BOULDERS SHOULD BE PLACED TO APPEAR "NATURAL" WITH ONE ANOTHER AND SHOULD NOT BE STACKED IN A STRUCTURED, ENGINEERED PATTERN. 2. ROCK WALLS THAT ARE 4FT AND HIGHER REQUIRE AND ENGINEERED DESIGN

AND SHALL BE CONSTRUCTED TO THE ENGINEERS RECOMMENDATIONS.

6 BOULDER RETAINING WALL
SCALE: NTS

WELDED STEEL FENCE, 3-RAIL 6' HEIGHT POOL SECURITY FENCE WITH 4" MAXIMUM OPENING

MATERIAL: GALVANIZED STEEL, 50,000 PSI (ASTM A653)

PICKETS: 3/4" SQUARE X 16 GA., SPEAR TOP PICKETS EXTEND PAST TOP AND BOTTOM

RAILS: 1.4375" X .075" TOP, 1.500" X 0.075" SIDES, 91.95" LONG

POSTS: 2-1/2" SQUARE X 16 GA.

COATING: E-COAT, 20 YEAR WARRANTY

CONSTRUCTION: PROFUSION WELDED ATF, RAKABLE TO FOLLOW TERRAIN CHANGES UP TO 30" PER 8 FEET


COLOR:BLACK

GATES:3' SELF CLOSING GATE, GATE STYLE TO MATCH FENCE STYLE. COORDINATE LOCKING SYSTEM WITH OWNER




8 PLAN
SCALE: 1"=20'



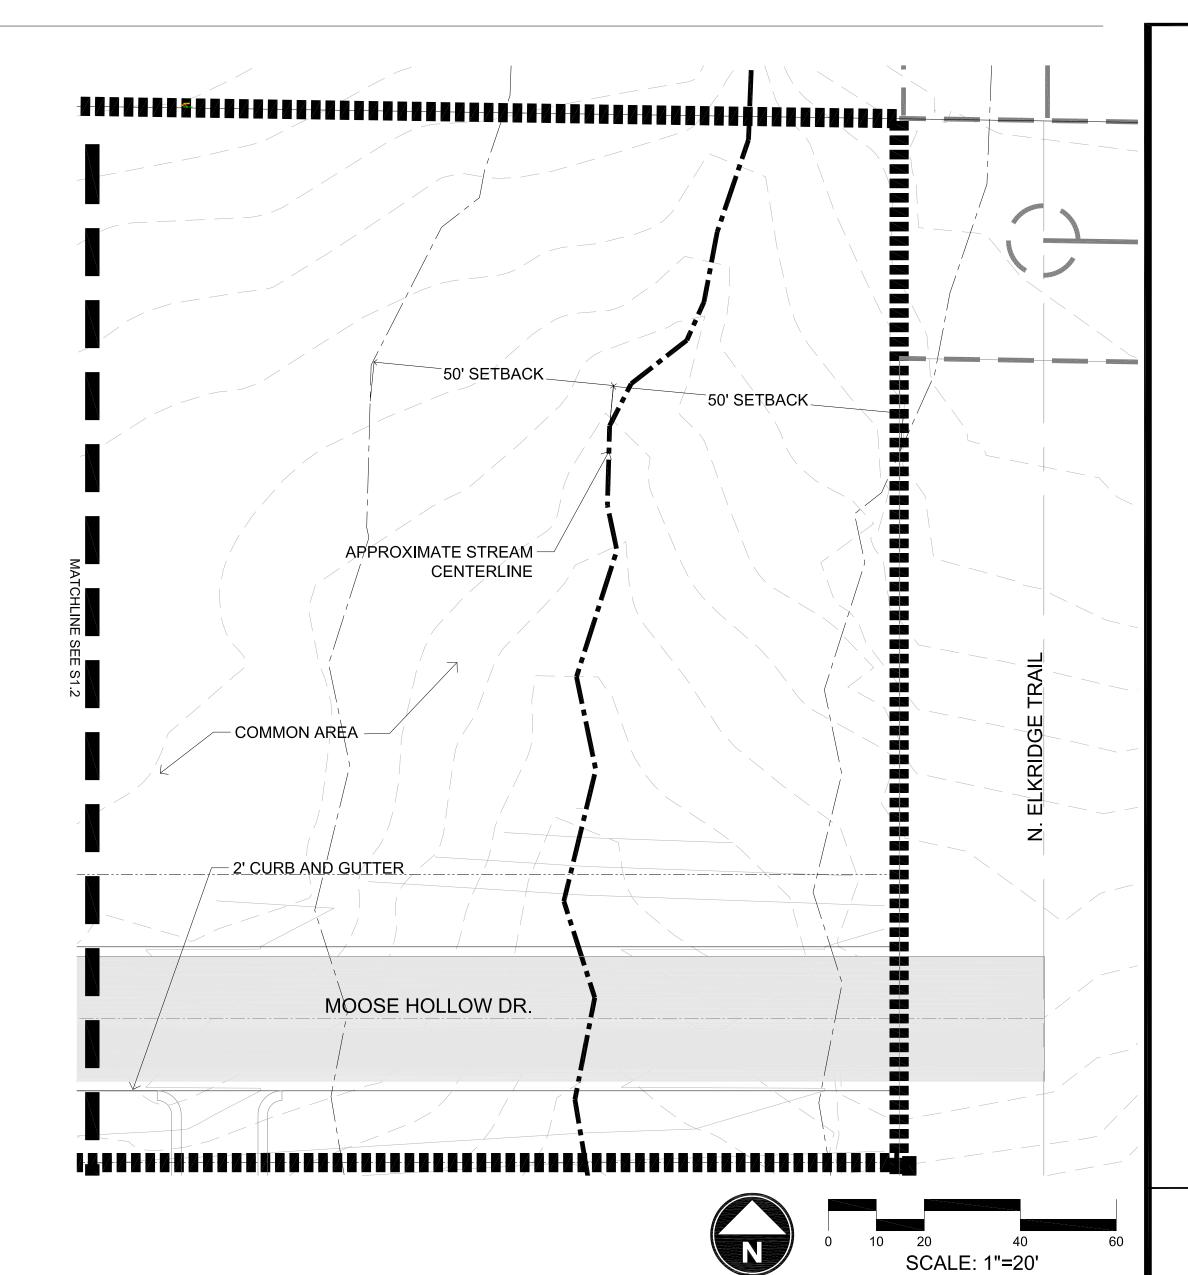


Phase Three Subdivision Application WEBER COUNTY, UT

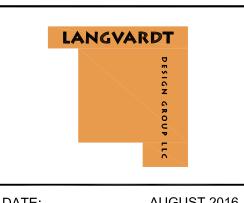

DATE:	AUGUST 2016
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REVIEW BY:	EL
VERSION:	SUBDIVISION APP.
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SHEET TITLE: SITE **DETAILS**

SHEET NUMBER:

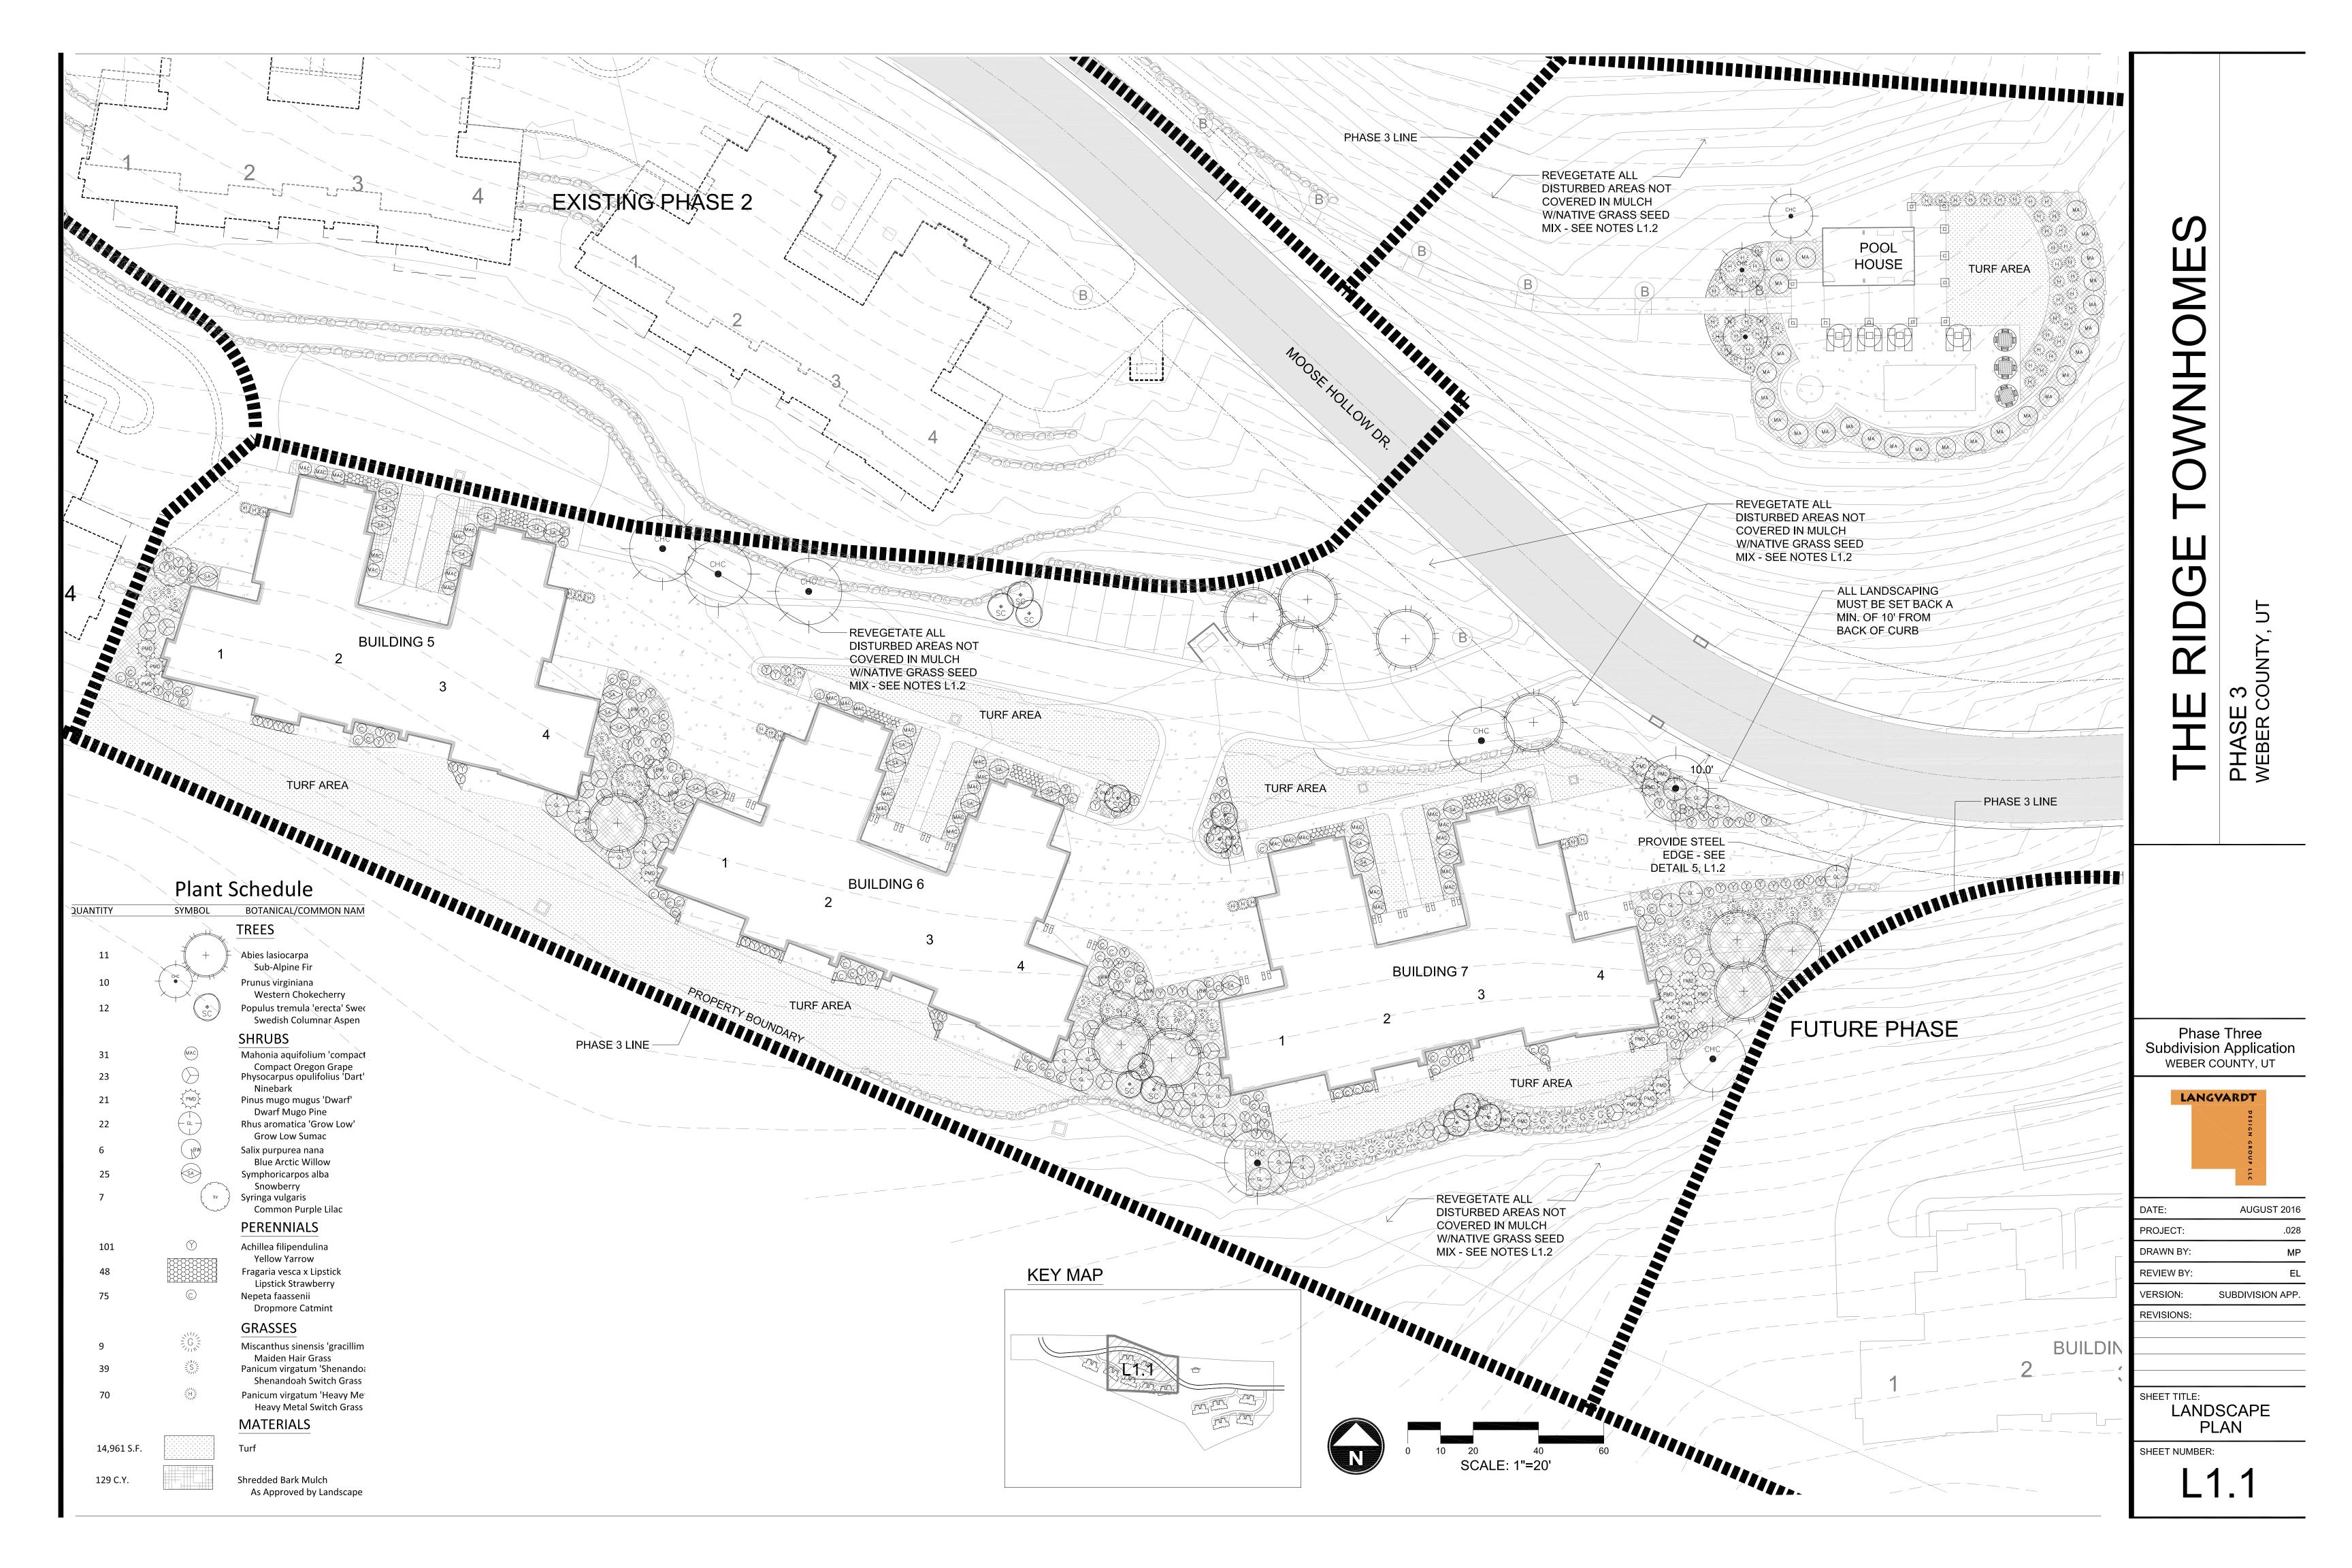


ONE PART MULCH TO THREE PARTS NATIVE SOIL.


PLANTING PIT SIZES: 1 GAL. OR 5 GAL. - 2X WIDTH OF ROOT BALL, DEPTH = ROOT BALL + 6"

15 GAL. OR LARGER - 3X WIDTH OF ROOT BALL, DEPTH = ROOT BALL + 12"

FERTILIZER TABLETS (21 GRAM AGRIFORM TABLETS) 1 PER 1 GAL., 3 PER 5 GAL., 5 PER 15 GAL., 1 PER 3" OF BOX SIZE (24" BOX OR LARGER)

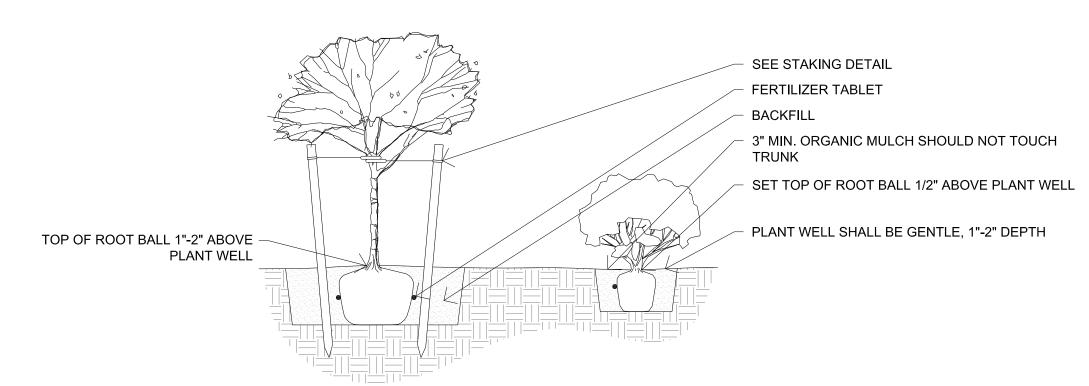

DECIDUOUS TREE AND SHRUB PLANTING

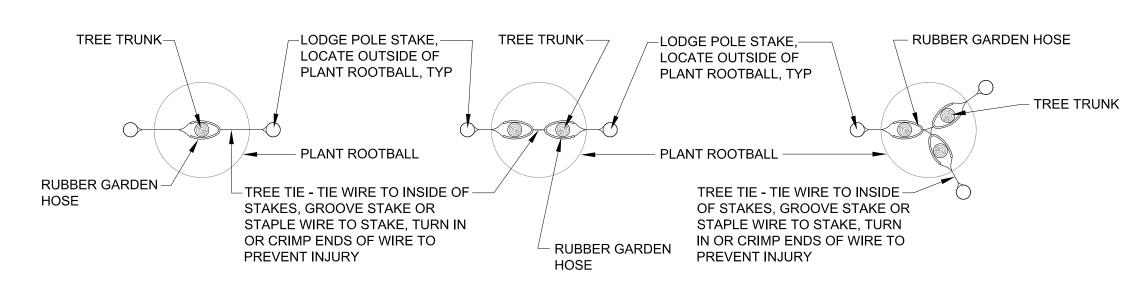



TREE STAKING PLAN - STANDARD


TREE STAKING PLAN - MULTIPLE

TREE STAKING PLAN - MULTIPLE

2 DECIDUOUS TREE STAKING

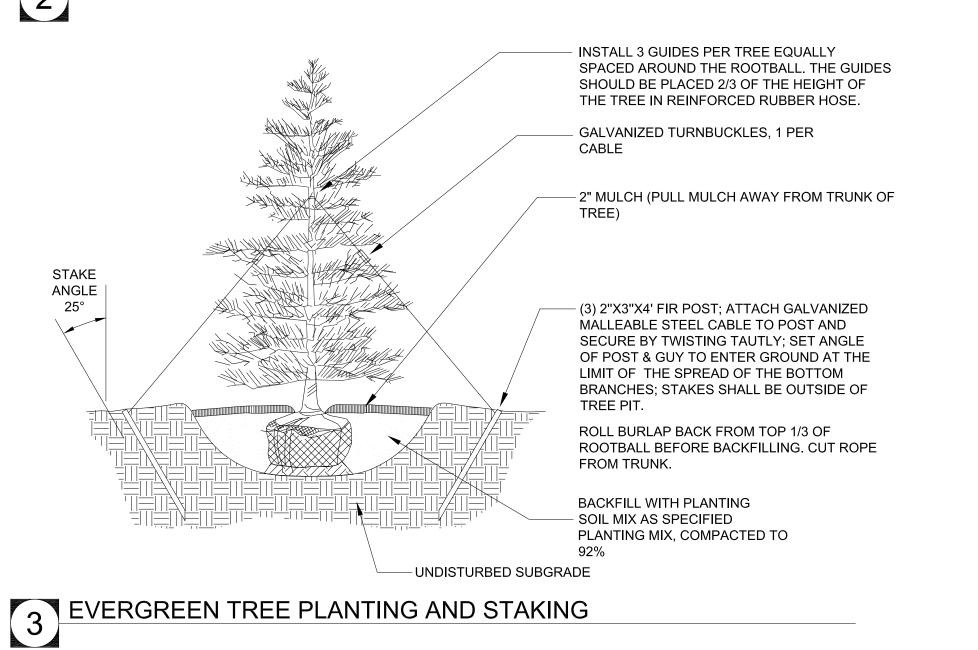


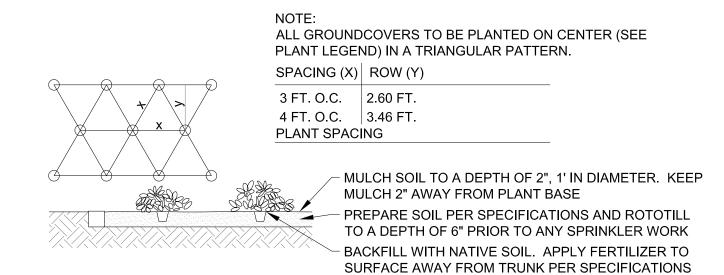

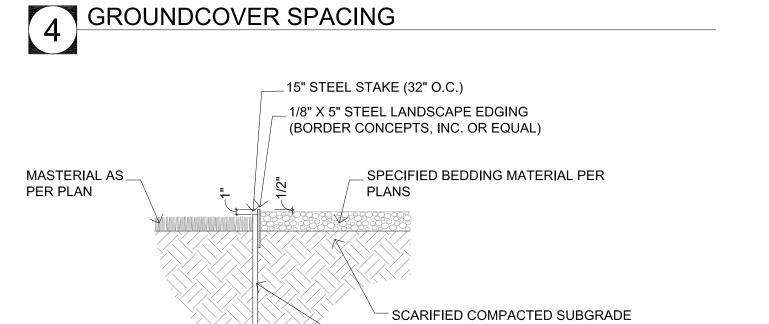

GRIND TO A POINT FOR EASE IN

5 STEEL LANDSCAPE EDGING

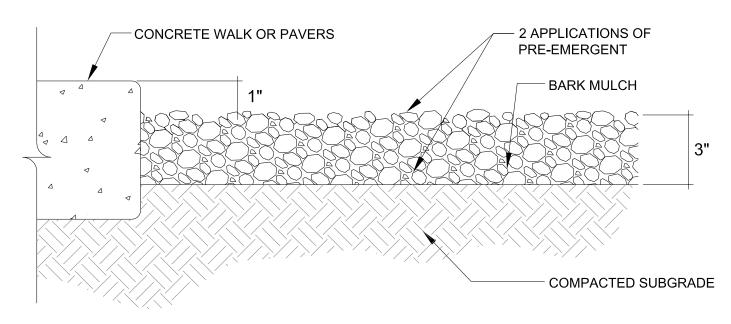

1. SIZE AND COLOR OF MULCH IS SHOWN ON THE SITE PLAN AND LANDSCAPE PLAN. 2. PRE-EMERGENT SHALL BE APPLIED TO FINISH GRADE BEFORE INSTALLATION OF MULCH. 3. FINAL APPLICATION OF PRE-EMERGENT SHALL BE APPLIED TO FINISH GRADE AFTER INSTALLATION OF MULCH IS RAKED SMOOTH AND UNIFORM.



QUANTITY SYMBOL BOTANICAL/COMMON NAME INSTALLED			
QUANTITY	STIVIBOL	<u> </u>	SIZE
		TREES	
11	+	Abies lasiocarpa Sub-Alpine Fir	6-8' Hgt.
10	CHC ●	Prunus virginiana Western Chokecherry	2" CAL.
12	SC SC	Populus tremula 'erecta' Swedish Columnar Swedish Columnar Aspen	2" CAL.
		SHRUBS	
31	MAC	Mahonia aquifolium 'compacta' Compact Oregon Grape	5 Gal.
23	<u>) </u>	Physocarpus opulifolius ['] Dart's Gold' Ninebark	5 Gal.
21	PMD }	Pinus mugo mugus 'Dwarf' Dwarf Mugo Pine	5 Gal.
22	GL	Rhus aromatica 'Grow Low' Grow Low Sumac	5 Gal
6	(NBW)	Salix purpurea nana Blue Arctic Willow	5 Gal.
25	SA	Symphoricarpos alba Snowberry	5 Gal.
7	& SV	Syringa vulgaris Common Purple Lilac	5 Gal.
		PERENNIALS	
101	\bigcirc	Achillea filipendulina Yellow Yarrow	1 Gal.
48		Fragaria vesca x Lipstick Lipstick Strawberry	FLATS
75	©	Nepeta faassenii Dropmore Catmint	1 Gal.
	NI.	GRASSES	
9	G	Miscanthus sinensis 'gracillimus' Maiden Hair Grass	1 Gal.
39	SS	Panicum virgatum 'Shenandoah' Shenandoah Switch Grass	1 Gal.
70	H	Panicum virgatum 'Heavy Metal' Heavy Metal Switch Grass	1 Gal.
MATERIALS			
14,961 S.F.		Turf	SOD
129 C.Y.		Shredded Bark Mulch As Approved by Landscape Architect	3" Depth

GENERAL LANDSCAPE NOTES

1. THE CONTRACTOR SHALL VERIFY THE EXACT LOCATION OF ALL EXISTING AND PROPOSED UTILITIES, AND ALL SITE CONDITIONS PRIOR TO BEGINNING CONSTRUCTION. THE CONTRACTOR SHALL COORDINATE HIS WORK WITH THE PROJECT MANAGER AND ALL OTHER CONTRACTORS WORKING ON THE SITE.

2. THE FINISH GRADE OF ALL PLANTING AREAS SHALL BE SMOOTH, EVEN AND CONSISTENT, FREE OF ANY HUMPS, DEPRESSIONS OR OTHER GRADING IRREGULARITIES. THE FINISH GRADE OF ALL LANDSCAPE AREAS SHALL BE GRADED CONSISTENTLY 3/4" BELOW THE TOP OF ALL SURROUNDING WALKS, CURBS, ETC. 3. THE CONTRACTOR SHALL STAKE THE LOCATION OF ALL PLANTS FOR APPROVAL PRIOR TO PLANTING. TREES SHALL BE LOCATED EQUIDISTANT FROM ALL SURROUNDING PLANT MATERIAL. SHRUBS AND GROUND COVERS SHALL BE TRIANGULAR AND EQUALLY SPACED.

4. THE PLANT MATERIALS LIST IS PROVIDED AS AN INDICATION OF THE SPECIFIC REQUIREMENTS OF THE PLANTS SPECIFIED, WHEREVER IN CONFLICT WITH THE PLANTING PLAN, THE PLANTING PLAN SHALL GOVERN. 5. THE CONTRACTOR SHALL PROVIDE ALL MATERIALS, LABOR AND EQUIPMENT REQUIRED FOR THE PROPER COMPLETION OF ALL LANDSCAPE WORK AS SPECIFIED AND SHOWN ON THE DRAWINGS. 6. ALL PLANT MATERIALS SHALL BE APPROVED PRIOR TO PLANTING. THE OWNER/LANDSCAPE ARCHITECT HAS THE RIGHT TO REJECT ANY AND ALL PLANT MATERIAL NOT CONFORMING TO THE SPECIFICATIONS. THE

OWNER/LANDSCAPE ARCHITECTS DECISION WILL BE FINAL. 7. THE CONTRACTOR SHALL KEEP THE PREMISES, STORAGE AREAS AND PAVING AREAS NEAT AND ORDERLY AT ALL TIMES. REMOVE TRASH, SWEEP, CLEAN, HOSE, ETC. DAILY. 8. THE CONTRACTOR SHALL PLANT ALL PLANTS PER THE PLANTING DETAILS, STAKE/GUY AS SHOWN. TOP OF

ROOT BALLS SHALL BE PLANTED FLUSH WITH FINISH GRADE. 9. THE CONTRACTOR SHALL NOT IMPEDE DRAINAGE IN ANY WAY. THE CONTRACTOR SHALL ALWAYS MAINTAIN

POSITIVE DRAINAGE AWAY FROM THE BUILDING, WALLS, ETC. 10. THE CONTRACTOR SHALL MAINTAIN ALL WORK UNTIL ALL WORK IS COMPLETE AND ACCEPTED BY THE OWNER. UPON COMPLETION OF LANDSCAPE WORK AN INSPECTION FOR ACCEPTANCE OF THE WORK SHALL BE HELD. THE CONTRACTOR SHALL NOTIFY THE OWNER/LANDSCAPE ARCHITECT FOR SCHEDULING OF INSPECTION

AT LEAST SEVEN (7) DAYS IN ADVANCE. 11. THE CONTRACTOR SHALL MAINTAIN AND GUARANTEE ALL WORK FOR A PERIOD OF ONE YEAR FROM THE DATE OF FINAL ACCEPTANCE BY THE OWNER. REPLACEMENT PLANTS SHALL BE GUARANTEED FOR AN ADDITIONAL 90 DAYS. MAINTENANCE SHALL INCLUDE MOWING, WEEDING, FERTILIZING, CLEANING, INSECTICIDES,

HERBICIDES, ETC. 12. NATIVE GRASS SEEDED AREAS TO BE A MIXTURE OF:

40% BIG HORN BLUE HARD FESCUE 40% DEFIANT HARD FESCUE

20% JAMESTOWN 4 CHEWINGS FESCUE

SEEDING RATE: 35 LBS PLS/ACRE

13. ALL DISTURBED AREAS OUTSIDE MULCHED LANDSCAPE BEDS ARE TO BE SEEDED WITH NATIVE GRASS

14. ALL LANDSCAPE BEDS TO BE MULCHED WITH A MINIMUM 3" SHREDDED BARK MULCH.

IRRIGATION NOTE:

1. ALL PLANT MATERIALS SHOWN ON THE DRAWING SHALL BE SERVICED BY AN AUTOMATIC UNDERGROUND IRRIGATION SYSTEM. ALL SHRUB BED AREAS, INCLUDING TREES SHALL BE IRRIGATED WITH A LOW PRESSURE DRIP IRRIGATION SYSTEM. ALL GRASS AREAS, EITHER NATIVE OR MANICURED SHALL BE IRRIGATED WITH A BROADCAST IRRIGATION SYSTEM.

2. THE CONTRACTOR IS TO HAVE A QUALIFIED IRRIGATION SYSTEM SPECIALIST PREPARE A DESIGN FOR AN AUTOMATIC UNDERGROUND IRRIGATION SYSTEM AND SUBMIT DRAWINGS TO THE ENGINEER FOR APPROVAL AT LEAST 30 DAYS PRIOR TO THE SYSTEM INSTALLATION. 3. UNDERGROUND IRRIGATION SYSTEM DRAWINGS SHALL BE PREPARED ON 24"X 36" SHEETS, NEATLY DRAWN


AND VERY LEGIBLE. DRAWINGS ARE TO INCLUDE HEAD SPACING, TYPES OF HEADS, PIPING WITH SIZES, VALVES, FITTINGS AND ALL OTHER ITEMS REQUIRED FOR PROPER INSTALLATION OF THE SYSTEM. 4. THE LANDSCAPE CONTRACTOR SHALL BE RESPONSIBLE FOR THE INSTALLATION OF ALL IRRIGATION SLEEVES PRIOR TO PLACEMENT OF HARD IMPROVEMENTS. COORDINATE WITH THE GENERAL CONTRACTOR. 5. THE UTILITY CONTRACTOR IS TO PROVIDE AN IRRIGATION SYSTEM CONNECTION TO EITHER THE CULINARY OR SECONDARY WATER LINE WITH A BACK FLOW PREVENTION DEVICE, AS APPLICABLE, WITHIN STATE AND LOCAL JURISDICTIONAL CODES. THE IRRIGATION CONTRACTOR IS RESPONSIBLE TO COORDINATE THIS ITEM WITH THE UTILITY CONTRACTOR. IF SECONDARY WATER IS USED, THE SYSTEM SHALL BE FILTERED WITH A CLEANABLE FILTER SYSTEM.

6. THE IRRIGATION CONTROL BOX SHALL BE LOCATED AT THE DIRECTION OF THE PROJECT MANAGER/OWNER.

Plant Schedule

JANTITY	SYMBOL	BOTANICAL/COMMON NAME	INSTALLE
		TREES	SIZE
11	+	Abies lasiocarpa Sub-Alpine Fir	6-8' Hgt.
10	CHC ●	Prunus virginiana Western Chokecherry	2" CAL.
12	SC SC	Populus tremula 'erecta' Swedish Columnar Swedish Columnar Aspen	2" CAL.
		SHRUBS	
31	MAC	Mahonia aquifolium 'compacta'	5 Gal.
23		Compact Oregon Grape Physocarpus opulifolius 'Dart's Gold' Ninebark	5 Gal.
21	PMD	Pinus mugo mugus 'Dwarf'	5 Gal.
22	GL	Dwarf Mugo Pine Rhus aromatica 'Grow Low' Grow Low Sumac	5 Gal
6	NBW)	Salix purpurea nana	5 Gal.
25	SA	Blue Arctic Willow Symphoricarpos alba	5 Gal.
7	sv	Snowberry Syringa vulgaris Common Purple Lilac	5 Gal.
		PERENNIALS	
101	\bigcirc	Achillea filipendulina	1 Gal.
48		Yellow Yarrow Fragaria vesca x Lipstick	FLATS
75	©	Lipstick Strawberry Nepeta faassenii Dropmore Catmint	1 Gal.
		GRASSES	
9	S G	Miscanthus sinensis 'gracillimus'	1 Gal.
39		Maiden Hair Grass Panicum virgatum 'Shenandoah' Shenandoah Switch Grass	1 Gal.
70	SH.	Panicum virgatum 'Heavy Metal' Heavy Metal Switch Grass	1 Gal.
		MATERIALS	
14,961 S.F.		Turf	SOD
129 C.Y.		Shredded Bark Mulch As Approved by Landscape Architect	3" Depth


Phase Three Subdivision Application WEBER COUNTY, UT

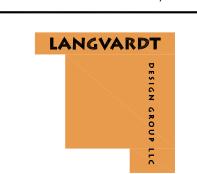



DATE:	AUGUST 2016
PROJECT:	.028
DRAWN BY:	MP
REVIEW BY:	EL
VERSION:	SUBDIVISION APP.
DEVICIONO.	

SHEET TITLE: LANDSCAPE PLAN & DETAILS

SHEET NUMBER:

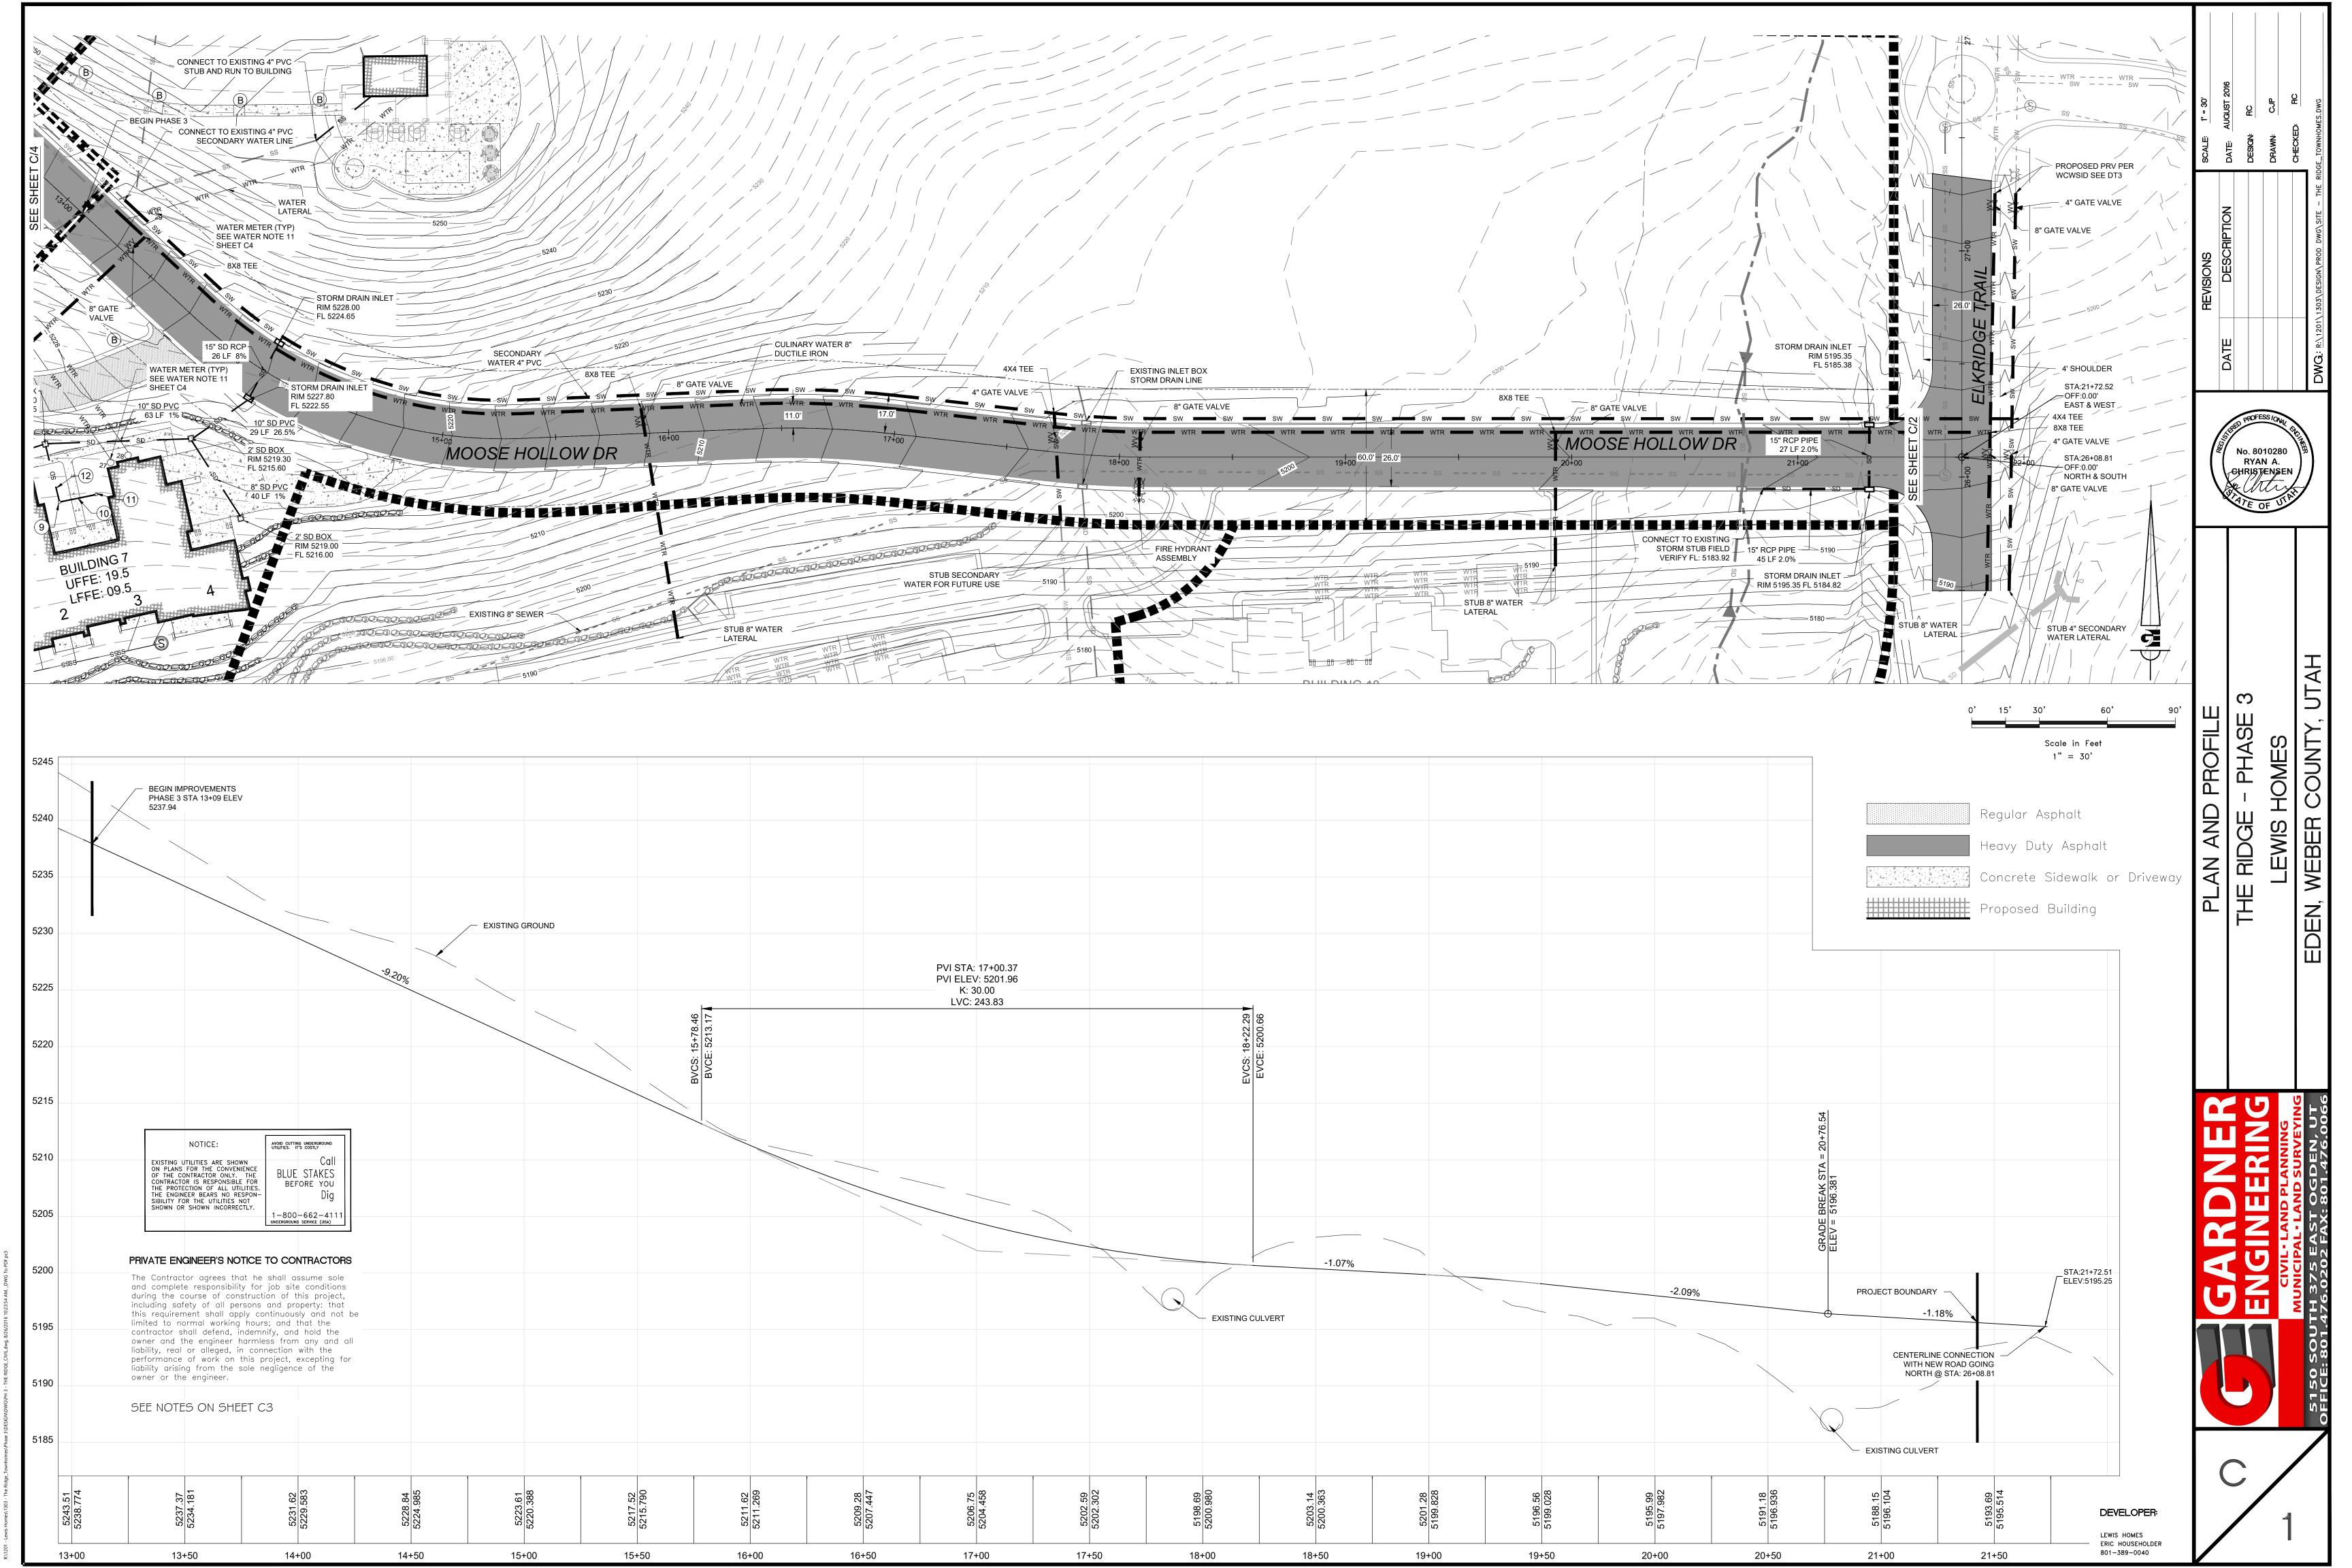

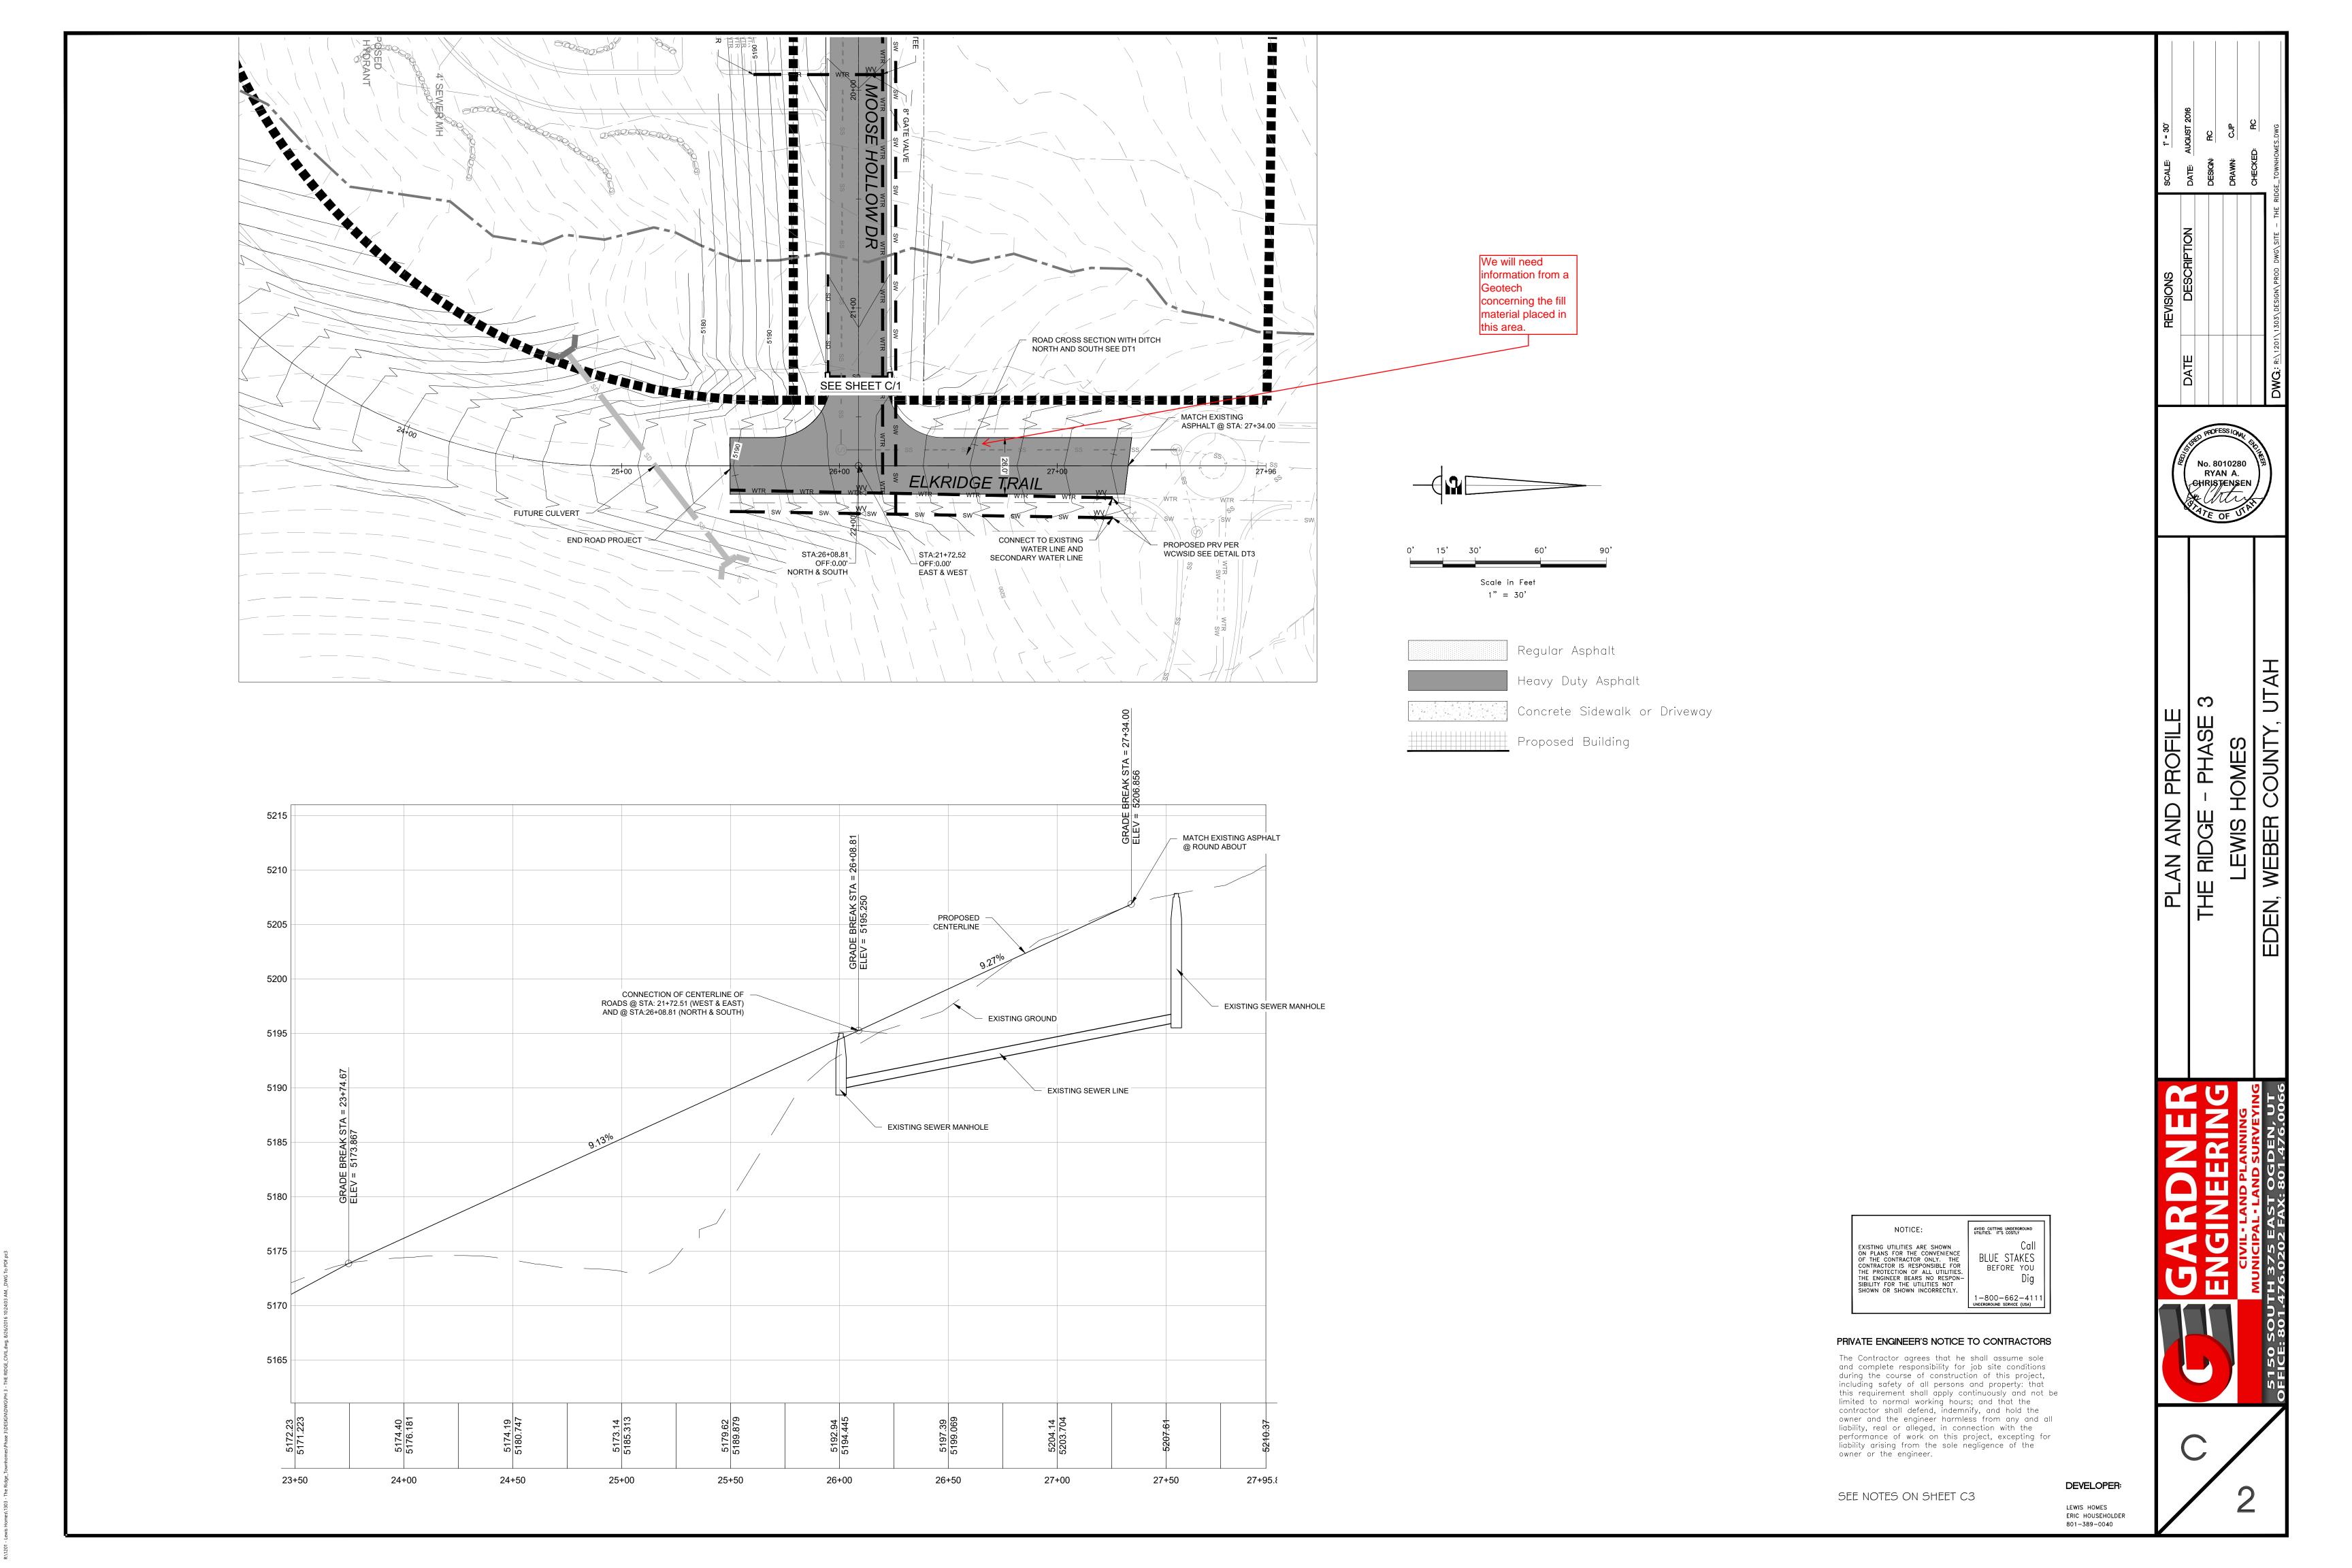

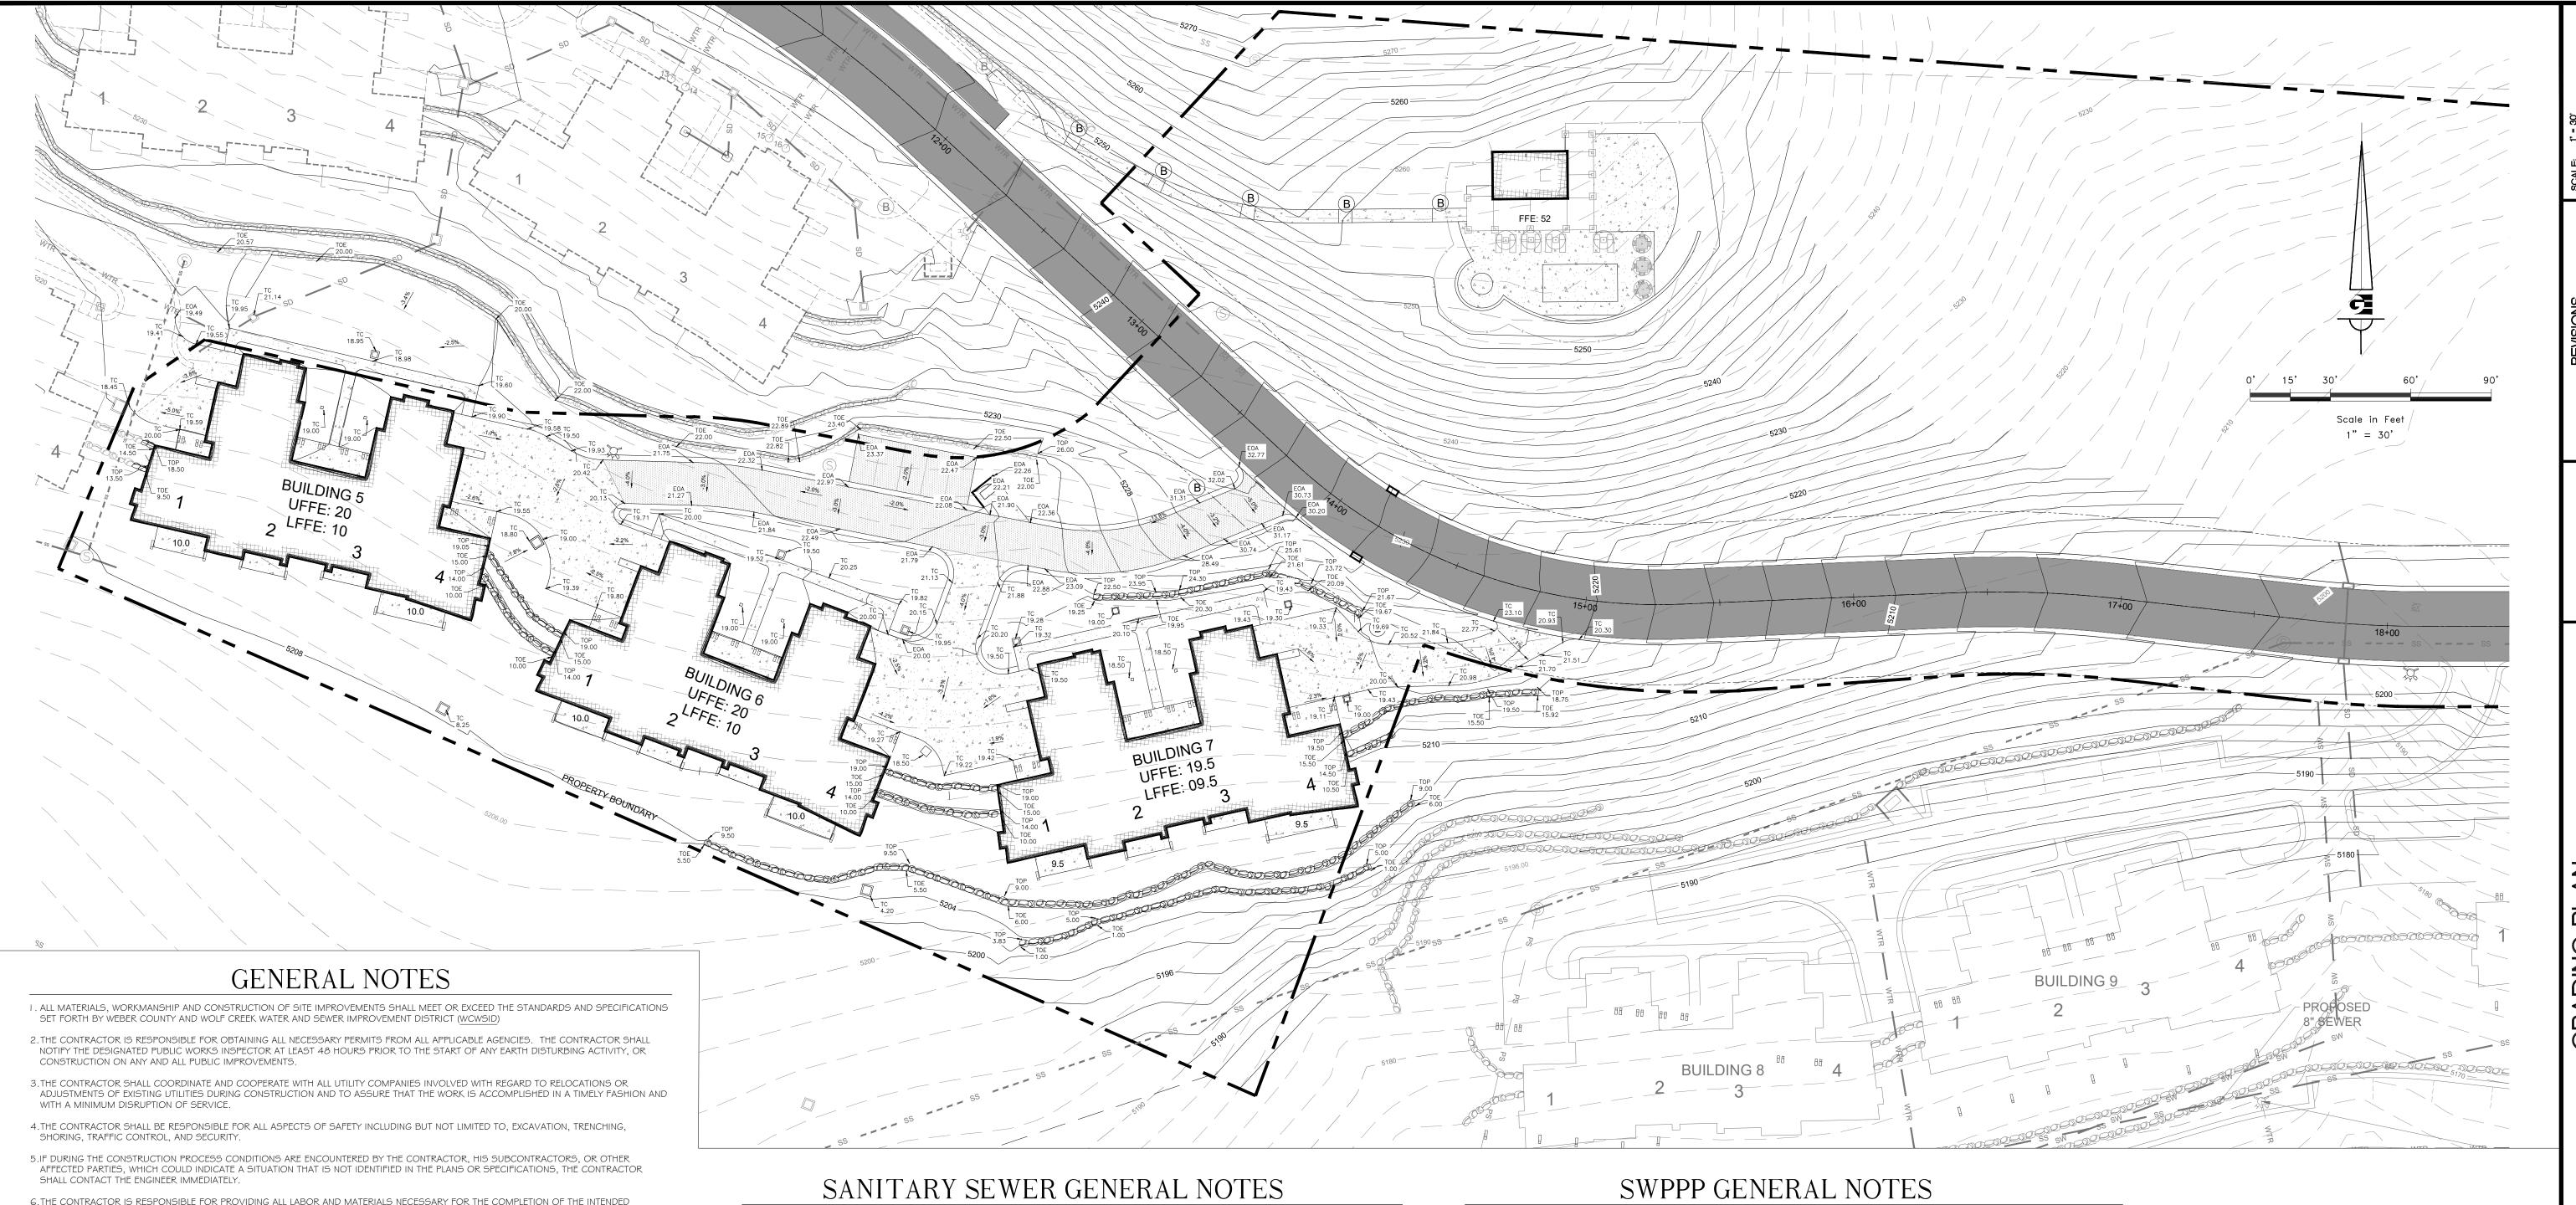

- 6.THE CONTRACTOR IS RESPONSIBLE FOR PROVIDING ALL LABOR AND MATERIALS NECESSARY FOR THE COMPLETION OF THE INTENDED IMPROVEMENTS SHOWN ON THESE DRAWINGS OR DESIGNATED TO BE PROVIDED, INSTALLED, CONSTRUCTED, REMOVED AND RELOCATED UNLESS SPECIFICALLY NOTED OTHERWISE.
- 7. THE CONTRACTOR SHALL BE RESPONSIBLE FOR KEEPING ROADWAYS FREE AND CLEAR OF ALL CONSTRUCTION DEBRIS AND DIRT TRACKED FROM THE SITE.
- 8.THE CONTRACTOR SHALL BE RESPONSIBLE FOR RECORDING AS-BUILT DRAWINGS ON A SET OF RECORD DRAWINGS KEPT AT THE CONSTRUCTION SITE, AND AVAILABLE TO THE OWNER.
- 9. THE CONTRACTOR SHALL SEQUENCE INSTALLATION OF UTILITIES IN SUCH A MANNER AS TO MINIMIZE POTENTIAL UTILITY CONFLICTS. IN GENERAL, STORM SEWER AND SANITARY SEWER SHOULD BE CONSTRUCTED PRIOR TO INSTALLATION OF WATER LINES AND DRY UTILITIES.
- 10. IT SHALL BE THE RESPONSIBILITY OF THE CONTRACTOR TO COORDINATE ALL UTILITY RELOCATIONS CONSISTENT WITH THE CONTRACTORS SCHEDULE FOR THIS PROJECT, WHETHER SHOWN OR NOT SHOWN AS IT RELATES TO THE CONSTRUCTION ACTIVITIES CONTEMPLATED IN THESE
- II. THE RECOMMENDATIONS OF THE GEOTECHNICAL REPORT SHALL BE FOLLOWED.

NOTICE TO CONTRACTOR

ALL CONTRACTORS AND SUBCONTRACTORS PERFORMING WORK SHOWN ON OR RELATED TO THESE PLANS SHALL CONDUCT THEIR OPERATIONS SO THAT ALL EMPLOYEES ARE PROVIDED A SAFE PLACE TO WORK AND THE PUBLIC IS PROTECTED. ALL CONTRACTORS AND SUBCONTRACTORS SHALL COMPLY WITH THE "OCCUPATIONAL SAFETY AND HEALTH REGULATIONS: OF THE U.S. DEPARTMENT OF LABOR AND THE STATE OF UTAH DEPARTMENT OF INDUSTRIAL RELATIONS CONSTRUCTION SAFETY ORDERS". THE CIVIL ENGINEER SHALL NOT BE RESPONSIBLE IN ANY WAY FOR CONTRACTORS AND SUBCONTRACTORS COMPLIANCE WITH SAID REGULATIONS AND ORDERS.

CONTRACTOR FURTHER AGREES THAT HE SHALL ASSUME SOLE AND COMPLETE RESPONSIBILITY FOR JOB-SITE CONDITIONS DURING THE COURSE OF CONSTRUCTION OF THIS PROJECT, INCLUDING SAFETY OF ALL PERSONS AND PROPERTY, THAT THIS REQUIREMENT SHALL APPLY CONTINUOUSLY AND NOT BE LIMITED TO NORMAL WORKING HOURS, AND THAT THE CONTRACTOR SHALL DEFEND, INDEMNIFY AND HOLD THE OWNER AND THE CIVIL ENGINEER HARMLESS FROM ANY AND ALL LIABILITY, REAL OR ALLEGED IN CONNECTION WITH THE PERFORMANCE OF WORK ON THIS PROJECT, EXCEPTING FOR LIABILITY ARISING FROM THE SOLE NEGLIGENCE OF THE OWNER OR ENGINEER.

STORM SEWER GENERAL NOTES

- I. ALL STORM SEWER CONNECTIONS SHALL BE IN CONFORMANCE WITH THE WEBER COUNTY STANDARDS AND SPECIFICATIONS. STORM DRAIN PIPE WITHIN THE ROADWAY SHALL BE 15" DIAM. MIN. RCP CLASS III. LINES OUTSIDE OF ROADWAY SHALL BE PVC SDR 35.
- 2.RIM ELEVATIONS SHOWN ARE APPROXIMATE ONLY AND ARE NOT TO BE TAKEN AS FINAL ELEVATION. PIPELINE CONTRACTOR SHALL USE PRECAST CONCRETE ADJUSTMENT RINGS, GROUT, AND STEEL SHIMS TO ADJUST THE MANHOLE FRAME TO THE REQUIRED FINAL GRADE IN CONFORMANCE WITH THE OGDEN CITY STANDARDS AND SPECIFICATIONS AND PLANS. ALL FRAMES SHALL BE ADJUSTED TO FINAL GRADE PRIOR TO PLACEMENT OF ASPHALT PAVING.
- 3.COMPACTION OF ALL TRENCHES WITHIN THE PROJECT SITE MUST BE ATTAINED AND COMPACTION RESULTS SUBMITTED PRIOR TO FINAL ACCEPTANCE.
- 4.ALL STORM DRAIN PIPES IN THE PUBLIC RIGHT-OF-WAY SHALL BE RCP CL III.
- 5.ALL STORM SEWER MANHOLES IN PAVED AREAS SHALL BE FLUSH WITH THE PAVEMENT AND SHALL HAVE TRAFFIC BEARING LIDS. ALL STORM SEWER LIDS SHALL BE LABELED "STORM DRAIN".
- 6. WHERE CONNECTION TO EXISTING UTILITY IS PROPOSED, CONTRACTOR SHALL VERIFY LOCATION AND ELEVATION AND NOTIFY OWNER/ENGINEER IF LOCATION AND ELEVATION OF EXISTING UTILITY VARIES FROM THE DESIGN.

- I. ALL SANITARY SEWER CONSTRUCTION SHALL BE IN CONFORMANCE WITH WCWSID STANDARDS AND SPECIFICATIONS. 2.ALL GRAVITY SANITARY SEWER LINES SHALL BE SDR-35 PVC MATERIAL. SEWER LINE CONSTRUCTION AND MATERIALS SHALL CONFORM TO ASTM STANDARDS AND SPECIFICATIONS.
- 3.DISTANCES SHOWN ON PLANS ARE APPROXIMATE AND COULD VARY DUE TO VERTICAL ALIGNMENT.

OWNER/ENGINEER IF LOCATION AND ELEVATION OF EXISTING UTILITY VARIES FROM THE DESIGN.

- 4.RIM ELEVATIONS SHOWN ARE APPROXIMATE ONLY AND ARE NOT TO BE TAKEN AS FINAL ELEVATION. PIPELINE CONTRACTOR SHALL USE PRECAST CONCRETE ADJUSTMENT RINGS, GROUT AND STEEL SHIMS TO ADJUST THE MANHOLE FRAME TO THE REQUIRED FINAL GRADE IN CONFORMANCE WITH THE STANDARD SPECIFICATIONS. ALL FRAMES SHALL BE ADJUSTED TO FINAL GRADE.
- 5. ALL SANITARY SEWER MAIN TESTING SHALL BE IN ACCORDANCE WITH THE WCWSID STANDARDS AND SPECIFICATIONS. COPIES OF ALL TEST RESULTS SHALL BE PROVIDED PRIOR TO FINAL ACCEPTANCE. 6.COMPACTION TESTING OF ALL TRENCHES WITH THE PROJECT SITE MUST BE ATTAINED AND RESULTS SUBMITTED PRIOR TO FINAL ACCEPTANCE.

7. CONTRACTOR IS RESPONSIBLE TO PROTECT ALL EXISTING STRUCTURES AND IMPROVEMENTS DURING INSTALLATION OF SANITARY SEWER

8. WHERE CONNECTION TO EXISTING UTILITY IS PROPOSED, CONTRACTOR SHALL VERIFY LOCATION AND ELEVATION AND NOTIFY

GENERAL GRADING NOTES

- I. ALL WORK SHALL BE IN ACCORDANCE WITH THE WEBER COUNTY STANDARDS AND DIRECTION FROM SOILS REPORT (GEOSTRATA | 2/3/13). 2.MAXIMUM SLOPES SHALL BE 2.5: I FOR CUT AND FILL UNLESS OTHERWISE NOTED (SEE NOTE 12).
- 3.COMPACTION REQUIREMENTS AND TESTING SHALL BE PERFORMED TO MEET THE REQUIREMENTS OF THE SOILS REPORT. MINIMUM COMPACTION TESTS AT 1 FT LIFTS.
- 4. IN AREAS WHERE BASEMENT ELEVATIONS ARE GREATER THAN 4 FT BELOW EXISTING GROUND FOUNDATION DRAINAGE SHALL BE INSTALLED PER THE SOILS REPORT. IT IS ASSUMED THAT FOUNDATION DRAINAGE WILL BE REQUIRED ON THE NORTH SIDE OF BUILDING 2.
- 5.NO FILL SHALL BE PLACED UNTIL VEGETATION HAS BEEN REMOVED AND SUB-GRADE PREPARED PER THE SOILS REPORT.

7.CONTRACTOR SHALL COMPLY WITH STORM WATER POLLUTION PREVENTION PLAN BY INSTALLING BMP'S PRIOR TO COMMENCEMENT OF

- 6.DUST SHALL BE CONTROLLED BY WATERING OR OTHER APPROVED METHODS.
- EXCAVATION ACTIVITIES. CONTACT THE CITY INSPECTOR FOR INSPECTION.
- 8.THE CONTRACTOR SHALL CONTACT BLUE STAKES FOR LOCATION MARKING PRIOR TO COMMENCING EXCAVATION ACTIVITIES. 9.STREETS ADJACENT TO THE PROJECT SHALL BE CLEAN AT ALL TIMES.
- 10. CONTRACTOR IS RESPONSIBLE FOR ARRANGING FOR ALL REQUIRED INSPECTIONS.
- II. PRIOR TO TAKING WATER FROM A CITY FIRE HYDRANT, THE CONTRACTOR SHALL MAKE ARRANGEMENTS WITH WATER UTILITY TO OBTAIN A WATER METER.
- I 2. IF WATER IS ENCOUNTERED ON CUT SLOPES, PERFORATED LAND DRAIN OR OTHER GROUNDWATER MITIGATION SHALL BE INSTALLED TO DIRECT WATER TO ROADWAY OR STORM DRAIN. WHERE SITE CONDITIONS ALLOW, ROCK WALLS MAYBE USED TO MINIMIZE CUT SLOPE. WALLS WILL BE CONSTRUCTED IN ACCORDANCE WITH RETAINING WALL DETAIL ON THE SITE DETAILS SHEET.


I. CONTRACTOR SHALL OBTAIN ALL NECESSARY PERMITS AS REQUIRED BY THE CITY AND STATE. 2. ALL STRUCTURAL EROSION MEASURES SHALL BE INSTALLED AT THE LIMITS OF CONSTRUCTION, PRIOR TO ANY OTHER GROUND-DISTURBING ACTIVITY. ALL EROSION CONTROL MEASURES SHALL BE MAINTAINED IN GOOD REPAIR BY THE CONTRACTOR, UNTIL SUCH TIME AS THE ENTIRE DISTURBED AREAS ARE STABILIZED WITH HARD SURFACE OR LANDSCAPING.

WATER GENERAL NOTES

- I. ALL INSTALLATION AND MATERIALS SHALL CONFORM TO WCWSID STANDARDS AND SPECIFICATIONS AND PLANS. CULINARY WATERLINES SHALL BE DUCTILE IRON CLASS 52. ALL SECONDARY WATERLINES SHALL BE PVC C900 DR 14.
- 2.TRUST BLOCKING IS REQUIRED AT ALL BENDS AND FITTINGS. TIE RODS SHALL BE USED AT ALL BENDS AND FITTINGS WHERE THRUST BLOCKS DO NOT BEAR AGAINST UNDISTURBED SOIL.
- 3.ALL WATERLINES AT SEWER CROSSINGS SHALL BE LOCATED ABOVE AND HAVE AN 18-INCH VERTICAL SEPARATION FROM THE SEWER PIPE. IF THIS IS NOT PROVIDED, THE WATERLINE SHALL BE INSTALLED WITH 20 L.F. OF CASING CENTERED OVER THE SEWER PIPE.
- 4.DISINFECTION TESTS SHALL BE PERFORMED BY THE CONTRACTOR IN COORDINATION WITH THE DISTRICT.
- 5.CHLORINATION OF COMPLETED WATER LINE. THE NEW WATER LINES SHALL BE DISINFECTED BY CHLORINATION. THE CONTRACTOR WILL BE RESPONSIBLE FOR ALL RELATED COSTS AND FEES RELATED TO THE CHLORINATION OF THE COMPLETED WATER LINE. THIS TEST SHALL BE PERFORMED PRIOR TO CONNECTION OF THE NEW WATER LINES TO THE EXISTING WATER SYSTEM. THE CONTRACTOR SHALL NOTIFY HWID AT LEAST 24 HOURS BEFORE THE CHLORINATION IS DESIRED.
- 6. CONTRACTOR SHALL COORDINATE CONNECTION TO THE WATER LINE WITH THE DISTRICT.
- 7.A MINIMUM HORIZONTAL CLEARANCE OF 10 FEET SHALL BE MAINTAINED FROM SANITARY SEWER MAINS.
- 8.UNLESS OTHERWISE SPECIFIED, ALL WATERLINES SHALL BE DUCTILE IRON.
- 9. CONTRACTOR SHALL LOCATE VALVES PRIOR TO CONNECTION WITH EXISTING SYSTEM, BUT SHALL NOT OPERATE ANY VALVE WITHOUT PERMISSION FROM THE DISTRICT.
- IO. ALL WATER MAINS, VALVES, FIRE HYDRANTS, SERVICES AND APPURTENANCES SHALL BE INSTALLED, TESTED, AND APPROVED PRIOR TO
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- I 2. WATER METERS SHALL BE MARKED WITH IDENTIFICATION NUMBER AS SHOWN ON PLANS.

UTILITY DISCLAIMER

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Heavy Duty Asphalt

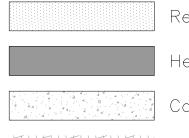Concrete Sidewalk or Driveway Proposed Building

AVOID CUTTING UNDERGROUND UTILITIES. IT'S COSTLY EXISTING UTILITIES ARE SHOWN ON PLANS FOR THE CONVENIENCE OF THE CONTRACTOR ONLY. THE CONTRACTOR IS RESPONSIBLE FOR


BLUE STAKES BEFORE YOU THE PROTECTION OF ALL UTILITIES.
THE ENGINEER BEARS NO RESPONSIBILITY FOR THE UTILITIES NOT
SHOWN OR SHOWN INCORRECTLY. I-800-662-411 UNDERGROUND SERVICE (USA)

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> **DEVELOPER:** LEWIS HOMES ERIC HOUSEHOLDER 801-389-0040





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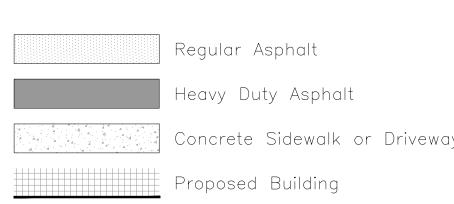
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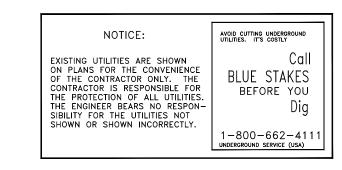
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> **DEVELOPER:** LEWIS HOMES ERIC HOUSEHOLDER 801-389-0040

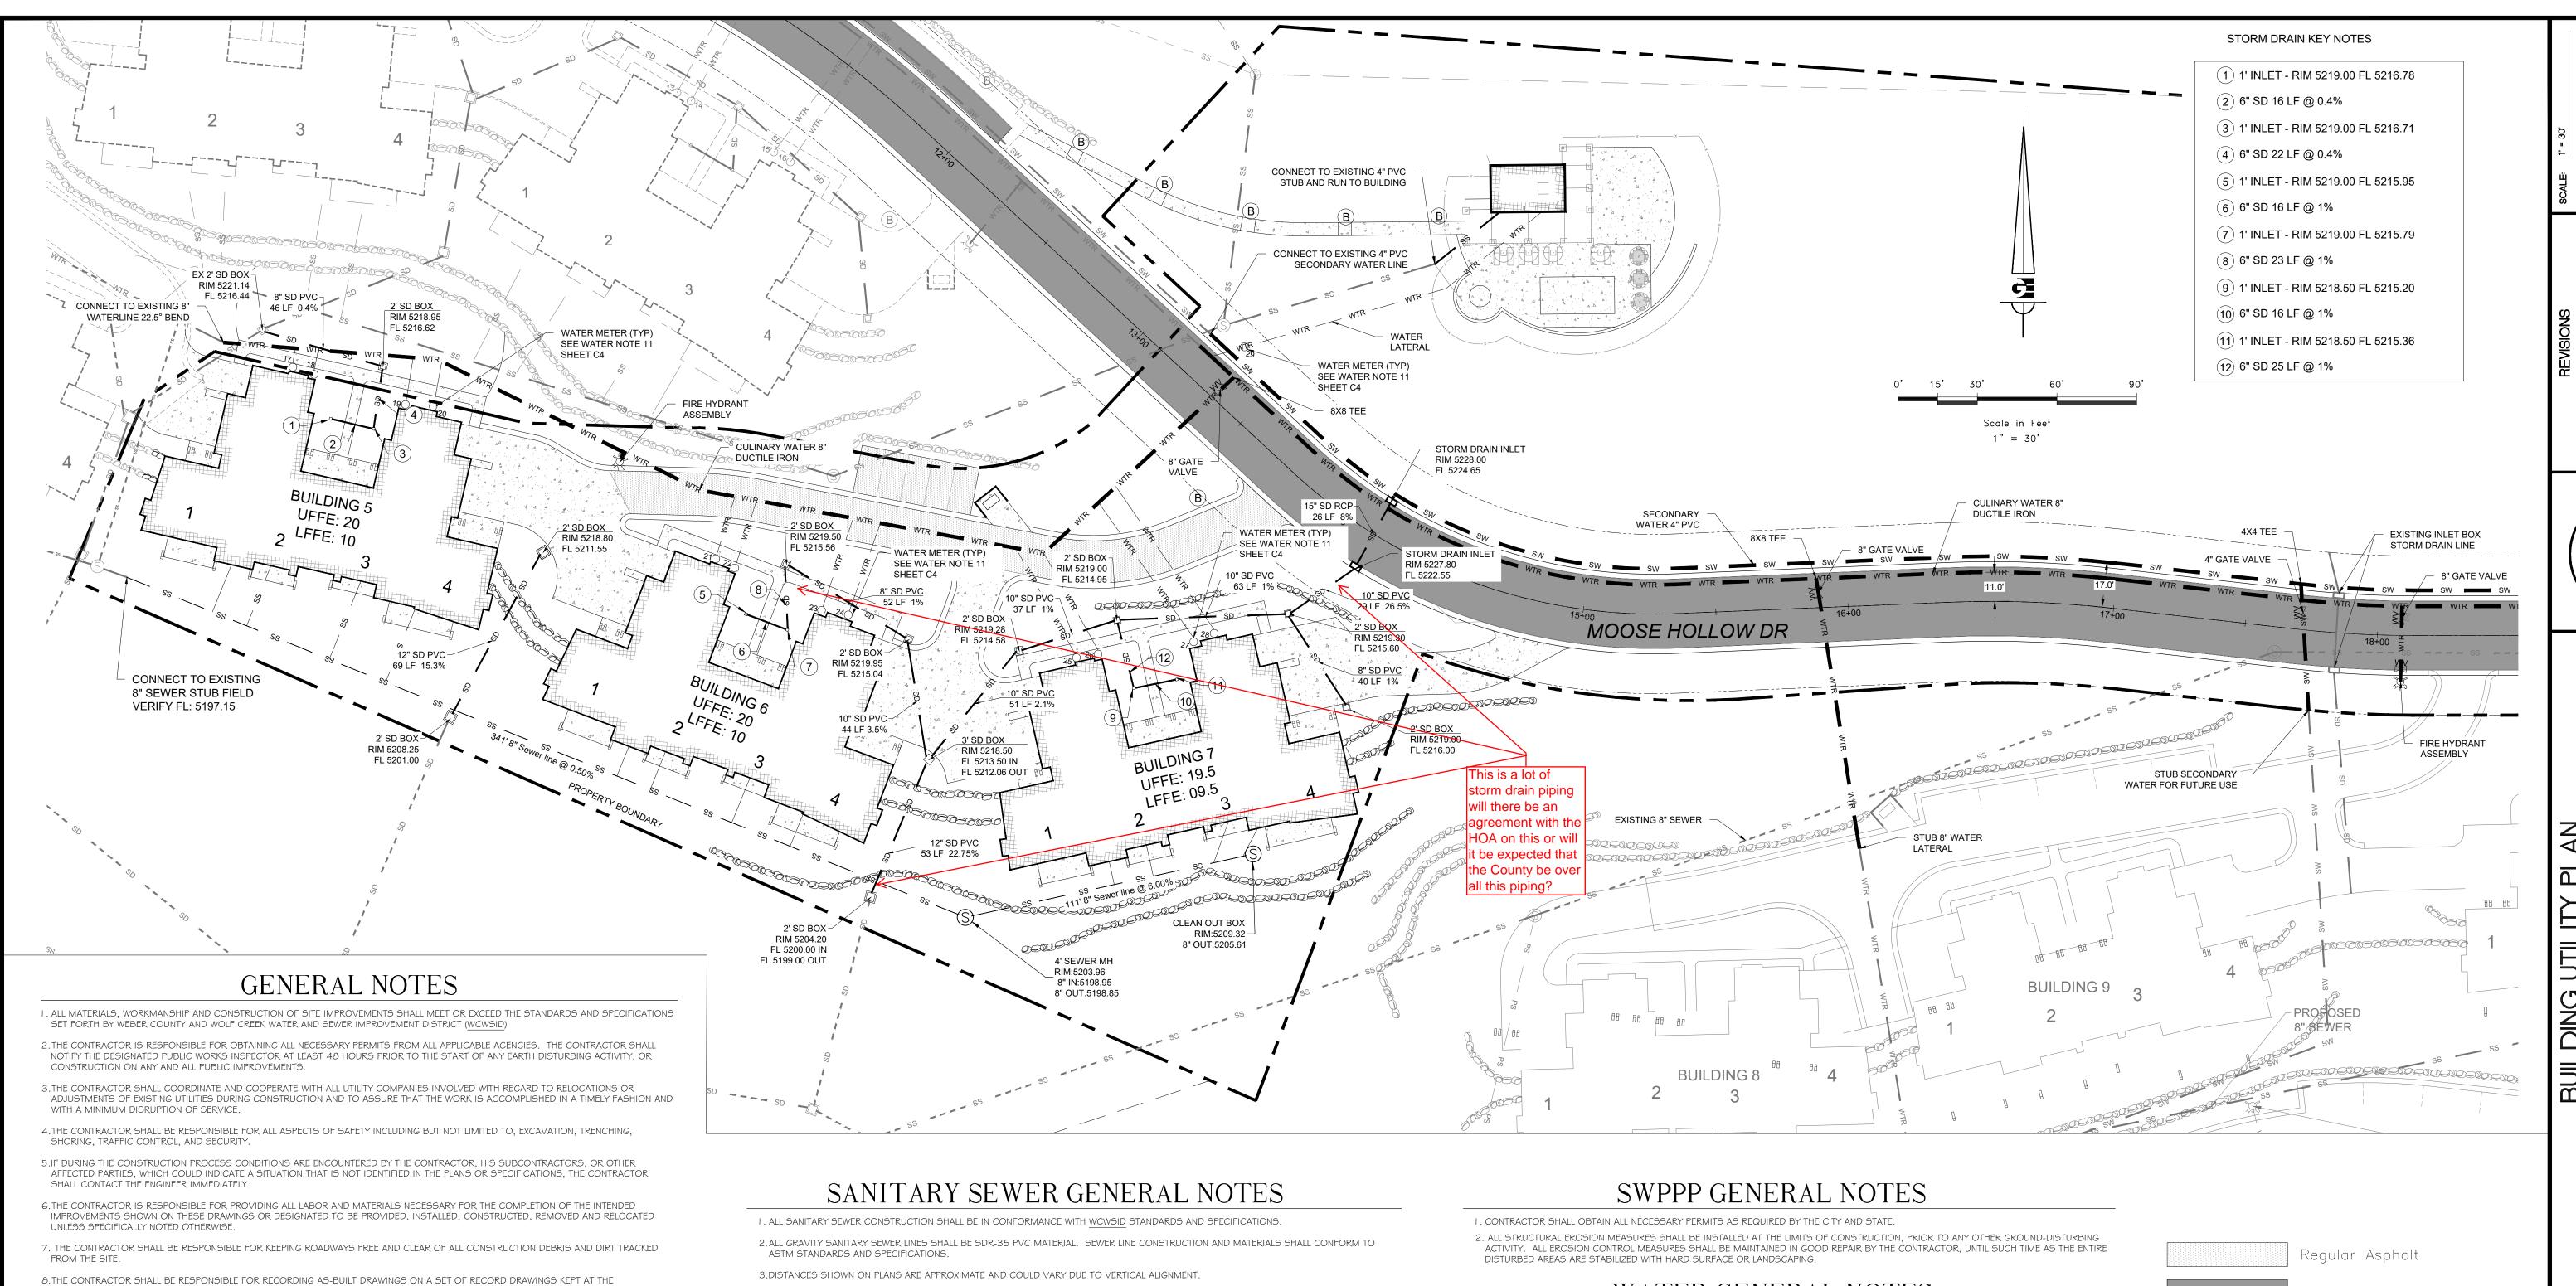CONSTRUCTION SITE, AND AVAILABLE TO THE OWNER.

PRIOR TO PLACEMENT OF ASPHALT PAVING.

SEWER LIDS SHALL BE LABELED "STORM DRAIN".

ACCEPTANCE.

II. THE RECOMMENDATIONS OF THE GEOTECHNICAL REPORT SHALL BE FOLLOWED.

CONTRACTORS AND SUBCONTRACTORS COMPLIANCE WITH SAID REGULATIONS AND ORDERS.

EXCEPTING FOR LIABILITY ARISING FROM THE SOLE NEGLIGENCE OF THE OWNER OR ENGINEER.

4.ALL STORM DRAIN PIPES IN THE PUBLIC RIGHT-OF-WAY SHALL BE RCP CL III.

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9. THE CONTRACTOR SHALL SEQUENCE INSTALLATION OF UTILITIES IN SUCH A MANNER AS TO MINIMIZE POTENTIAL UTILITY CONFLICTS. IN

GENERAL, STORM SEWER AND SANITARY SEWER SHOULD BE CONSTRUCTED PRIOR TO INSTALLATION OF WATER LINES AND DRY UTILITIES.

I O. IT SHALL BE THE RESPONSIBILITY OF THE CONTRACTOR TO COORDINATE ALL UTILITY RELOCATIONS CONSISTENT WITH THE CONTRACTORS

NOTICE TO CONTRACTOR

ALL CONTRACTORS AND SUBCONTRACTORS PERFORMING WORK SHOWN ON OR RELATED TO THESE PLANS SHALL CONDUCT THEIR OPERATIONS

CONTRACTOR FURTHER AGREES THAT HE SHALL ASSUME SOLE AND COMPLETE RESPONSIBILITY FOR JOB-SITE CONDITIONS DURING THE COURSE

OF CONSTRUCTION OF THIS PROJECT, INCLUDING SAFETY OF ALL PERSONS AND PROPERTY, THAT THIS REQUIREMENT SHALL APPLY CONTINUOUSLY

AND NOT BE LIMITED TO NORMAL WORKING HOURS, AND THAT THE CONTRACTOR SHALL DEFEND, INDEMNIFY AND HOLD THE OWNER AND THE CIVIL

I. ALL STORM SEWER CONNECTIONS SHALL BE IN CONFORMANCE WITH THE WEBER COUNTY STANDARDS AND SPECIFICATIONS. STORM DRAIN

PRECAST CONCRETE ADJUSTMENT RINGS, GROUT, AND STEEL SHIMS TO ADJUST THE MANHOLE FRAME TO THE REQUIRED FINAL GRADE IN

CONFORMANCE WITH THE OGDEN CITY STANDARDS AND SPECIFICATIONS AND PLANS. ALL FRAMES SHALL BE ADJUSTED TO FINAL GRADE

5.ALL STORM SEWER MANHOLES IN PAVED AREAS SHALL BE FLUSH WITH THE PAVEMENT AND SHALL HAVE TRAFFIC BEARING LIDS. ALL STORM

ENGINEER HARMLESS FROM ANY AND ALL LIABILITY, REAL OR ALLEGED IN CONNECTION WITH THE PERFORMANCE OF WORK ON THIS PROJECT,

STORM SEWER GENERAL NOTES

2.RIM ELEVATIONS SHOWN ARE APPROXIMATE ONLY AND ARE NOT TO BE TAKEN AS FINAL ELEVATION. PIPELINE CONTRACTOR SHALL USE

3.COMPACTION OF ALL TRENCHES WITHIN THE PROJECT SITE MUST BE ATTAINED AND COMPACTION RESULTS SUBMITTED PRIOR TO FINAL


PIPE WITHIN THE ROADWAY SHALL BE 15" DIAM. MIN. RCP CLASS III. LINES OUTSIDE OF ROADWAY SHALL BE PVC SDR 35.


SO THAT ALL EMPLOYEES ARE PROVIDED A SAFE PLACE TO WORK AND THE PUBLIC IS PROTECTED. ALL CONTRACTORS AND SUBCONTRACTORS


SHALL COMPLY WITH THE "OCCUPATIONAL SAFETY AND HEALTH REGULATIONS: OF THE U.S. DEPARTMENT OF LABOR AND THE STATE OF UTAH DEPARTMENT OF INDUSTRIAL RELATIONS CONSTRUCTION SAFETY ORDERS". THE CIVIL ENGINEER SHALL NOT BE RESPONSIBLE IN ANY WAY FOR

SCHEDULE FOR THIS PROJECT, WHETHER SHOWN OR NOT SHOWN AS IT RELATES TO THE CONSTRUCTION ACTIVITIES CONTEMPLATED IN THESE

RYAN A. CHRISTENSEN

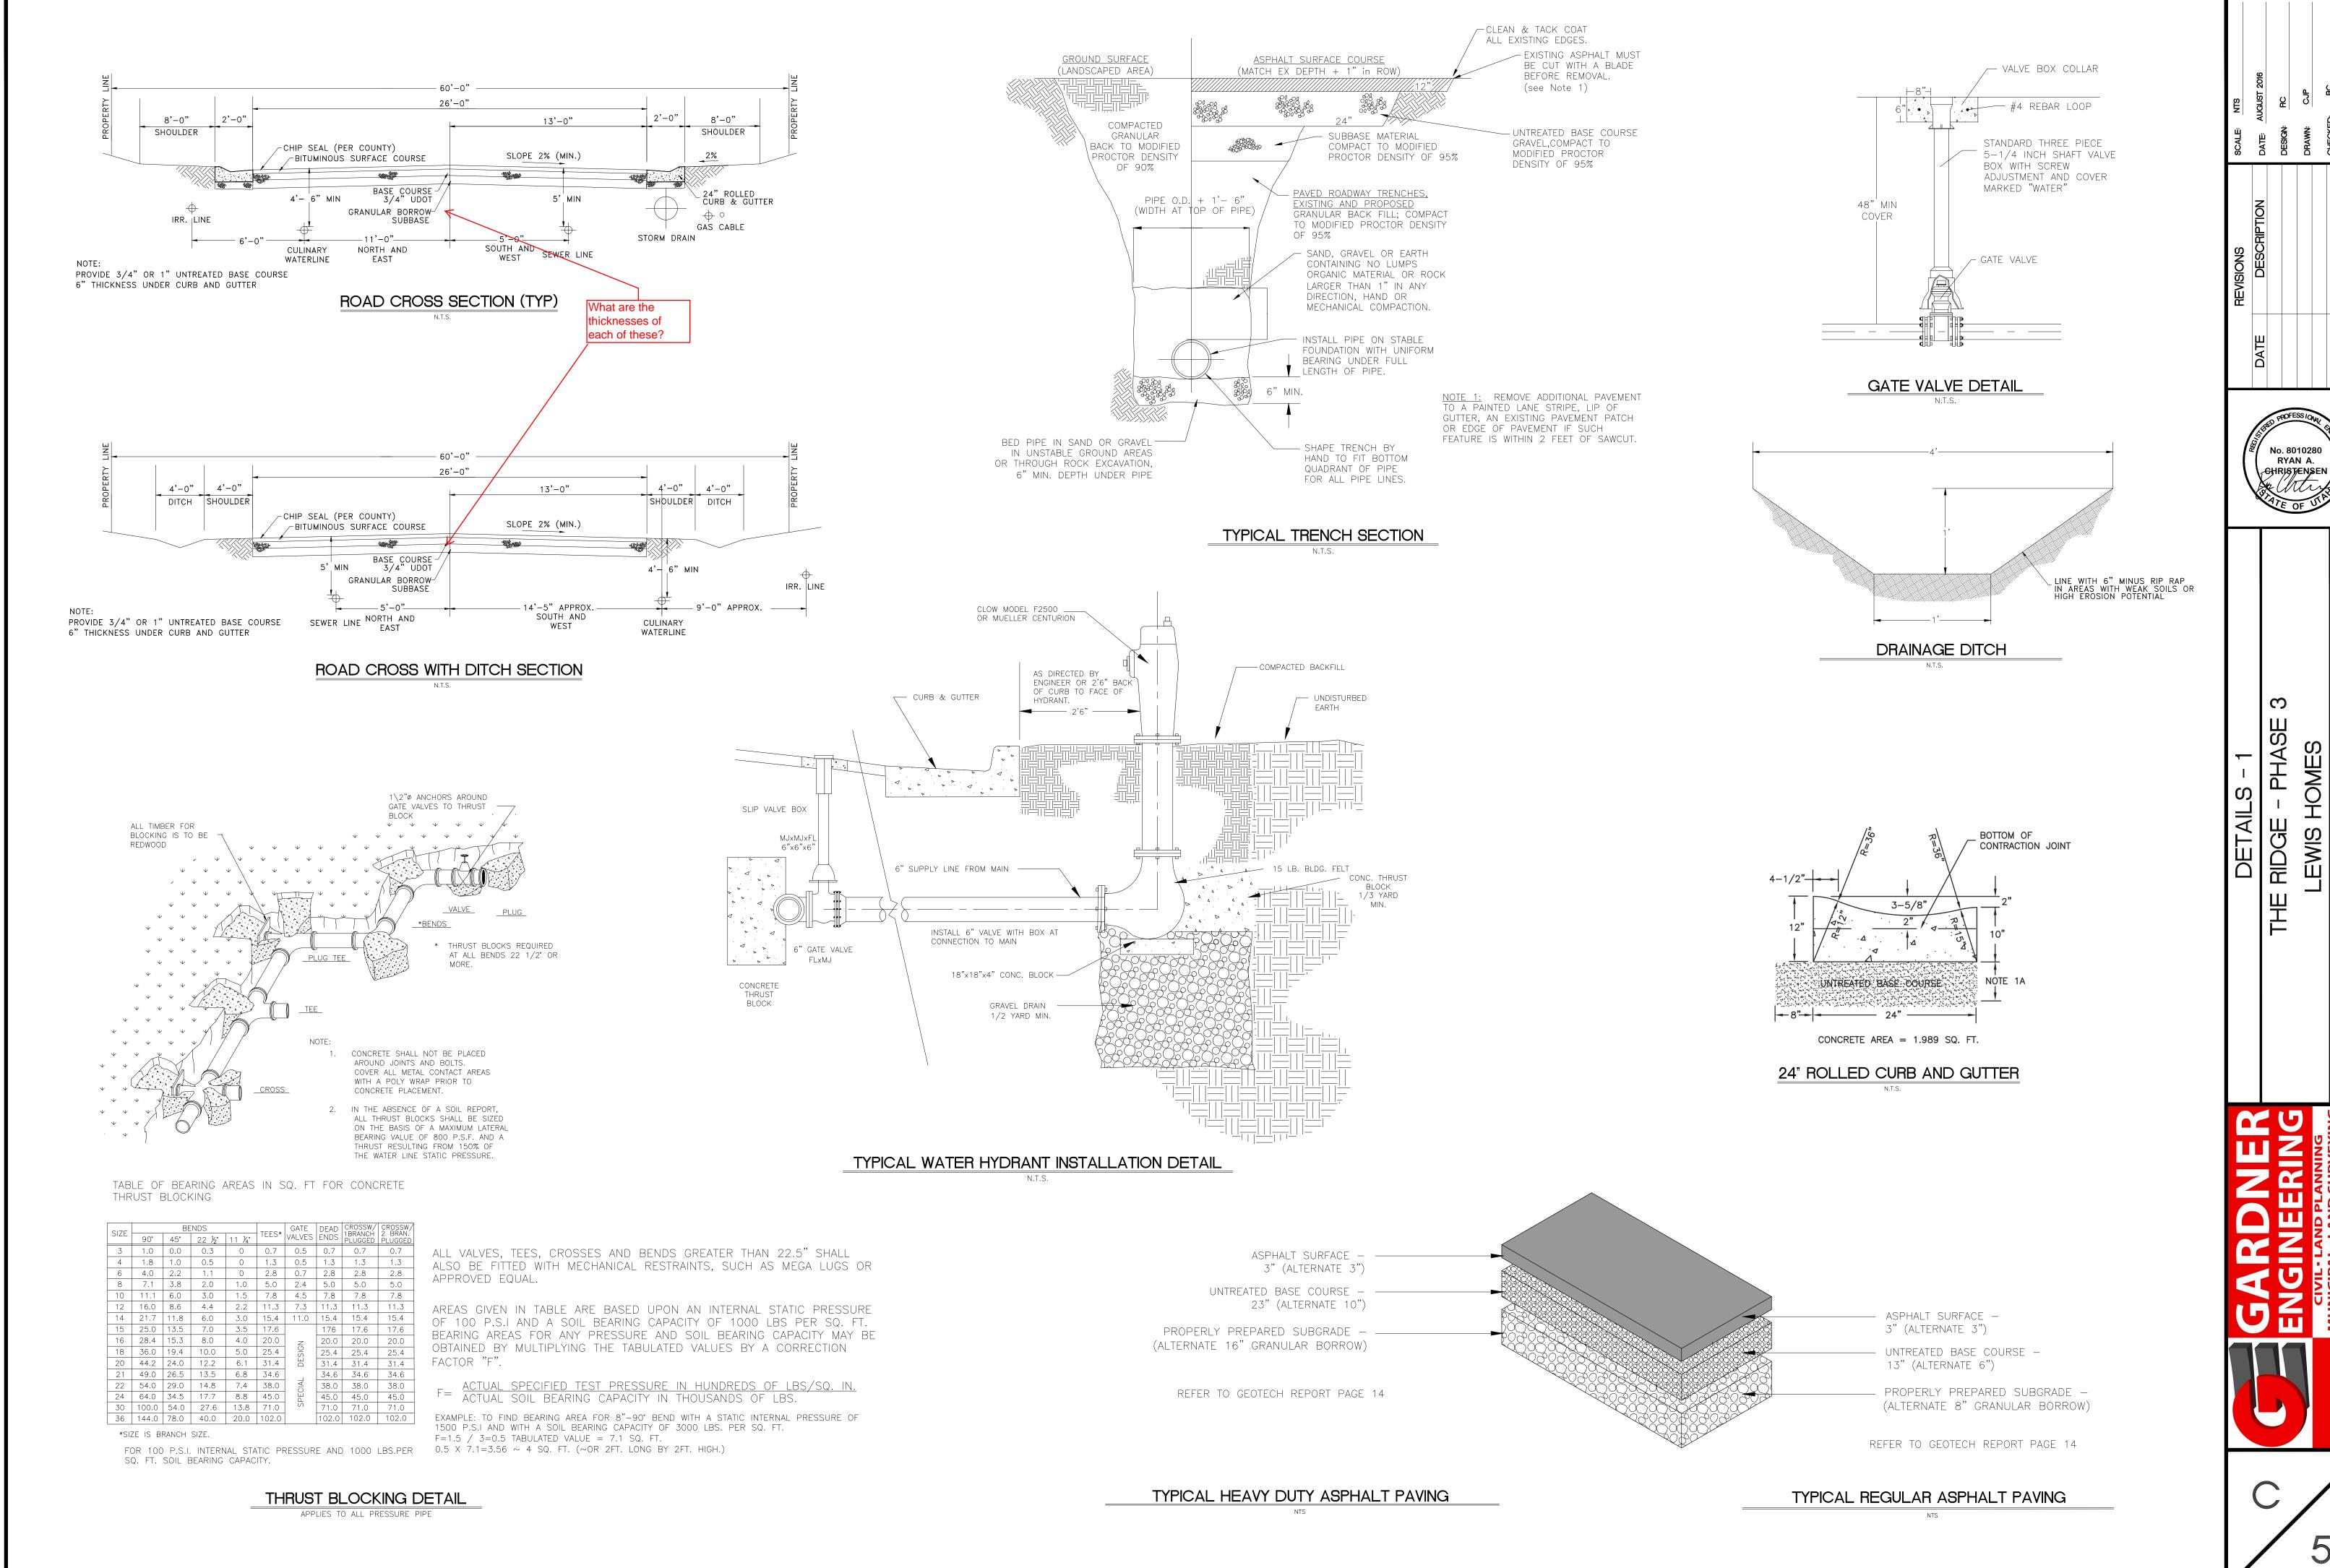

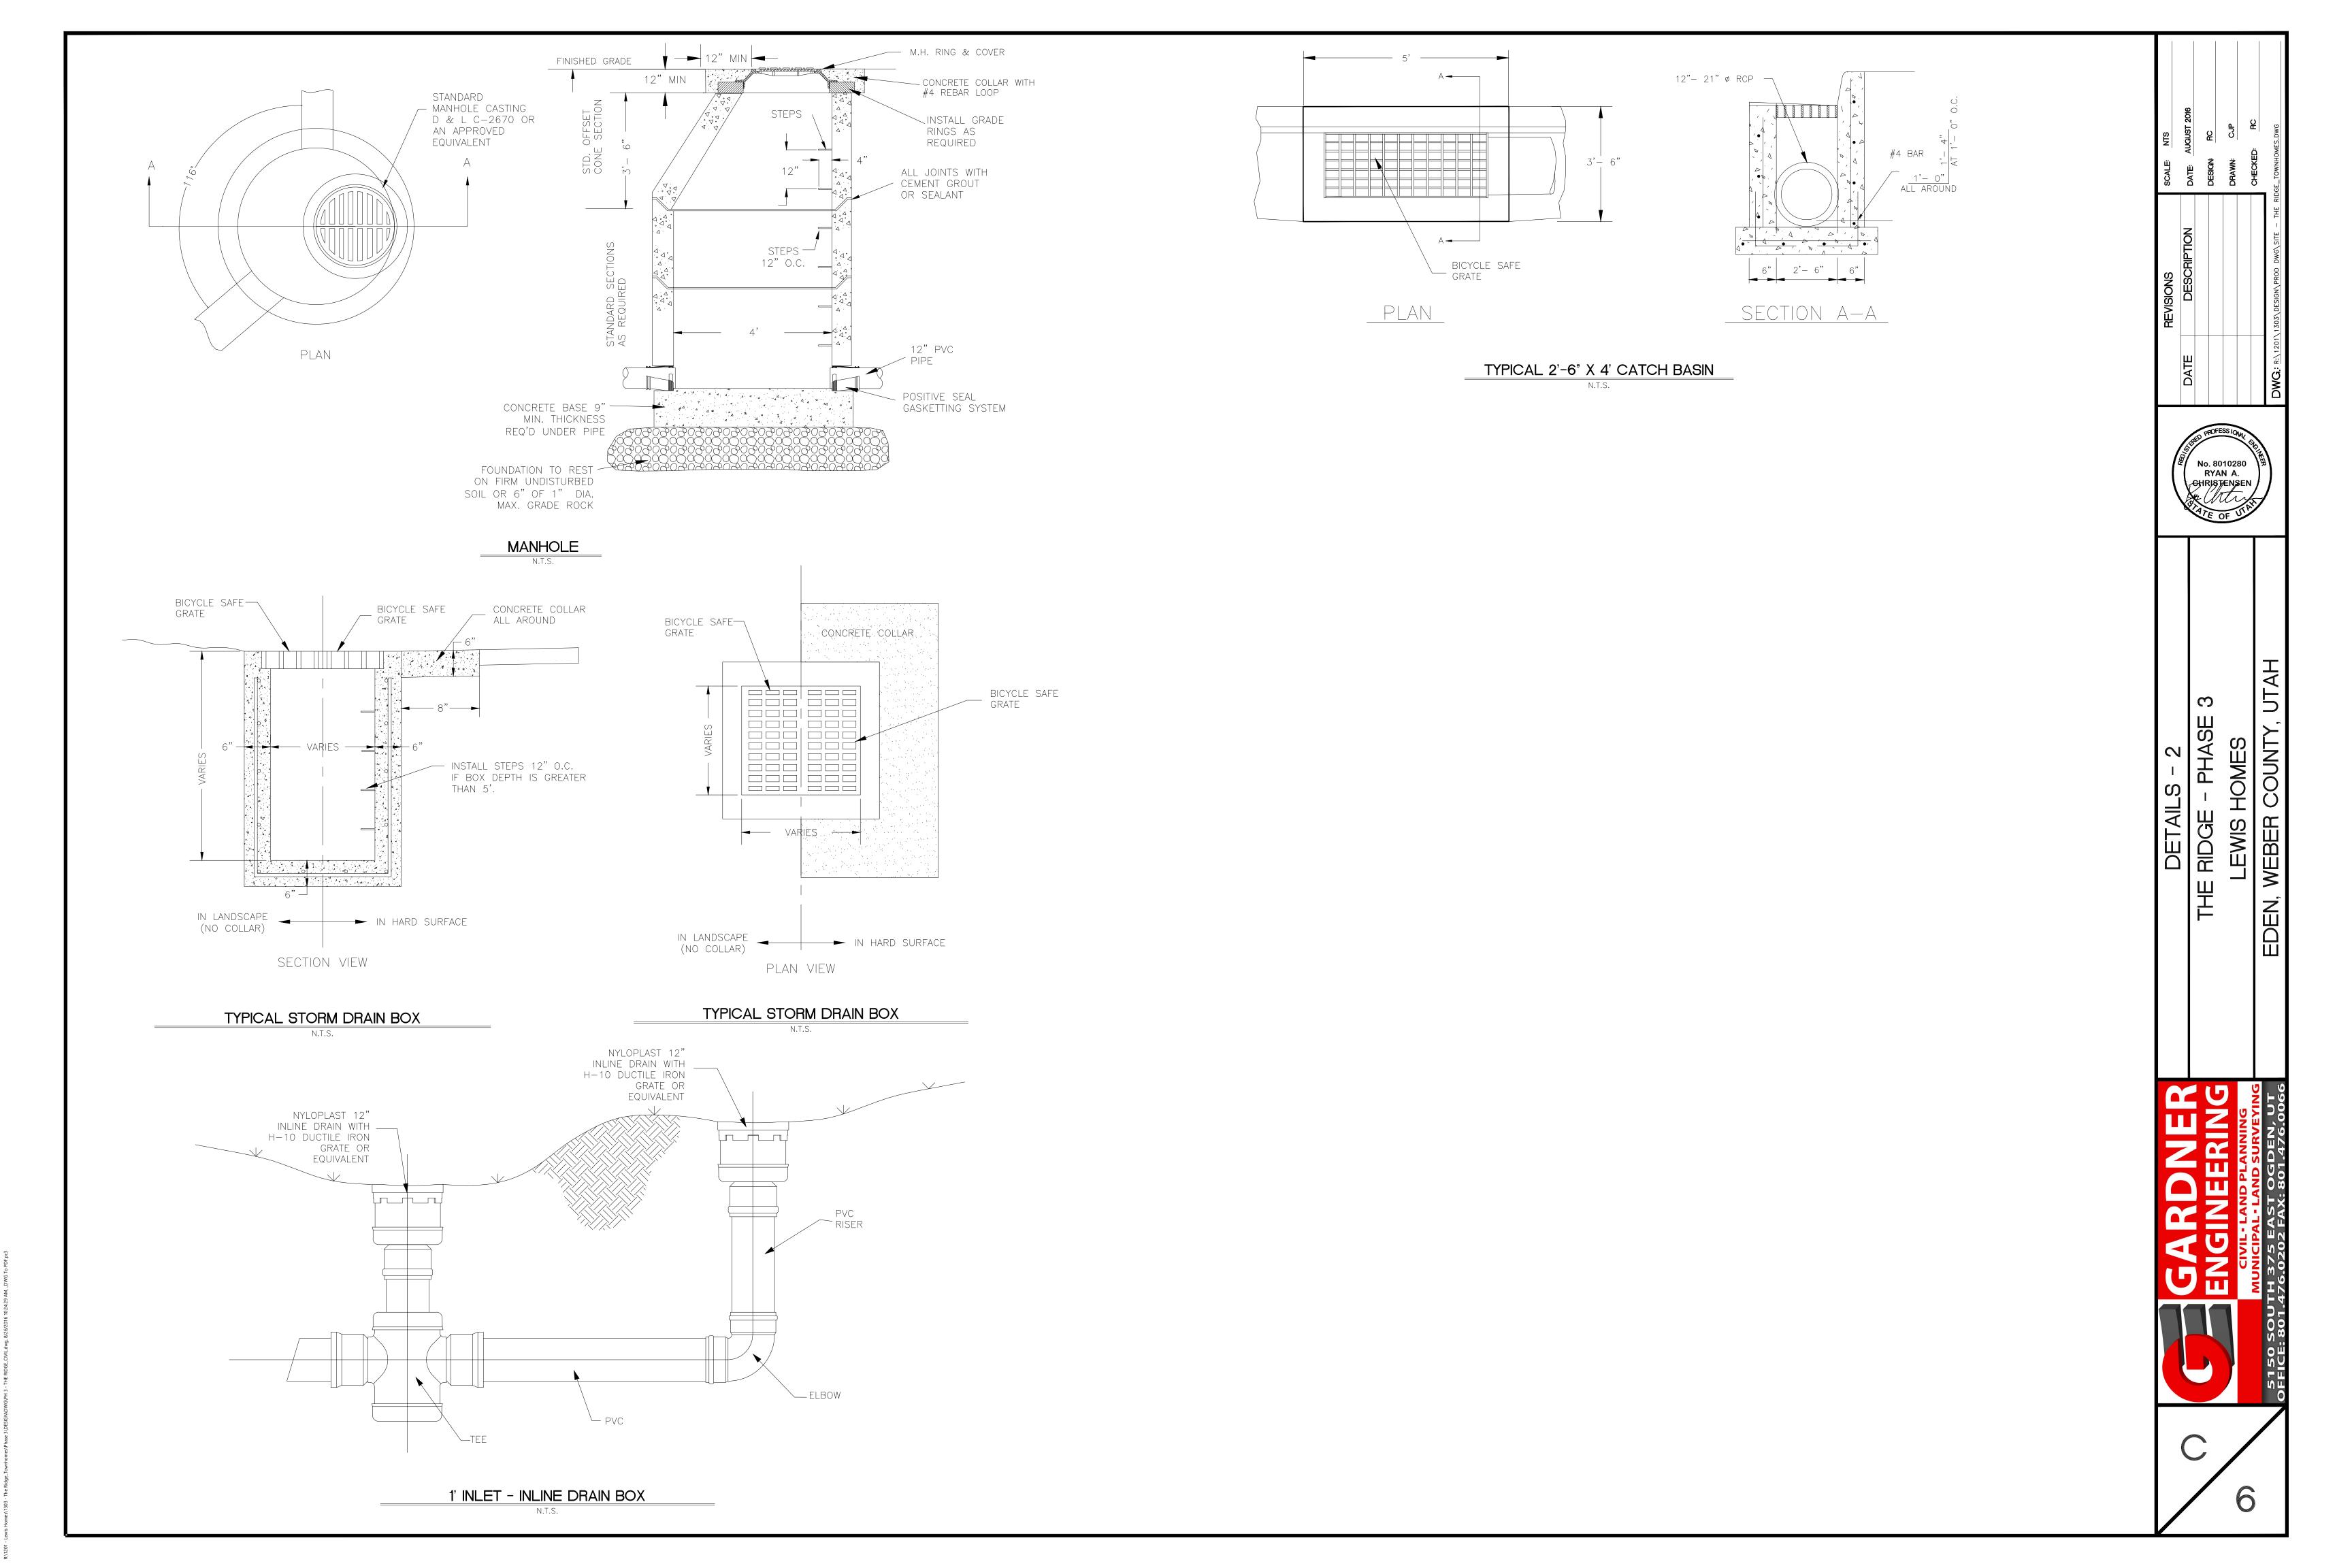

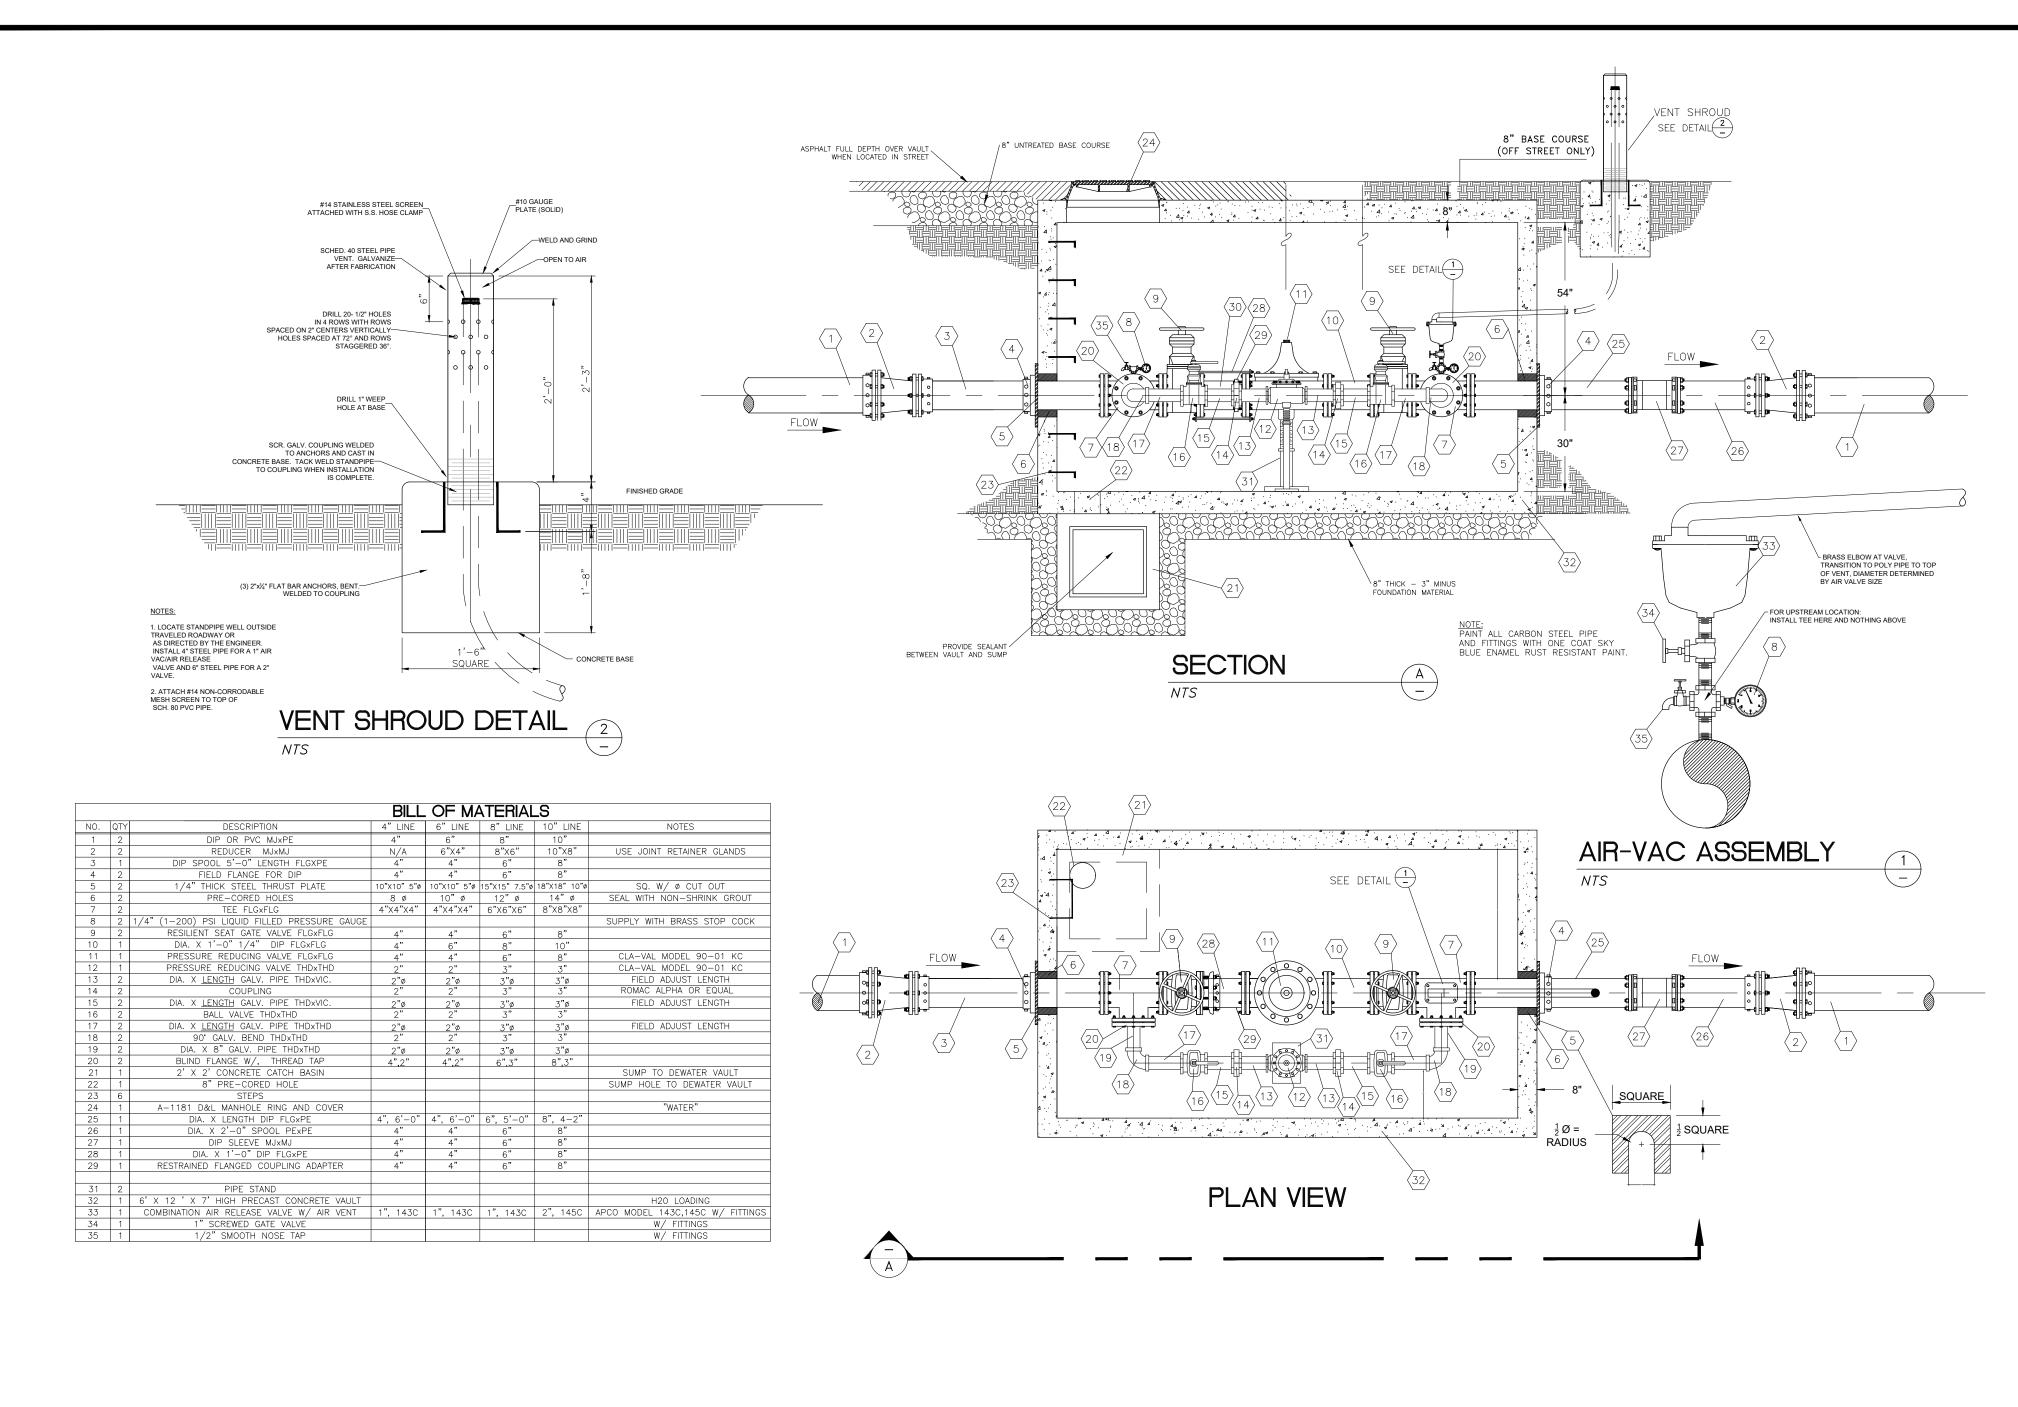

PRV DETAIL

N.T.S.

DETAILS - 3

THE RIDGE - PHASE 3


LEWIS HOMES

No. 8010280

RYAN A.
CHRISTENSEN

GARDN
GARINEER
ENGINEER

C/7

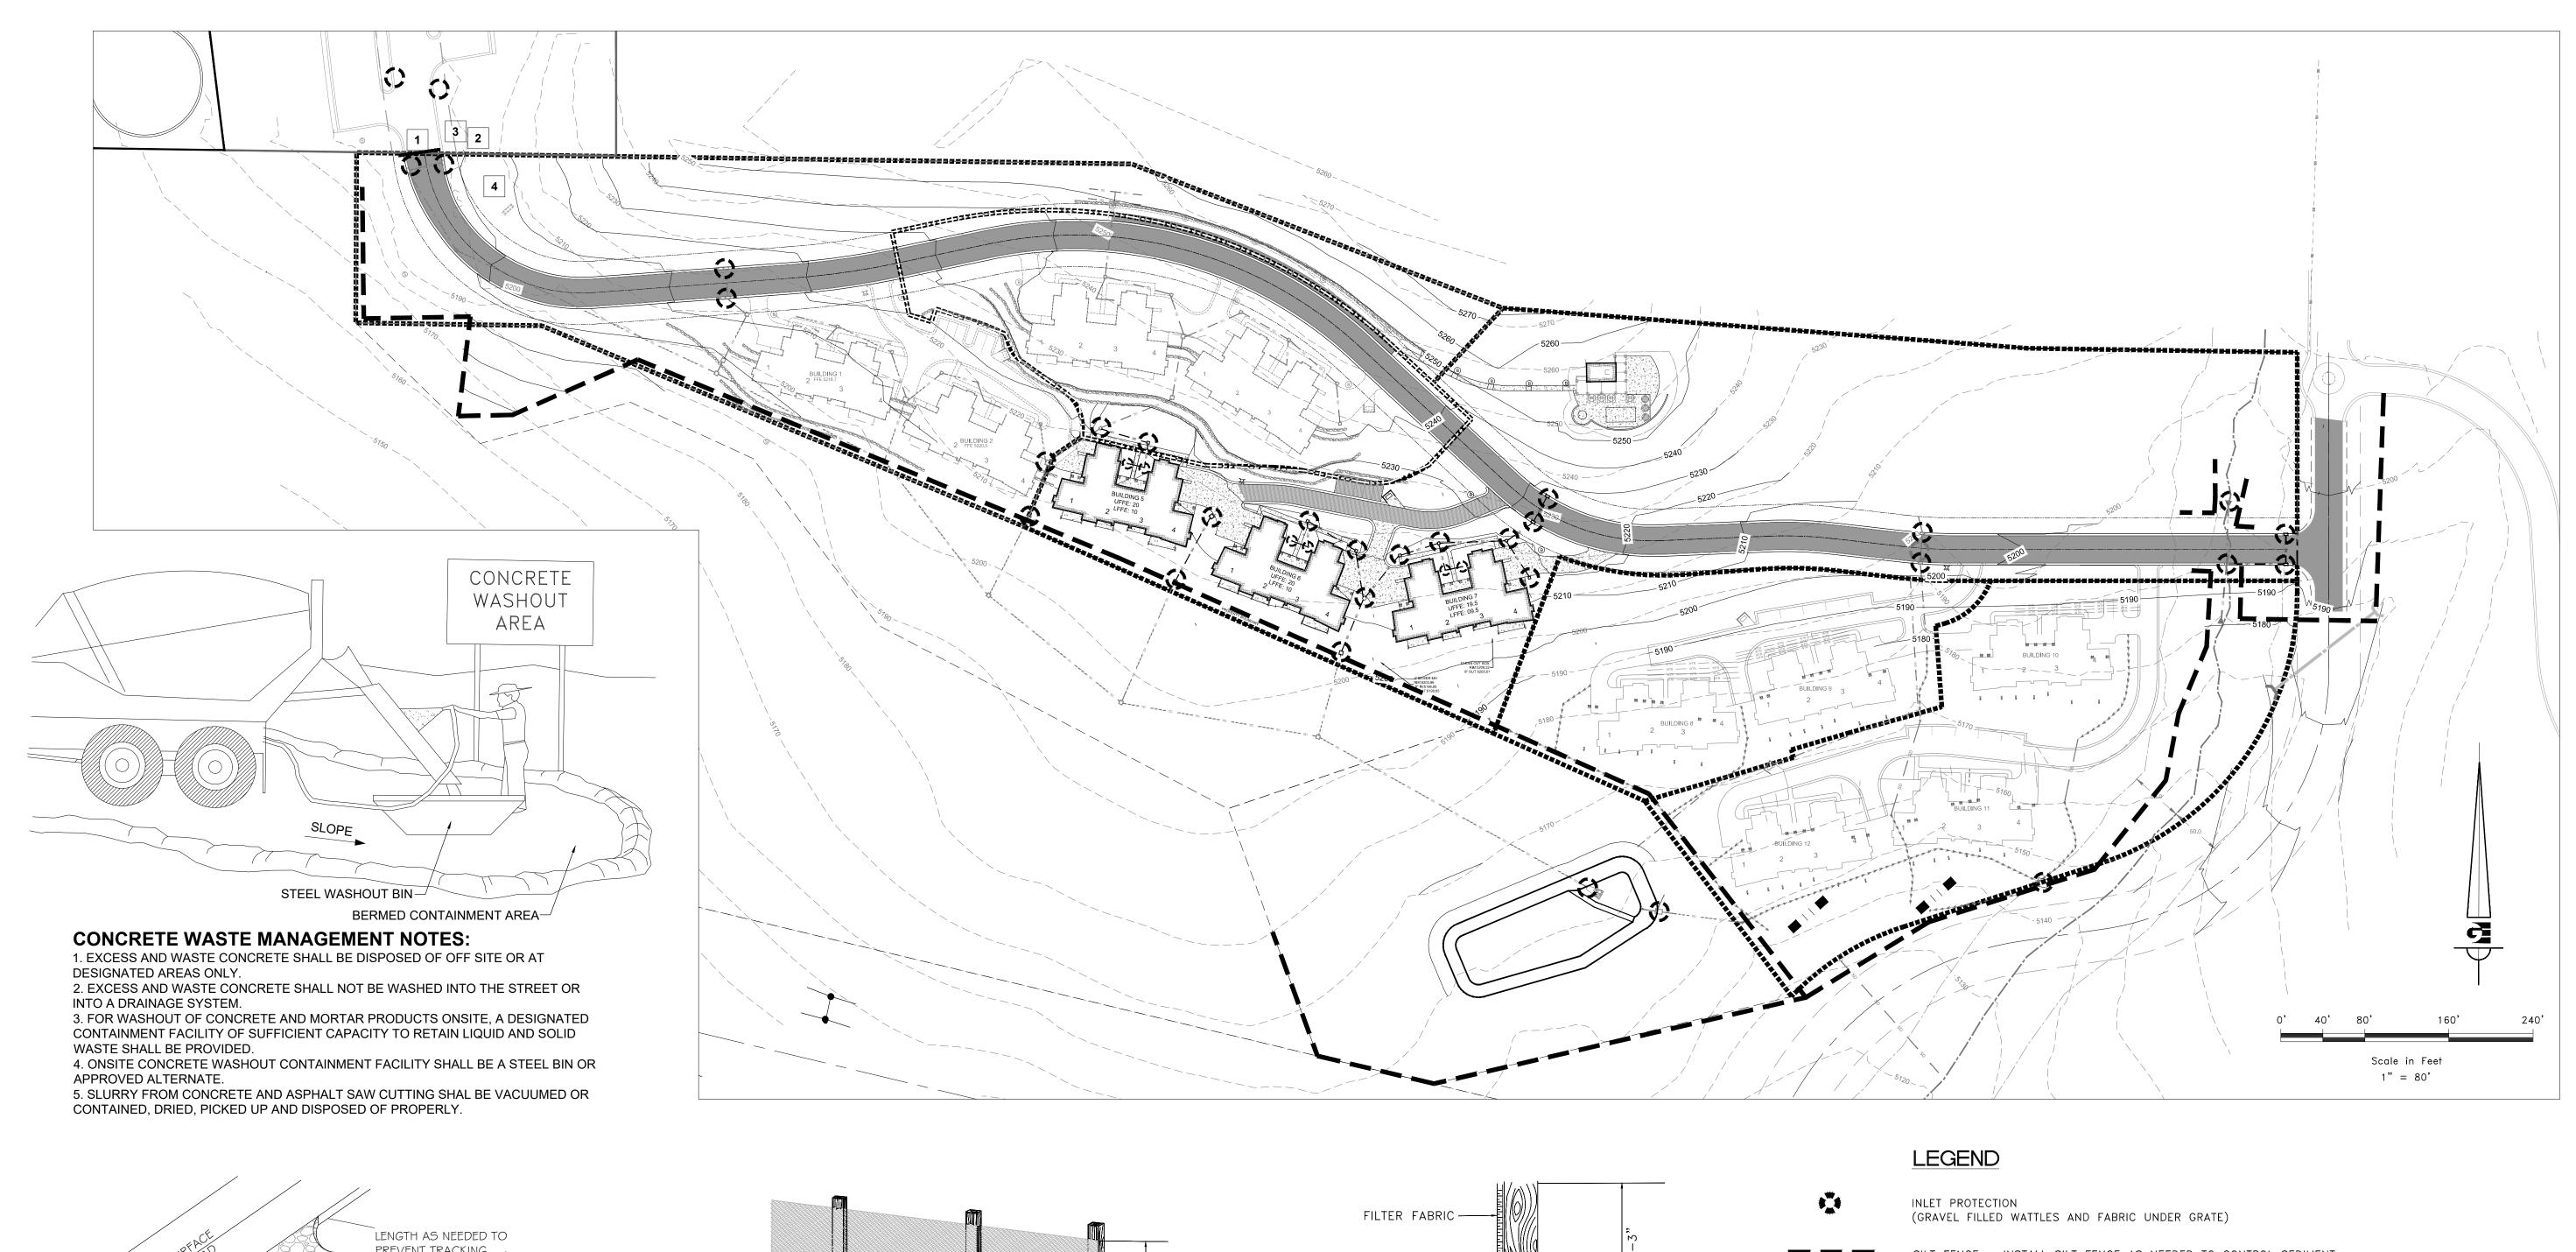

PREVENT TRACKING A SERIES OF STEEL PLATES (3 OR MORE) WITH RUMBLE


ENTRANCE STABILIZATION NOTES:


STRIPS OR MIN. 3" COARSE AGGREGATE.

- 1. SEDIMENTS AND OTHER MATERIALS SHALL NOT BE TRACKED FROM THE SITE BY VEHICLE TRAFFIC. THE CONSTRUCTION ENTRANCE ROADWAYS SHALL BE STABILIZED SO AS TO PREVENT SEDIMENTS FROM BEING DEPOSITED INTO THE STORM DRAIN SYSTEMS. DEPOSITIONS MUST BE SWEPT UP IMMEDIATELY AND MAY NOT BE WASHED DOWN BY RAIN OR OTHER MEANS INTO THE STORM DRAIN SYSTEM.
- 2. STABILIZED CONSTRUCTION ENTRANCE SHALL BE: a. LOCATED AT ANY POINT WHERE TRAFFIC WILL BE ENTERING OR LEAVING A
- CONSTRUCTION SITE TO OR FROM A PUBLIC RIGHT-OF-WAY, STREET, ALLEY AND SIDEWALK OR PARKING AREA. b. A SERIES OF STEEL PLATES WITH "RUMBLE STRIPS", AND/OR MIN. 3" COARSE
- AGGREGATE WITH LENGTH, WIDTH AND THICKNESS AS NEEDED TO ADEQUATELY PREVENT ANY TRACKING ONTO PAVED SURFACES.
- 3. ADDING A WASH RACK WITH A SEDIMENT TRAP LARGE ENOUGH TO COLLECT ALL WASH WATER CAN GREATLY IMPROVE EFFICIENCY.
- 4. ALL VEHICLES ACCESSING THE CONSTRUCTION SITE SHALL UTILIZE THE STABILIZED CONSTRUCTION ENTRANCE SITES.

STREET MAINTENANCE NOTES:

- 1. REMOVE ALL SEDIMENT DEPOSITED ON PAVED ROADWAYS IMMEDIATELY.
- 2. SWEEP PAVED AREAS THAT RECEIVE CONSTRUCTION TRAFFIC WHENEVER SEDIMENT BECOMES VISIBLE.
- 3. PAVEMENT WASHING WITH WATER IS PROHIBITED IF IT RESULTS IN A DISCHARGE TO THE STORM DRAIN SYSTEM.

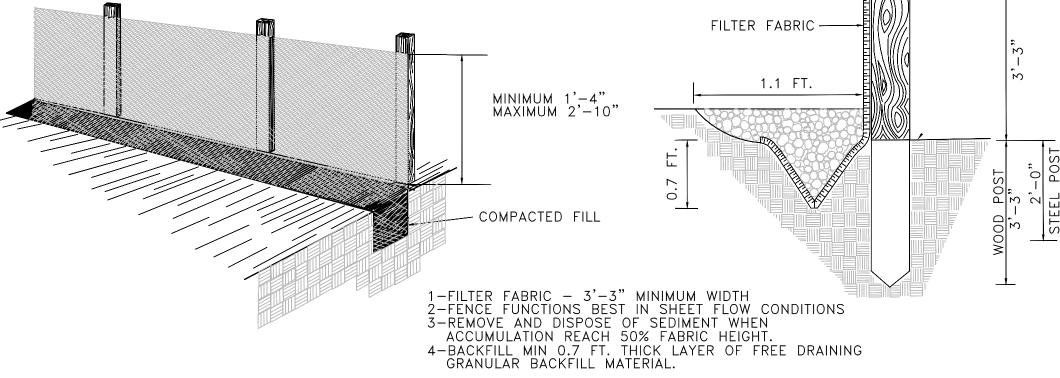

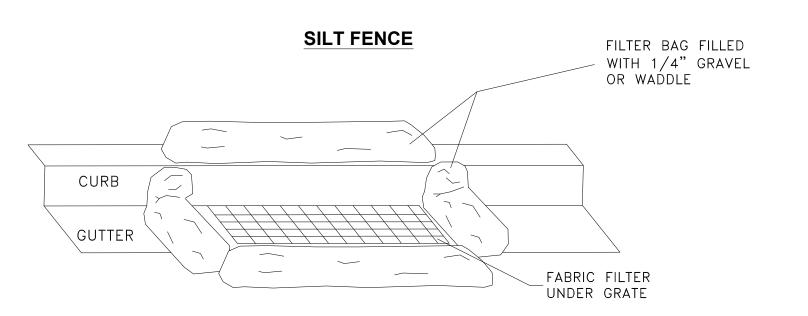

INLET PROTECTION

SILT FENCE - INSTALL SILT FENCE AS NEEDED TO CONTROL SEDIMENT

FIBER ROLL / GRAVEL FILLED WATTLES (INSTALLED IN DRAINAGE SWALE)

SWPPP KEY NOTES

- 1 STABILIZED CONSTRUCTION ENTRANCE
- 2 WASH-OUT AREA
- 3 POSTED SWPPP LOCATION
- 4 STAGING AREA / CONSTRUCTION SUPPORT

SWPPP NOTES

- 1. CONTRACTOR SHALL OBTAIN NECESSARY PERMITS FROM THE COUNTY AND THE STATE AS REQUIRED.
- 2. ALL REQUIREMENTS OF THE GENERAL PERMIT FOR CONSTRUCTION ACTIVITIES SHALL BE MET.
- 3. ALL BMP'S SHALL BE IN PLACE PRIOR TO BEGINNING OF CONSTRUCTION OR ACTIVITIES THAT MAY REQUIRE BMP'S
- 4. AN UPDATED COPY OF THE SWPPP SHALL BE MAINTAINED AT THE SITE.

5. SILT FENCE, INLET PROTECTION, AND STREET CLEANING SHALL BE COMPLETED AS NEEDED TO PREVENT EROSION AND SEDIMENT FROM ENTERING DRAINAGES.

DEVELOPER:

LEWIS HOMES ERIC HOUSEHOLDER 801-389-0040