
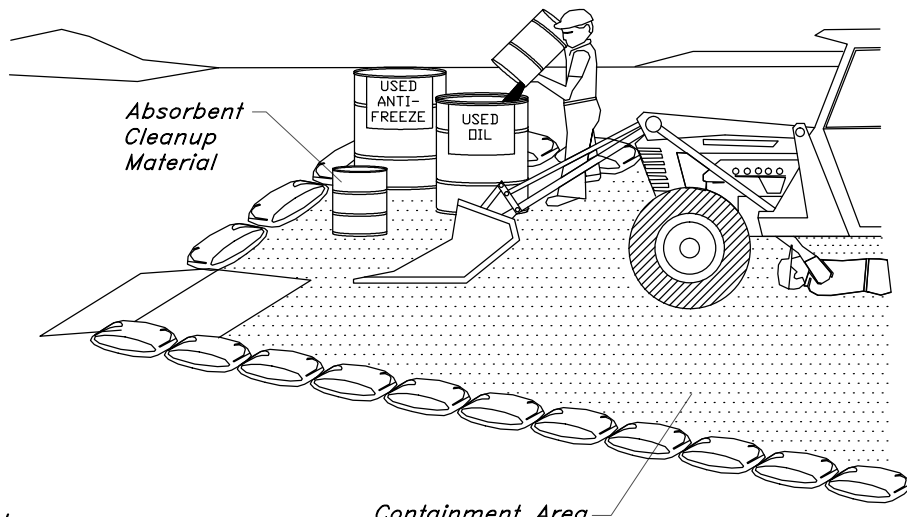


Note:
Inspect the silt snakes on a weekly basis. If silt snake is showing signs of failure remove and replace those sections of the silt snake.

Silt Snake Detail
Not to Scale

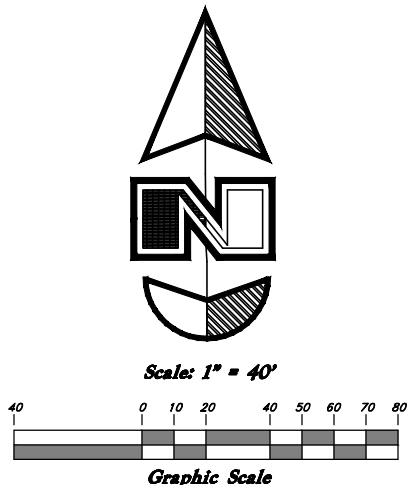

Notes:

1. Leaking vehicles and equipment shall not be allowed on-site. Equipment and vehicles shall be inspected frequently for leaks and shall be repaired immediately. Clean up spills and leaks promptly with absorbent materials; do not flush with water.
2. Vehicles and equipment shall be maintained, and repaired on-site only in designated areas. Prevent run-on and run-off from designated areas.
3. Containment devices shall be provided and areas shall be covered if necessary.
4. Designate on-site vehicle and equipment maintenance areas, away from storm drain inlets and watercourses.
5. Always use secondary containment, such as a drain pan or drop cloth, to catch spills and leaks when removing or changing fluids.
6. Legally dispose of used oils, fluids, and lubricants.
7. Provide spill containment dikes or secondary containment around stored oil, fuel, and chemical drums.
8. Maintain an adequate supply of absorbent spill cleanup materials in designated area.

Equipment Repair/Maintenance

Erosion Control Notes :

1. Sandbags will be placed at discharge locations to contain and divert storm water through straw bales.
2. An earthen berm 6" high will be constructed to contain the storm water and divert it to discharge areas.
3. Storm water will be discharged into an existing drainage system to the Southwest of property. Existing Lines shall be inspected prior to Certificate of Occupancy and cleaned if necessary.
4. The Storm Water Prevention Plan shall conform to all Utah Division of Environmental Protection Regulations.


Legend

(Note: All items may not appear on drawing)



- San. Sewer Manhole
- Water Manhole
- Storm Drain Manhole
- Electrical Manhole
- Catch Basins
- Exist. Fire Hydrant
- Exist. Water Valve
- Water Valve
- Sanitary Sewer
- Culinary Water
- Gas Line
- Irrigation Line
- Storm Drain
- Telephone Line
- Secondary Waterline
- Power Line
- Fire Line
- Land Drain
- Power pole w/guy
- Light Pole
- Fence
- Flowline of ditch
- Overhead Power line
- Corrugated Metal Pipe
- Concrete Pipe
- RCP
- DI
- PVC
- TA
- EA
- CL
- FL
- FF
- TC
- TW
- TWN
- NG
- 90
- 95.33TA
- 95.224
- R
- Direction of Flow
- Existing Asphalt
- New Asphalt
- Heavy Duty Asphalt
- Concrete
- Open Face Curb & Gutter

CAUTION: NOTICE TO CONTRACTOR


The contractor is specifically cautioned that the location and/or elevation of existing utilities as shown on these plans is based on records of the various utility companies and, where possible, measurements taken in the field. The information is not to be relied on as being exact or complete. The contractor must call the appropriate utility company at least 48 hours before any excavation to request exact field location of utilities. It shall be the responsibility of the contractor to relocate all existing utilities which conflict with the proposed improvements shown on the plans.

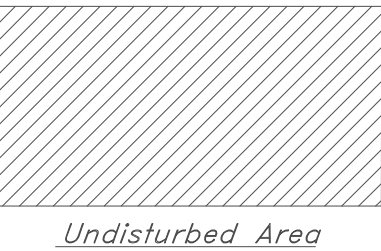

Total Area = 7.785 Acres
Disturbed Area = 1.982 Acres
Undisturbed Area = 5.803 Acres

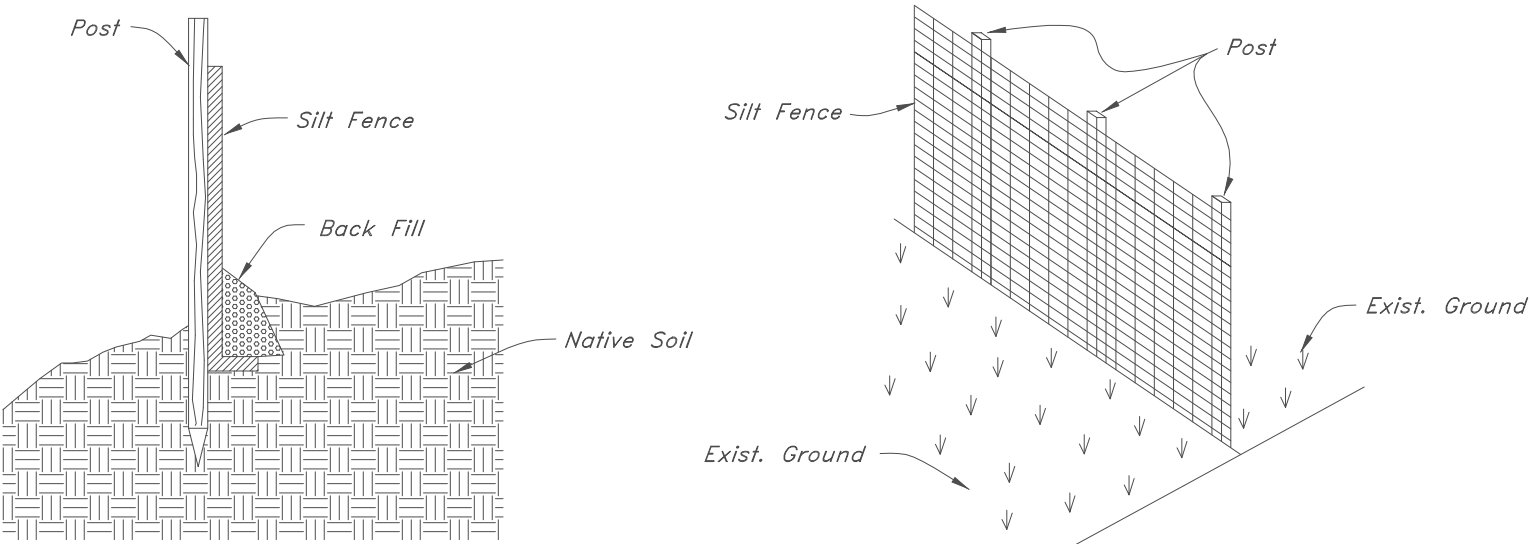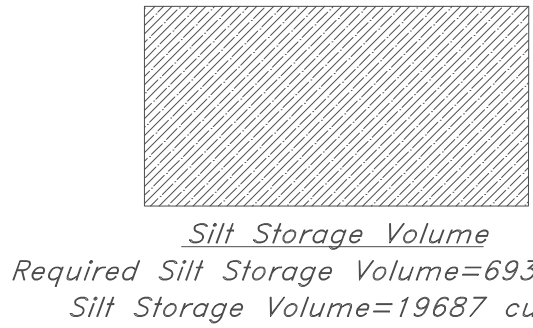


Silt Fence Section

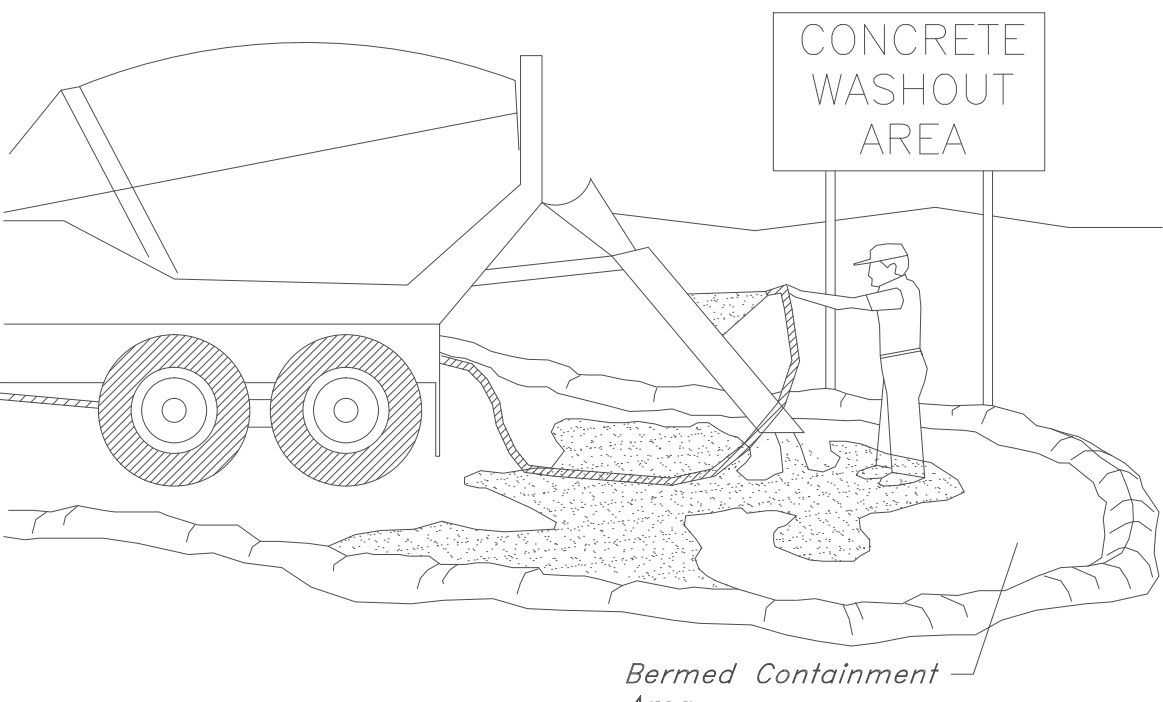

Notes:

1. Excess and waste concrete shall not be washed into the street or into a drainage system.
2. For washout of concrete and mortar products, a designated containment facility of sufficient capacity to retain liquid and solid waste shall be provided on site.
3. Slurry from concrete and asphalt saw cutting shall be vacuumed or contained, dried, picked up and disposed of properly.

Concrete Waste Management

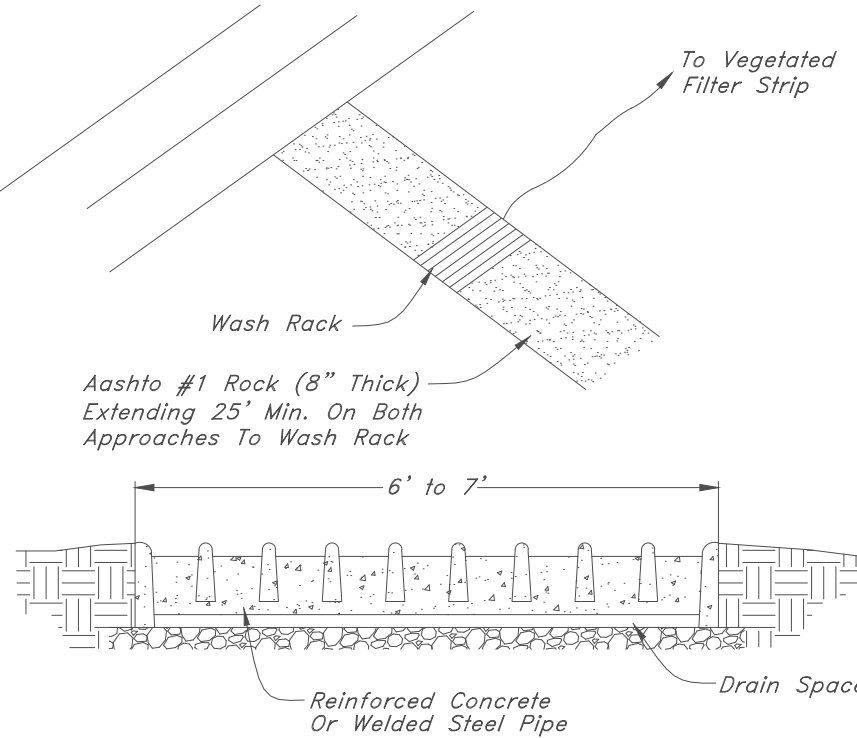

Maintenance: Rock construction entrance thickness shall be constantly maintained to the specified dimensions by adding rock. A stockpile of rock material shall be maintained on site for this purpose. Drain space under wash rack shall be kept open at all times. Damage to the wash rack shall be repaired prior to further use of the rack. At the end of each construction day, all sediment deposited on paved roadways shall be removed and returned to the construction site.

Storm Water Pollution Prevention Plan



GREAT BASIN ENGINEERING NORTH
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Ogden, Utah 84403
P.O. Box 150048, Ogden, Utah 84415
Ogden (801)394-4315 Salt Lake City (801)521-0222 Fax (801)392-7544

SCALE : **1" = 40'**
DRAWN : **MRK**
96N120 PH 5

DATE : **24 Jun, 2009**
REVISIONS :

The Chalets at Ski Lake Phase 5
A part of the Southwest 1/4 of Section 13, a part of the Northeast 1/4 of Section 23, and a part of the Northwest 1/4 of Section 24, T6N, R1E, SLBKM, U.S. Survey

DRWG. NO.

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of 5