GENERAL NOTES:

THE CONTRACTOR TO USE BEST MANAGEMENT PRACTICES FOR PROVIDING EROSION CONTROL FOR CONSTRUCTION OF THIS PROJECT. ALL MATERIAL AND WORKMANSHIP SHALL CONFORM TO WEBER COUNTY ORDINANCES AND ALL WORK SHALL BE SUBJECT TO INSPECTION BY WEBER COUNTY. ALSO, INSPECTORS WILL HAVE THE RIGHT TO CHANGE THE FACILITIES AS NEEDED.

DUST MUST BE KEPT TO A MINIMUM. CONTRACTOR SHALL KEEP THE SITE WATERED TO CONTROL DUST. CONTACT POWDER MOUNTAIN WATER & SEWER IMPROVEMENT DISTRICT TO LOCATE A NEARBY HYDRANT FOR USE AND TO INSTALL TEMPORARY METER.


THE CONTRACTOR SHALL MODIFY EROSION CONTROL MEASURES TO ACCOMMODATE PROJECT PLANNING.


ALL ACCESS TO PROPERTY WILL BE FROM PUBLIC RIGHT-OF-WAYS.


THE CONTRACTOR IS REQUIRED BY STATE AND FEDERAL REGULATIONS TO PREPARE A STORM WATER POLLUTION PREVENTION PLAN AND FILE A "NOTICE OF INTENT" WITH THE UTAH DEPARTMENT OF ENVIRONMENTAL QUALITY DIVISION OF WATER QUALITY.


ENSURE ALL GRADING SLOPES AWAY FROM STRUCTURE AT 5% FOR A MINIMUM OF 10' PER IRC R401.3

<u>Utilities:</u> Ensure minimum buried depth per building code for all buried utilities. IMPROVEMENTS, INCLUDING LANDSCAPING, SHALL NOT INTERFERE WITH THE DRAINAGE CULVERT, RIP RAP, AND DRAINAGE PATTERN ASSOCIATED WITH THE DRAINAGE EASEMENT.

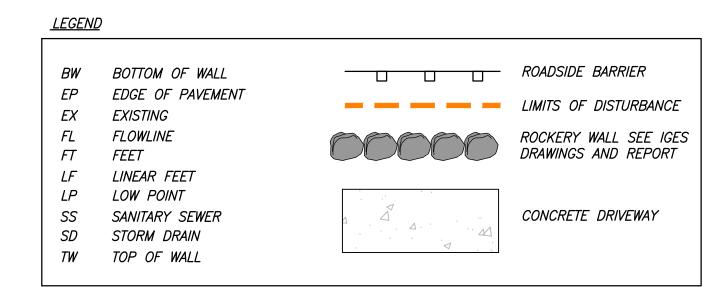

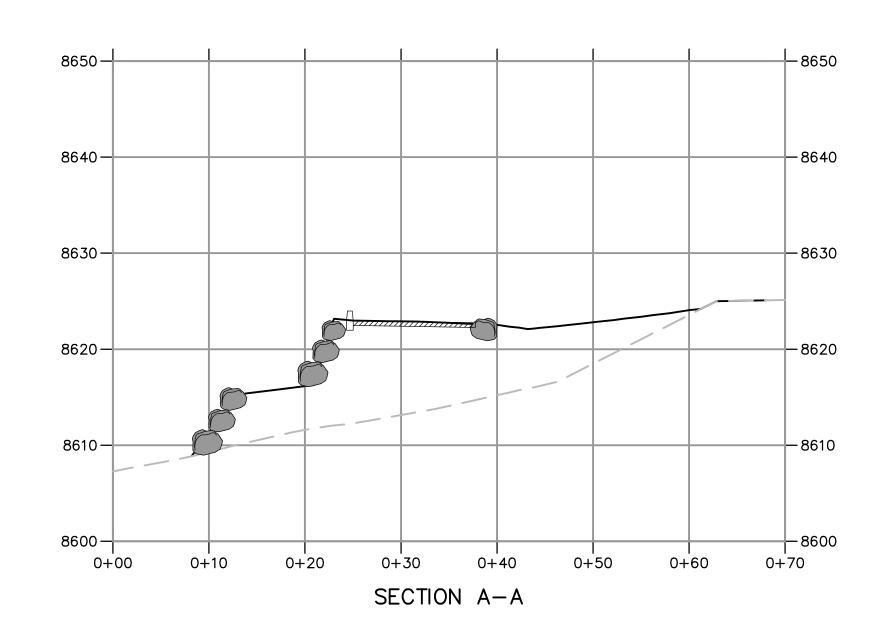

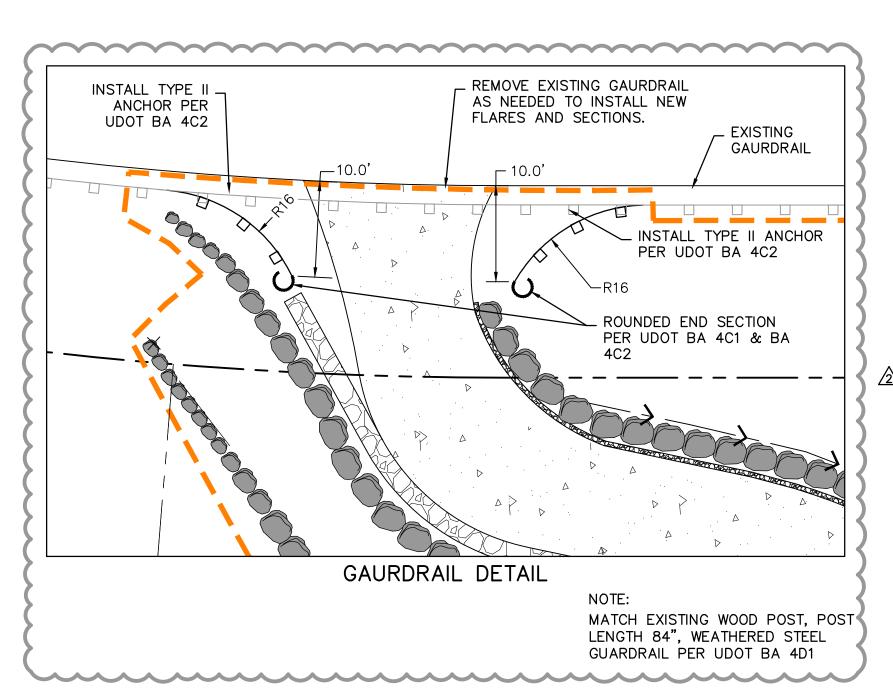

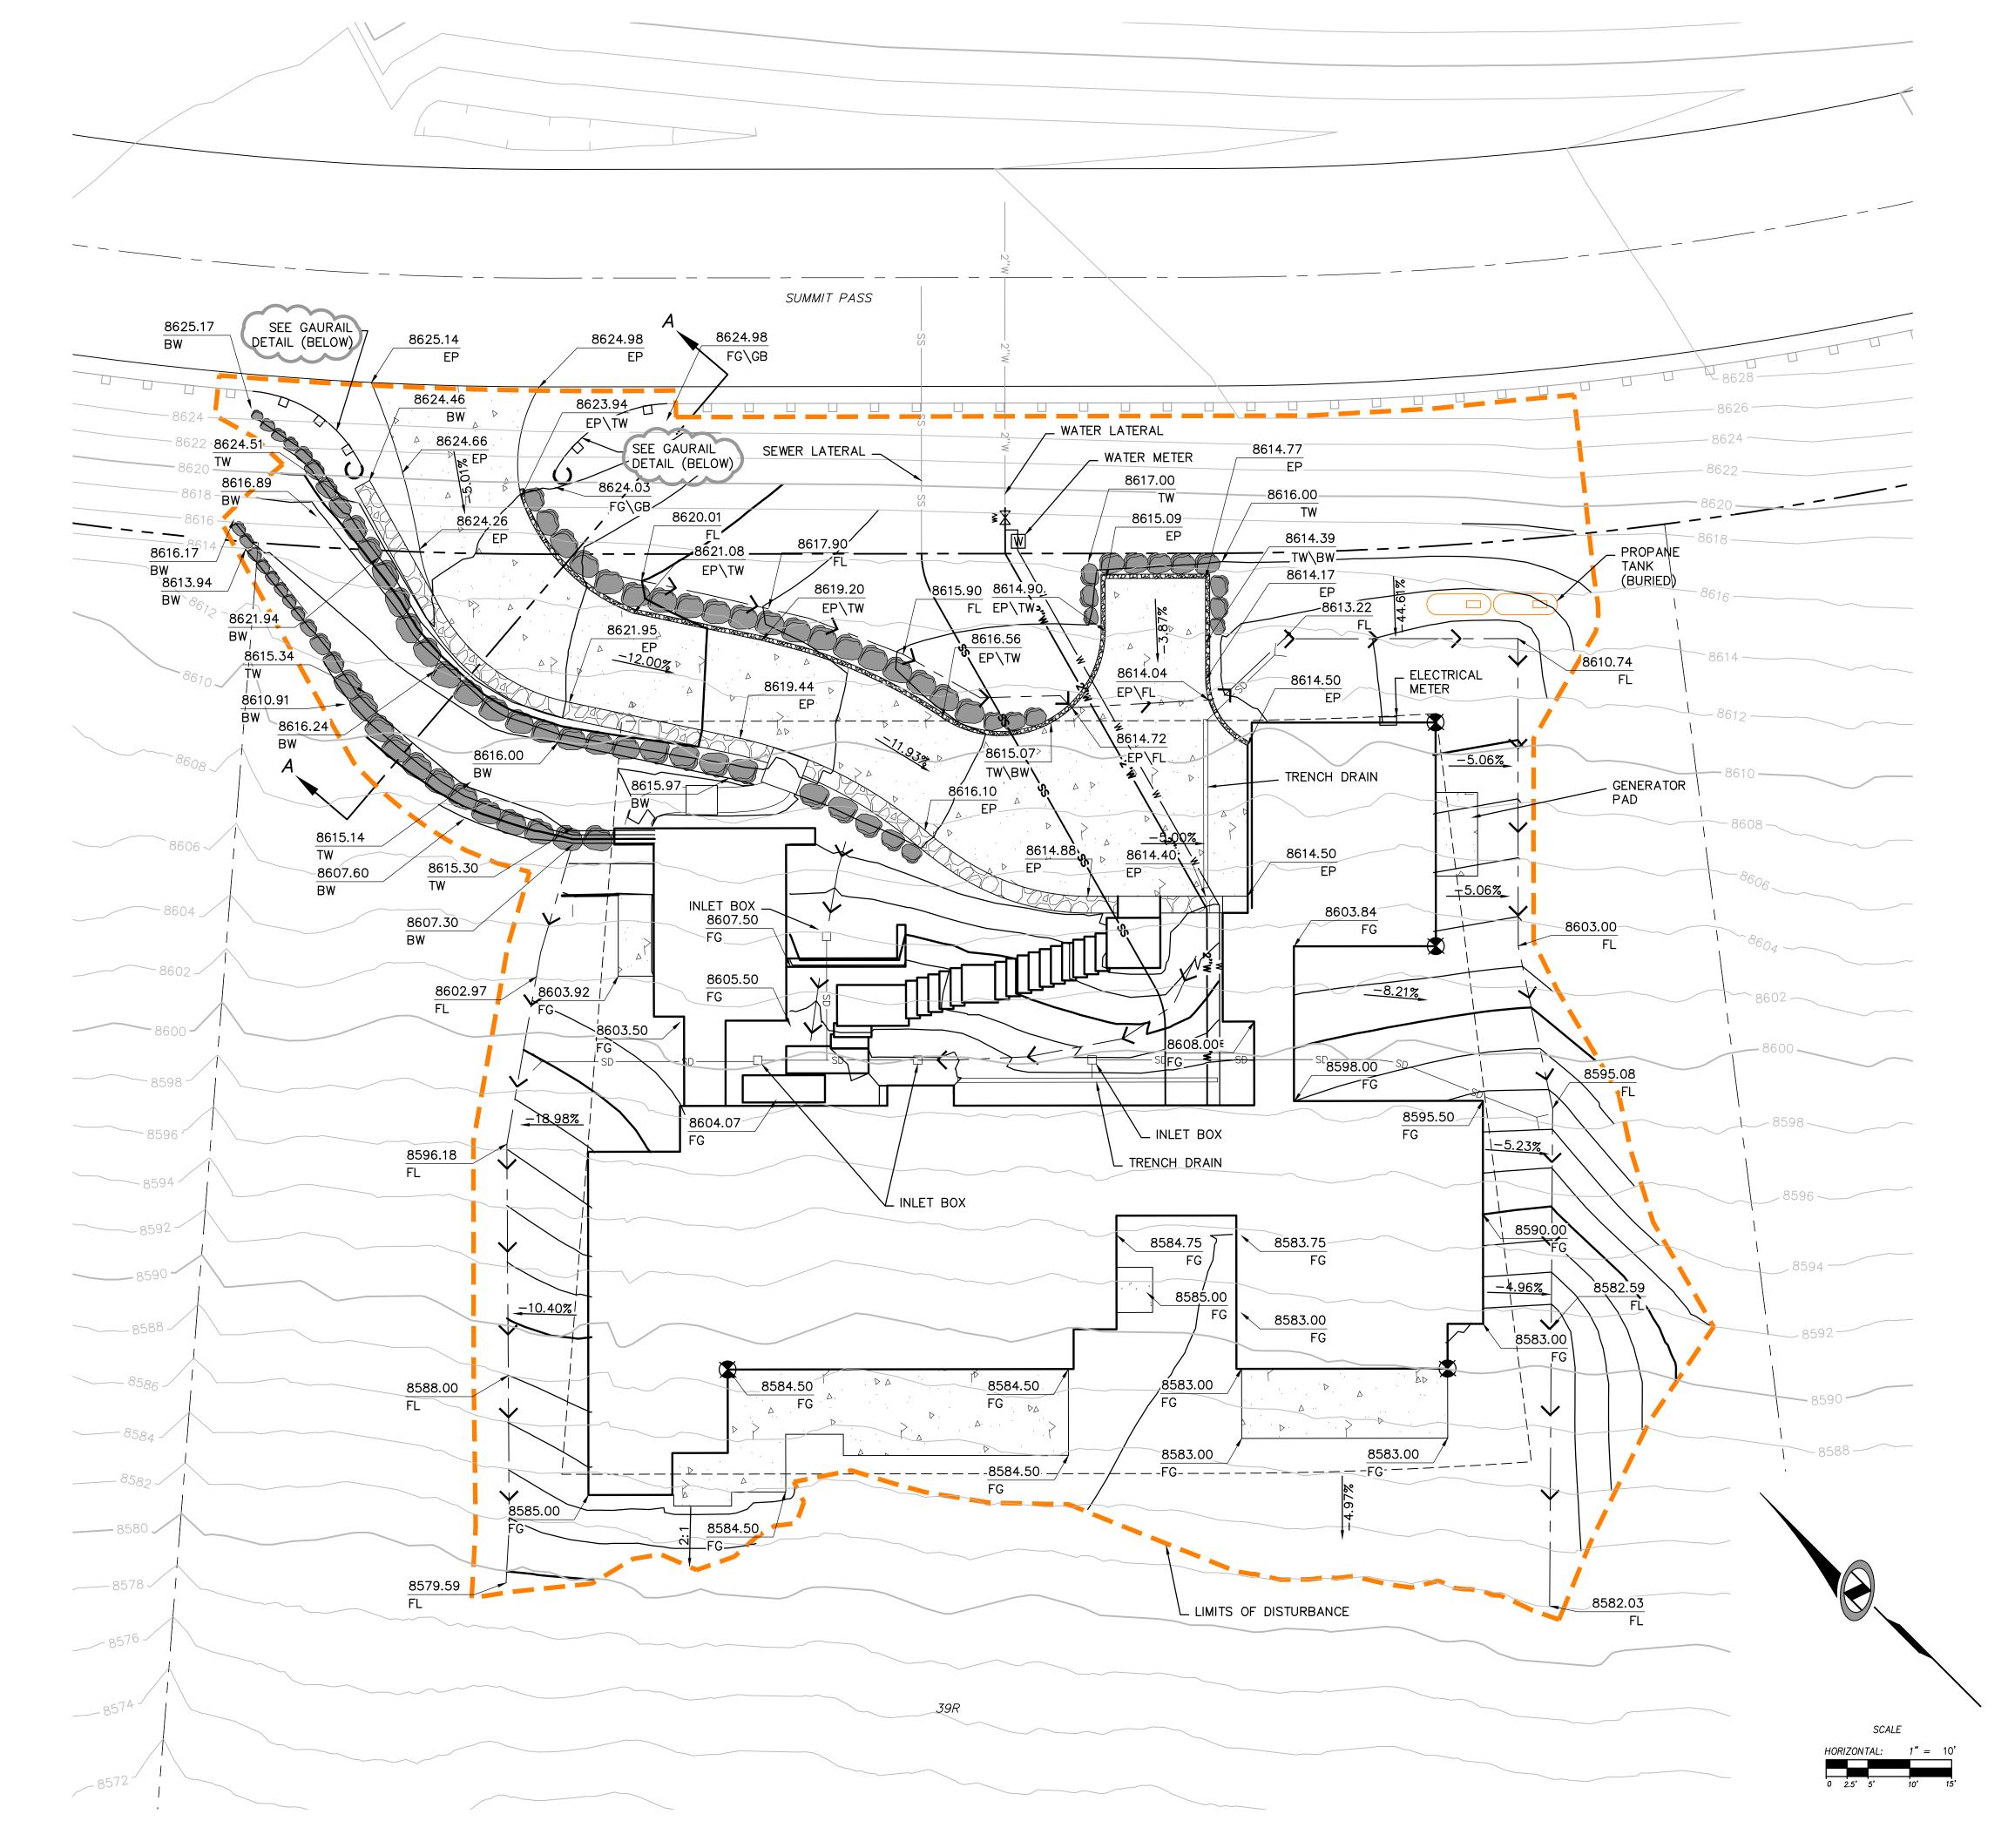

EROSION CONTROL GENERAL NOTES:

THE CONTRACTOR TO USE BEST MANAGEMENT PRACTICES FOR PROVIDING EROSION CONTROL FOR CONSTRUCTION OF THIS PROJECT. ALL MATERIAL AND WORKMANSHIP SHALL CONFORM TO WEBER COUNTY ORDINANCES AND ALL WORK SHALL BE SUBJECT TO INSPECTION BY THE COUNTY. ALSO, INSPECTORS WILL HAVE THE RIGHT TO CHANGE THE FACILITIES AS NEEDED.

CONTRACTOR SHALL KEEP THE SITE WATERED TO CONTROL DUST. CONTRACTOR TO LOCATE A NEARBY HYDRANT FOR USE AND TO INSTALL TEMPORARY METER. CONSTRUCTION WATER COST TO BE INCLUDED IN BID.

WHEN GRADING OPERATIONS ARE COMPLETED AND THE DISTURBED GROUND IS LEFT "OPEN" FOR 14 DAYS OR MORE, THE AREA SHALL BE FURROWED PARALLEL TO THE CONTOURS.

THE CONTRACTOR SHALL MODIFY EROSION CONTROL MEASURES TO ACCOMMODATE PROJECT PLANNING.

ALL ACCESS TO PROPERTY WILL BE FROM PUBLIC RIGHT-OF-WAYS.

THE CONTRACTOR IS REQUIRED BY STATE AND FEDERAL REGULATIONS TO PREPARE A STORM WATER POLLUTION PREVENTION PLAN AND FILE A "NOTICE OF INTENT" WITH THE UTAH DIVISION OF WATER QUALITY.

MAINTENANCE:

ALL BEST MANAGEMENT PRACTICES (BMP'S) SHOWN ON THIS PLAN MUST BE MAINTAINED AT ALL TIMES UNTIL VEGETATION IS RE-ESTABLISHED.

THE CONTRACTOR'S RESPONSIBILITY SHALL INCLUDE MAKING BI-WEEKLY CHECKS ON ALL EROSION CONTROL MEASURES TO DETERMINE IF REPAIR OR SEDIMENT REMOVAL IS NECESSARY. CHECKS SHALL BE DOCUMENTED AND COPIES OF THE INSPECTIONS KEPT ON SITE.

SEDIMENT DEPOSITS SHOULD BE REMOVED AFTER EACH RAINFALL. THEY MUST BE REMOVED WHEN THE LEVEL OF DEPOSITION REACHES APPROXIMATELY ONE-HALF THE HEIGHT OF BARRIER.


SEDIMENT TRACKED ONTO PAVED ROADS MUST BE CLEANED UP AS SOON AS PRACTICAL, BUT IN NO CASE LATER THAN THE END OF THE NORMAL WORK DAY. THE CLEAN UP WILL INCLUDE SWEEPING OF THE TRACKED MATERIAL, PICKING IT UP, AND DEPOSITING IT TO A CONTAINED AREA.

EXPOSED SLOPES:
ANY EXPOSED SLOPE THAT WILL REMAIN UNTOUCHED FOR LONGER THAN 14 DAYS MUST BE STABILIZED BY ONE OR MORE OF THE FOLLOWING METHODS:

- A) SPRAYING DISTURBED AREAS WITH A TACKIFIER VIA HYDROSEED B) TRACKING STRAW PERPENDICULAR TO SLOPES
- C) INSTALLING A LIGHT-WEIGHT, TEMPORARY EROSION CONTROL BLANKET

SCOPE OF WORK:

PROVIDE, INSTALL AND/OR CONSTRUCT THE FOLLOWING PER THE SPECIFICATIONS GIVEN OR REFERENCED, THE DETAILS NOTED, AND/OR AS SHOWN ON THE CONSTRUCTION DRAWINGS:

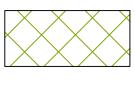

HATCHING INDICATES AREAS TO RECEIVE 4" TOPSOIL AND TO BE SEEDED FOR NATURAL VEGETATION. AREAS RECEIVING SEEDING FOR NATURAL REVEGETATION MUST BE COVERED WITH AN EROSION CONTROL BLANKET AFTER THE FINAL GRADING AND SEEDING ARE FINISHED. INSTALL NORTH AMERICAN GREEN SC-150 BLANKET OR APPROVED EQUAL. FOLLOW MANUFACTURER'S SPECIFICATIONS. INSTALL NORTH AMERICAN GREEN P300 EROSION CONTROL BLANKET ON ALL SLOPES GREATER THAN 1.5:1.



STABILIZED CONSTRUCTION ENTRANCE FOR SITE INGRESS/EGRESS. IF ALTERNATE ACCESS POINTS ARE APPROVED BY OWNER, ADDITIONAL STABILIZED CONSTRUCTION ENTRANCES WILL BE REQUIRED.



INSTALL INLET PROTECTION IN FORM OF CONCRETE BLOCKS / FILTER CLOTH / GRAVEL OR SILT SACK AT EXISTING AND PROPOSED CATCH BASINS AS SHOWN ON PLAN.

INSTALL SILT FENCE ALONG DOWN GRADIENT LIMITS OF

INSTALL ORANGE SAFETY FENCING AROUND OUTER LIMITS OF PROJECT PRIOR TO GRADING.

DISTURBANCE AS SHOWN ON PLAN.

★ SEED MIXTURE FOR REVEGITATION

40% MOUNTAIN BROME (BROMUS MARGINATUS)

25% SLENDER WHEATGRASS (ELYMUS TRACHYCAULUS SSP. TRACHYCAULUS)

5% SHEEP FESCUE (FESTUCA OVINA SPP. DURIUSCULA)


5% ALPINE BLUEGRASS (POA ALPINE) 25% THICKSPIKE WHEATGRASS (ELYMUS LANCEOLATUS SSP. LANCEOLATUS)


SEEDING RATE IS 40 POUNDS PER ACRE.

SUMMIT PASS TRENCH DRAIN INLET BOX -└_ INLET BOX TRENCH DRAIN ∠ INLET BOX LIMITS OF DISTURBANCE

HORIZONTAL: 1" = 10'
0 2.5' 5' 10' 15'

39 8365

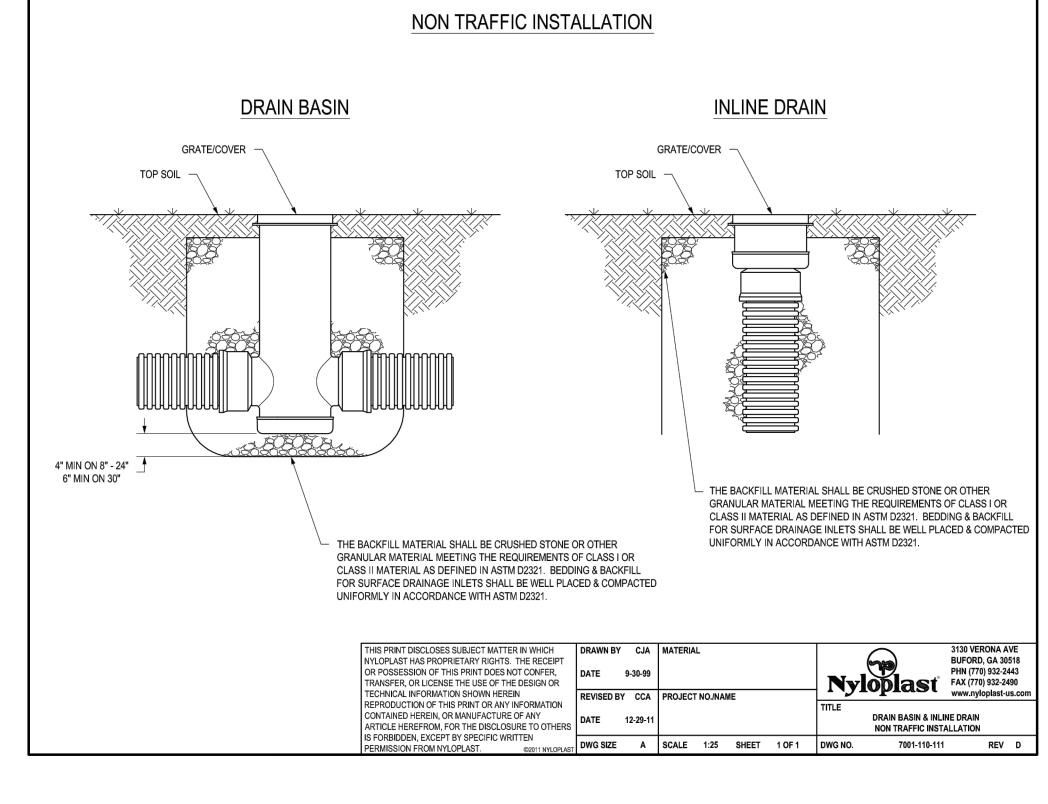

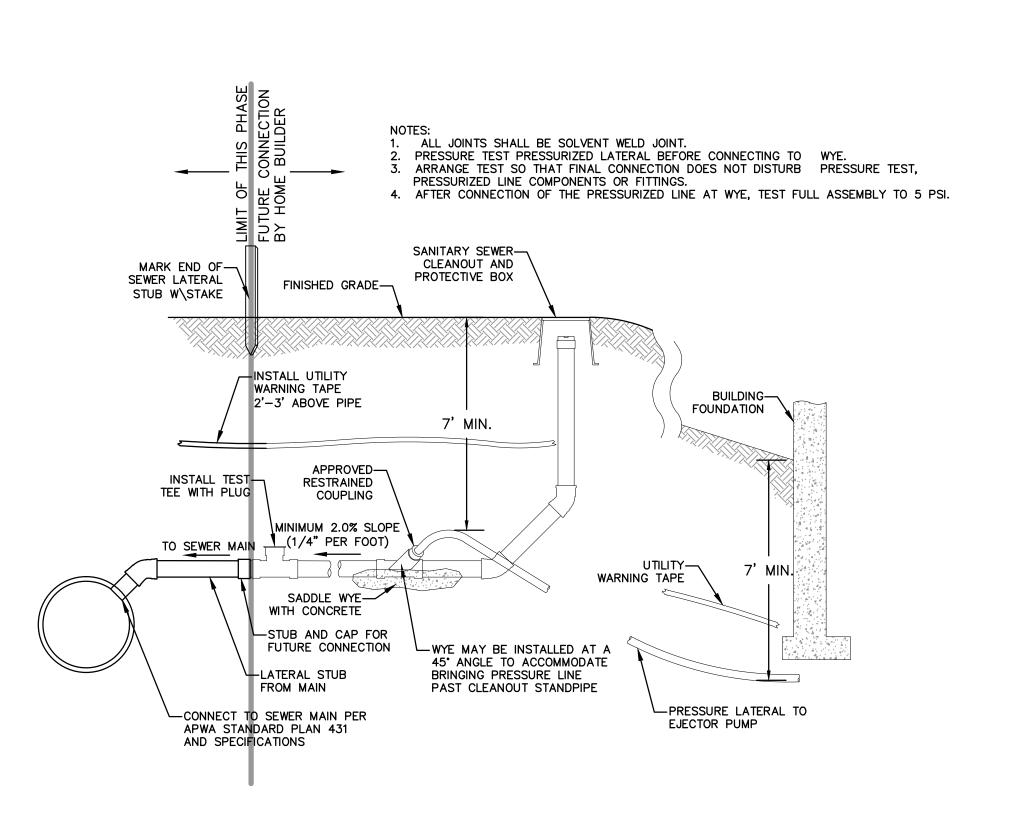

SEWER LATERAL CONNECTION



<u>SECTION</u>

- WATER METER

2" FIRE LINE

3/4" SERVICE -

WATER METER

METER BOX ~


EXISTING 2" VALVE


EXISTING 2" WATERLINE

EXISTING WATER VALVE BOX

✓ WATER VALVE BOX

2" WATERLINE

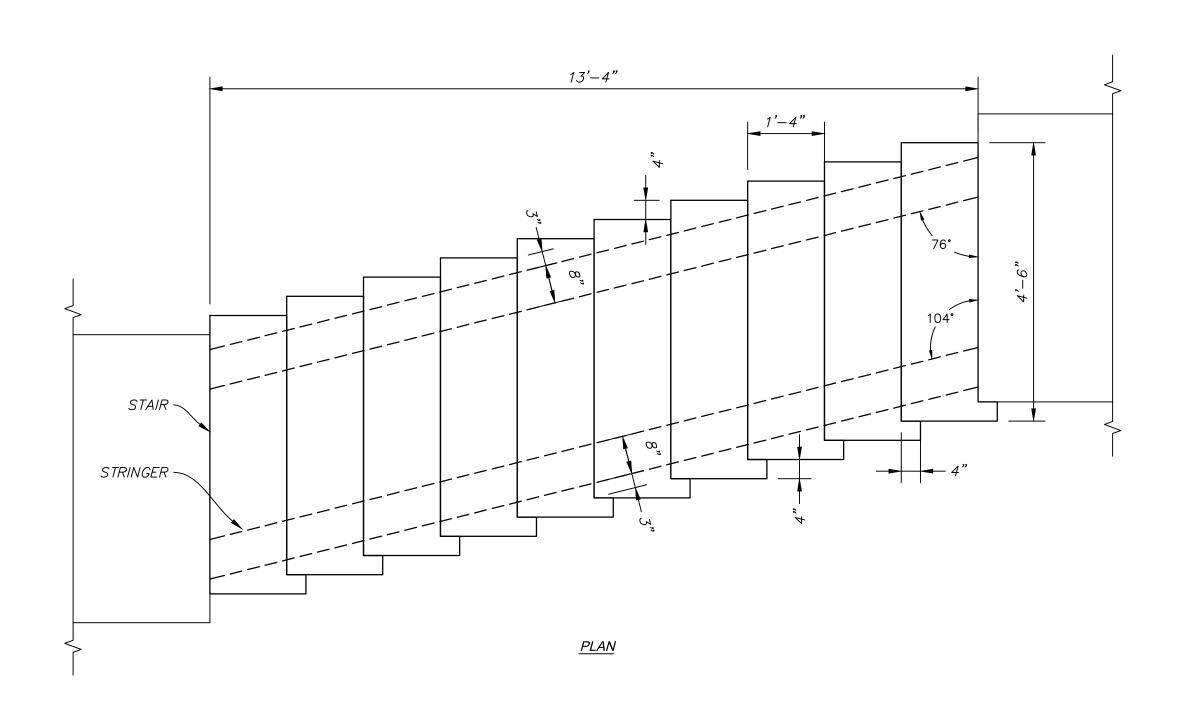


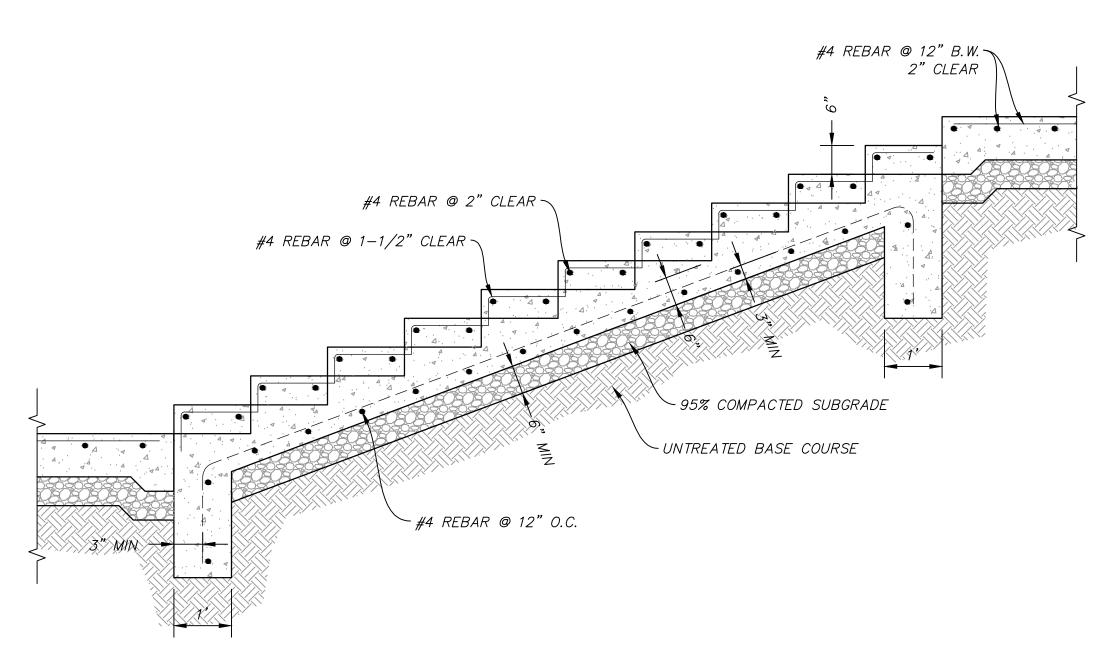


C TYPICAL STAIR AND REINFORCEMENT DETAIL

SCALE: 1" = N.T.S.

<u>PROFILE</u>

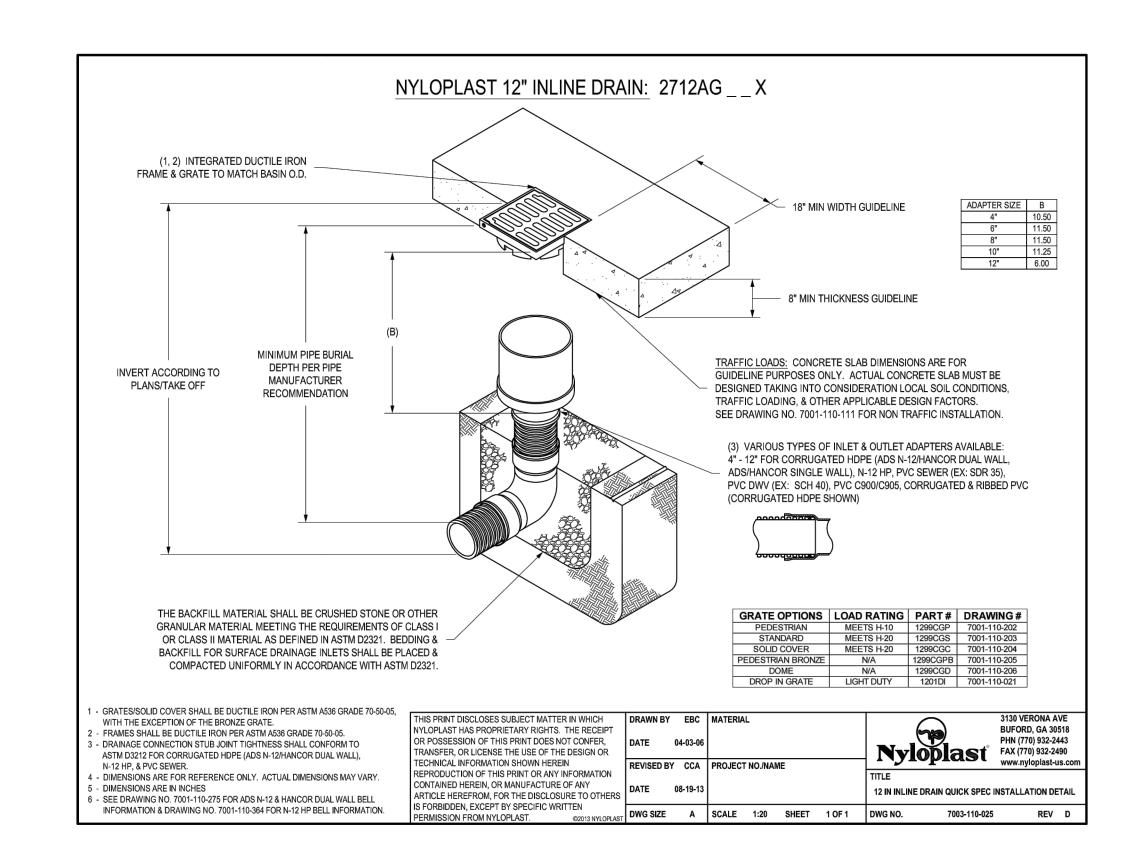





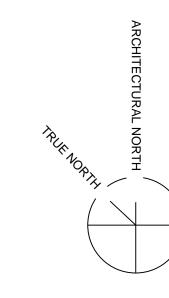



June 26, 2015

November 2, 2015 /1

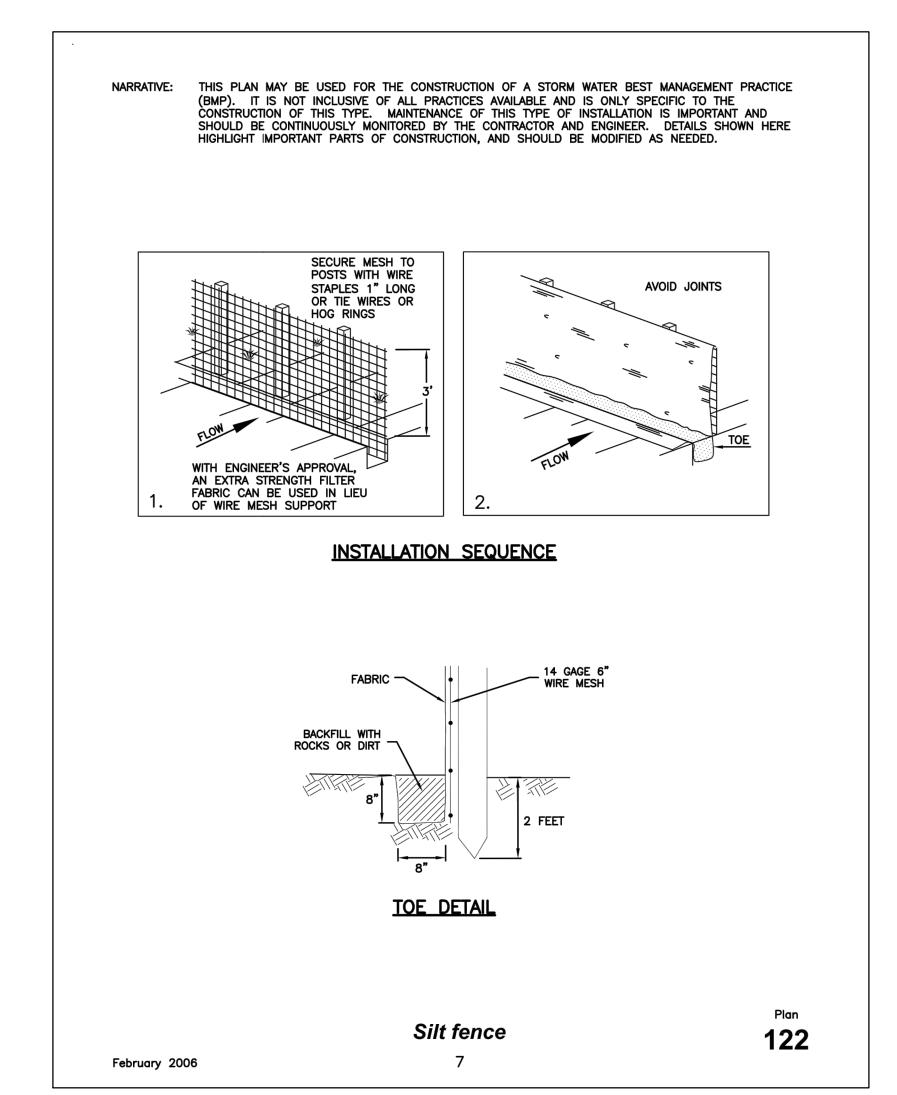

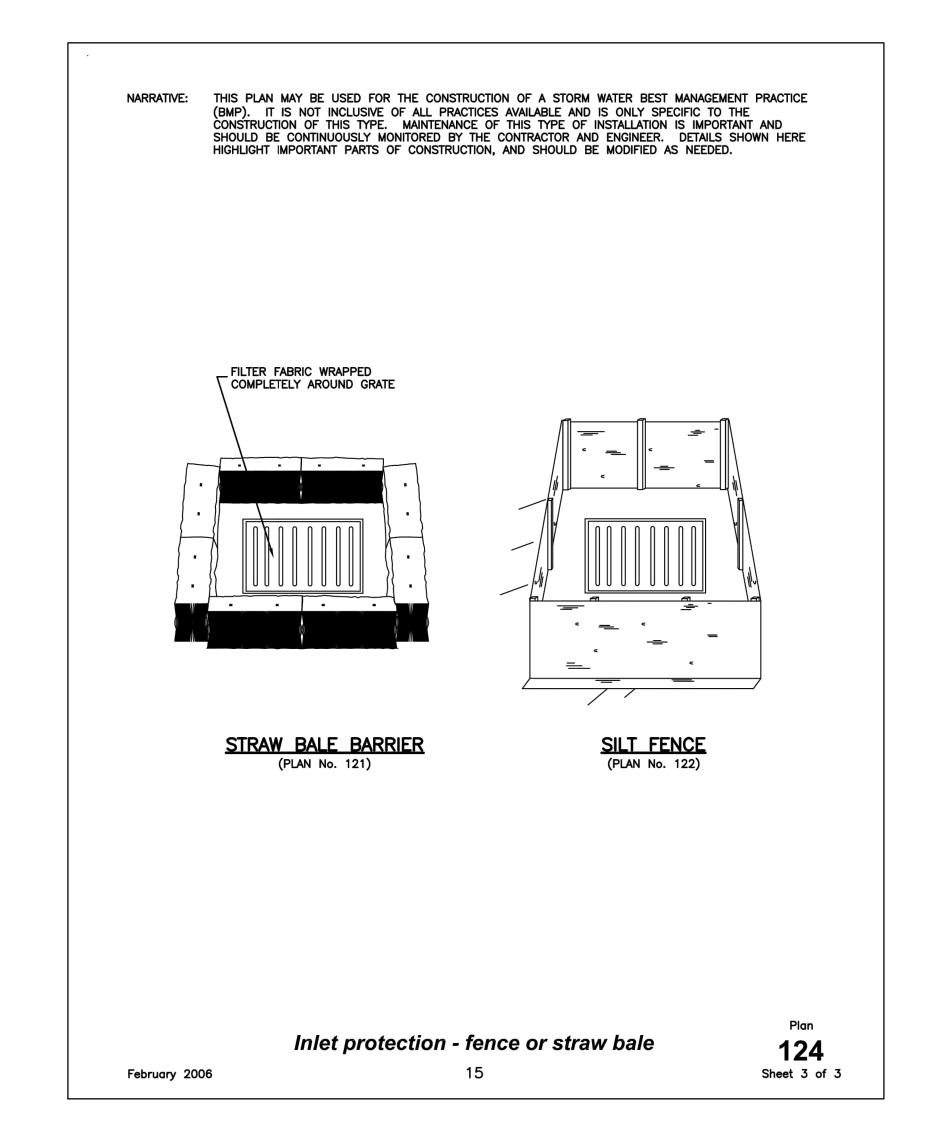

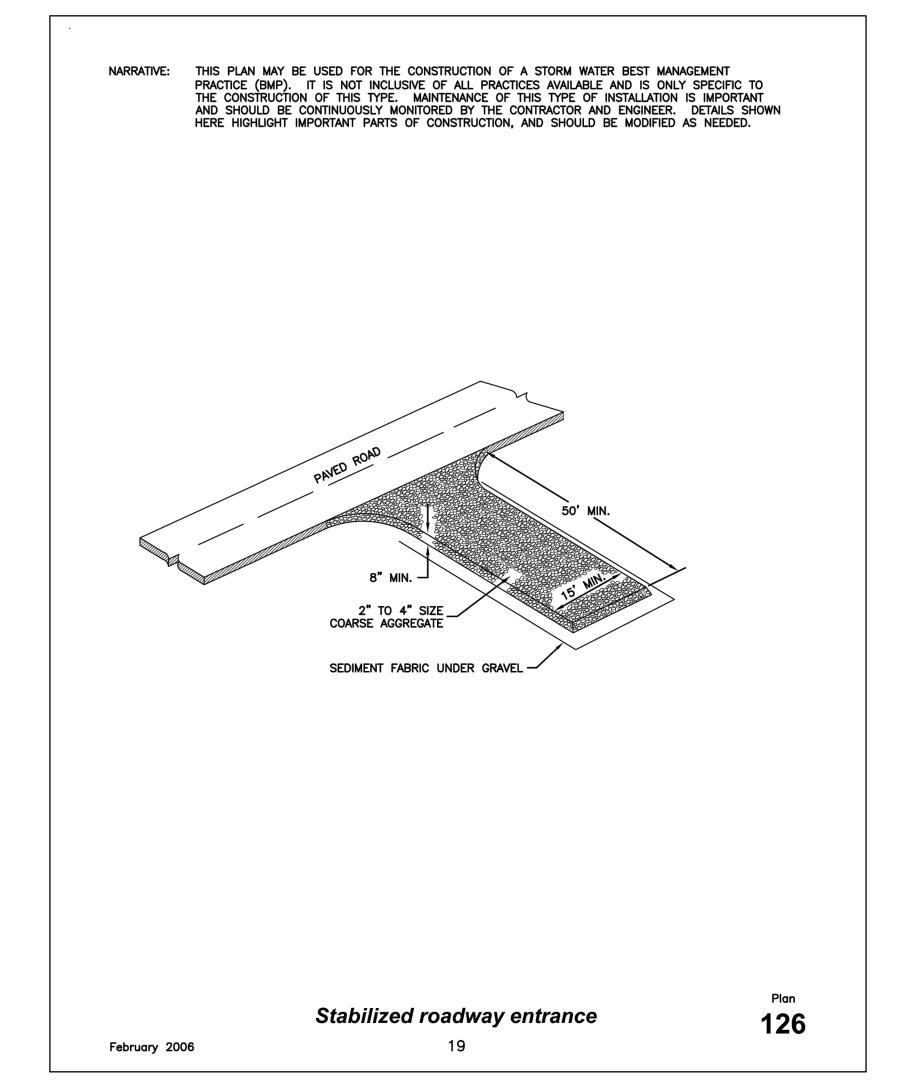

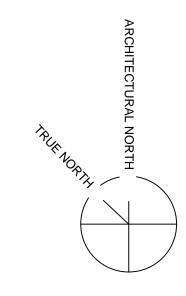

November 2, 2015 1










STD. DWG. NO.

BA 4C2


June 26, 2015 December 28, 2015/

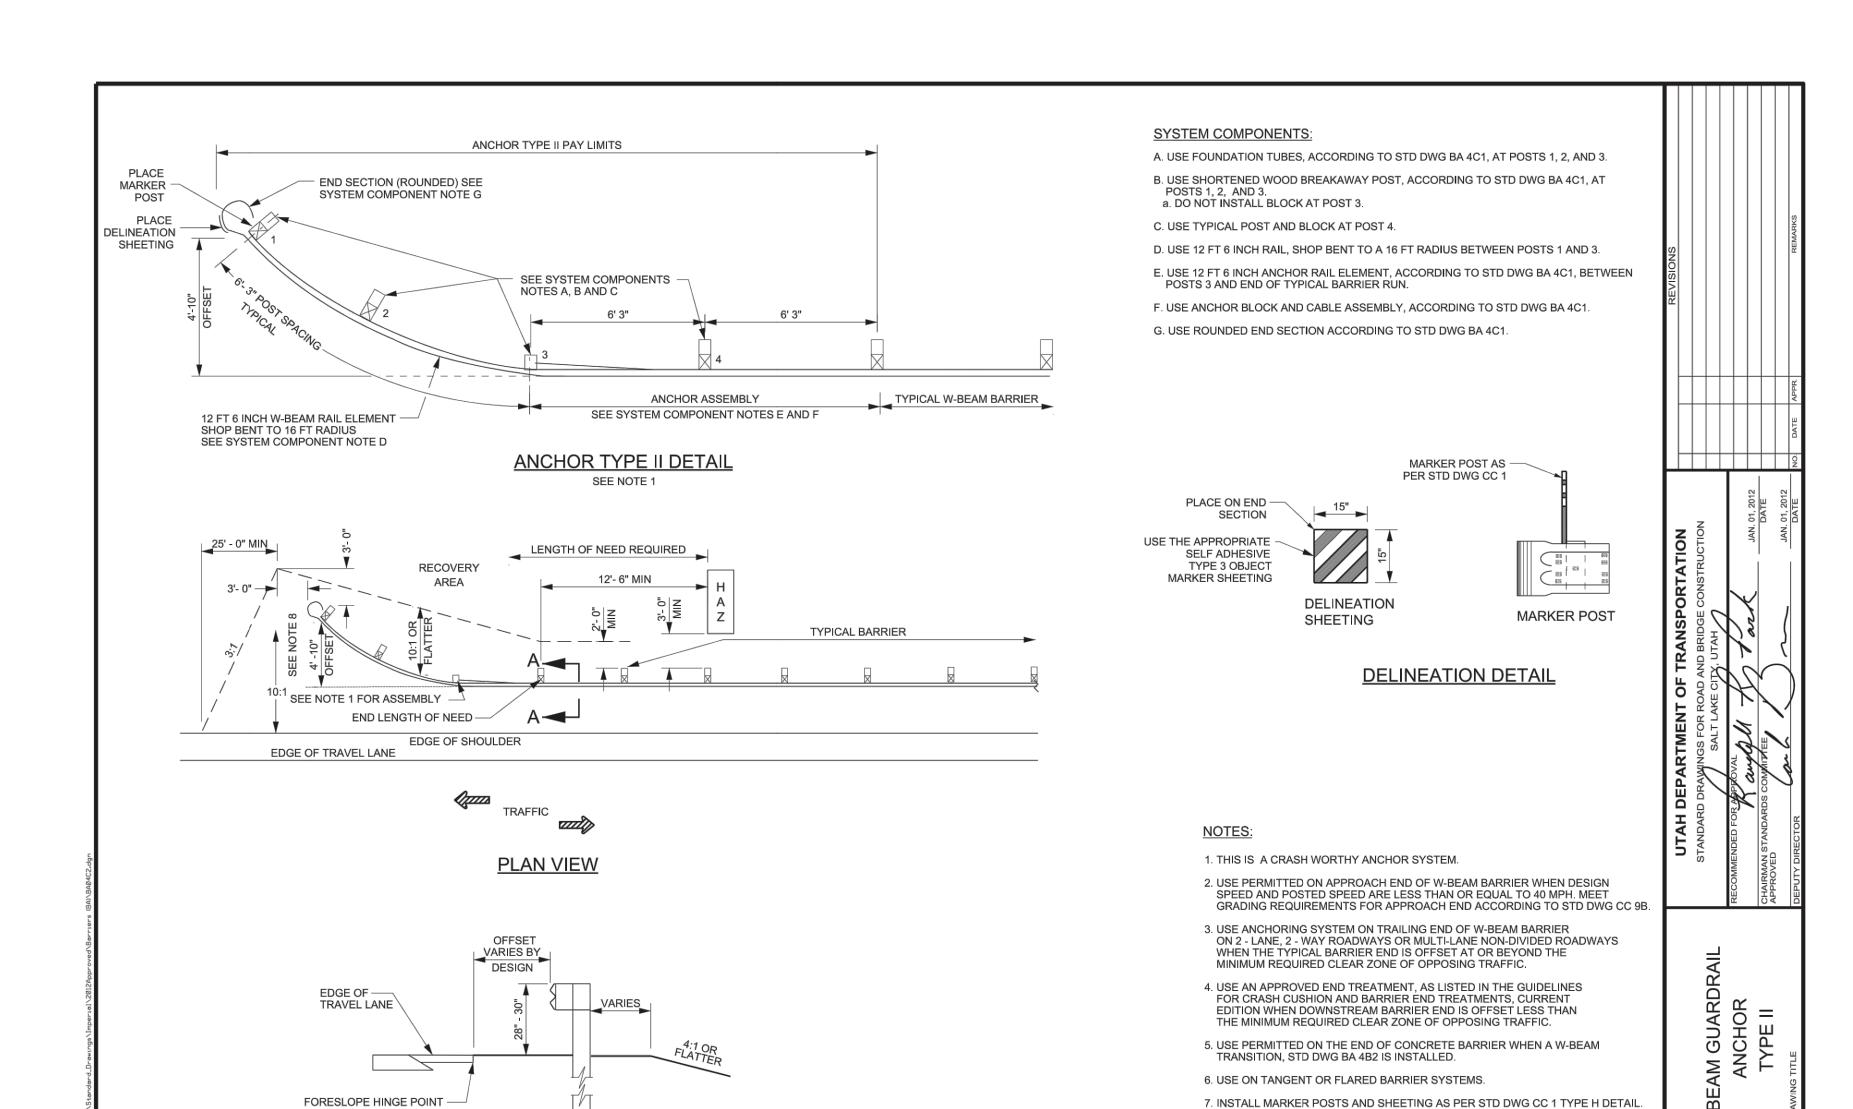

SECTION A-A

8. USE OF THIS ANCHORAGE PERMITTED ON SLOPES STEEPER THAN 10:1 AND

AN OFFSET OF 12 FT OR MORE FROM FORESLOPE HINGE POINT. REFER TO

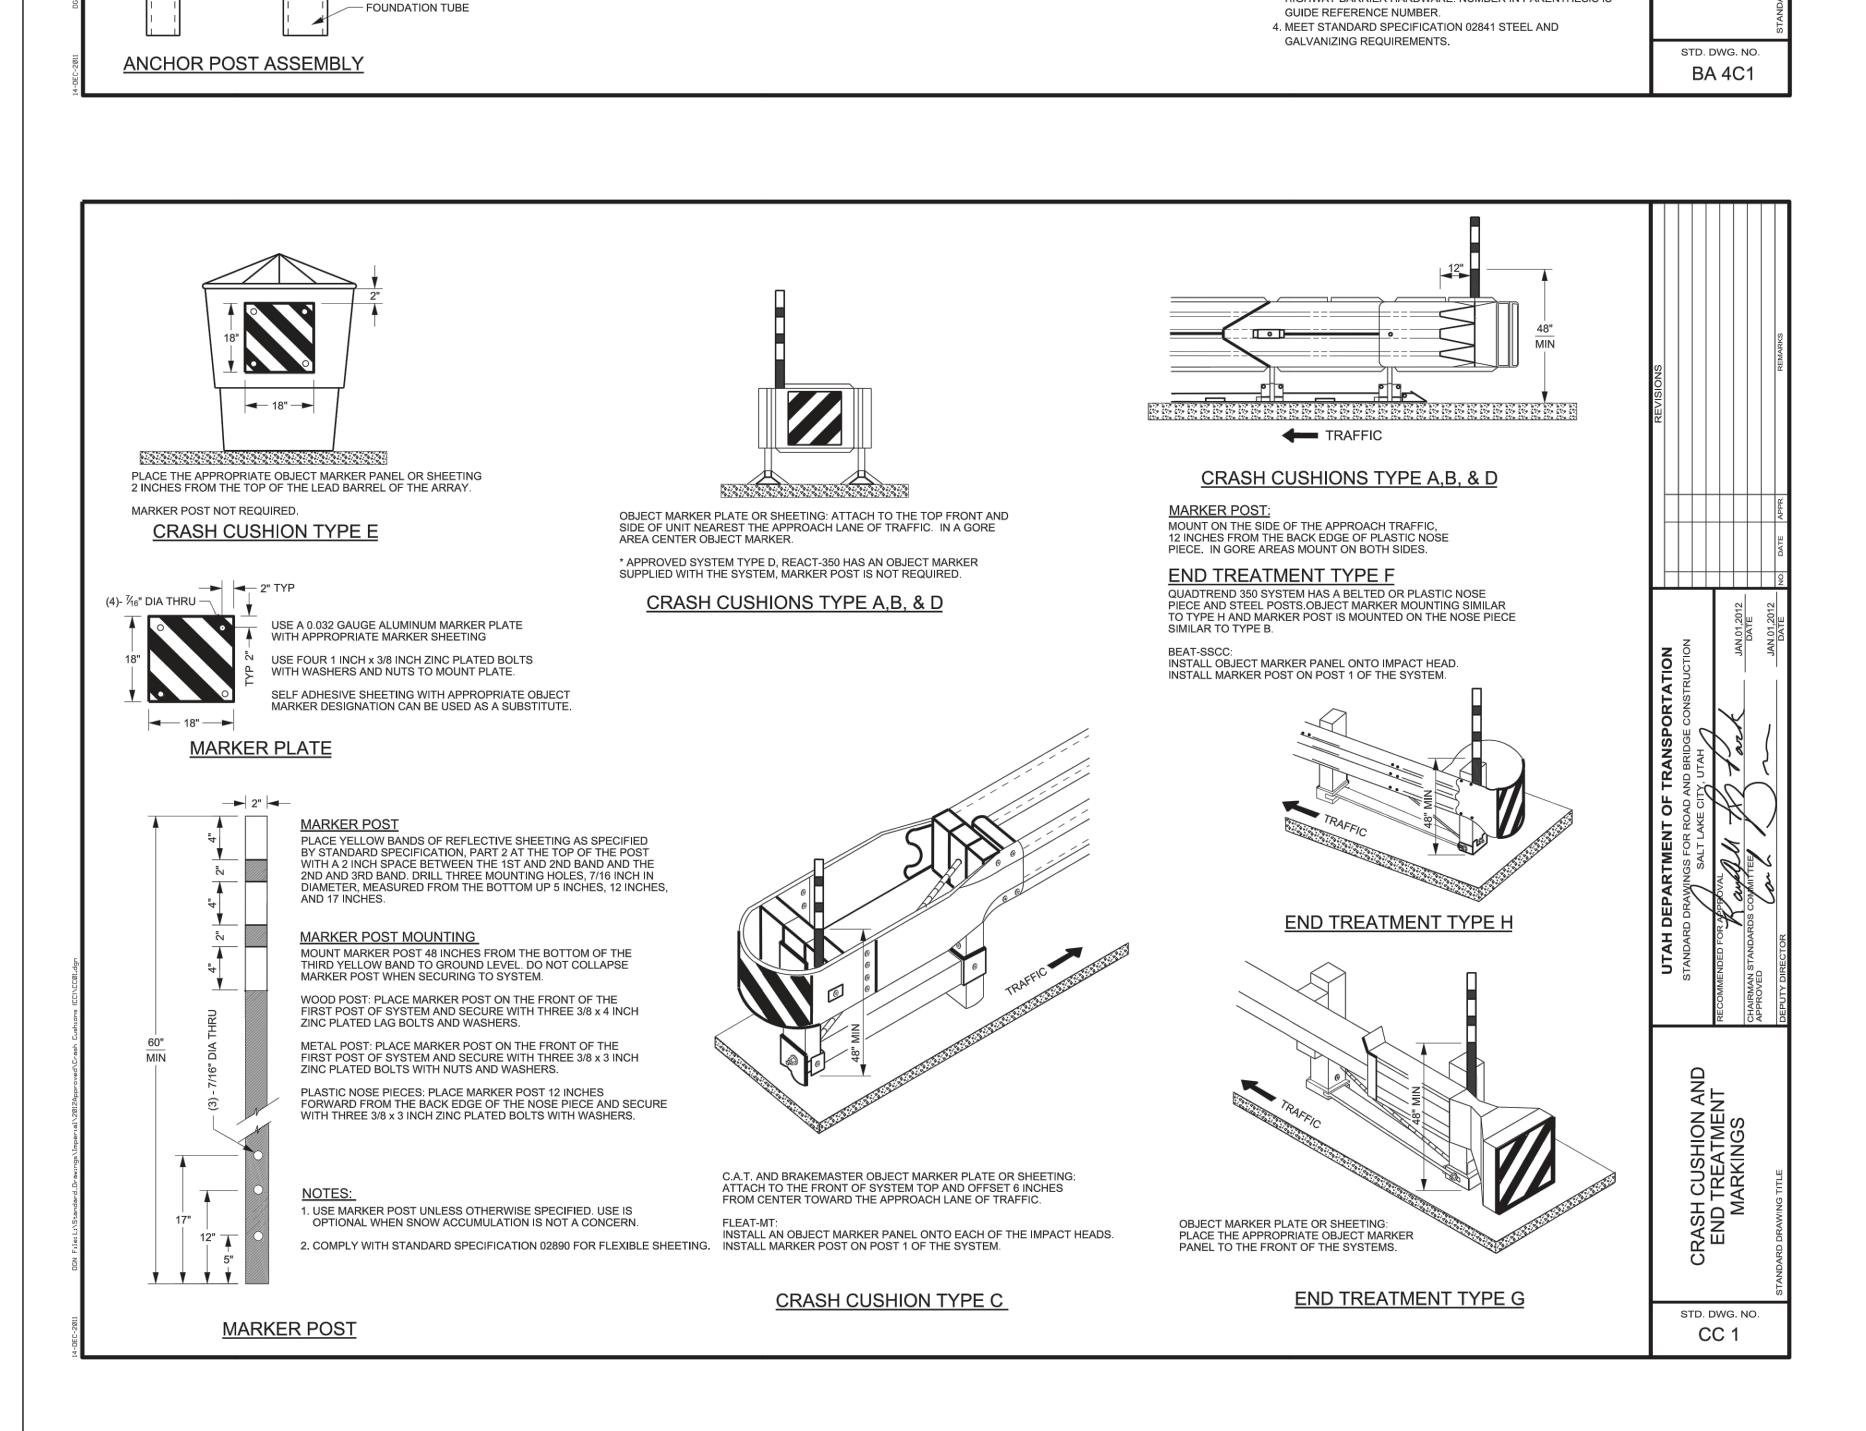

12 FT -6 INCH

- 29/32 INCH ANCHOR ATTACHMENT SLOT

RAIL ELEMENT (RWM14A)

FOUNDATION TUBE (PTE05)

WOOD BREAKAWAY POST

5/8 INCH x 10 INCH BOLT

- 5/8 INCH X 7 1/2 INCH BOLT

(TWO REQUIRED PER POST)

NUT AND WASHER

NUT AND WASHER

SEE NOTE 3

SEE NOTE 3

6 FT -3 INCH

TS 8 INCH X 6 INCH X 0.1875 INCH

MARKER POST AS -PER STD DWG CC 1

STANDARD 2 INCH ID PIPE -

SLEEVE (2 3/8 INCH OD)

BEARING PLATE -

TWO 1 INCH NUTS -

AND WASHERS

ANCHOR POST ASSEMBLY -

6 1/4 INCH

6 FT 6 INCH

CABLE ANCHOR ASSEMBLY (FCA01)

— 3/4 INCH CABLE /— SWAGE

1 INCH X 7 INCH STUD -

THREADED FULL

LENGTH (TYP)

— 1 INCH X 1 1/8 INCH SPLICE BOLT SLOT (TYP)

MATCH BEAM

POST AND BLOCK

W-BEAM ANCHOR INSTALLATION

GUARDRAIL

END SECTION (ROUNDED)(RWE03A)

ANCHOR PAY LIMIT (12 1/2 FT)

75 INCH

TWO 1 INCH NUTS -

AND WASHERS

15/16 INCH R ---

SECTION B-B

1 1/16 INCH HOLE

5/8 INCH STEEL PLATE

INSTALL BEARING PLATE WITH

TO POST USING TWO NAILS AT

TOP OF PLATE.

5 INCH PORTION UP. SECURE PLATE

BEARING PLATI

ANCHOR BRACKET (FPA01)

3/16 INCH X 1 INCH X 8 INCH PLATE

- 1 INCH X 1 1/8 INCH SPLICE

1. DO NOT USE ON APPROACH END.

DESIGN GUIDE, CURRENT EDITION.

2. USE ON BARRIER TRAILING END ON DIVIDED ROADWAYS WHEN

BARRIER END IS OUTSIDE THE MAXIMUM REQUIRED CLEAR ZONE AS DEFINED IN STD DWG DD 18 AND THE AASHTO ROADSIDE

3. MANUFACTURE ACCORDING TO AASHTO GUIDE TO STANDARDIZED HIGHWAY BARRIER HARDWARE. NUMBER IN PARENTHESIS IS

BOLT SLOT (TYP)

TYPICAL BARRIER

TACK WELD TO 5/8 INCH PLATE

R16 5/16 INCH -

3/8 INCH R -1/4"

11/16 INCH HOLE (EIGHT REQUIRED)

ELEVATION

3 INCH X 2 1/4 INCH X 1/2 INCH END PLATE -

6 FT -3 INCH

ф 0 0

1 INCH X 1 1/8 INCH SPLICE BOLT HOLE

45" 3 SPACES @ 4"

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4 1/4"

2" 8 1/2 INCH

HOLE

WOOD BREAKAWAY POST

HOLES

