

COBABE RANCH

PRELIMINARY SUBMITTAL - PHASE 1
WEBER COUNTY, UTAH

LOCATION MAP



PREPARED FOR:

COBABE RANCH LLC.
JOHN LEWIS/SHANE DUNLEAVY
3718 N WOLF CREEK DR
EDEN, UTAH 84310
801.430.1507 - 801.979.7989

CONSULTANTS:


LANDSCAPE ARCHITECT
LANGVARDT DESIGN GROUP
328 WEST, 200 SOUTH, SUITE 102
SALT LAKE CITY, UTAH 84101
801.583.1295

ENGINEER:
GARDNER ENGINEERING
RYAN CHRISTENSEN
968 CHAMBERS STREET, SUITE 5
SOUTH OGDEN, UTAH 84403
801.476.0202

PROJECT MANAGEMENT:
THE HOUSEHOLDER GROUP
ERIC HOUSEHOLDER
2850 NORTH NORDIC VALLEY DRIVE
EDEN, UTAH 84310
801.389.0040

SHEET INDEX:


C-01	COVER SHEET
SP1	SITE PLAN
DRI	DRAINAGE OVERALL
UTO	UTILITY OVERVIEW
UT1-5	UTILITY SHEETS
SS1-4	SEWER MASTER PLAN
SW1	SWPPP
PP1-PPF	PLAN AND PROFILE SHEETS
DT1	DETAILS

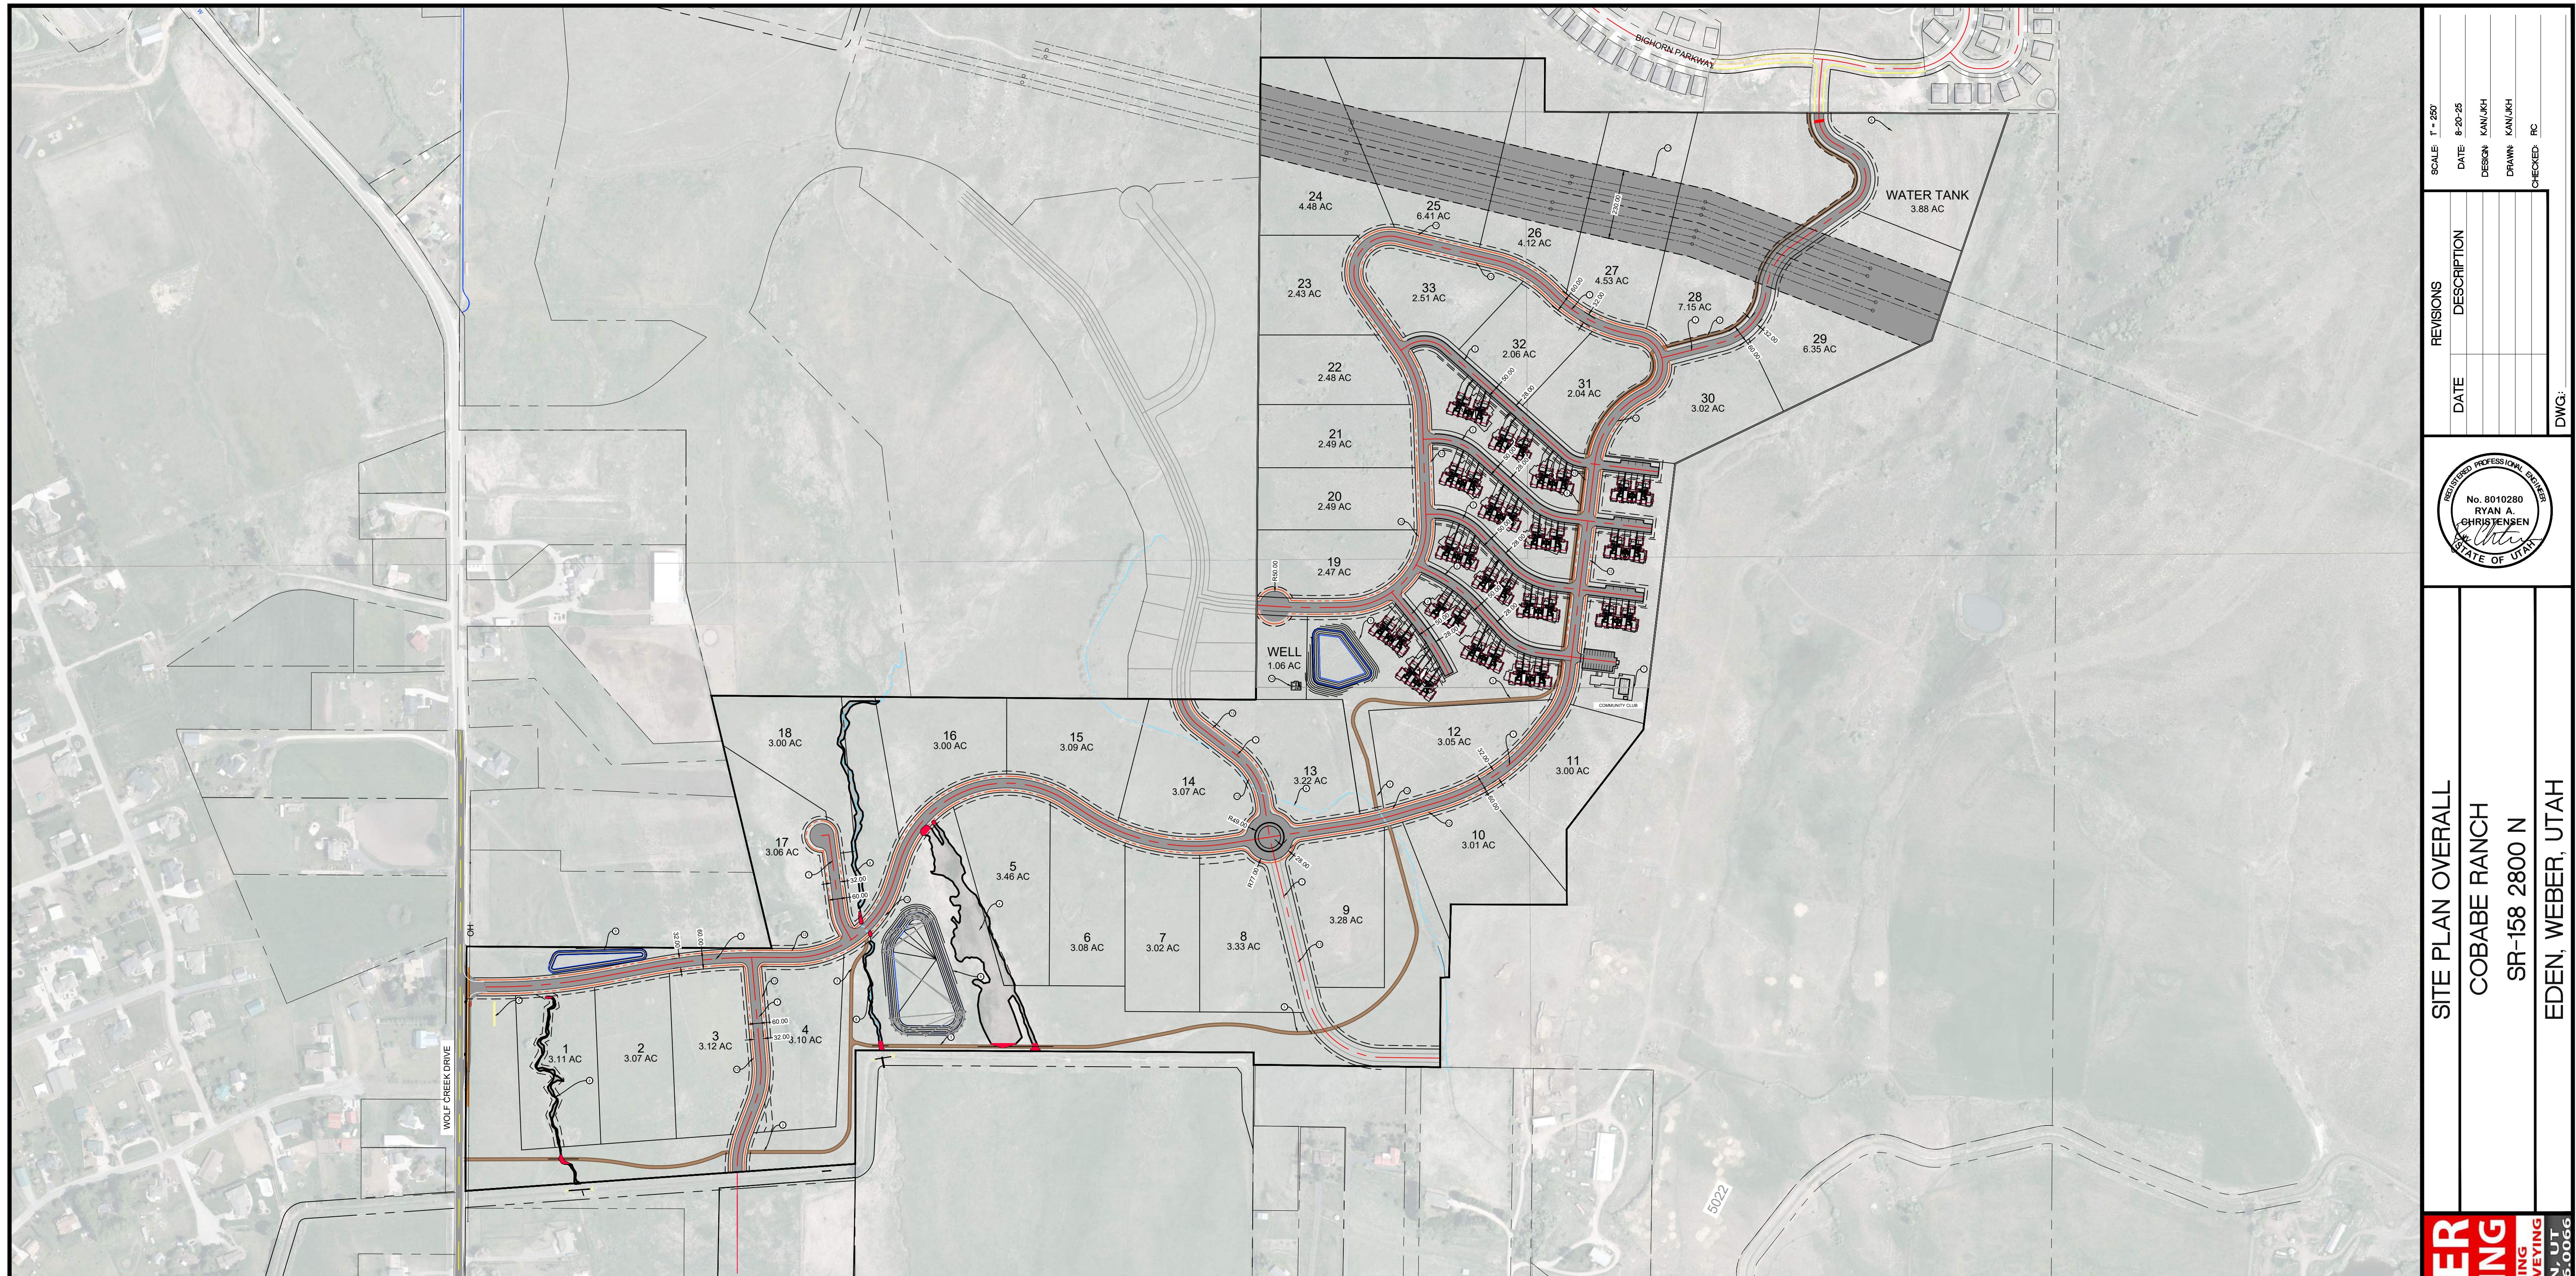



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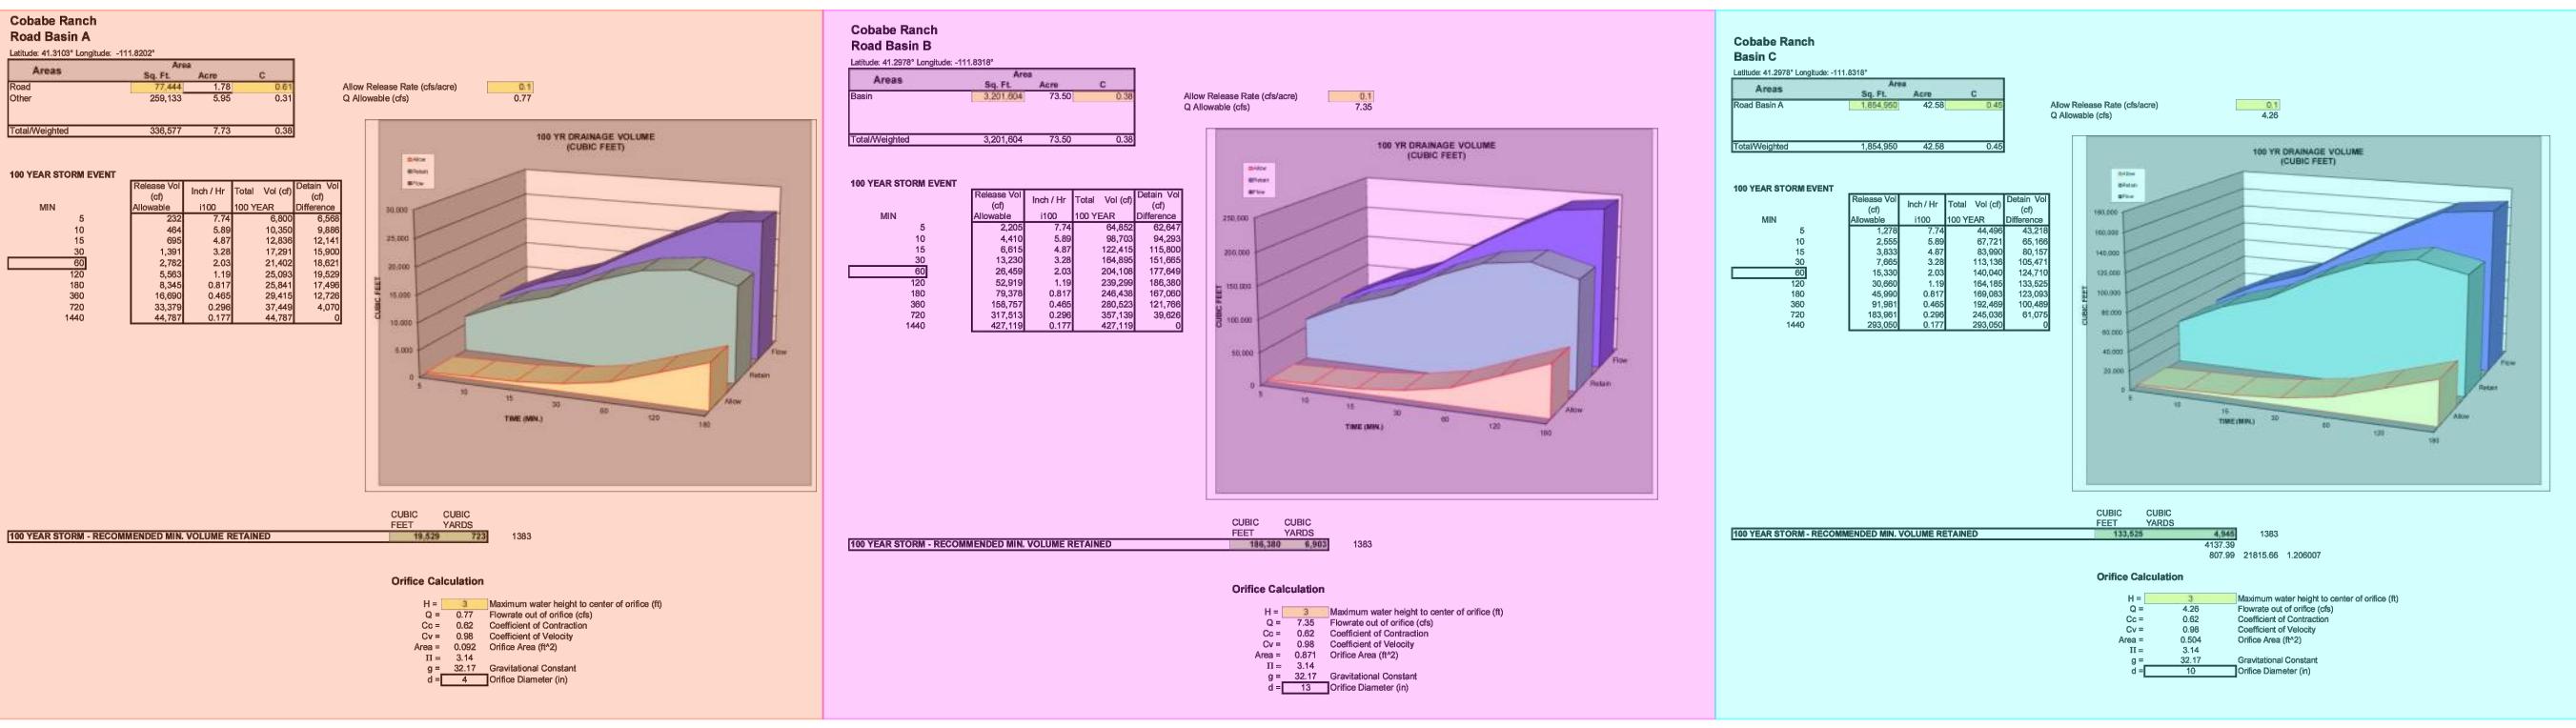
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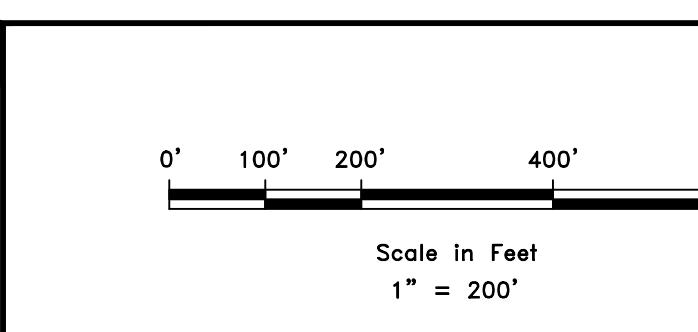
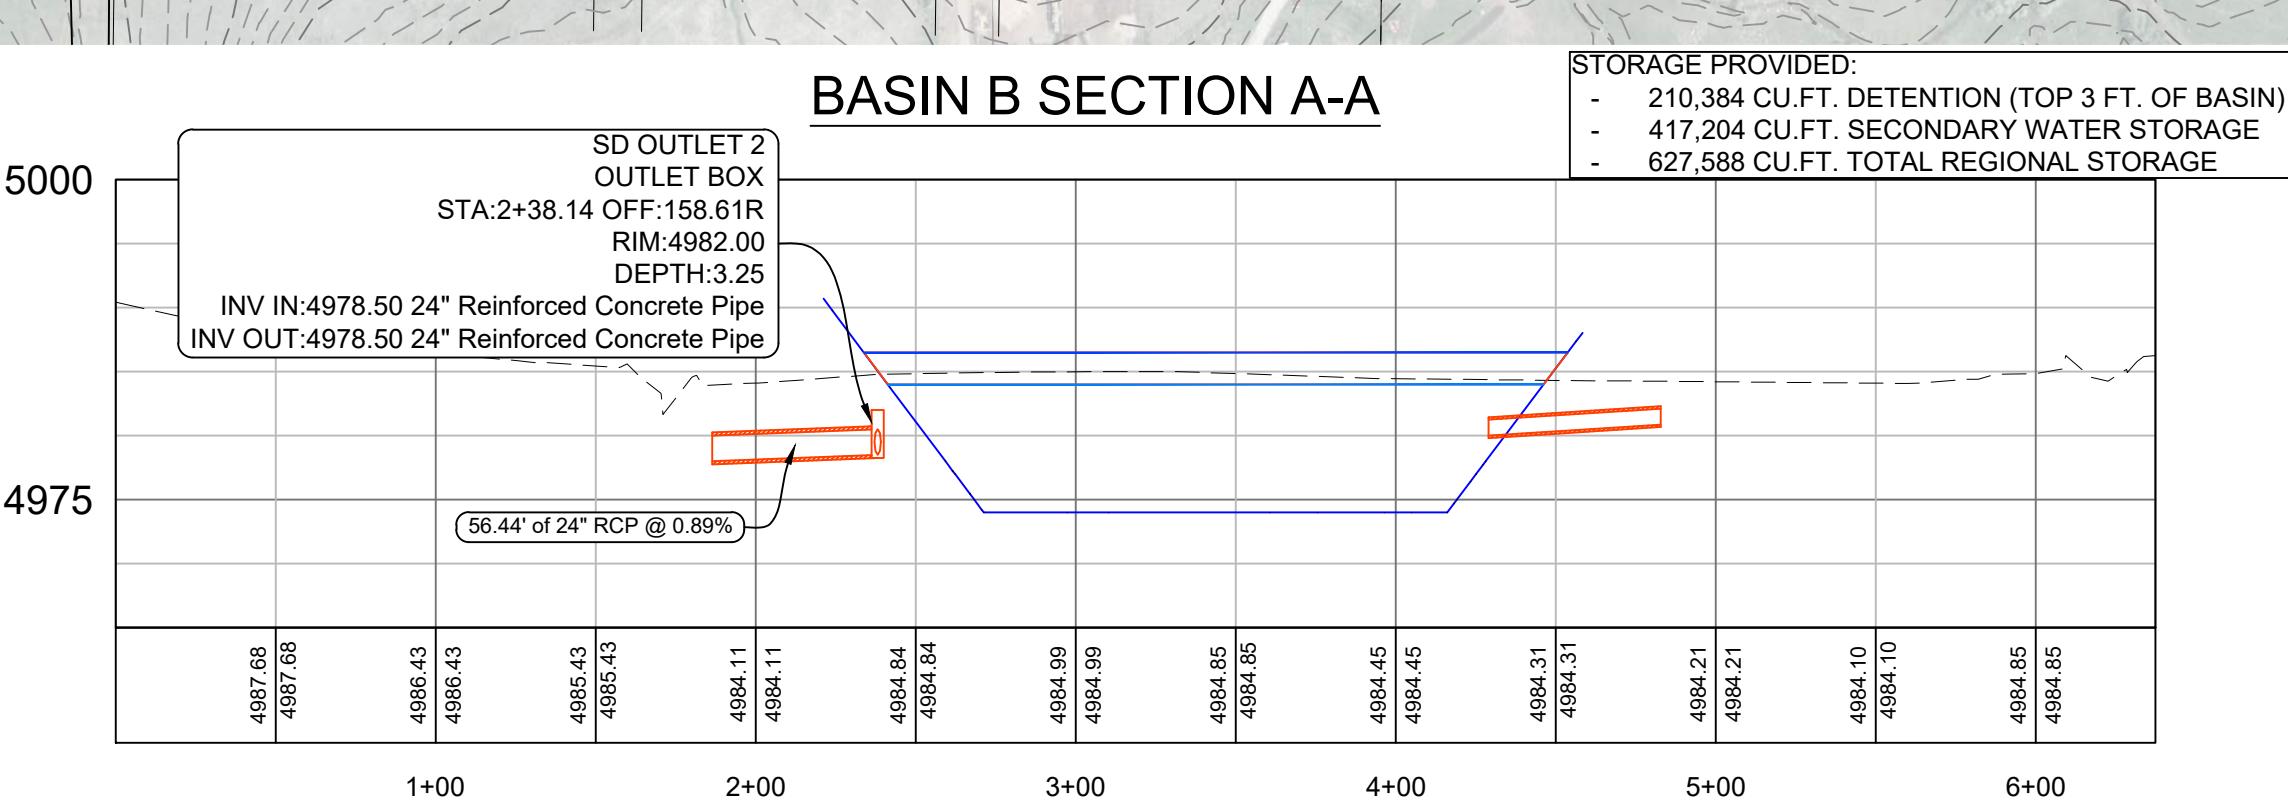
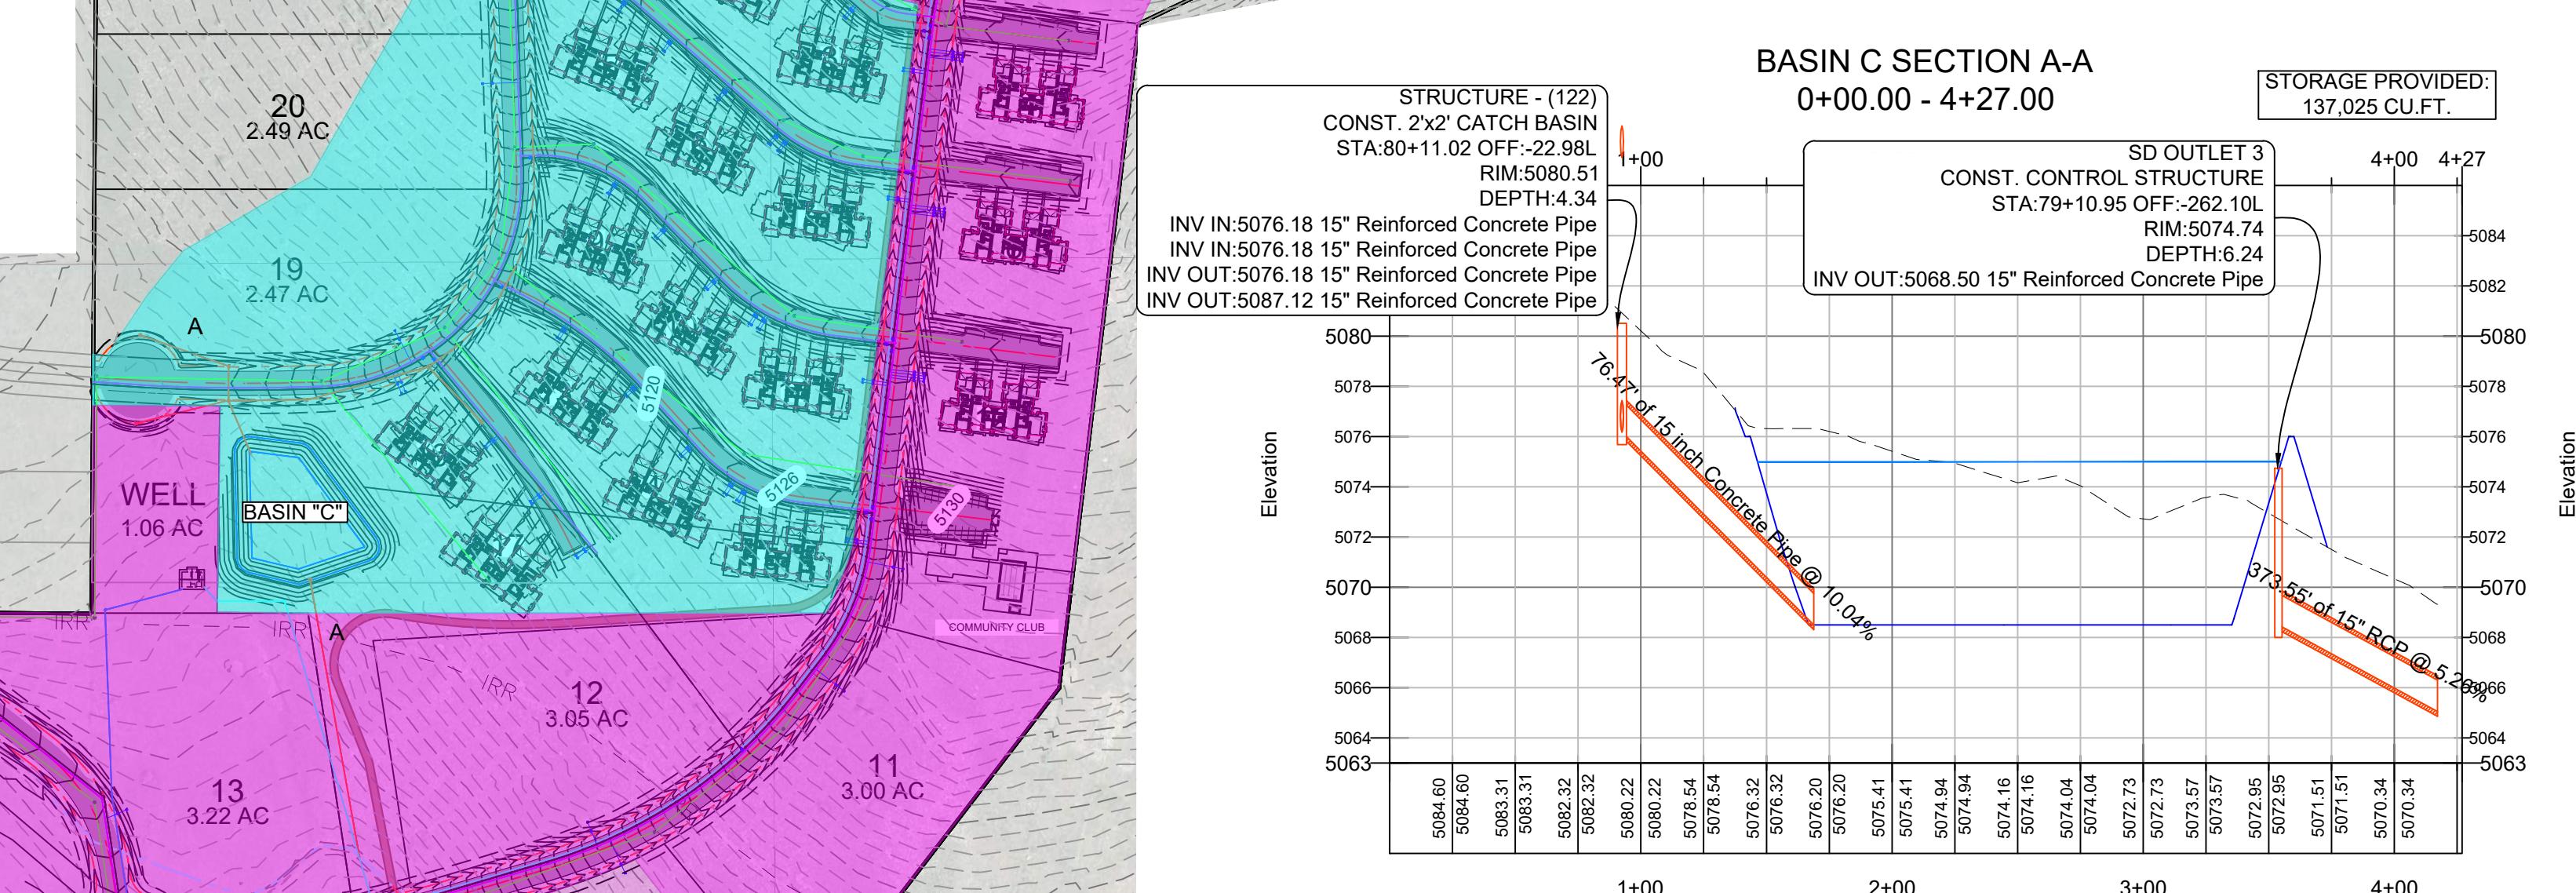
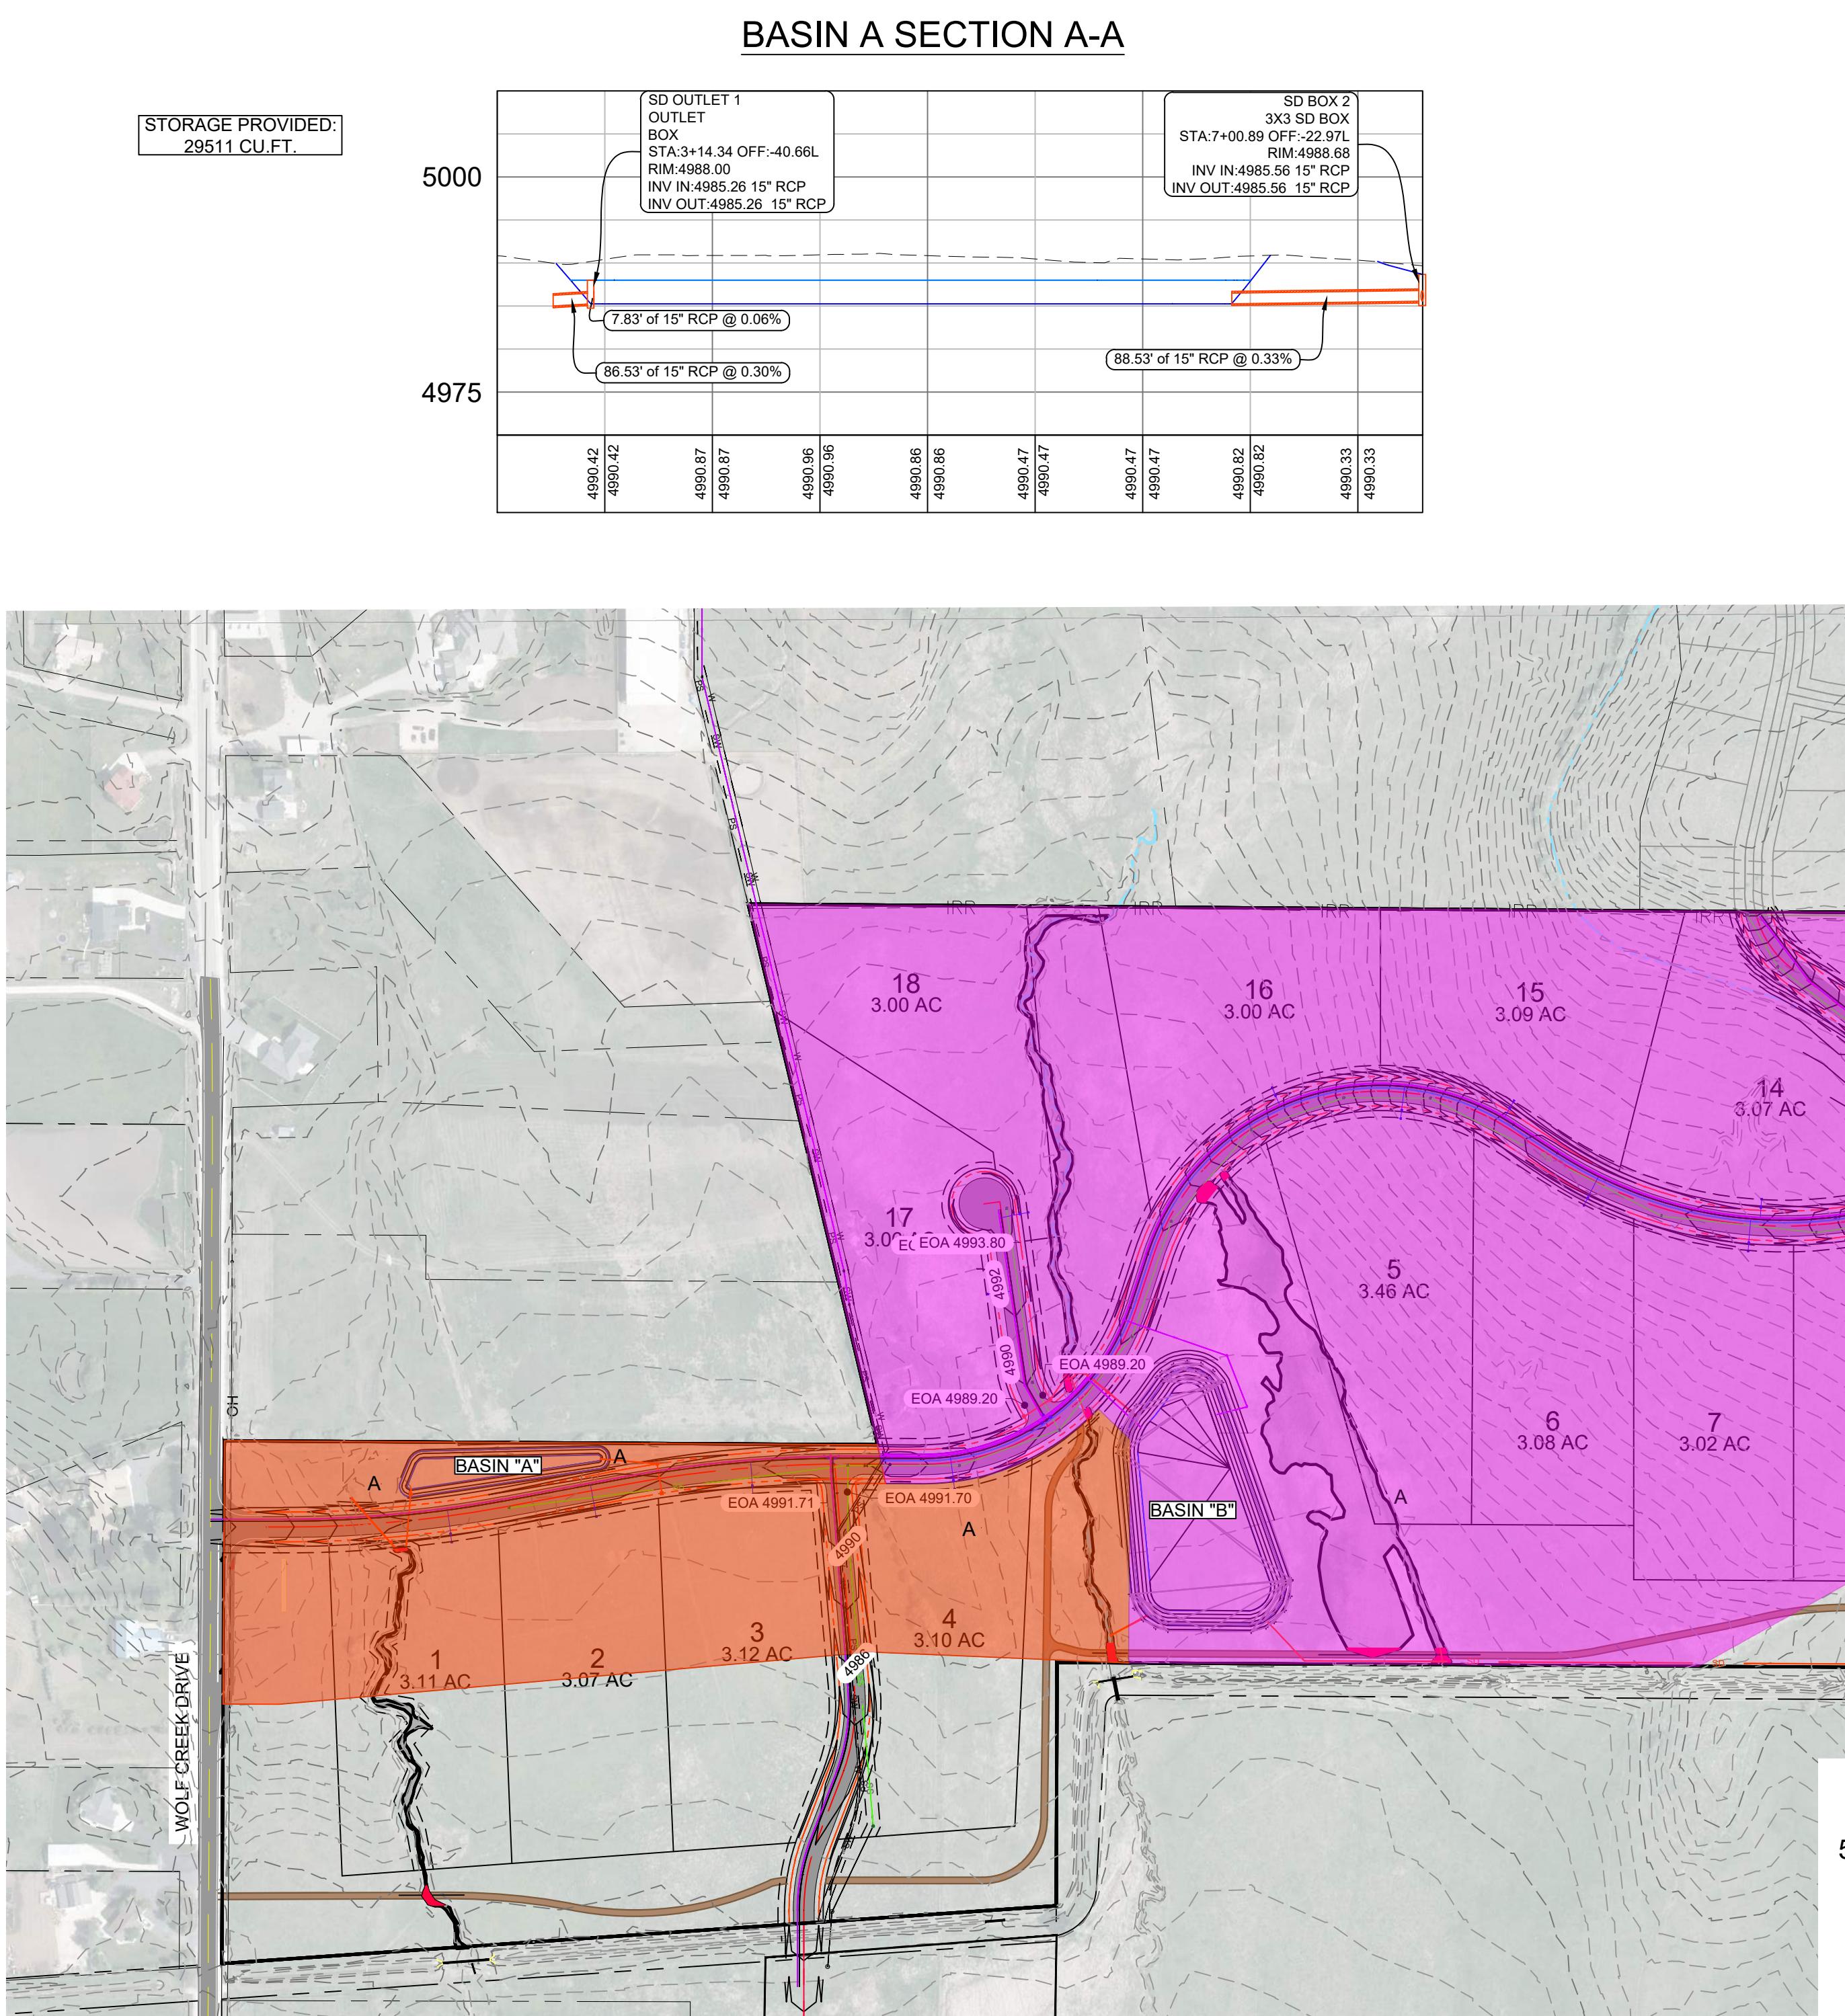
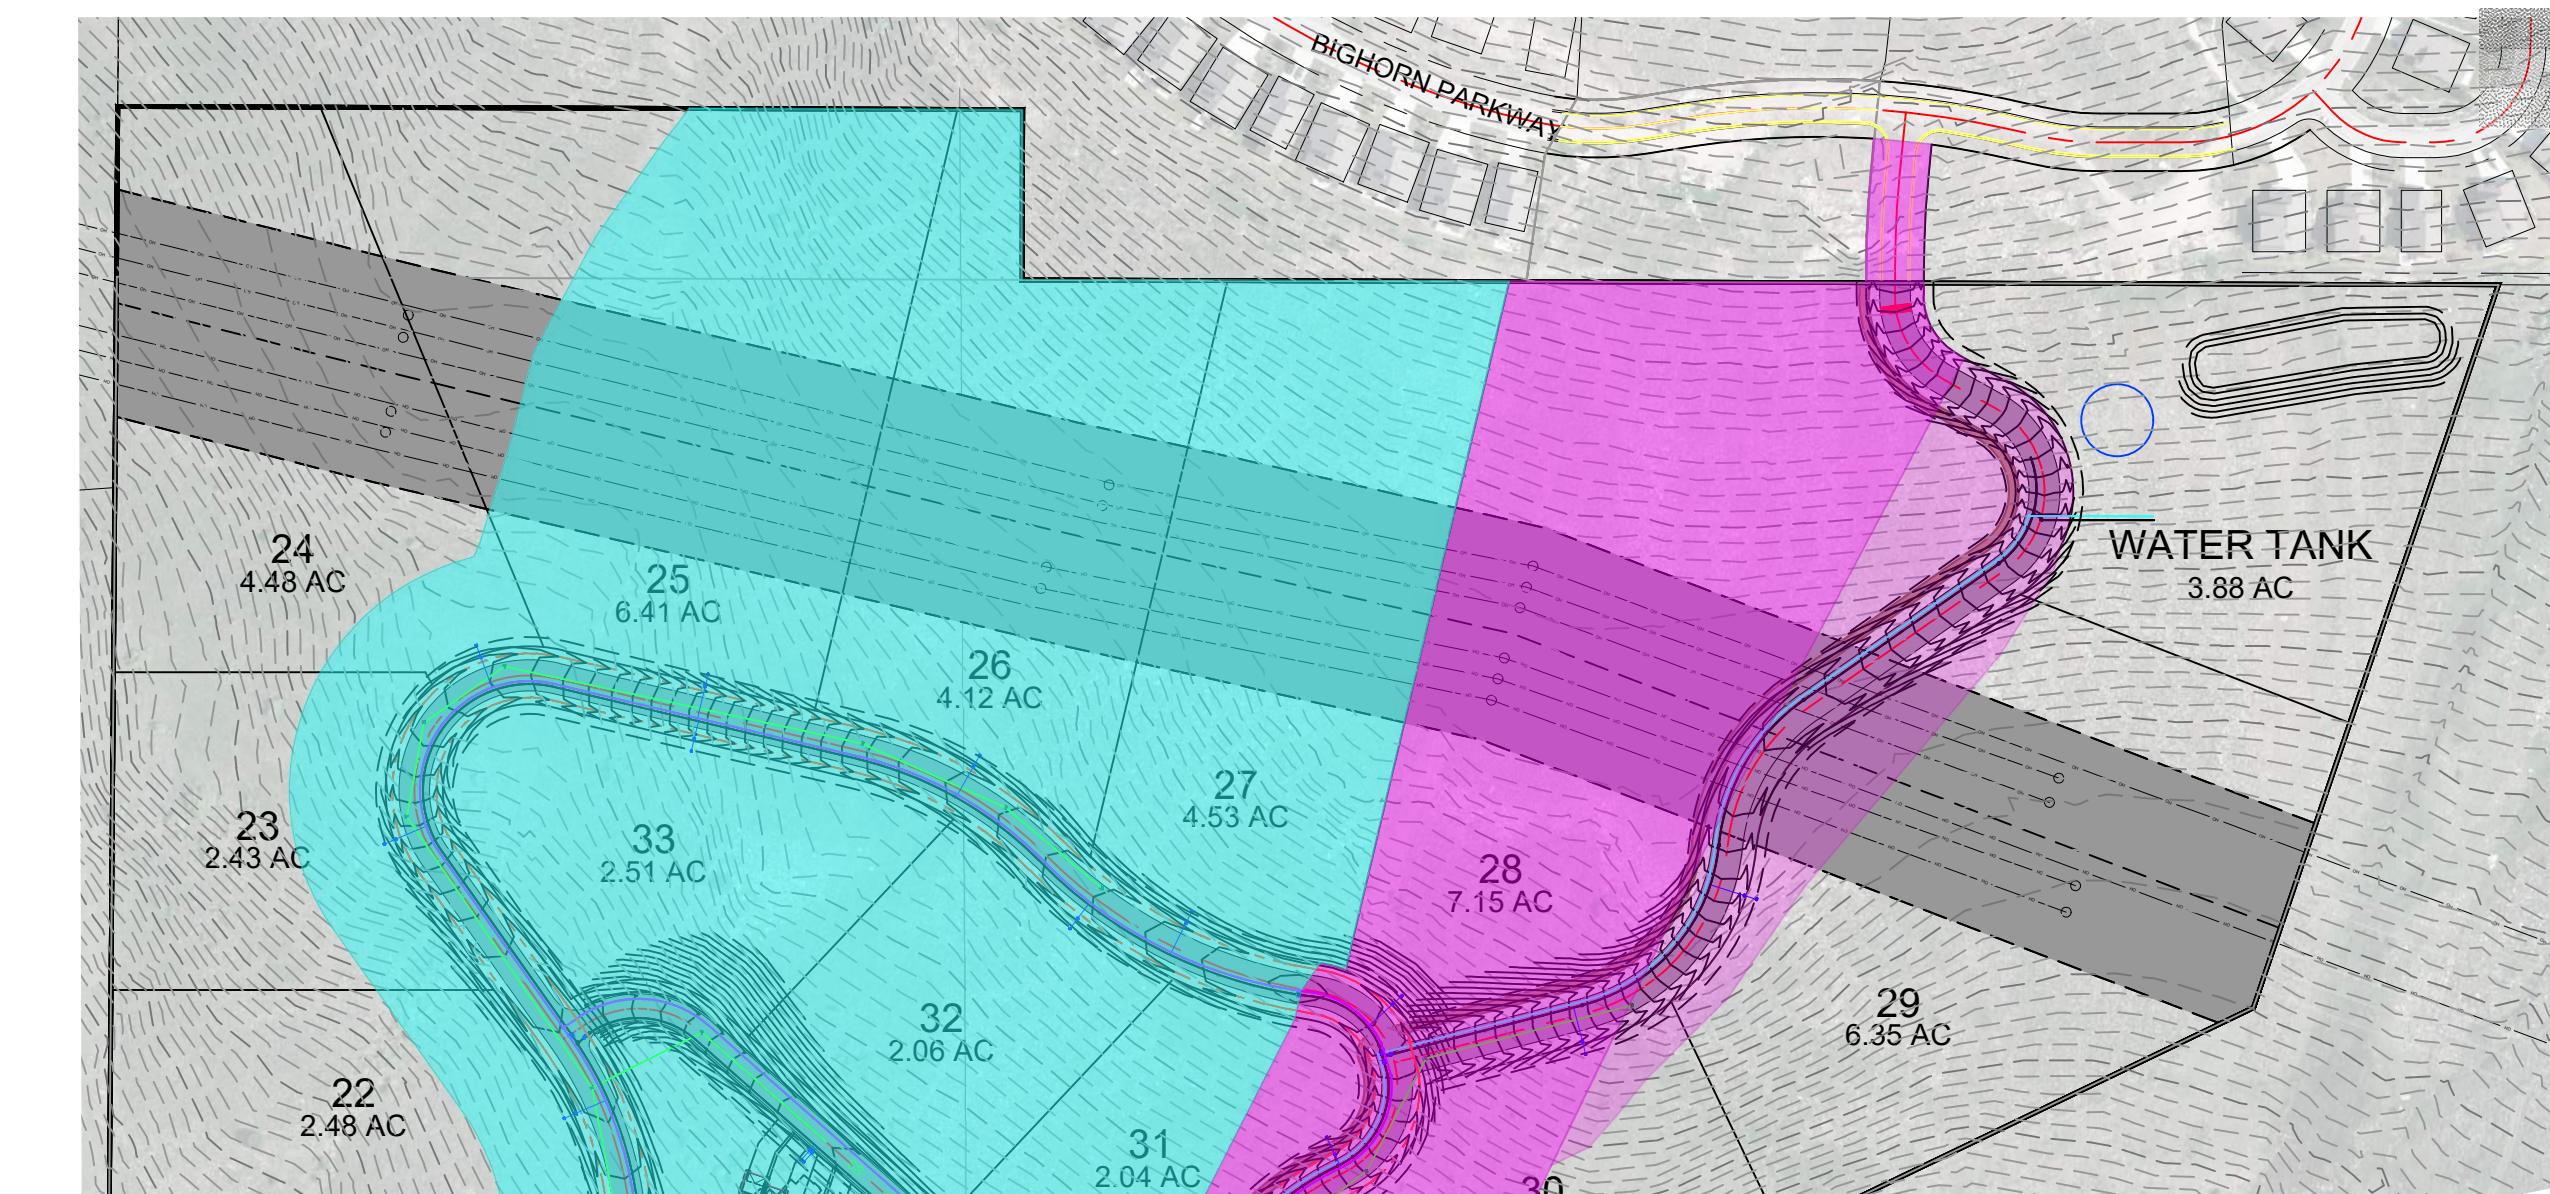
- SITE KEYNOTES:
- 1 60' ROW TYPICAL ROAD SECTION
 - 2 50' ROW TYPICAL ROAD SECTION
 - 3 TRAIL
 - 4 WETLANDS
 - 5 EXISTING ENTRANCE MONUMENT
 - 6 WATER STORAGE TANK SITE
 - 7 COMMUNITY CLUB SITE
 - 8 EXISTING DRAINAGE COURSE
 - 9 DETENTION POND
 - 10 WATER WELL SITE
 - 11 OVERHEAD POWER EASEMENT
 - 12 DRAINAGE SWALE
 - 13 FUTURE ROAD



Scale in Feet
1" = 250'

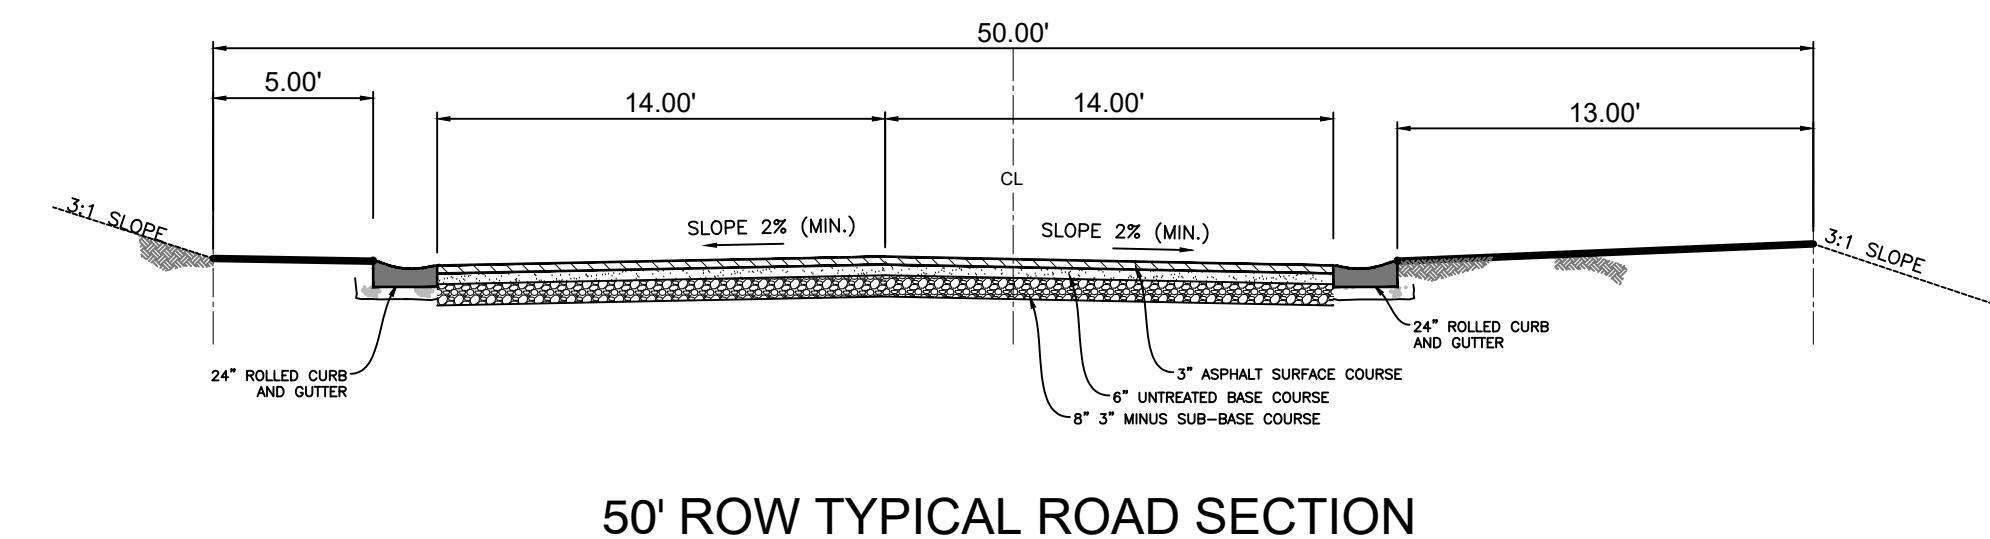

OVERALL DRAINAGE

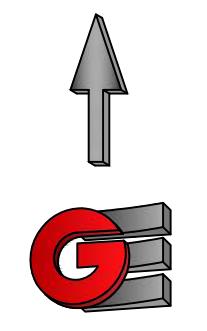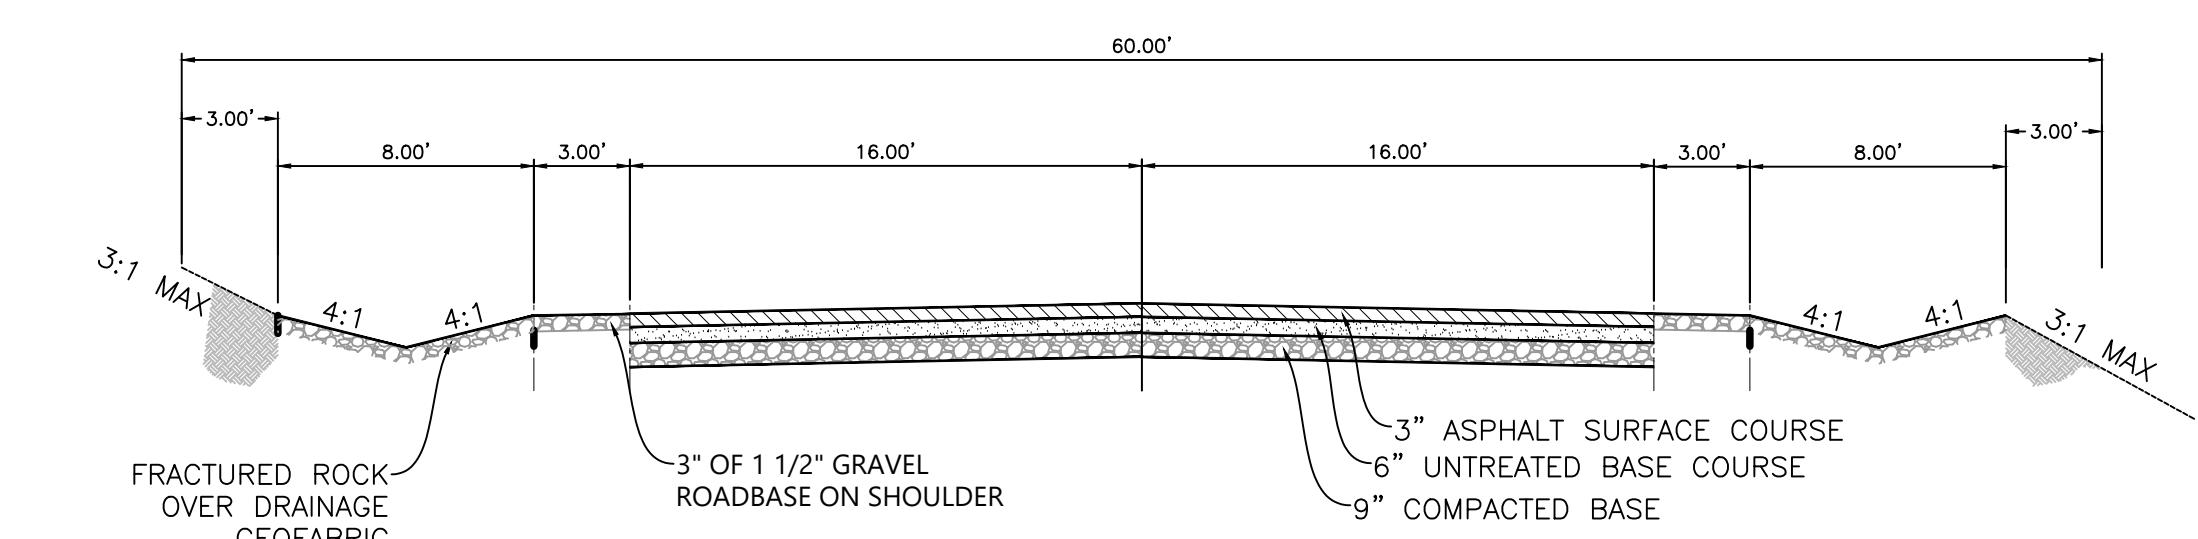

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DR1


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SCALE: 1" = 200'	DATE: 8-20-25	DESIGN: KAN/JKH
		DRAWN: KAN/JKH
		CHECKED: RC

DWG:

REGISTERED PROFESSIONAL ENGINEER
No. 8010280
RYAN A.
CHRISTENSEN
STATE OF UTAH
[Signature]

OVERALL DRAINAGE
COBABE RANCH
SR-158 2800 N
EDEN, WEBER, UTAH

OVERALL UTILITY

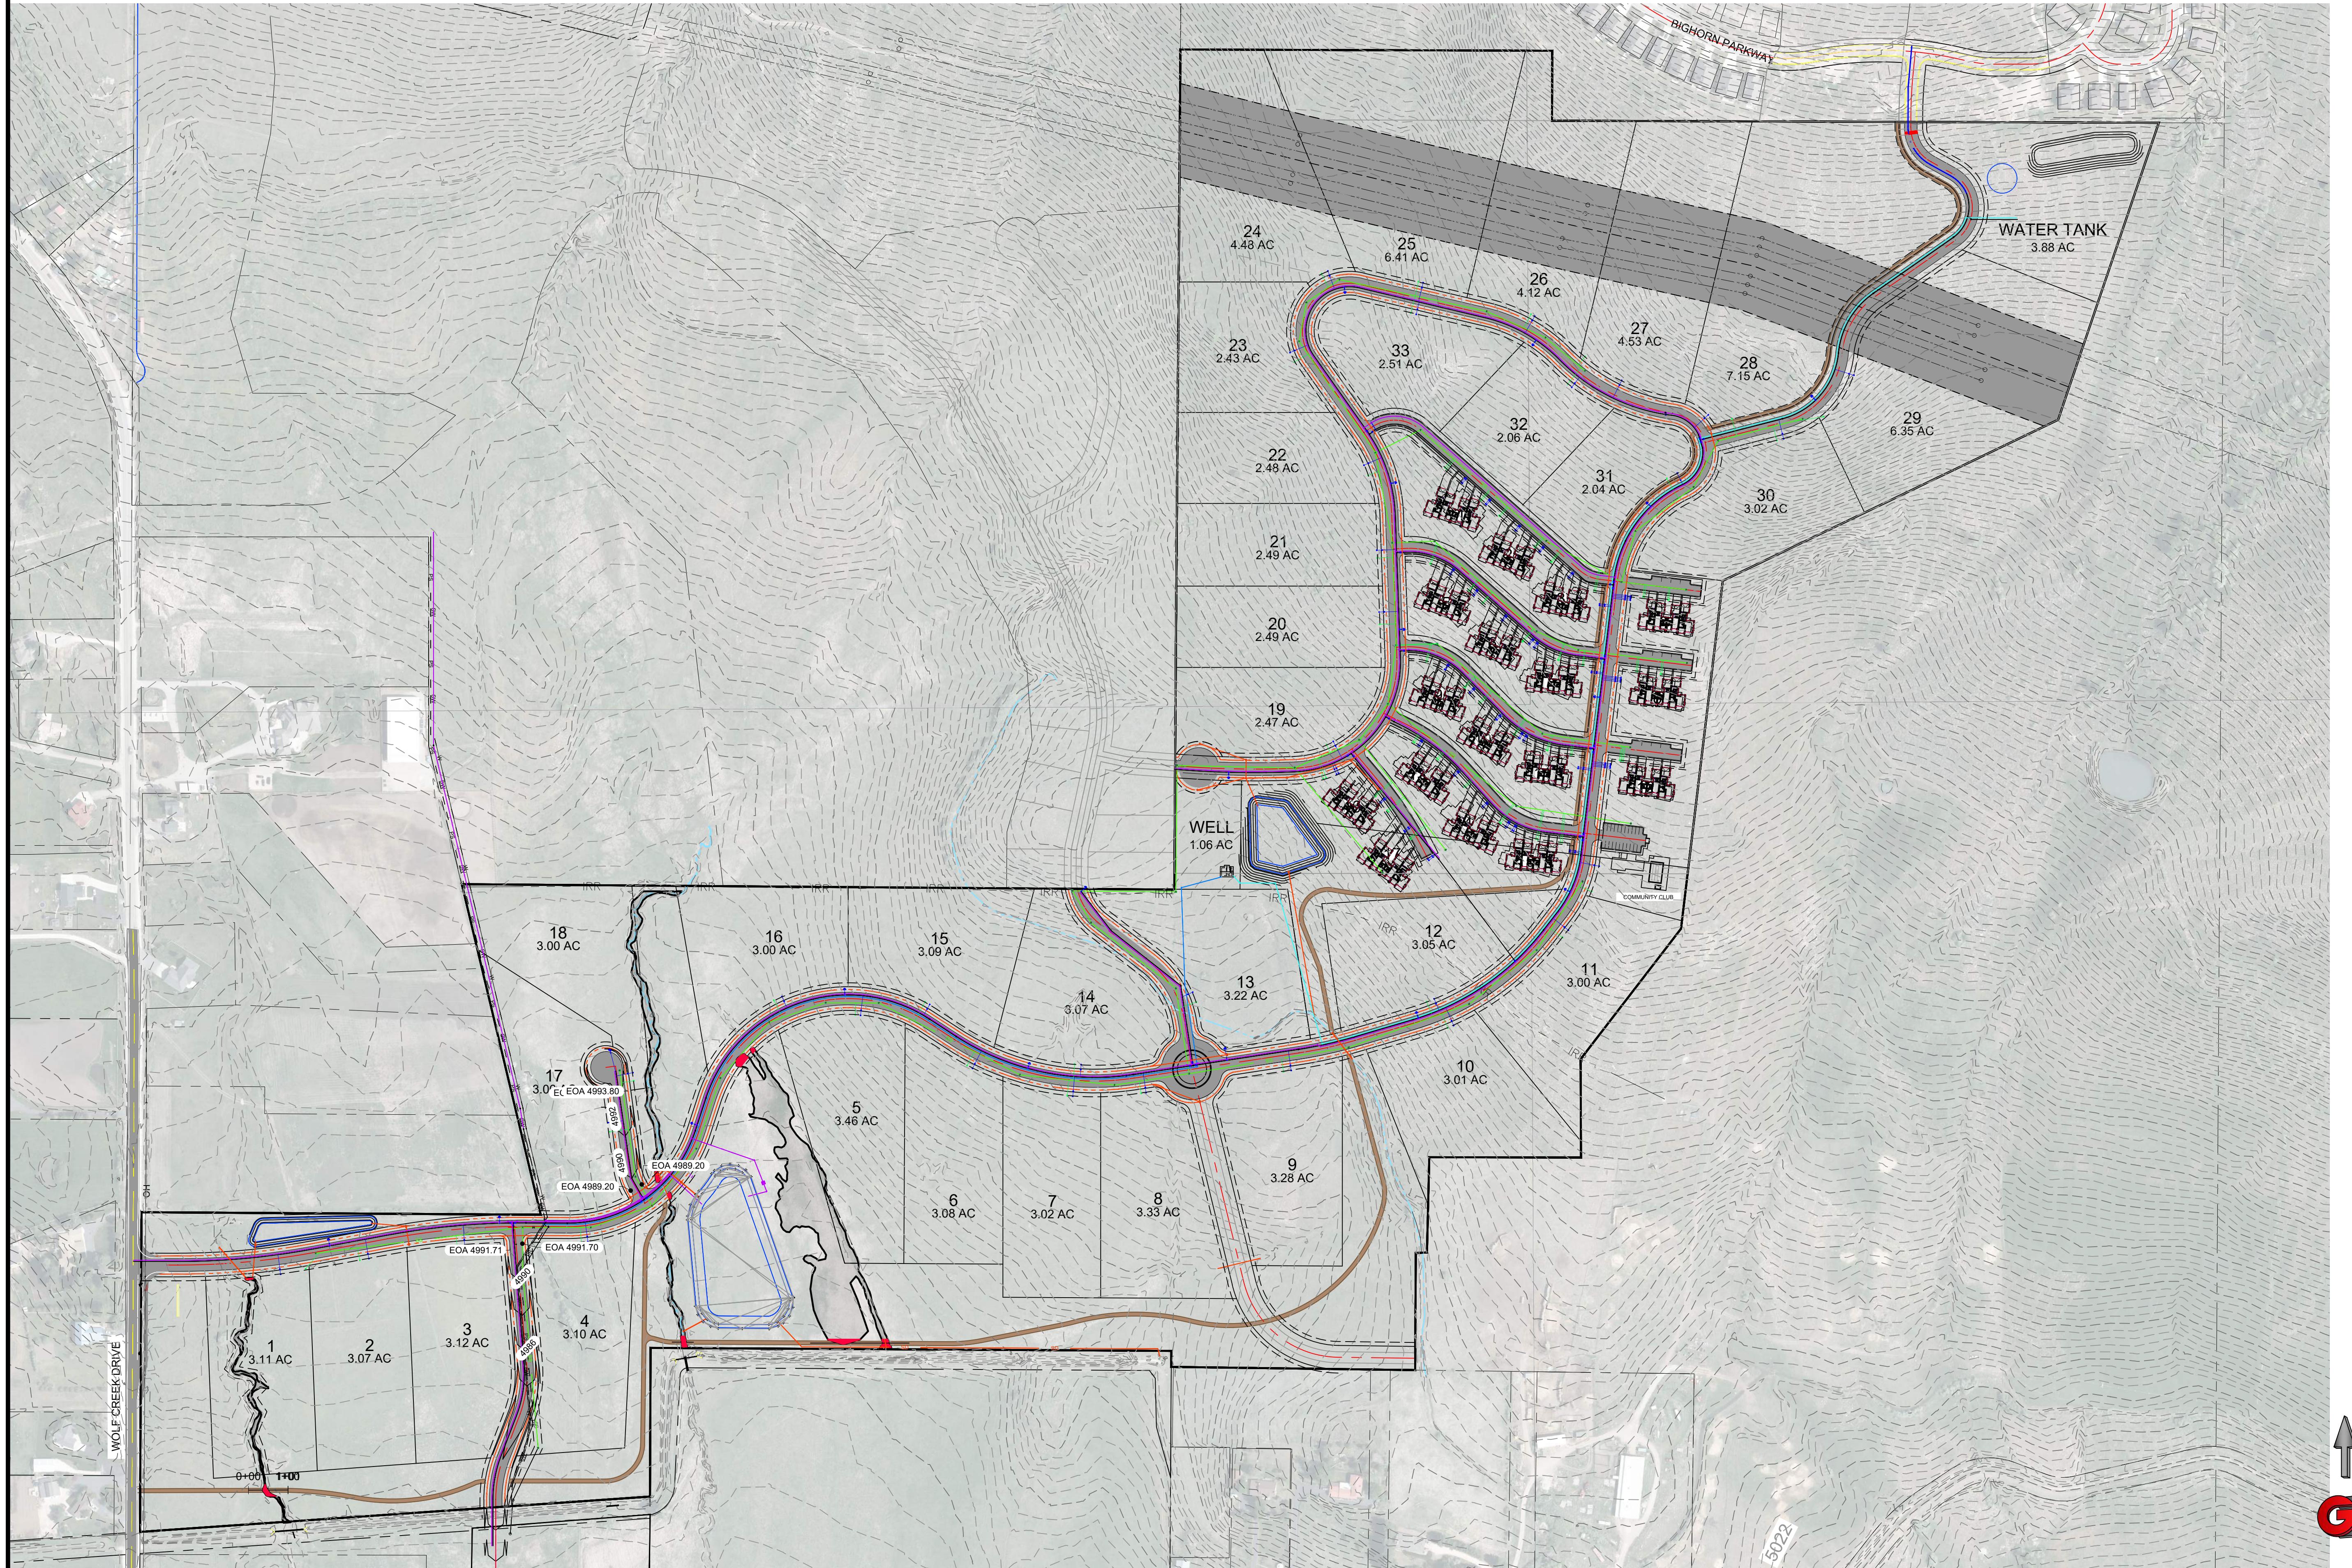



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UTO

SCALE: 1" = 200'	DATE: 8-20-25
REVISIONS	DESCRIPTION
DATE	DESIGN
	KANJH
	DRAWN: KANJH
CHECKED:	RC

DWG: R:\1201 - LEWIS HOMES\2101 - COBABE RANCH\DESIGN\DWG\COBABE_RANCH.DWG



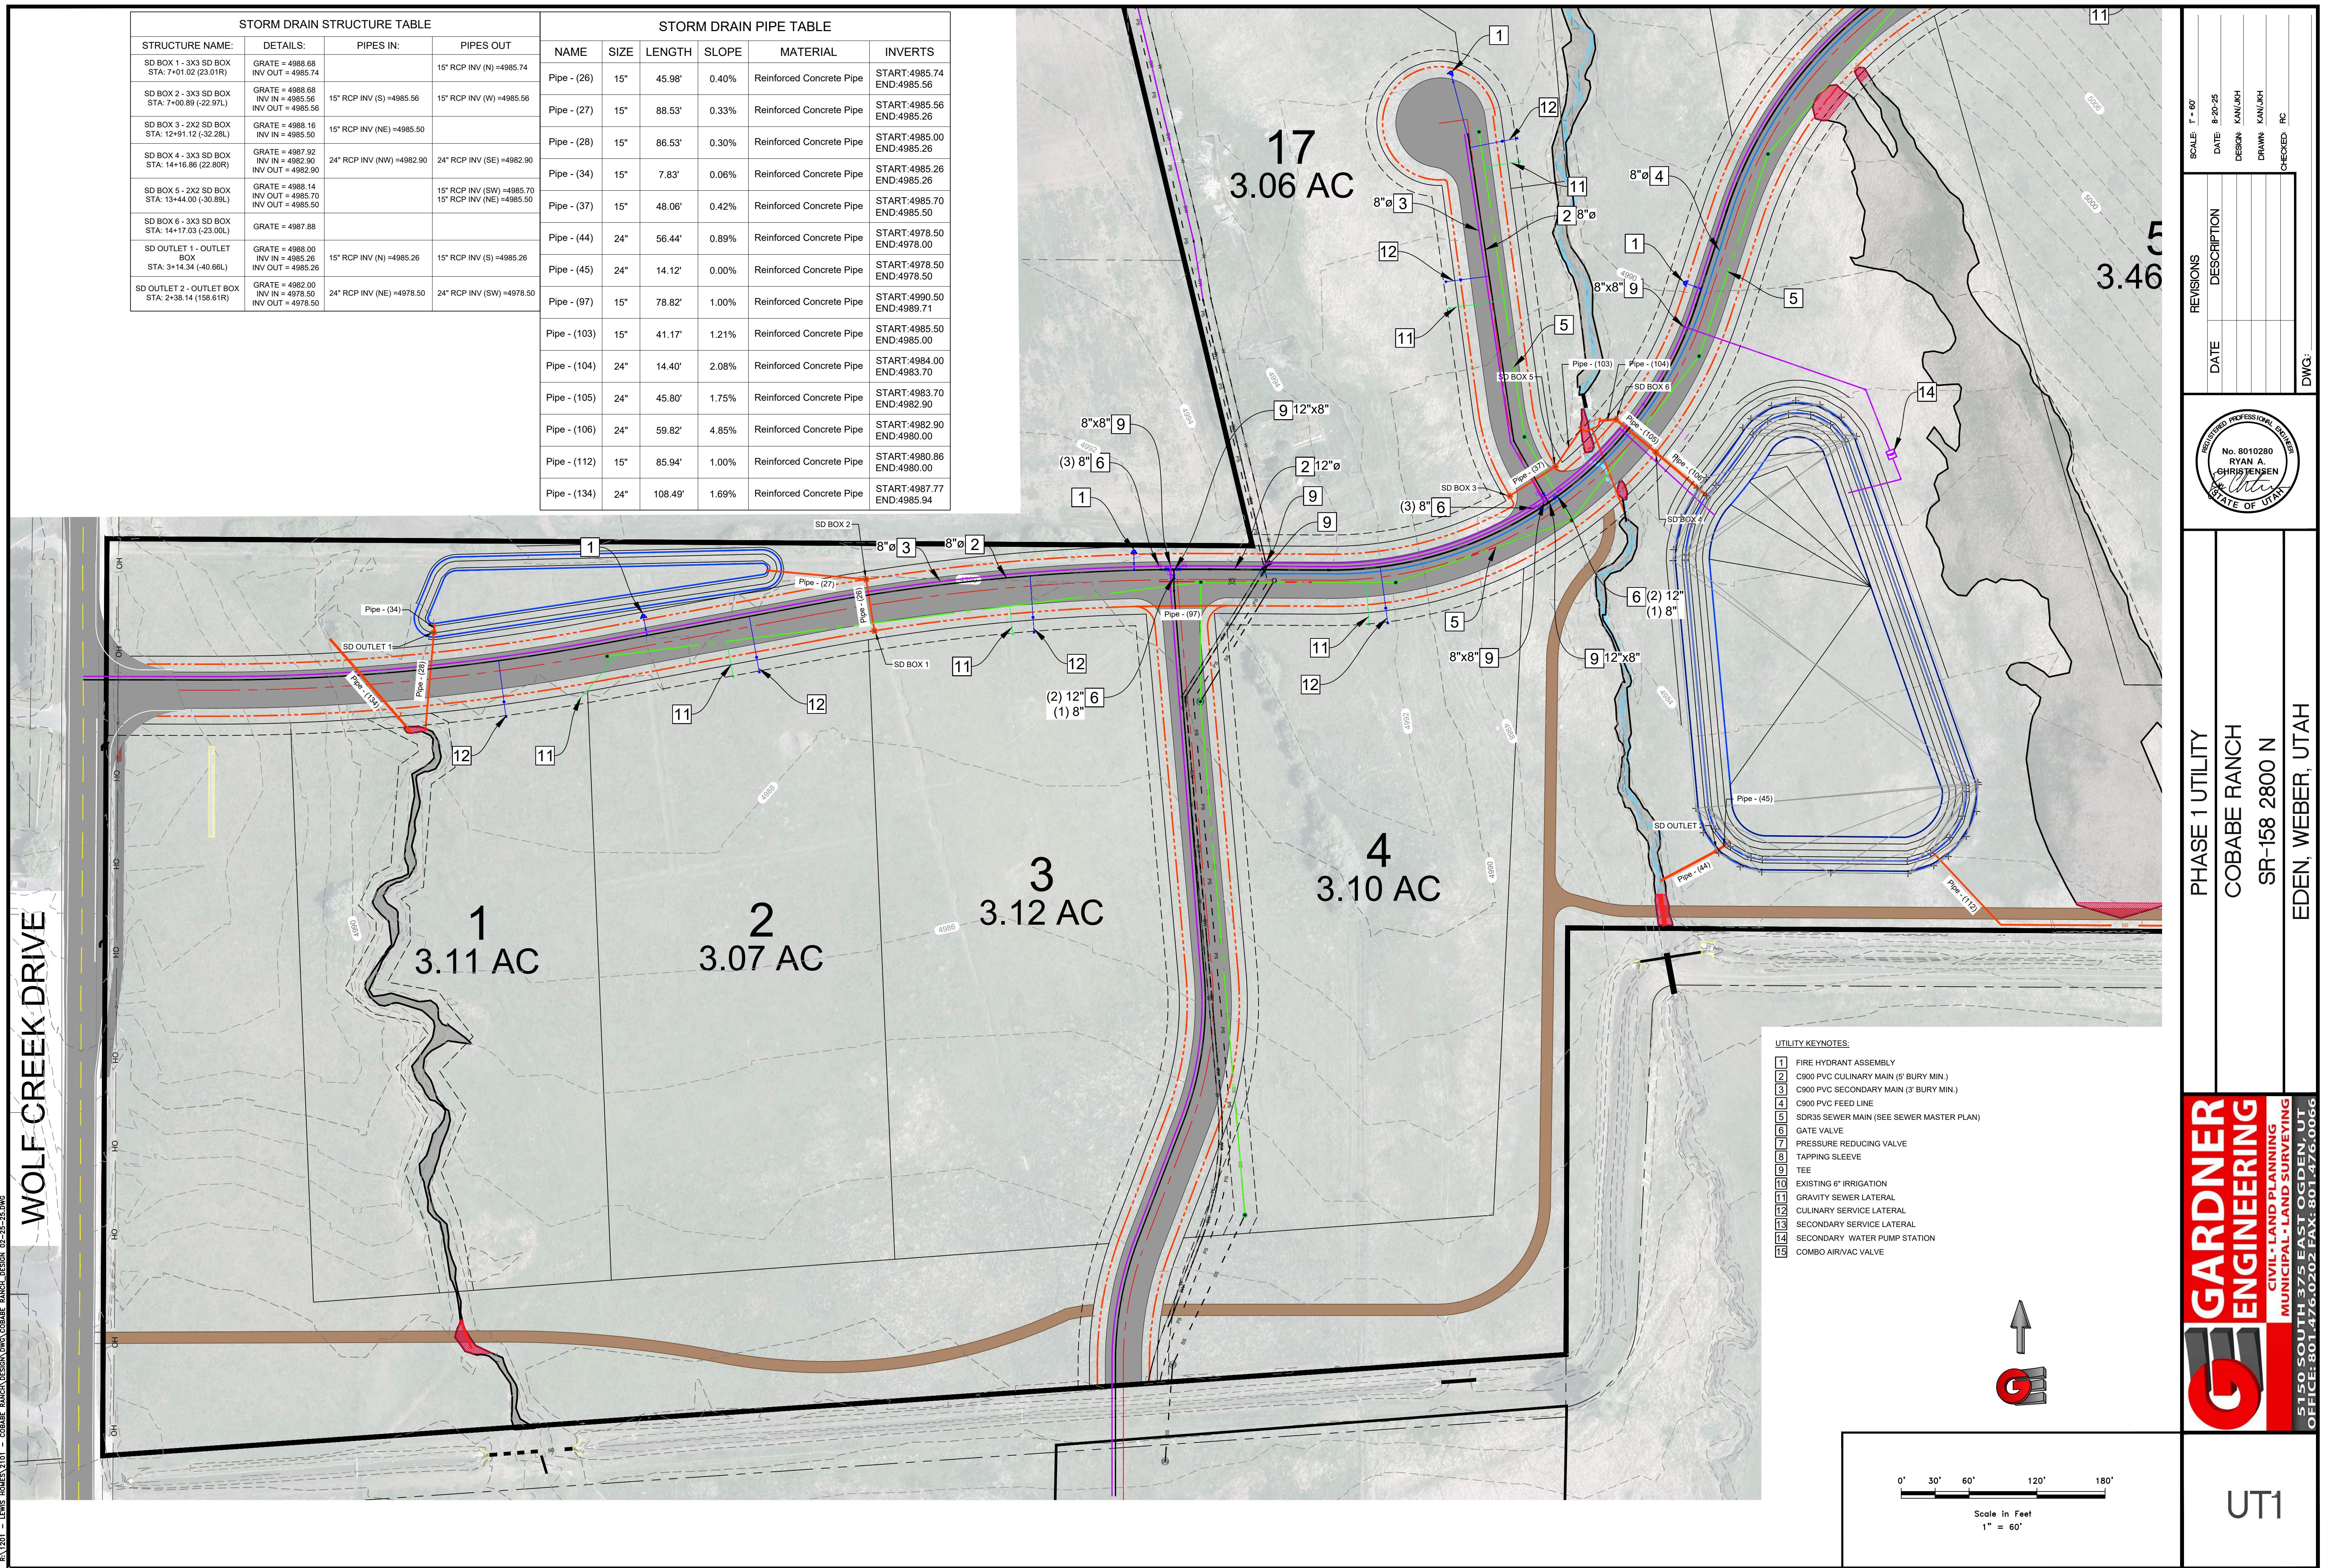

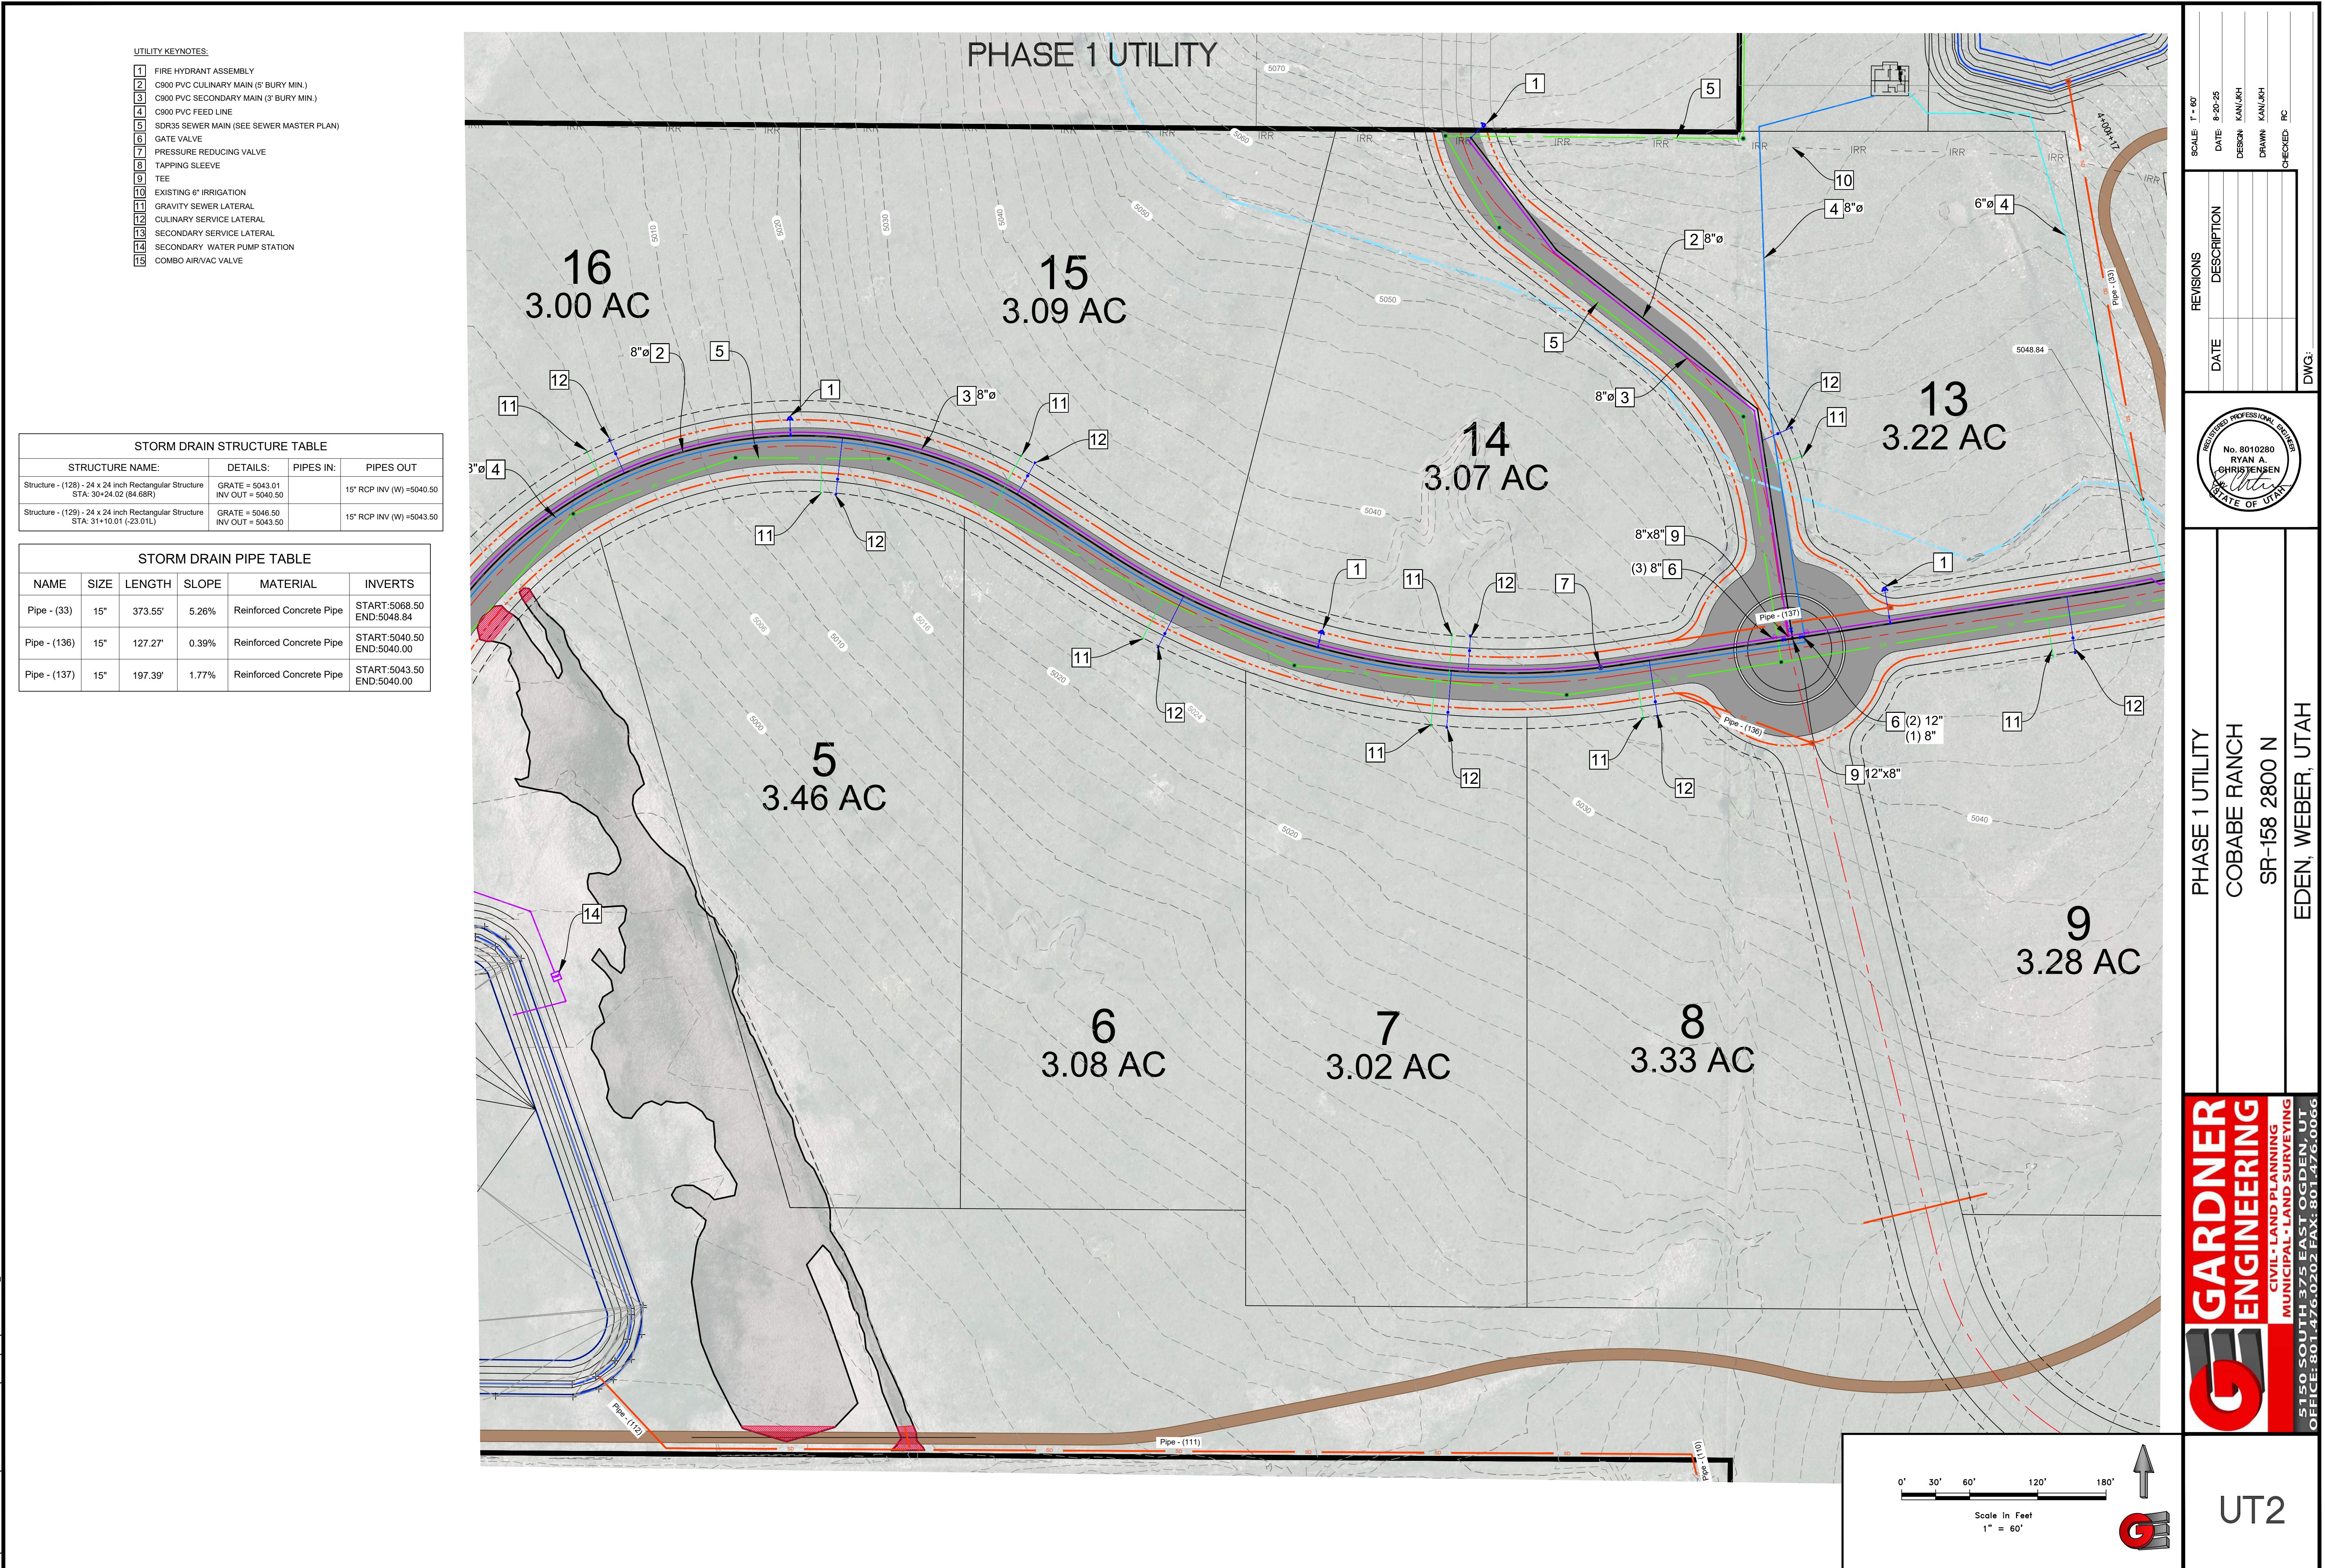UTILITY KEYNOTES:


- 1 FIRE HYDRANT ASSEMBLY
- 2 C900 PVC CULINARY MAIN (5' BURY MIN.)
- 3 C900 PVC SECONDARY MAIN (3' BURY MIN.)
- 4 C900 PVC FEED LINE
- 5 SDR35 SEWER MAIN (SEE SEWER MASTER PLAN)
- 6 GATE VALVE
- 7 PRESSURE REDUCING VALVE
- 8 TAPPING SLEEVE
- 9 TEE
- 10 EXISTING 6" IRRIGATION
- 11 GRAVITY SEWER LATERAL
- 12 CULINARY SERVICE LATERAL
- 13 SECONDARY SERVICE LATERAL
- 14 SECONDARY WATER PUMP STATION
- 15 COMBO AIR/VAC VALVE

STORM DRAIN PIPE TABLE					
NAME	SIZE	LENGTH	SLOPE	MATERIAL	INVERTS
Pipe - (124)	15"	41.72'	1.98%	Reinforced Concrete Pipe	START:5162.97 END:5162.14
Pipe - (125)	15"	40.61'	5.81%	Reinforced Concrete Pipe	START:5231.05 END:5228.69
Pipe - (126)	15"	41.44'	6.35%	Reinforced Concrete Pipe	START:5188.91 END:5186.28
Pipe - (127)	15"	37.72'	10.29%	Reinforced Concrete Pipe	START:5188.87 END:5184.99




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UT4

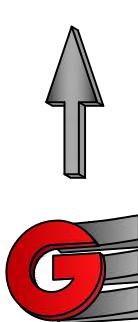

Scale in Feet
1" = 60'

SCALE: 1" = 60'
DATE: 8-20-25
DESIGN: KAN/JKH
DRAWN: KAN/JKH
CHECKED: RC

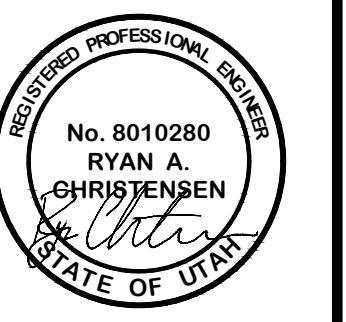

REGISTERED PROFESSIONAL ENGINEER


No. 8010280

RYAN A.

CHRISTENSEN

STATE OF UTAH

PHASE UTILITY
COBABE RANCH
SR-158 2800 N
EDEN, WEBER, UTAH

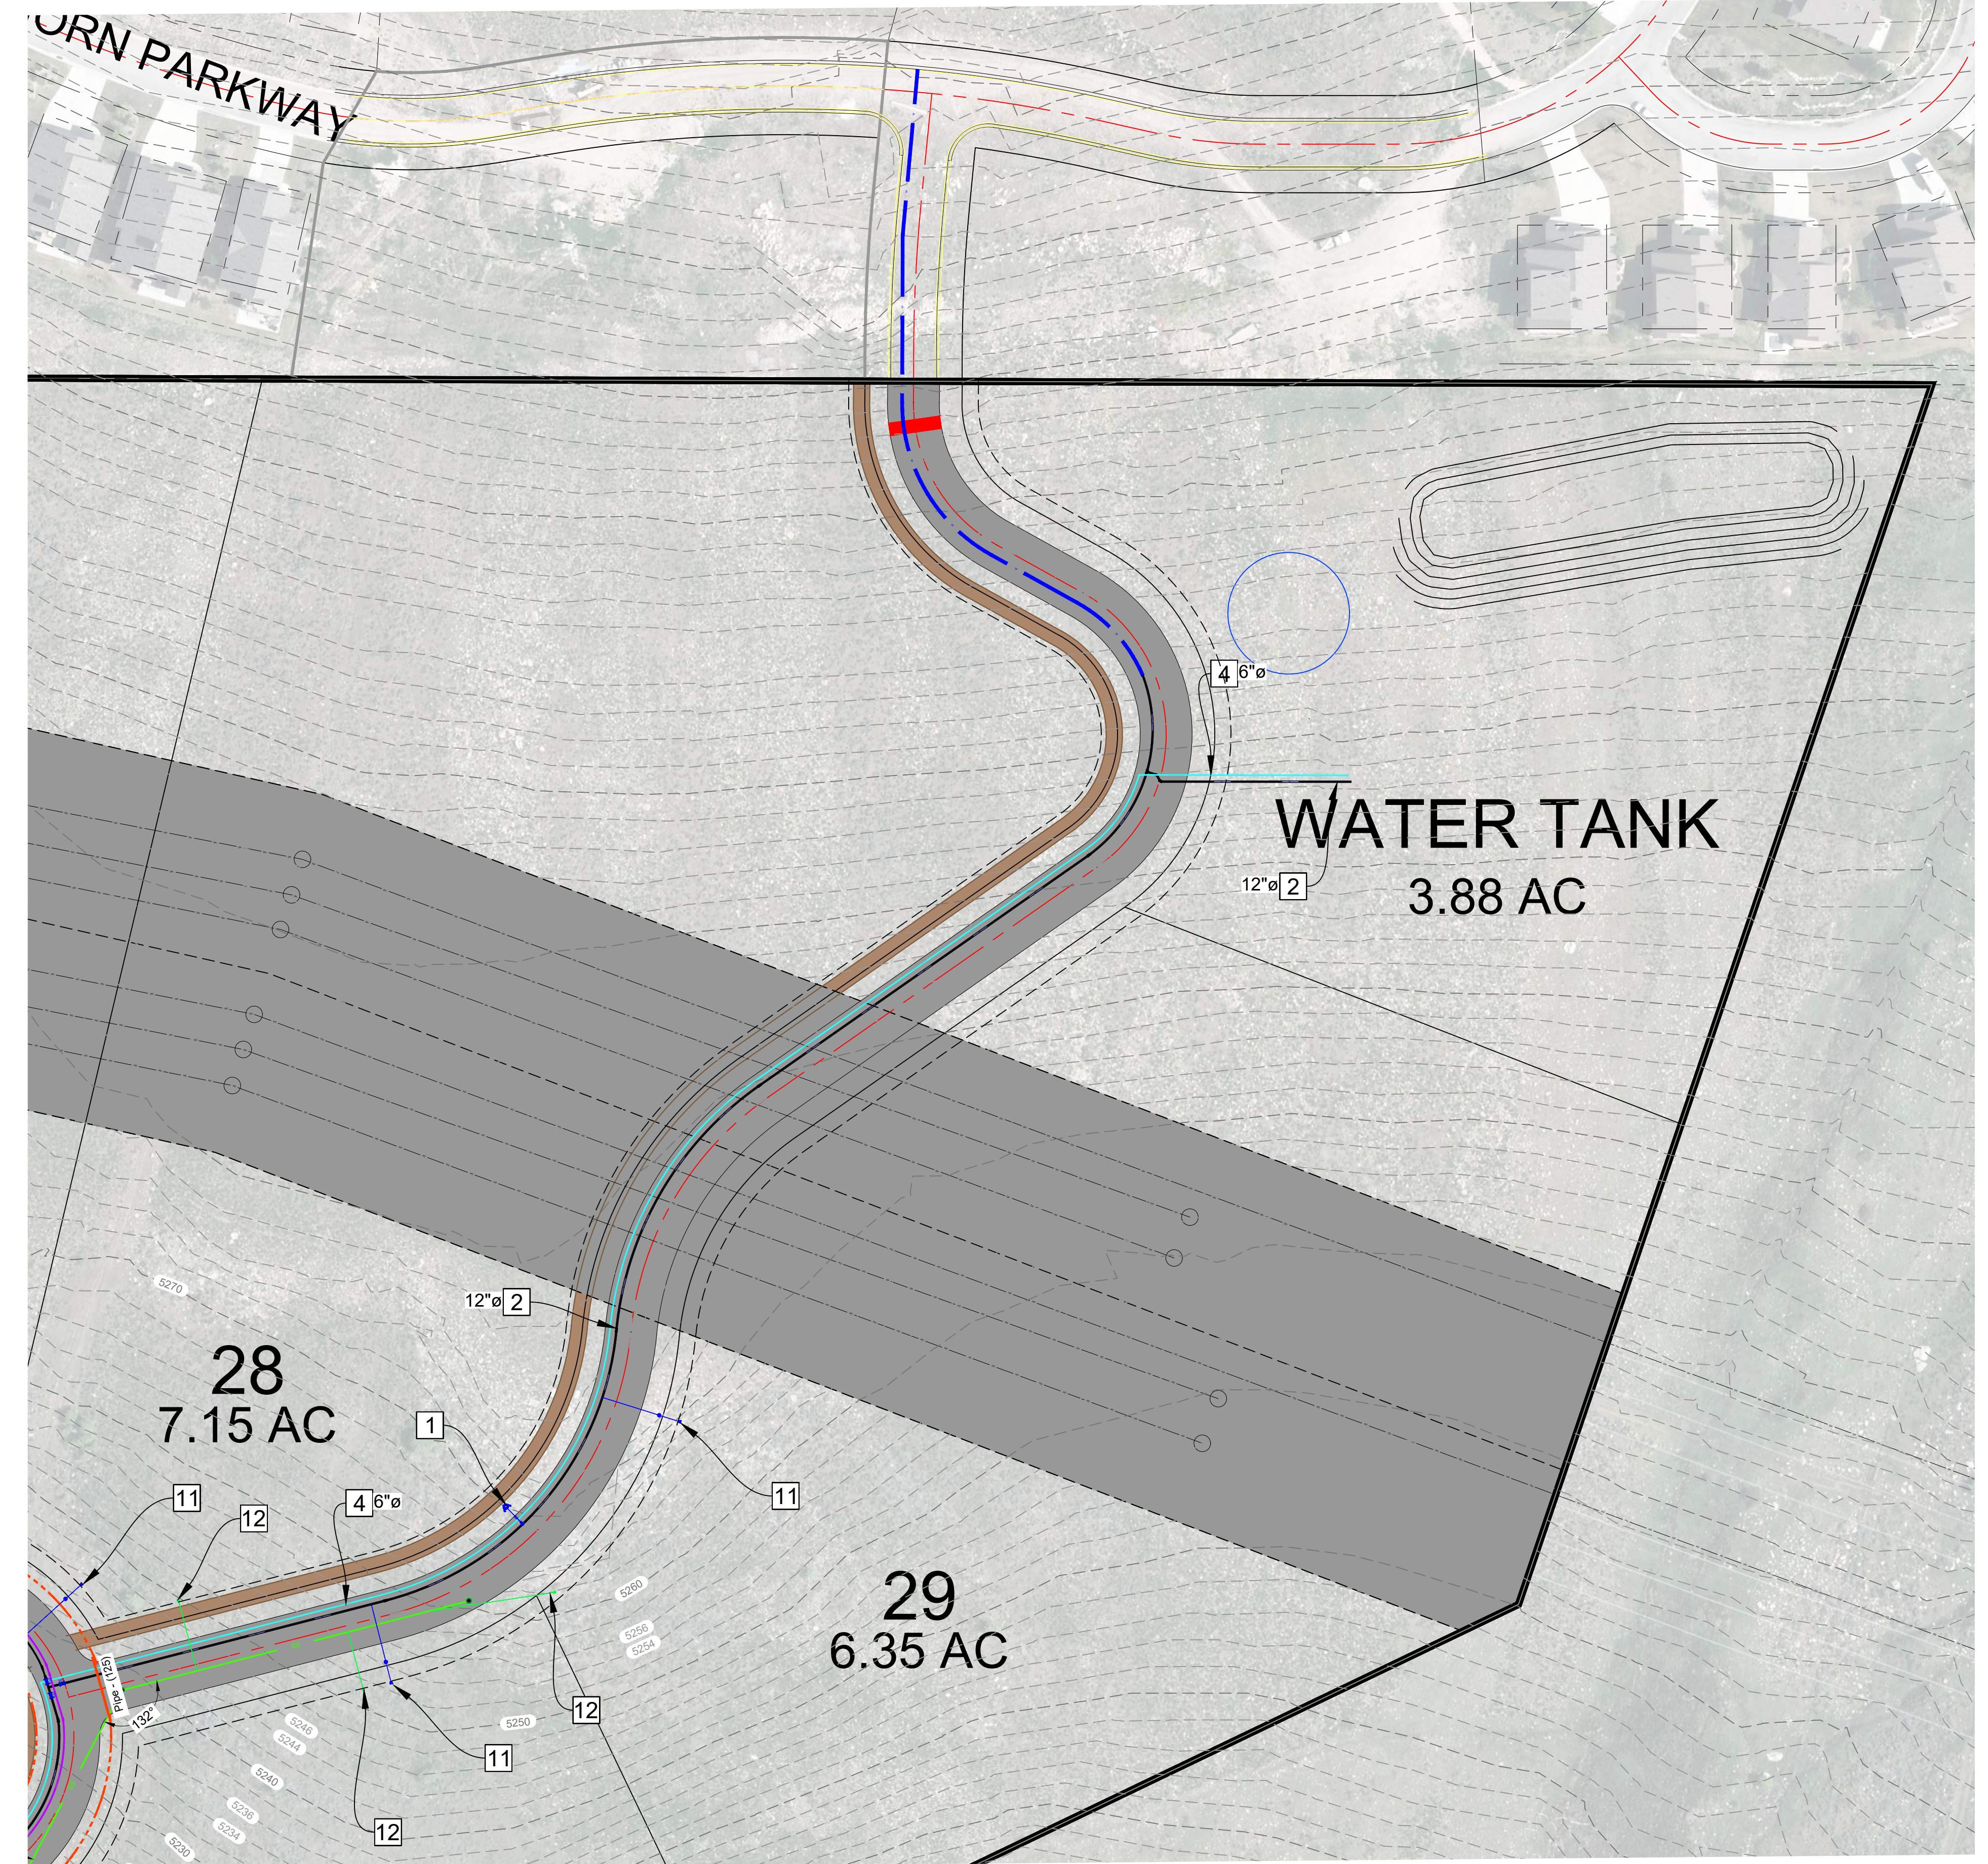


SCALE: 1" = 60'	DATE: 8-20-25
DESIGN: KAN/JKH	DRAWN: KAN/JKH
CHECKED: RC	DWG: DWG: 1

REGISTERED PROFESSIONAL ENGINEER
No. 8010280
RYAN A.
CHRISTENSEN
STATE OF UTAH
[Signature]

PHASE: UTILITY	COBABE RANCH
SR-158 2800 N	EDEN, WEBER, UTAH

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UT5

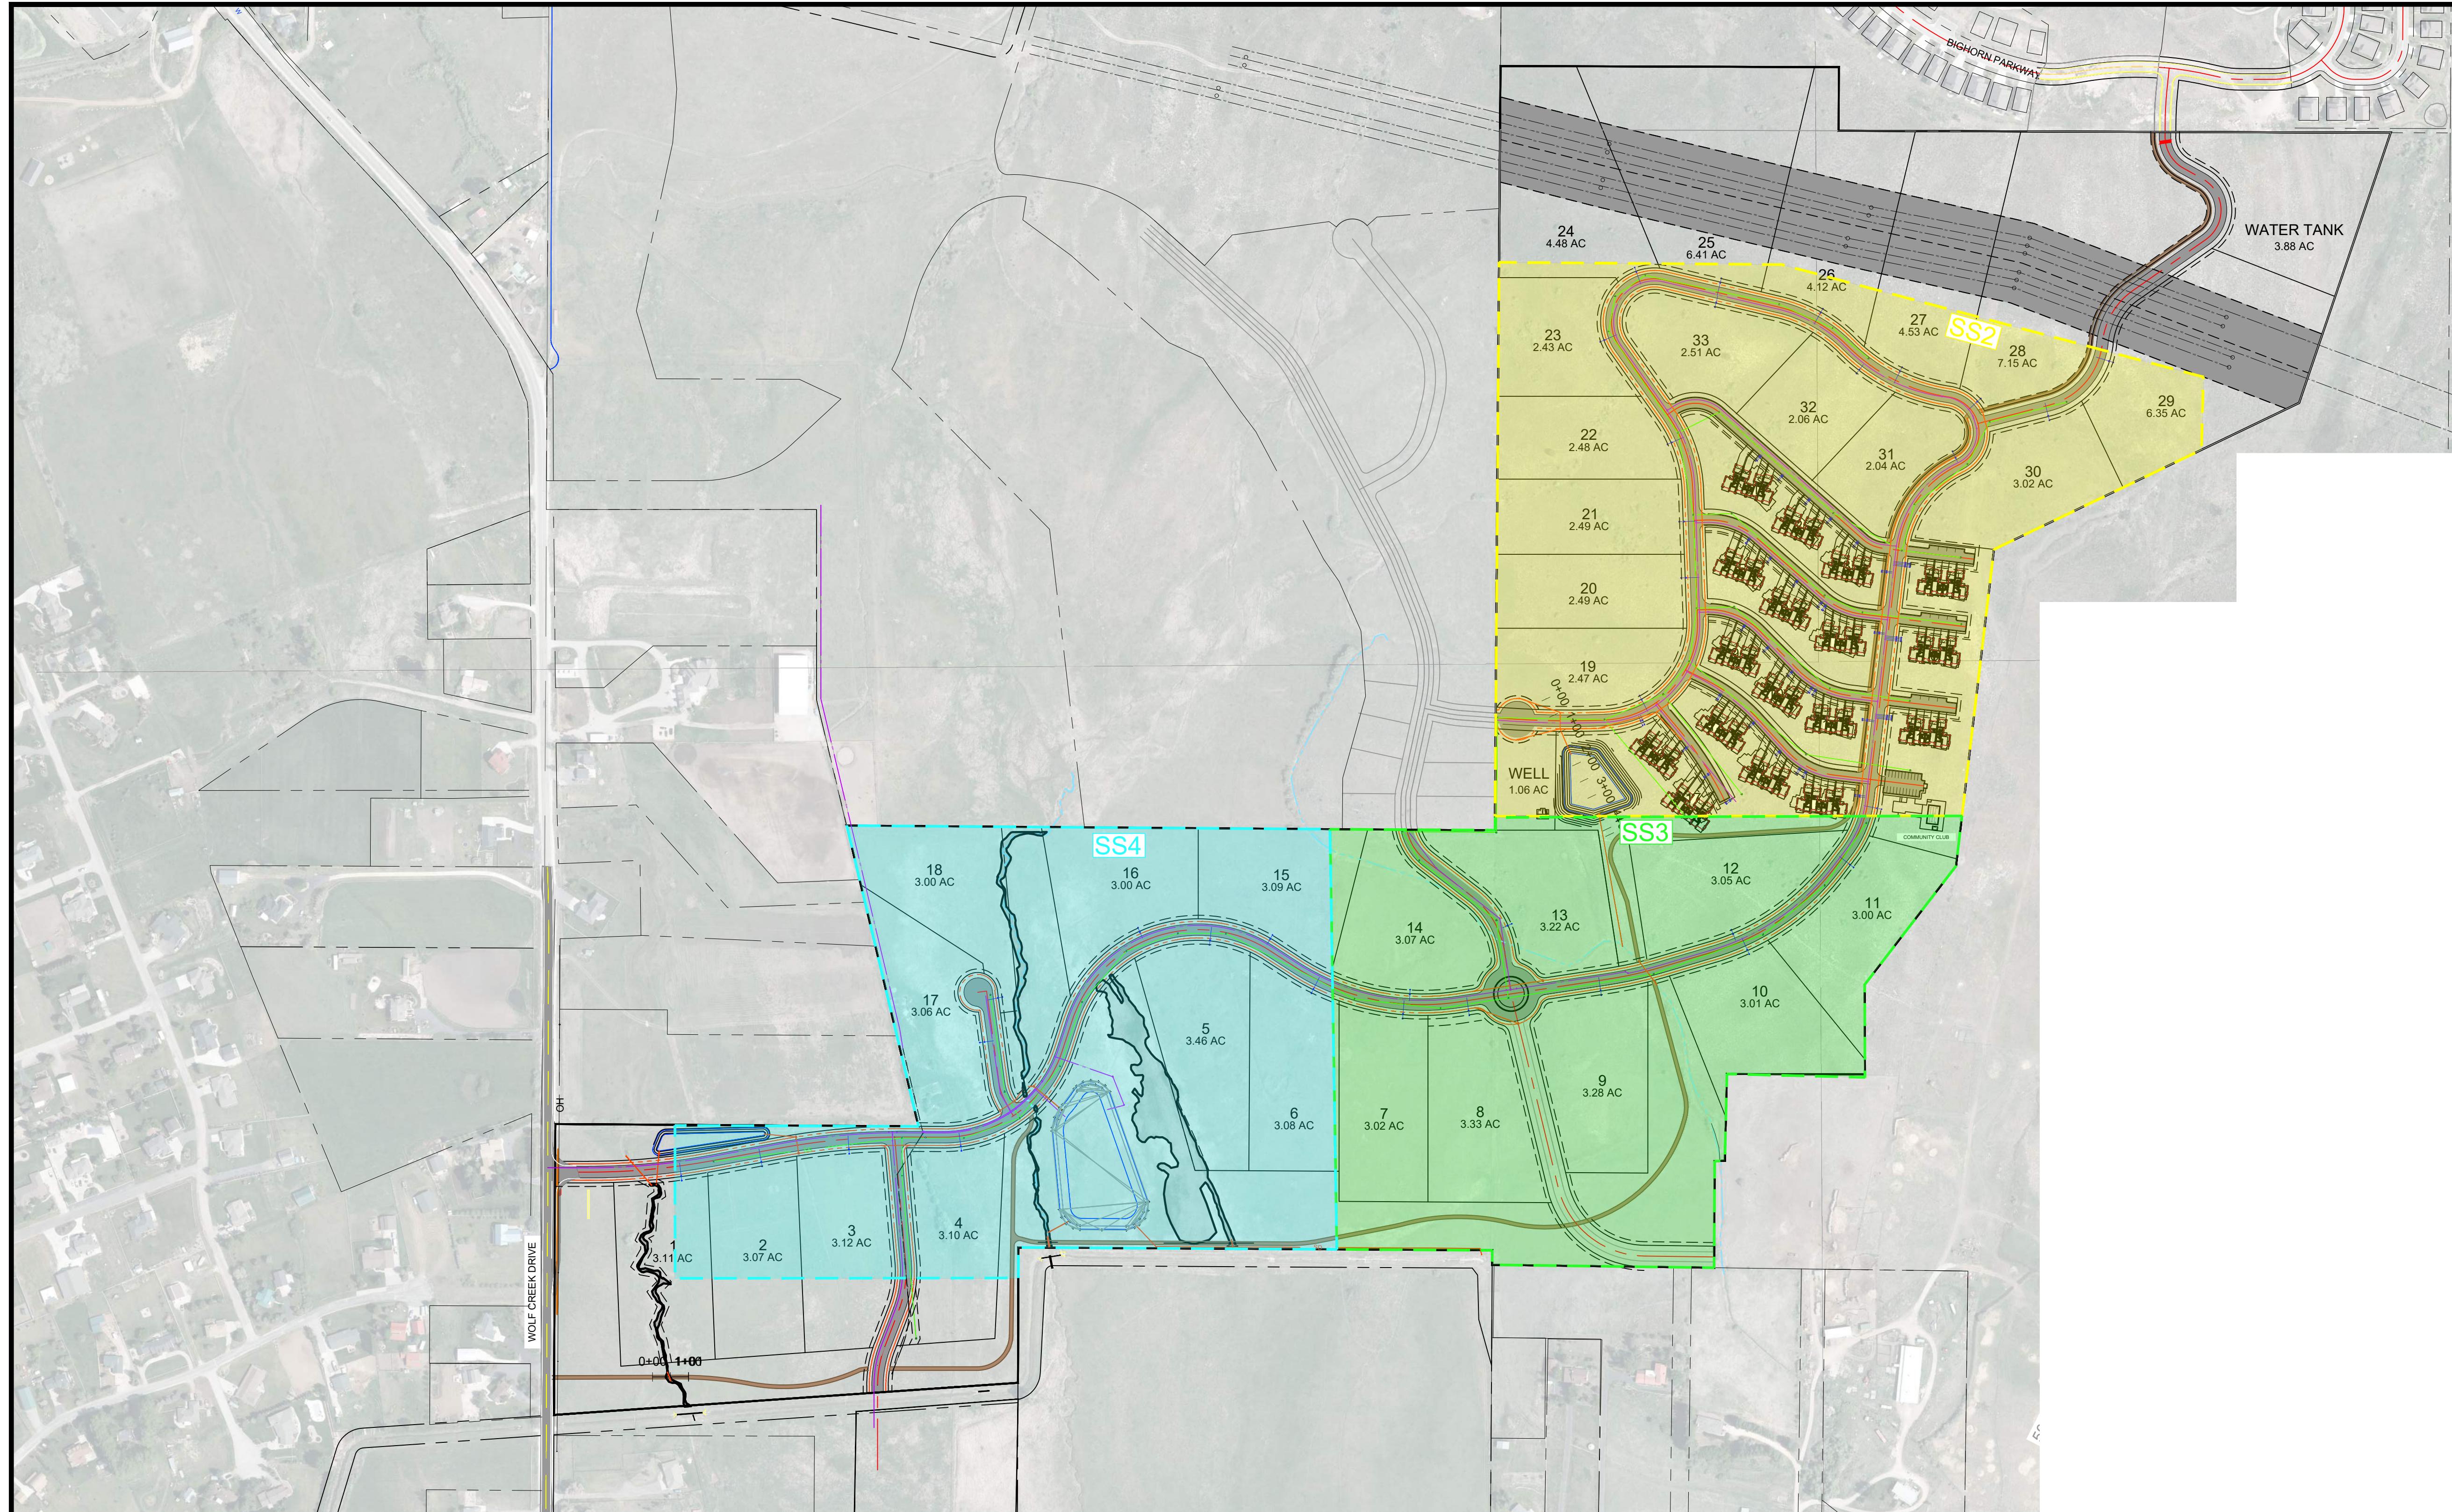


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SEWER MASTER PLAN
COBABE RANCH
SR-158 2800 N
EDEN, WEBER, UTAH


REGISTRED PROFESSIONAL PRACTITIONER
No. 8010280
RYAN A.
CHRISTENSEN
STATE OF UTAH
LUTHER

SCALE: 1" = 250'
DATE: 8-20-25
DESIGN: KANUKH
DRAWN: KANUKH
CHECKED: RC
DWG:



SS1

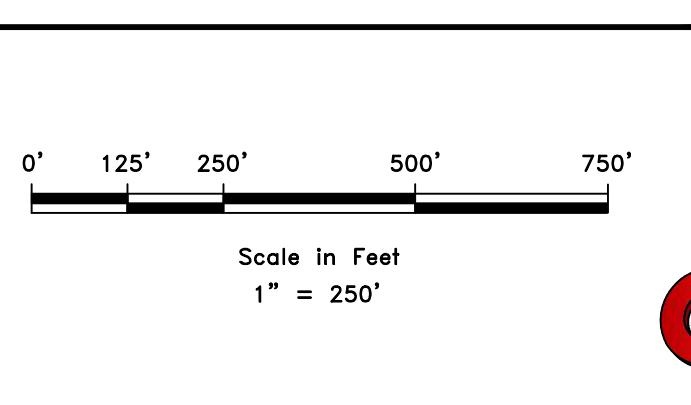

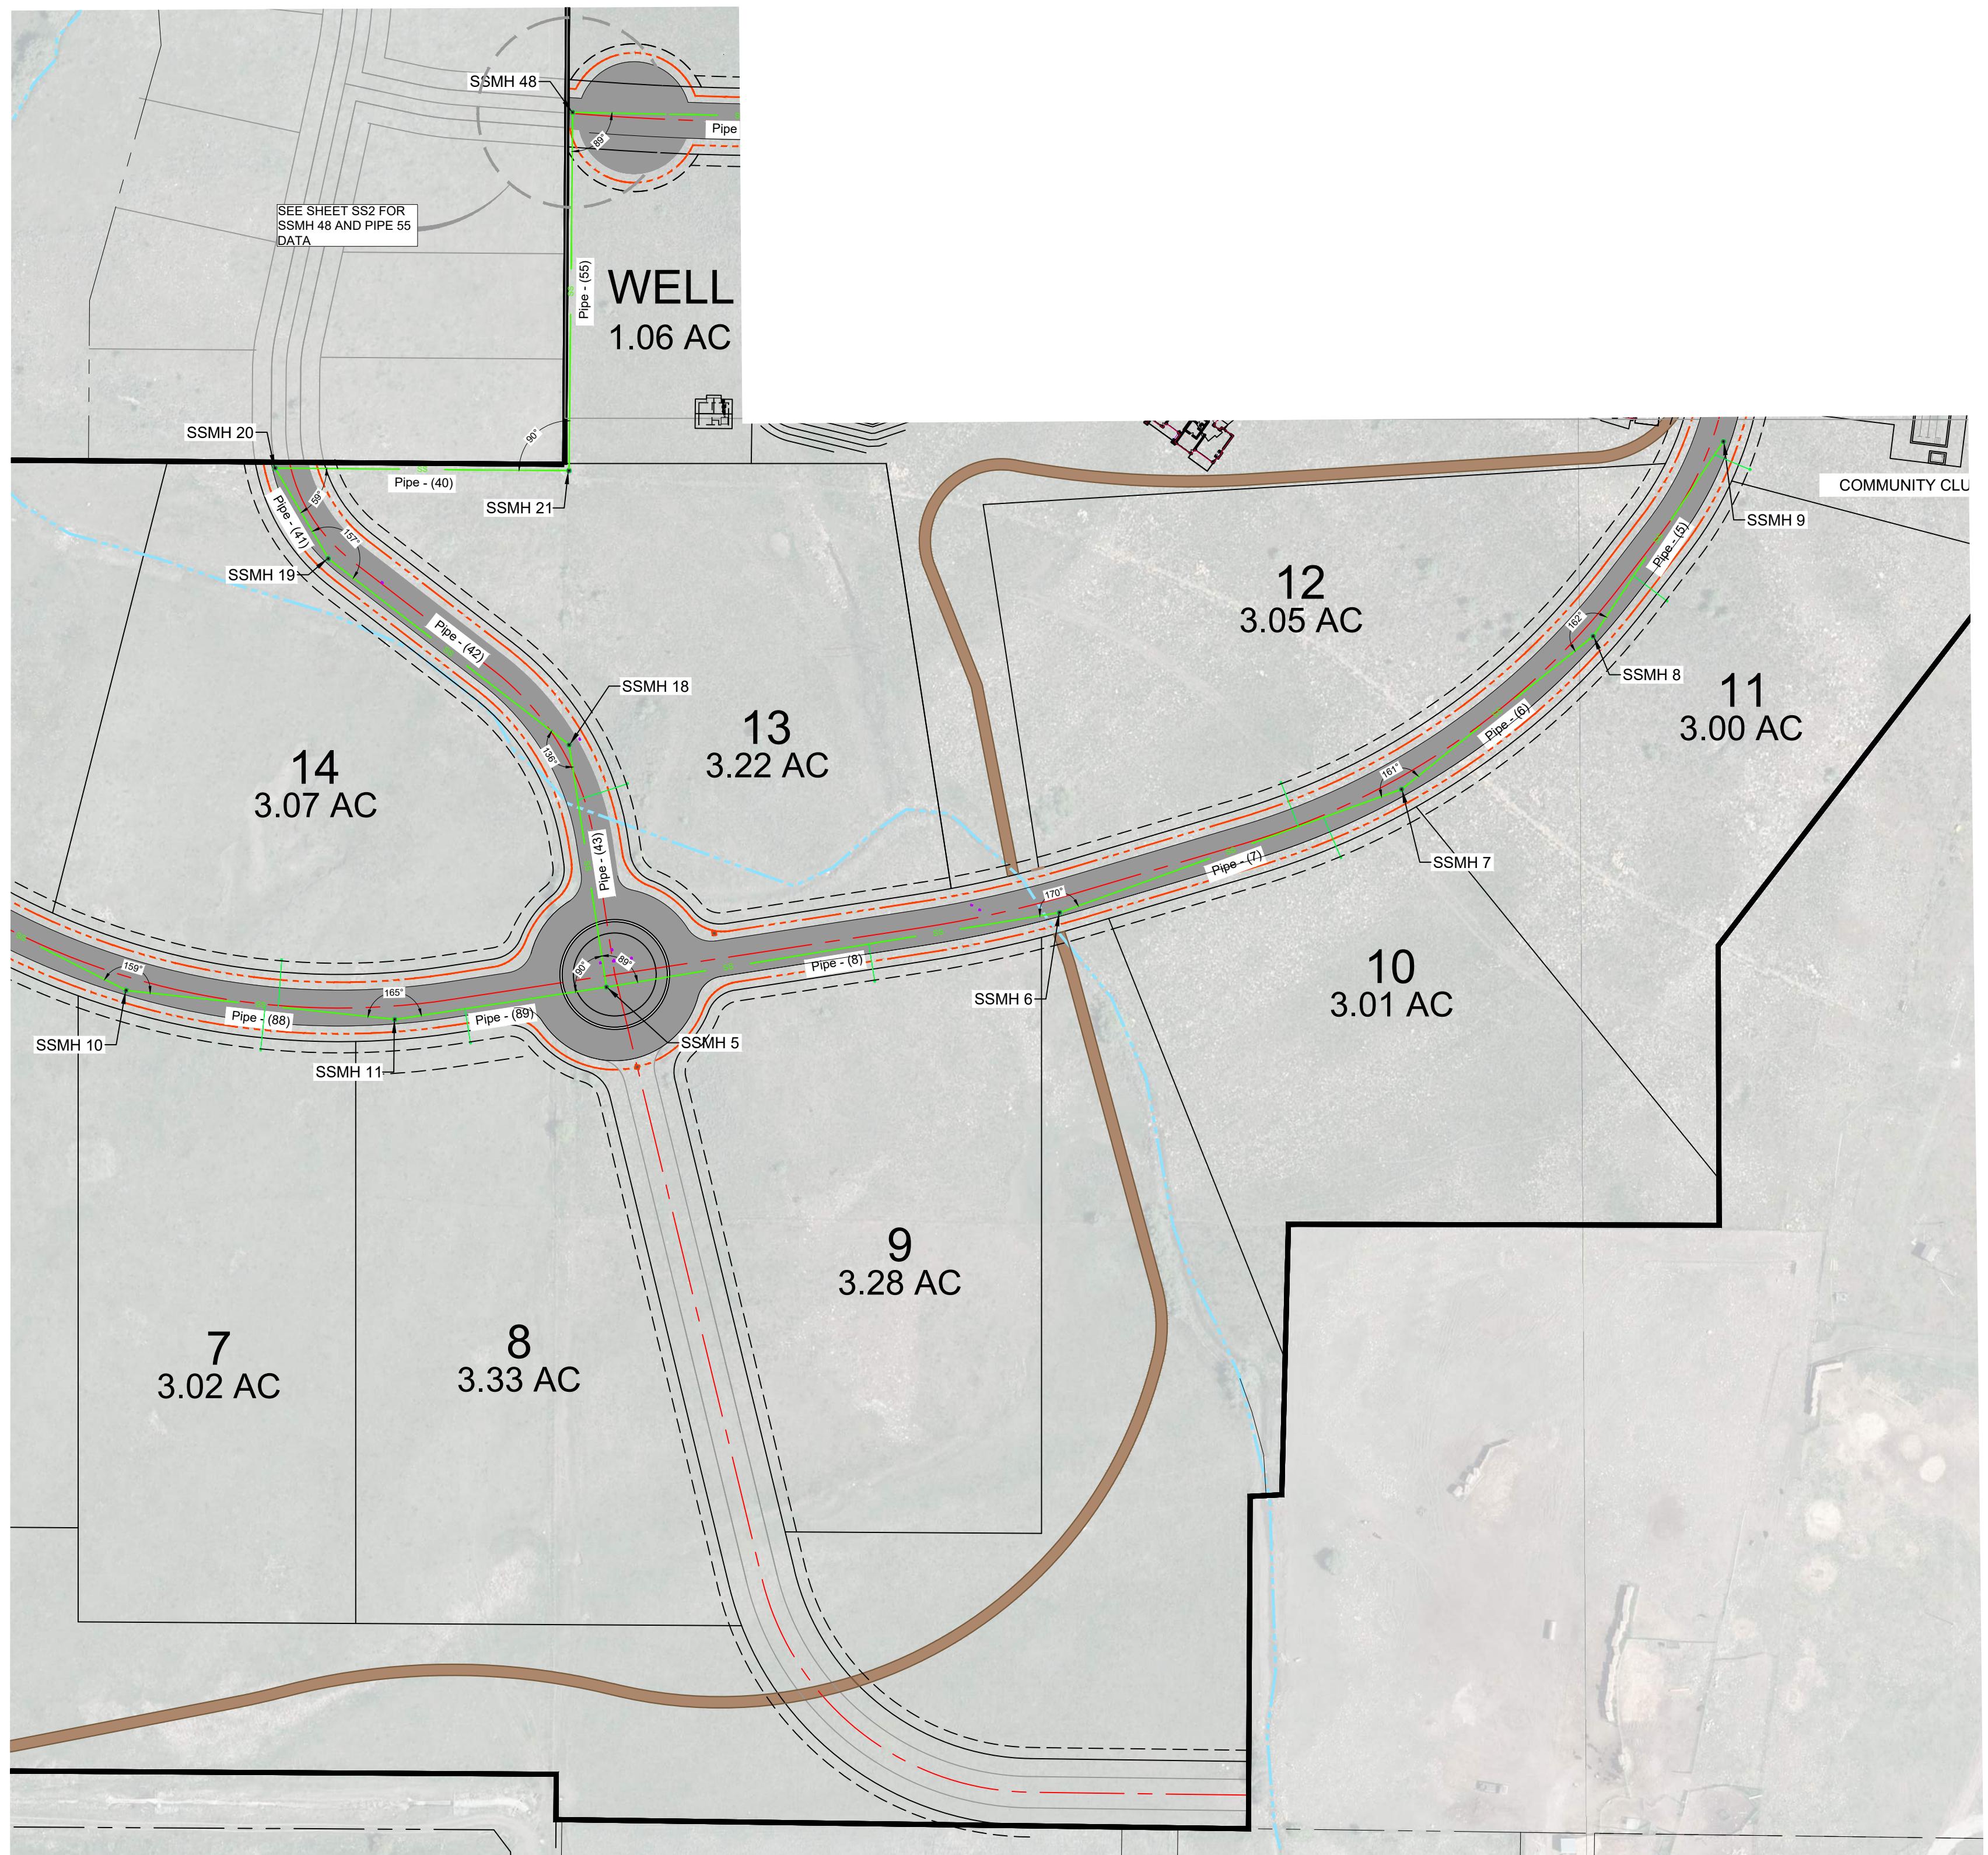

SEWER STRUCTURE TABLE			
STRUCTURE NAME:	DETAILS:	PIPES IN:	PIPES OUT
SSMH 5 5' SSMH	RIM = 5046.00 INV (IN) = 5034.19 INV (N) = 5034.19 INV OUT = 5034.09	INV (E) = 5034.19 INV (N) = 5034.19	INV (W) = 5034.09
SSMH 6 4' SSMH	RIM = 5054.65 INV (IN) = 5040.76 INV OUT = 5040.66	INV (E) = 5040.76	INV (W) = 5040.66
SSMH 7 4' SSMH	RIM = 5056.59 INV (IN) = 5075.33 INV OUT = 5075.23	INV (NE) = 5075.33	INV (W) = 5075.23
SSMH 8 4' SSMH	RIM = 5108.21 INV (IN) = 5098.21 INV OUT = 5098.11	INV (NE) = 5098.21	INV (SW) = 5098.11
SSMH 9 4' SSMH	RIM = 5125.28 INV OUT = 5115.18		INV (SW) = 5115.18
SSMH 10 4' SSMH	RIM = 5031.42 INV (IN) = 5019.42 INV OUT = 5019.32	INV (E) = 5019.42	INV (NW) = 5019.32
SSMH 11 4' SSMH	RIM = 5034.16 INV (IN) = 5023.83 INV OUT = 5023.73	INV (E) = 5023.83	INV (W) = 5023.73
SSMH 12 4' SSMH	RIM = 5052.54 INV (IN) = 5043.97 INV OUT = 5043.87	INV (NW) = 5043.97	INV (S) = 5043.87
SSMH 13 4' SSMH	RIM = 5062.93 INV (IN) = 5048.73 INV OUT = 5048.63	INV (NW) = 5048.73	INV (SE) = 5048.63
SSMH 14 5' SSMH	RIM = 5059.64 INV (IN) = 5058.55 INV OUT = 5058.45	INV (E) = 5058.55	INV (SE) = 5058.45
SSMH 15 5' SSMH	RIM = 5059.84 INV (IN) = 5059.70 INV OUT = 5059.60	INV (N) = 5059.70	INV (W) = 5059.60

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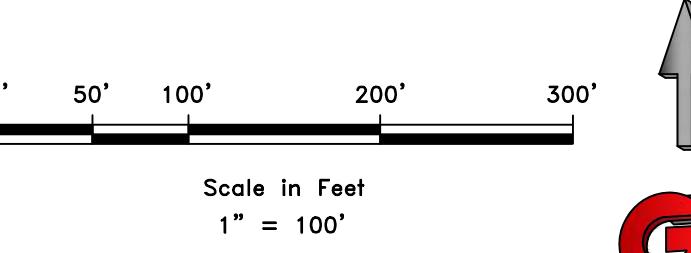
SEWER MASTER PLAN
COBABE RANCH
SR-158 2800 N
EDEN, UTAH

DATE	DESCRIPTION
DATE	

REVISIONS

DWG:

REGISTERED PROFESSIONAL PRACTITIONER
No. 8010280 RYAN A. CHRISTENSEN
STATE OF UTAH



SS3



SEWER STRUCTURE TABLE		SEWER PIPE TABLE	
STRUCTURE NAME:	DETAILS:	PIPES IN:	PIPES OUT
EX SSMH 3 EX SSMH	RIM = 4994.36		
REPLACE EX SSMH 2 EX SSMH	RIM = 4990.32 INV IN = 4977.36 INV OUT = 4982.67 INV OUT = 4977.26	INV (N) = 4977.36	INV (S) = 4982.67 INV (S) = 4977.26
SSMH 1 5' SSMH	RIM = 4997.37 INV IN = 4980.45 INV IN = 4980.45 INV OUT = 4980.35	INV (NE) = 4980.45 INV (NW) = 4980.45	INV (W) = 4980.35
SSMH 2 4' SSMH	RIM = 4999.99 INV IN = 4981.47 INV OUT = 4981.37	INV (N) = 4981.47	INV (SW) = 4981.37
SSMH 3 4' SSMH	RIM = 4999.97 INV IN = 4987.95 INV OUT = 4987.85	INV (E) = 4987.95	INV (SW) = 4987.85
SSMH 4 4' SSMH	RIM = 5020.85 INV IN = 5008.85 INV OUT = 5008.75	INV (SE) = 5008.85	INV (W) = 5008.75
SSMH 10 4' SSMH	RIM = 5031.42 INV IN = 5019.42 INV OUT = 5019.32	INV (E) = 5019.42	INV (NW) = 5019.32
SSMH 14 4' SSMH	RIM = 4992.62 INV IN = 4979.53 INV OUT = 4979.43	INV (E) = 4979.53	INV (W) = 4979.43
SSMH 16 4' SSMH	RIM = 4995.00 INV OUT = 4985.13	INV (S) = 4985.13	
SSMH 17 4' SSMH	RIM = 4989.83 INV IN = 4981.13 INV OUT = 4981.03	INV (N) = 4981.13	INV (SE) = 4981.03
SSMH 52 4' SSMH	RIM = 4991.18 INV OUT = 4980.75	INV (E) = 4980.75	
SSMH 53 5' SSMH	RIM = 4993.57 INV IN = 4978.98 INV IN = 4978.39 INV OUT = 4978.29	INV (W) = 4978.39 INV (E) = 4978.39	INV (S) = 4978.29

SEWER MASTER PLAN
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SS4




SCALE: 1" = 100'	DATE: 8-20-25
DESIGN: KANUKH	DRAWN: KANUKH
CHECKED: RC	DWG:

REGISTERED PROFESSIONAL PRACTICE
No. 8010280
RYAN A.
CHRISTENSEN
STATE OF UTAH

EROSION CONTROL NOTES:

1. SANDBAGS WILL BE PLACED AT DISCHARGE LOCATIONS TO CONTAIN AND DIVERT STORM WATER THROUGH THE INLET PROTECTION.
2. AN EARTHEN BERM 6" HIGH WILL BE CONSTRUCTED TO CONTAIN THE STORM WATER AND DIVERT IT TO DISCHARGE AREAS.
3. STORM WATER WILL BE DISCHARGED INTO AN EXISTING DRAINAGE SYSTEM. EXISTING LINES SHALL BE INSPECTED PRIOR TO CERTIFICATE OF OCCUPANCY AND CLEANED IF NECESSARY.
4. THE STORM WATER POLLUTION PREVENTION PLAN SHALL CONFORM TO ALL STATE DIVISION OF ENVIRONMENTAL PROTECTION REGULATIONS.

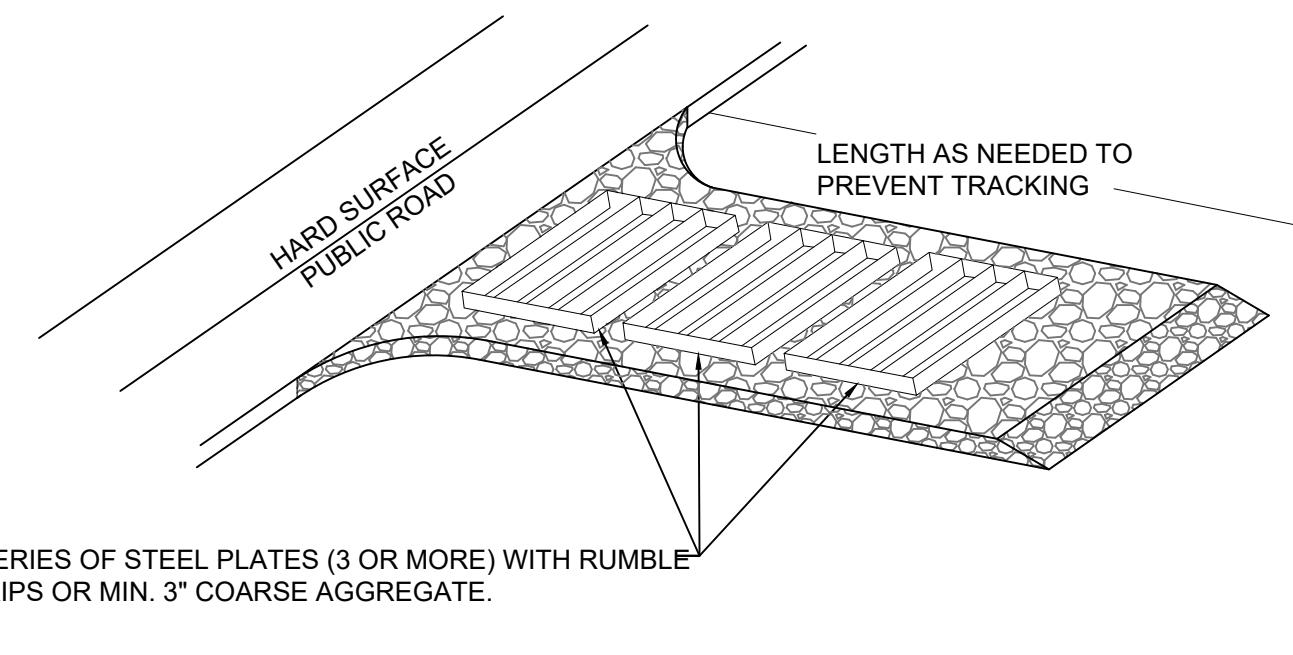


ENTRANCE STABILIZATION NOTES:

1. SEDIMENTS AND OTHER MATERIALS SHALL NOT BE TRACKED FROM THE SITE BY VEHICLE TRAFFIC. THE CONSTRUCTION ENTRANCE ROADWAYS SHALL BE STABILIZED SO AS TO PREVENT SEDIMENTS FROM BEING DEPOSITED INTO THE STORM DRAIN SYSTEMS. DEPOSITIONS MUST BE SWEEP UP IMMEDIATELY AND MAY NOT BE WASHED DOWN BY RAIN OR OTHER MEANS INTO THE STORM DRAIN SYSTEM.
2. STABILIZED CONSTRUCTION ENTRANCE SHALL BE:
 - a. LOCATED AT ANY POINT WHERE TRAFFIC WILL BE ENTERING OR LEAVING A CONSTRUCTION SITE TO OR FROM A PUBLIC RIGHT-OF-WAY, STREET, ALLEY AND SIDEWALK OR PARKING AREA.
 - b. A SERIES OF STEEL PLATES WITH "RUMBLE STRIPS", AND/OR MIN. 3" COARSE AGGREGATE WITH LENGTH, WIDTH AND THICKNESS AS NEEDED TO ADEQUATELY PREVENT ANY TRACKING ONTO PAVED SURFACES.
3. ADDING A WASH RACK WITH A SEDIMENT TRAP LARGE ENOUGH TO COLLECT ALL WASH WATER CAN GREATLY IMPROVE EFFICIENCY.
4. ALL VEHICLES ACCESSING THE CONSTRUCTION SITE SHALL UTILIZE THE STABILIZED CONSTRUCTION ENTRANCE SITES.


STREET MAINTENANCE NOTES:

1. REMOVE ALL SEDIMENT DEPOSITED ON PAVED ROADWAYS IMMEDIATELY.
2. SWEEP PAVED AREAS THAT RECEIVE CONSTRUCTION TRAFFIC WHENEVER SEDIMENT BECOMES VISIBLE.
3. PAVEMENT WASHING WITH WATER IS PROHIBITED IF IT RESULTS IN A DISCHARGE TO THE STORM DRAIN SYSTEM.

NOTE:
CONTRACTOR SHALL COMPLETE AND SUBMIT A STATE NOTICE OF INTENT (NOI) AND A STORM WATER POLLUTION PLAN BOOKLET

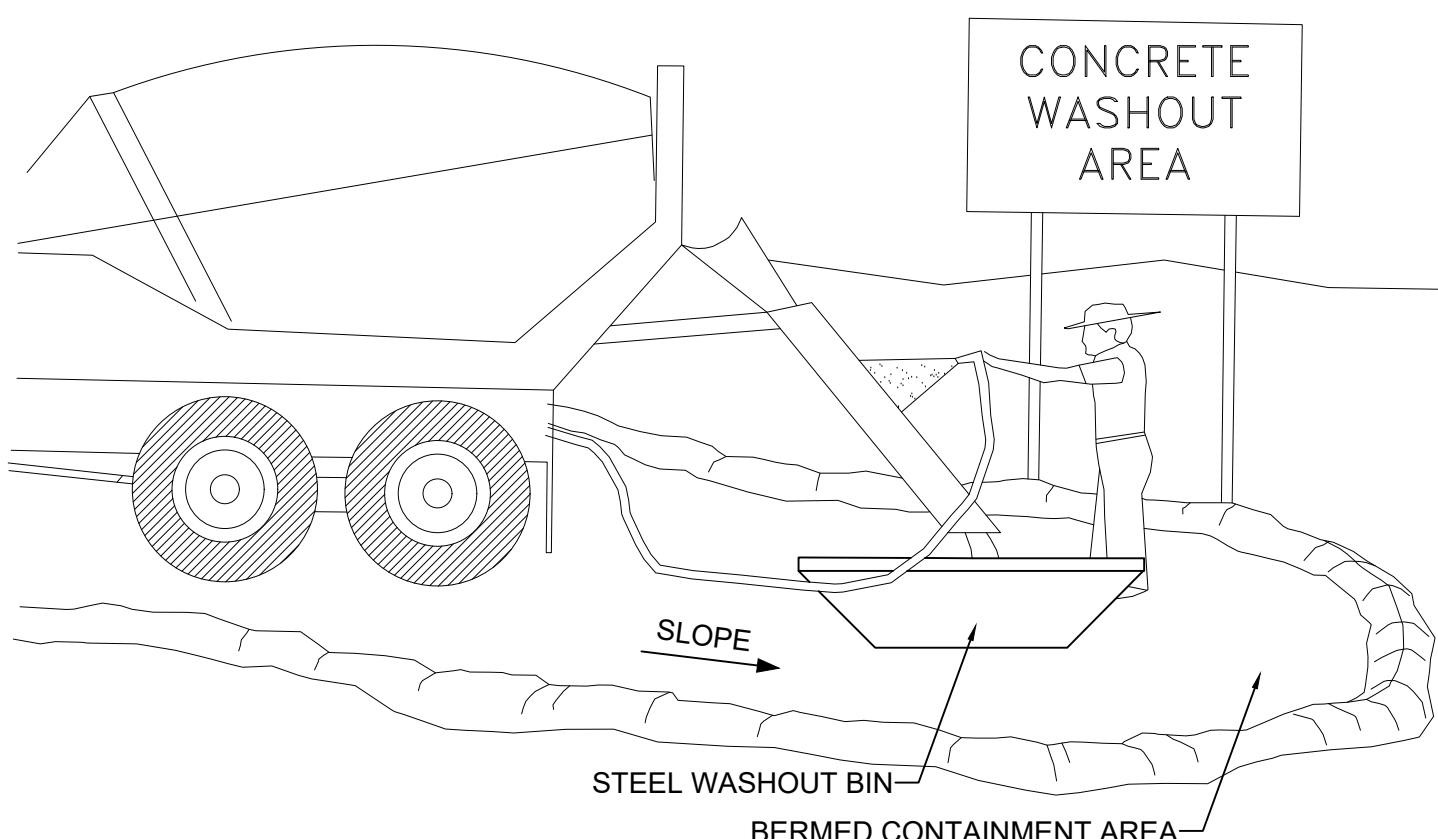


- NOTES:**
1. EXCESS AND WASTE CONCRETE SHALL BE DISPOSED OF OFF SITE OR AT DESIGNATED AREAS ONLY.
 2. EXCESS AND WASTE CONCRETE SHALL NOT BE WASHED INTO THE STREET OR INTO A DRAINAGE SYSTEM.
 3. FOR WASHOUT OF CONCRETE AND MORTAR PRODUCTS ONSITE, A DESIGNATED CONTAINMENT FACILITY OF SUFFICIENT CAPACITY TO RETAIN LIQUID AND SOLID WASTE SHALL BE PROVIDED.
 4. ONSITE CONCRETE WASHOUT CONTAINMENT FACILITY SHALL BE A STEEL BIN OR APPROVED ALTERNATE.
 5. SLURRY FROM CONCRETE AND ASPHALT SAW CUTTING SHALL BE VACUUMED OR CONTAINED, DRIED, PICKED UP AND DISPOSED OF PROPERLY.

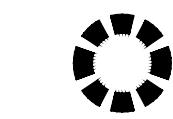

INLET PROTECTION
(EITHER OPTION)




SILT FENCE

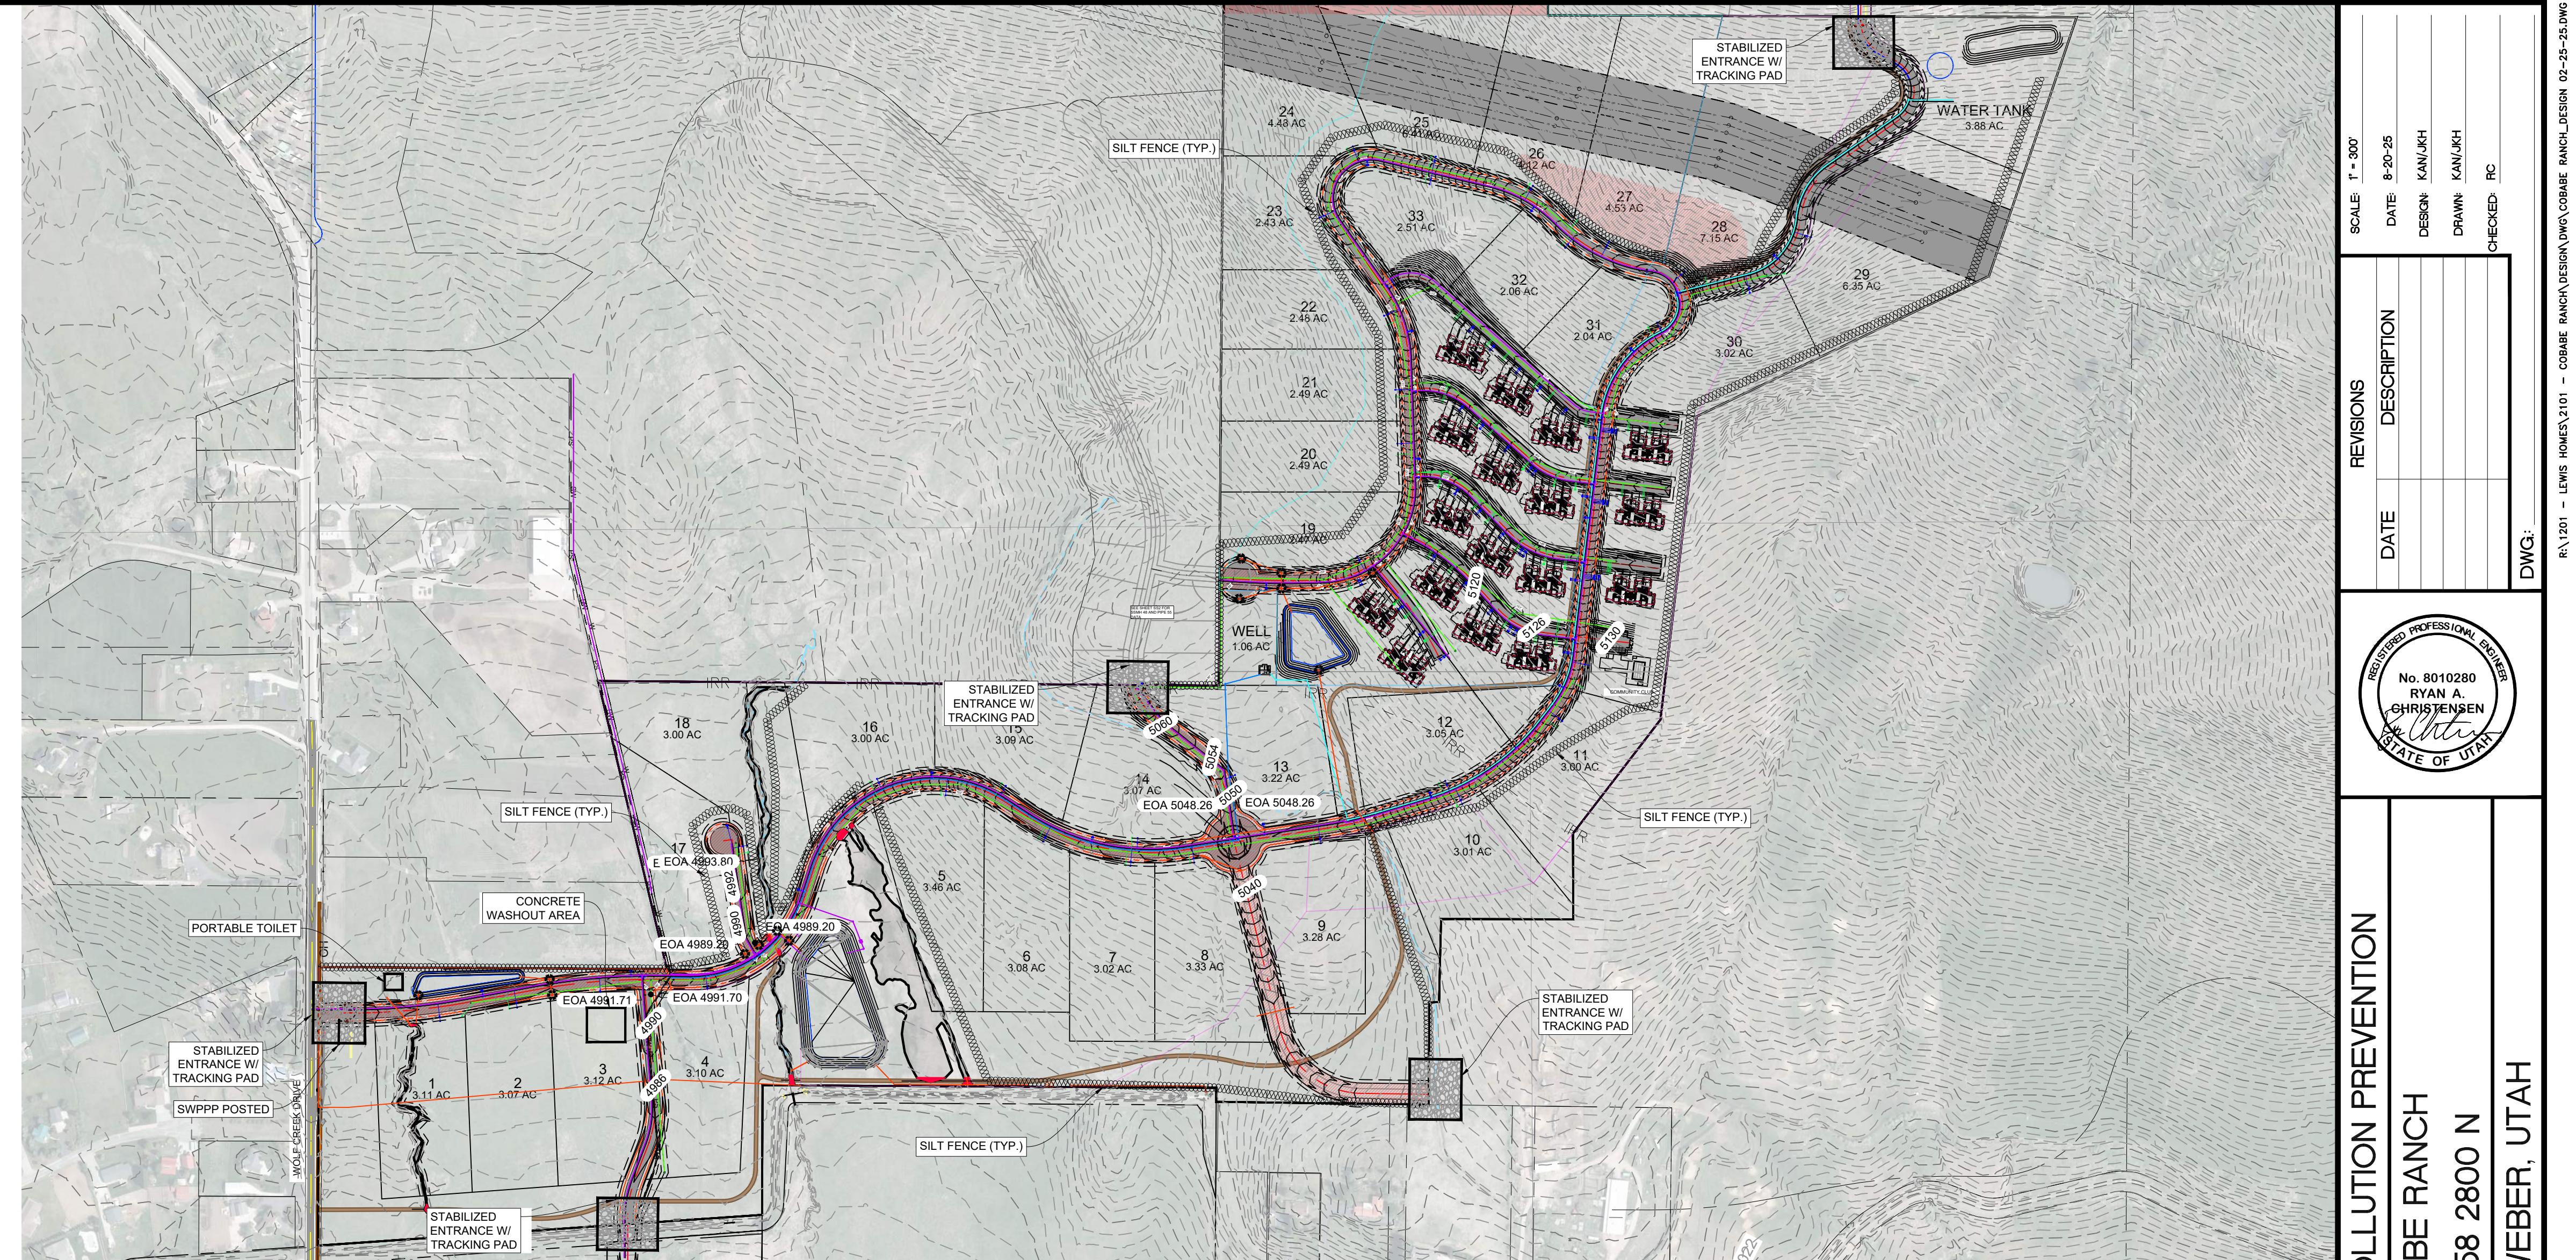


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INSTALLATION NOTES

1. PLACEMENT: PLACE CG TIGHTLY AGAINST CURB OPENING AND COVER ENTIRE GRATE. CG SHOULD EXTEND AT LEAST 2 INCHES PAST GRATE TOWARDS STREET.
2. OVERLAP FOR LONG OPENINGS: OVERLAP CG UNITS AT LONGER OPENINGS.
3. ANCHOR: ANCHOR CG SO THAT WATER CANNOT FLOW BEHIND IT.
4. ALTERNATE ANCHOR METHODS: A) INSTALL GRAVEL BAGS AT EACH SIDE OF CG - HALF-ON AND HALF-OFF THE EDGES. USE HALF-FILLED GRAVEL BAGS (15 OR 20 LBS). ROUND ROCK IS RECOMMENDED. OR B) ATTACH WITH 16 GAUGE TIE-WIRE. CUT WIRE TO 18" LENGTH. AT EACH CORNER OF CG, FEED ONE END OF WIRE DOWN THROUGH CG, AROUND GRATE BAR, AND BACK UP THRU CG ABOVE GROUND, TWIST WIRES SEVERAL TIMES, CUT-OFF EXCESS. OR C) FASTEN WITH CONCRETE ANCHORS/NAILS AT THE OUTSIDE EDGES OF CG.

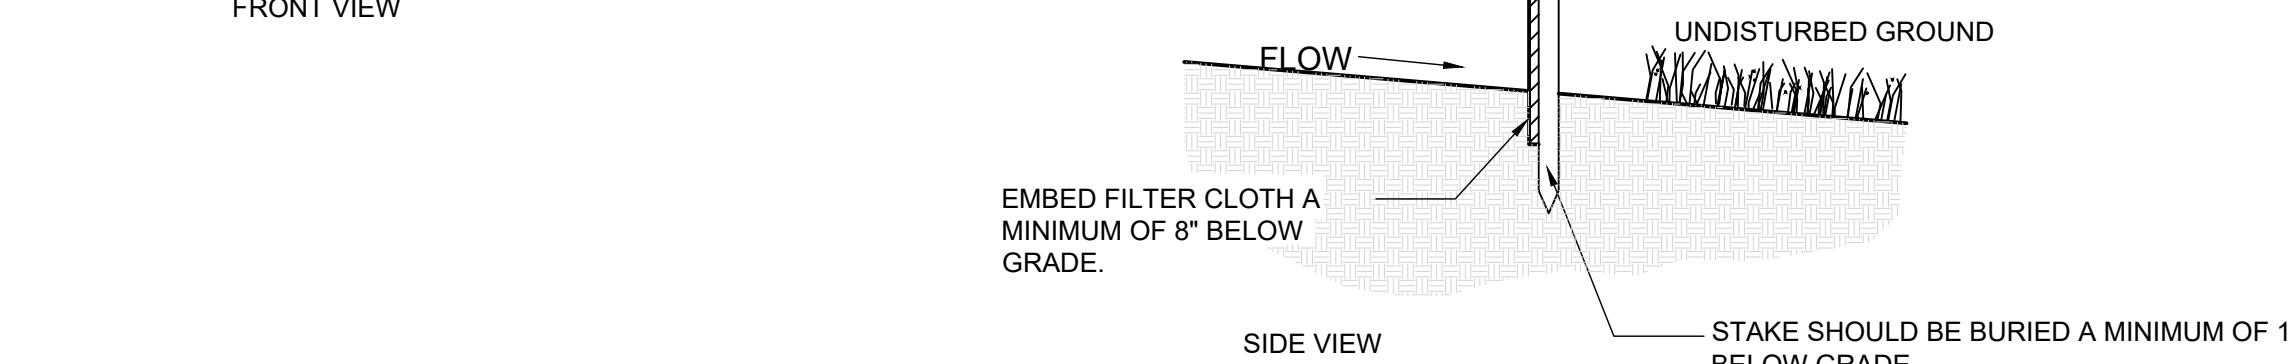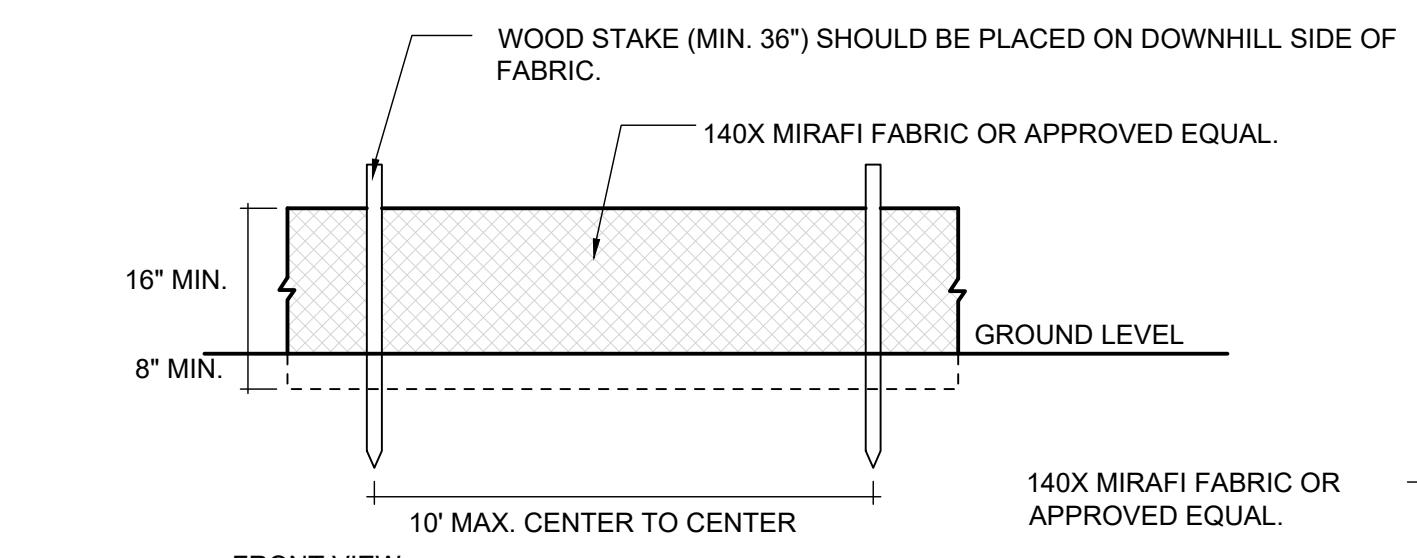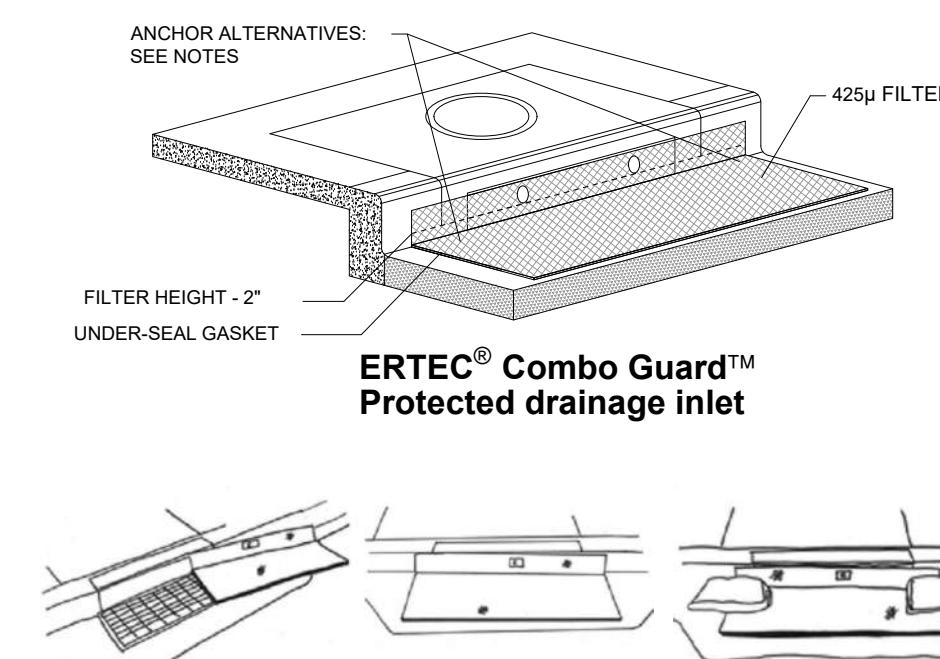


1A INLET PROTECTION - OPTION 1

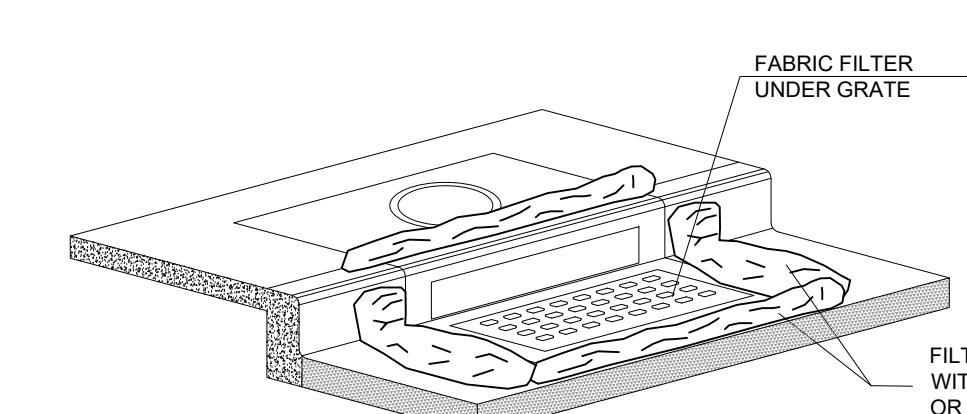

2 SILT FENCE




1B INLET PROTECTION - OPTION 2

Scale: NTS



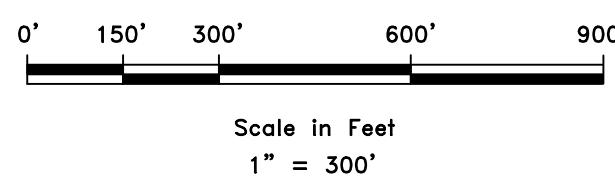


SWP-01

PLAN AND PROFILE

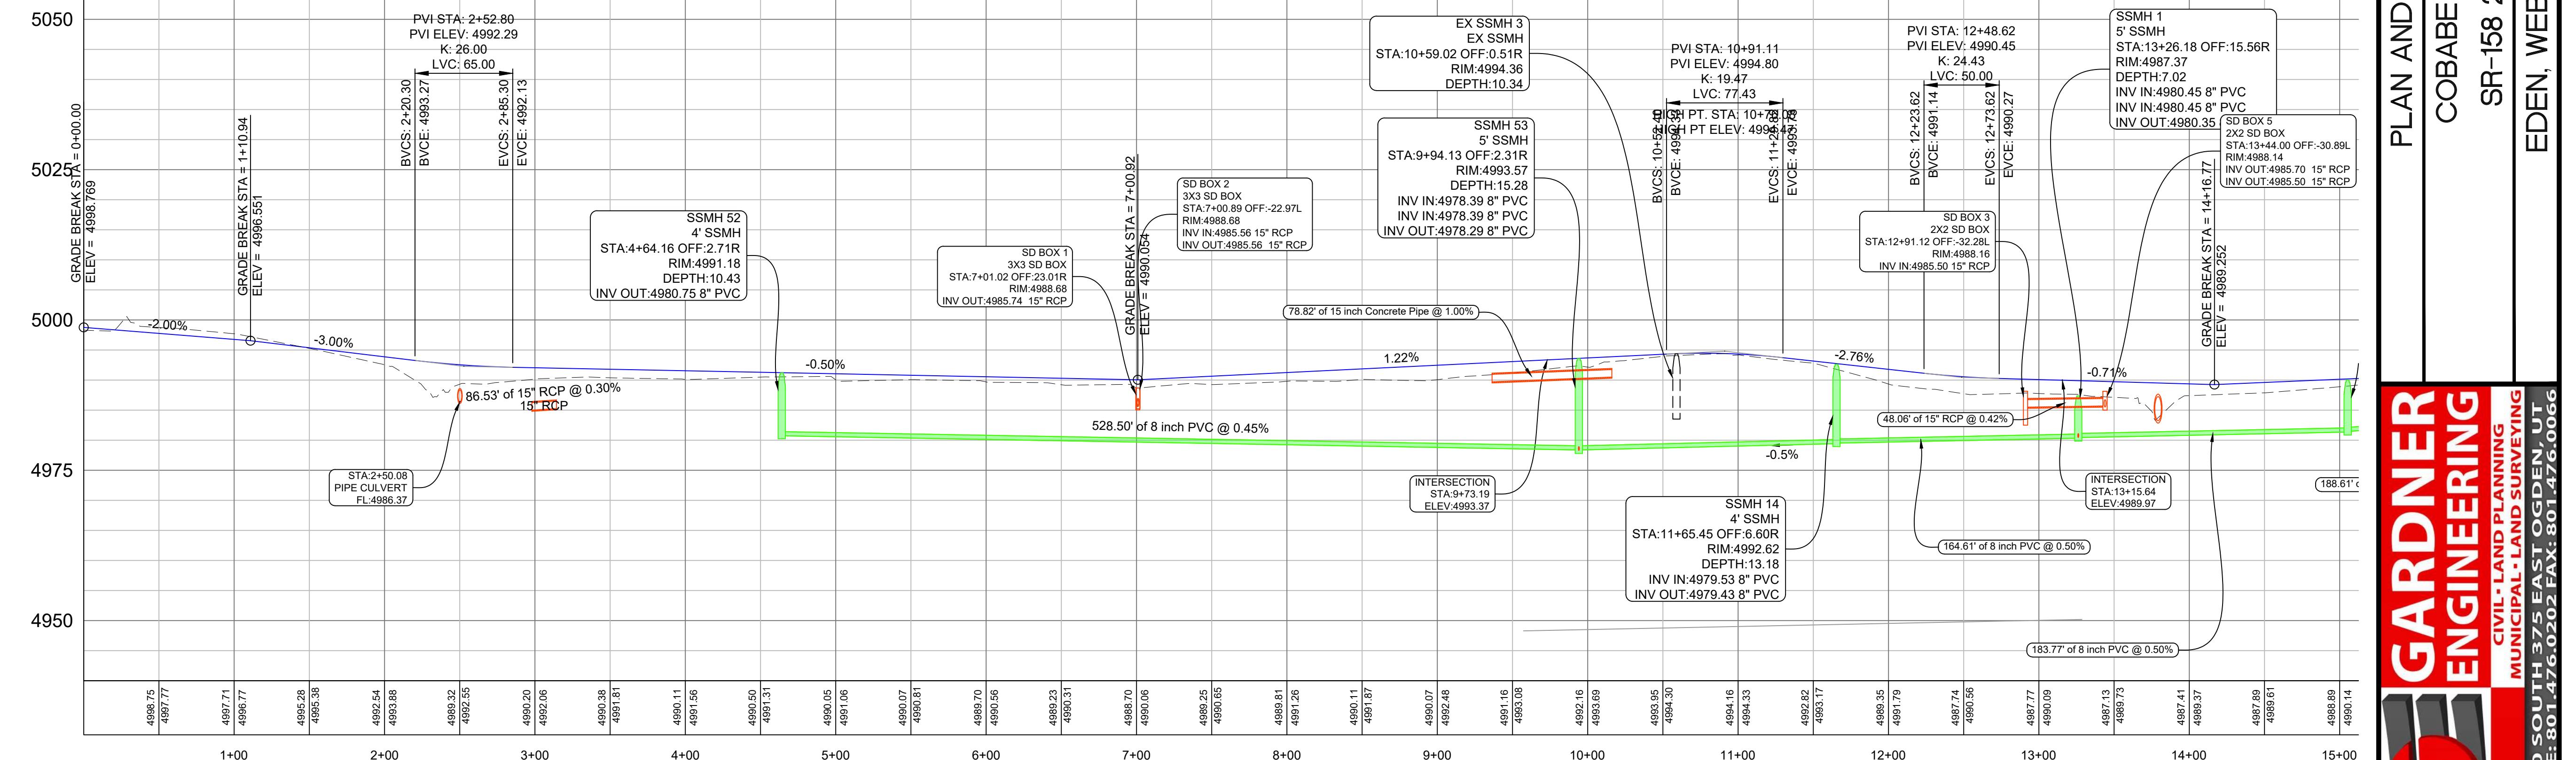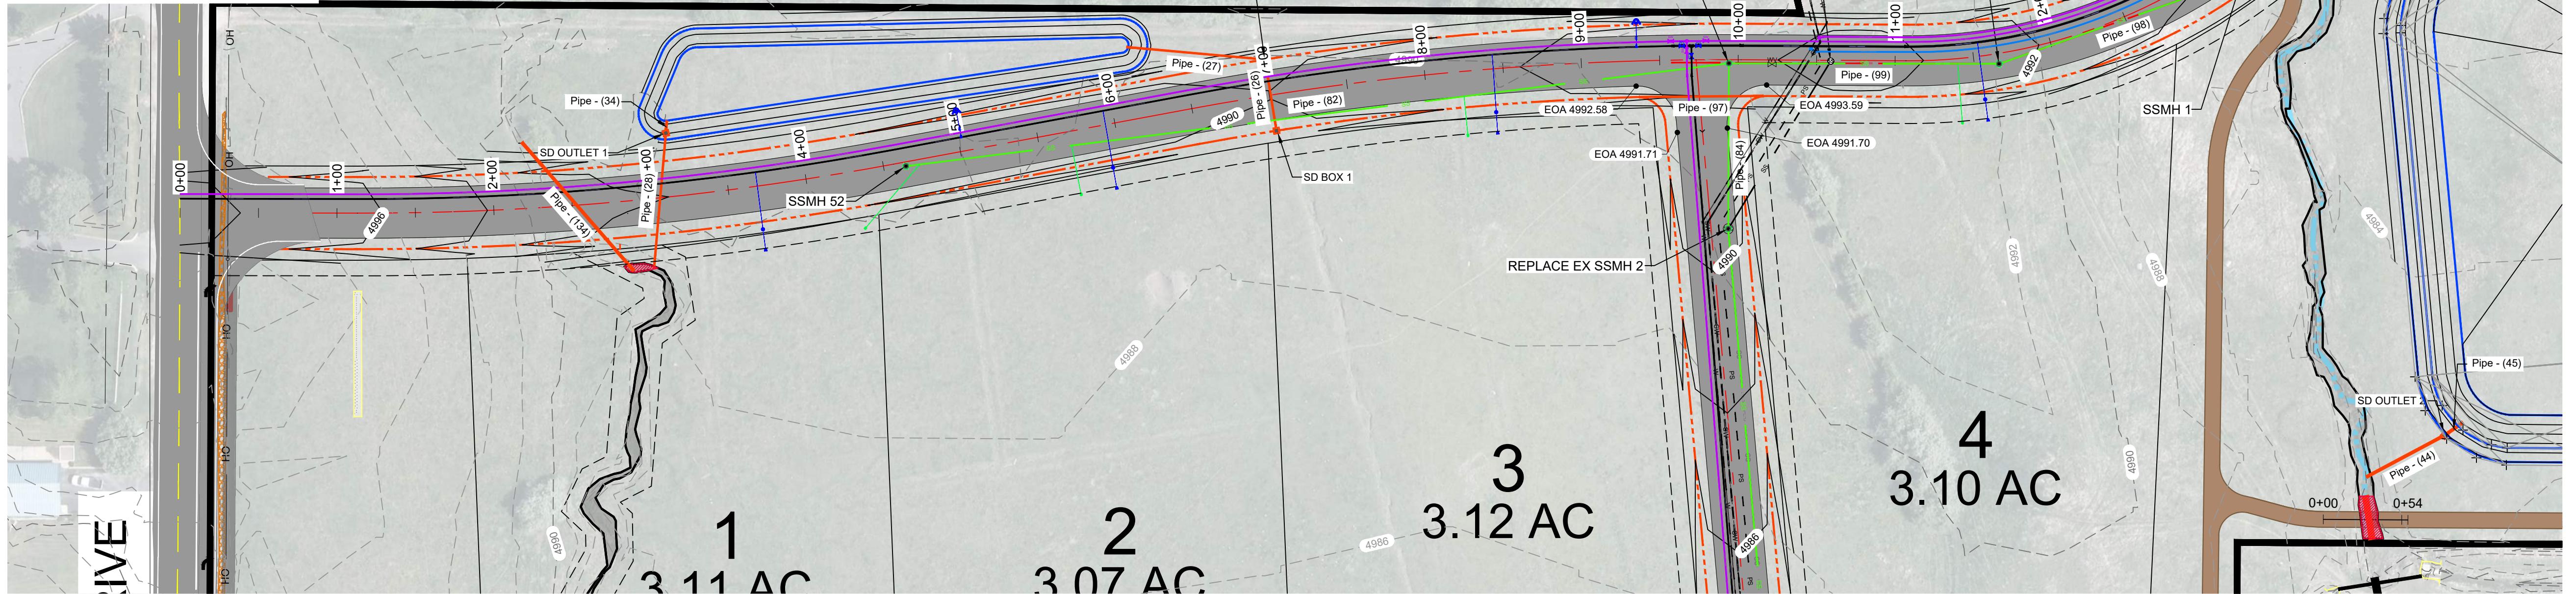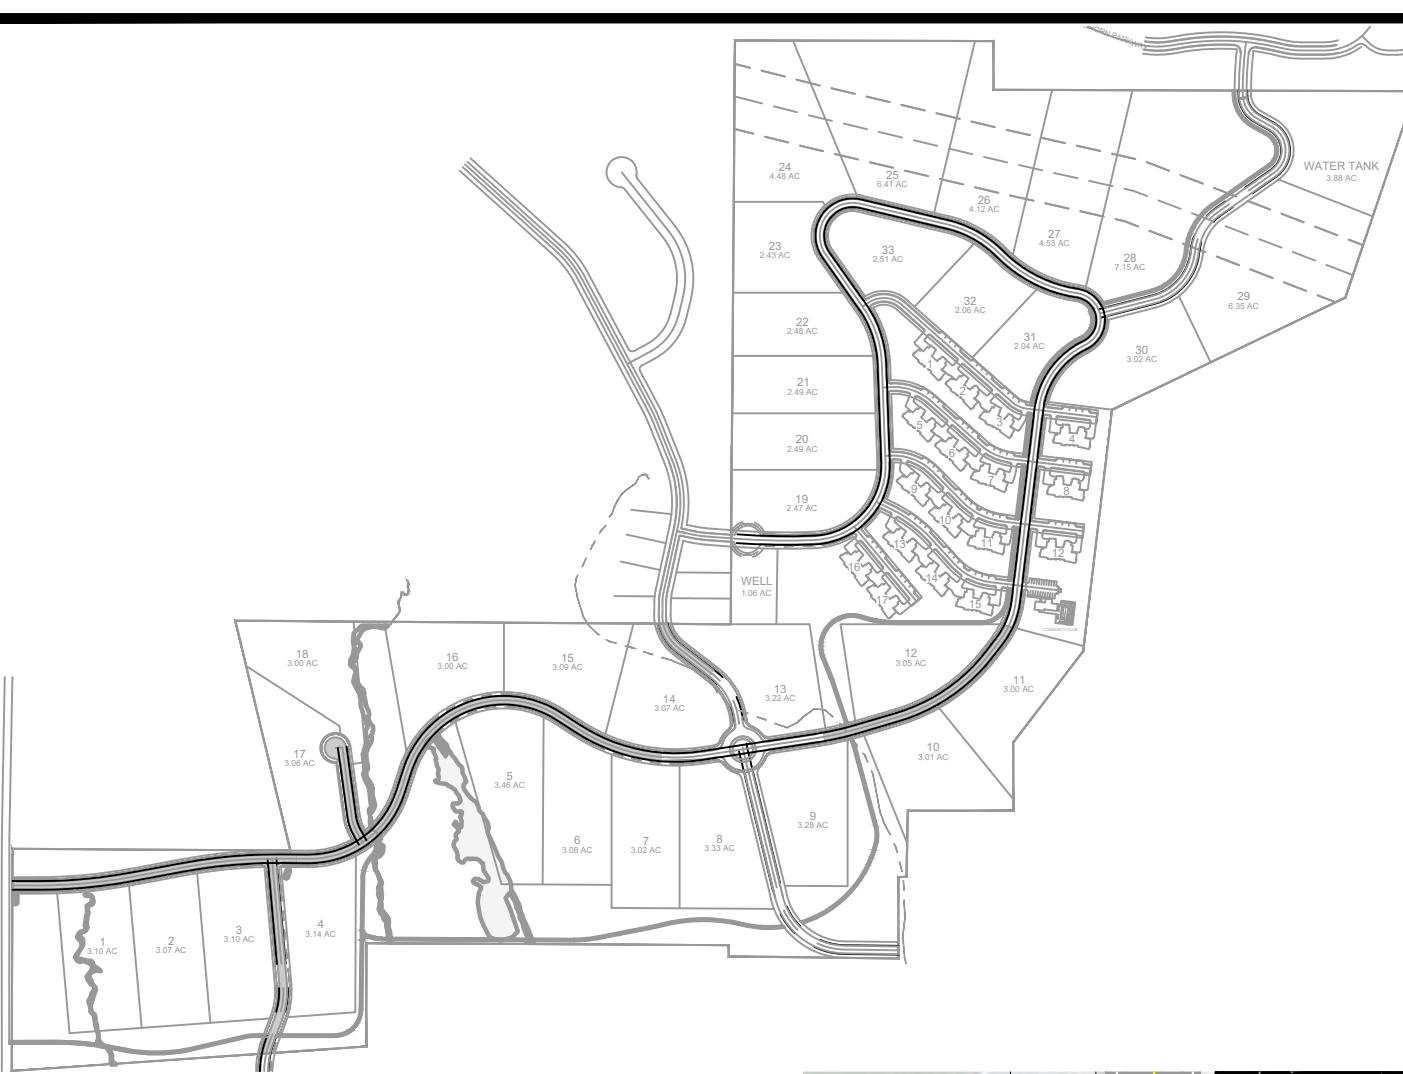

PLAN AND PROFILE

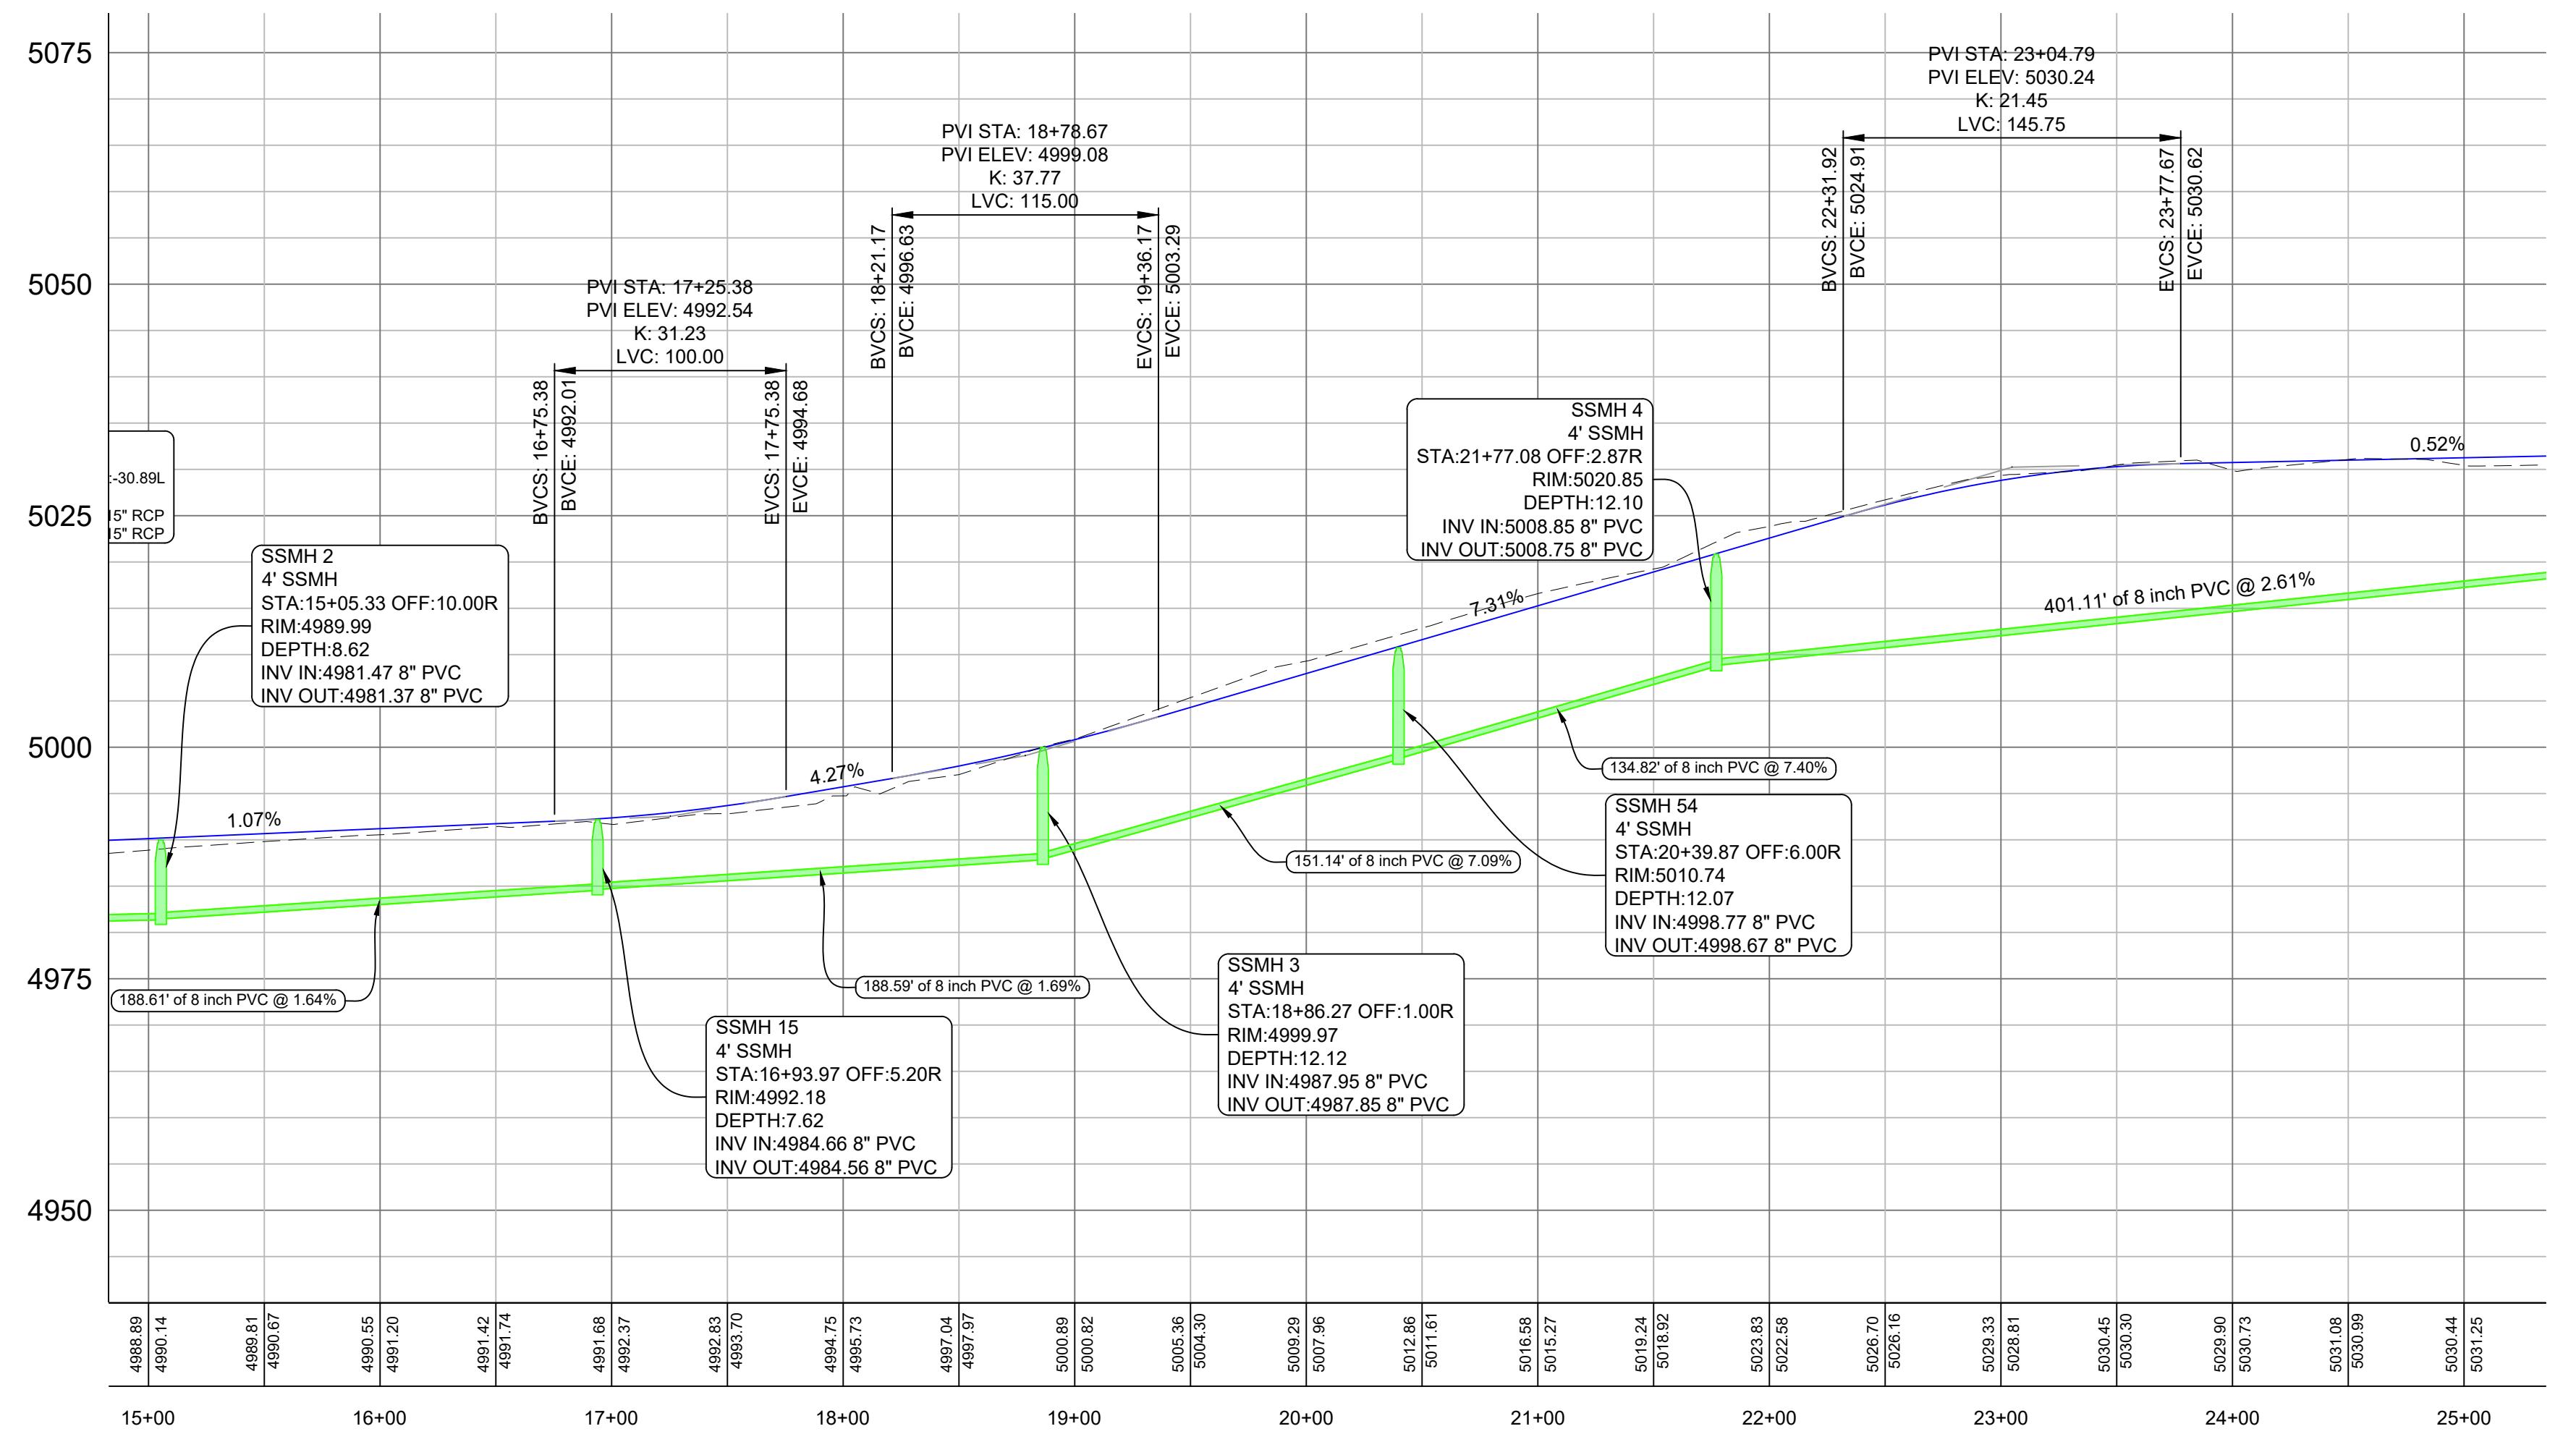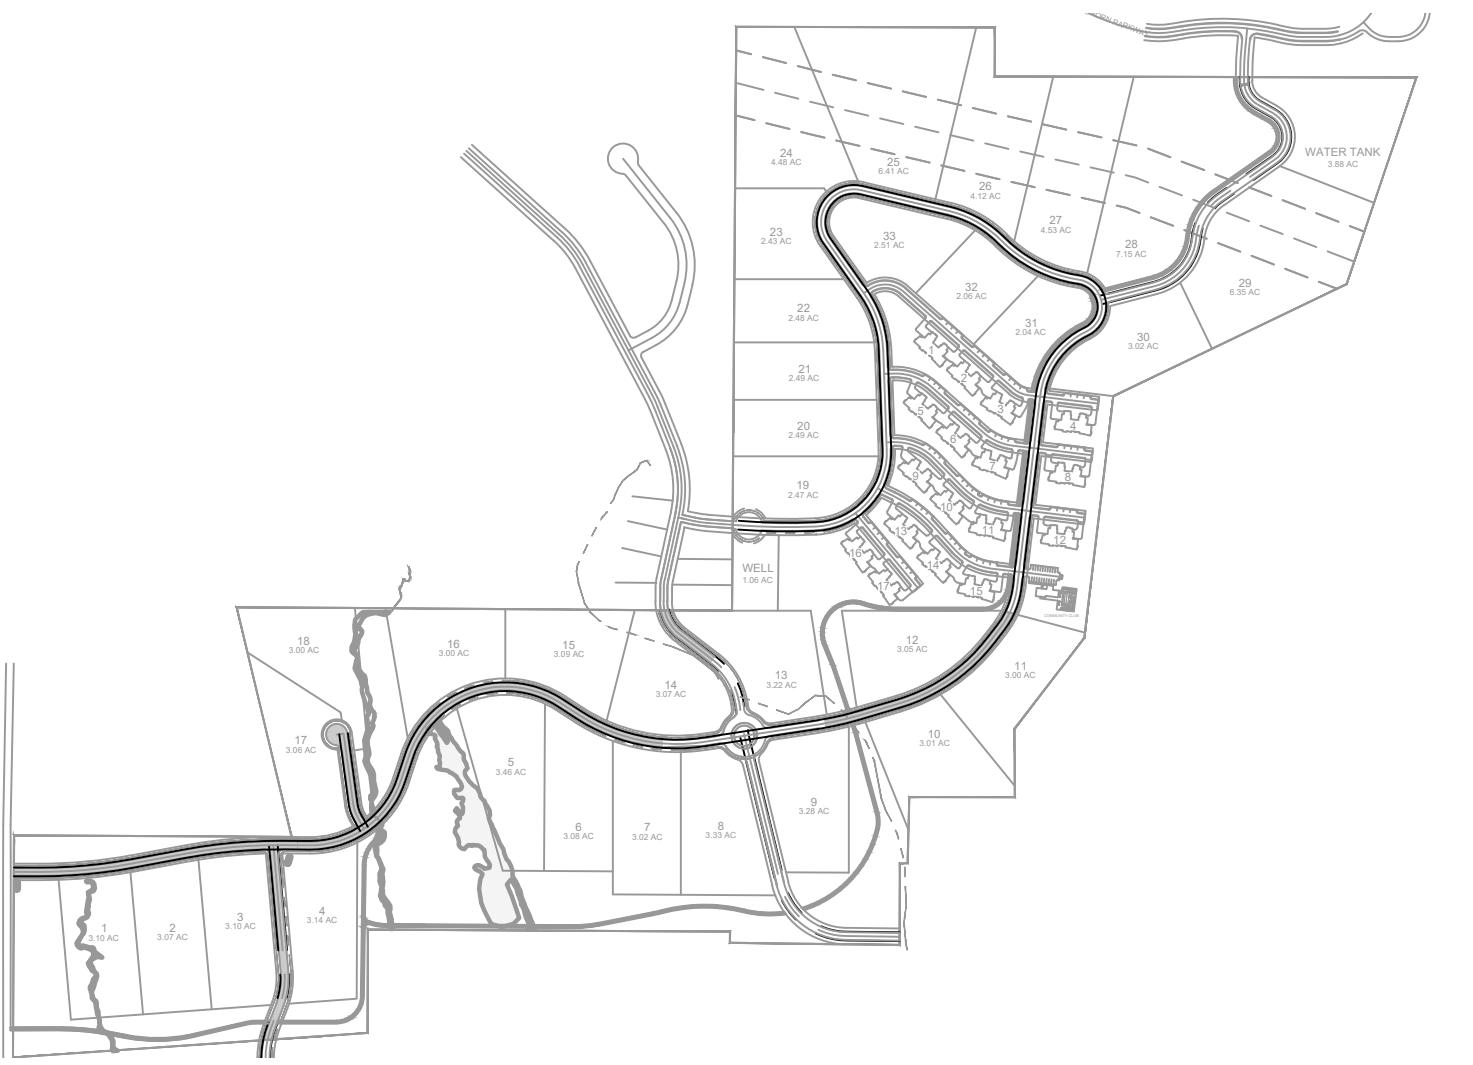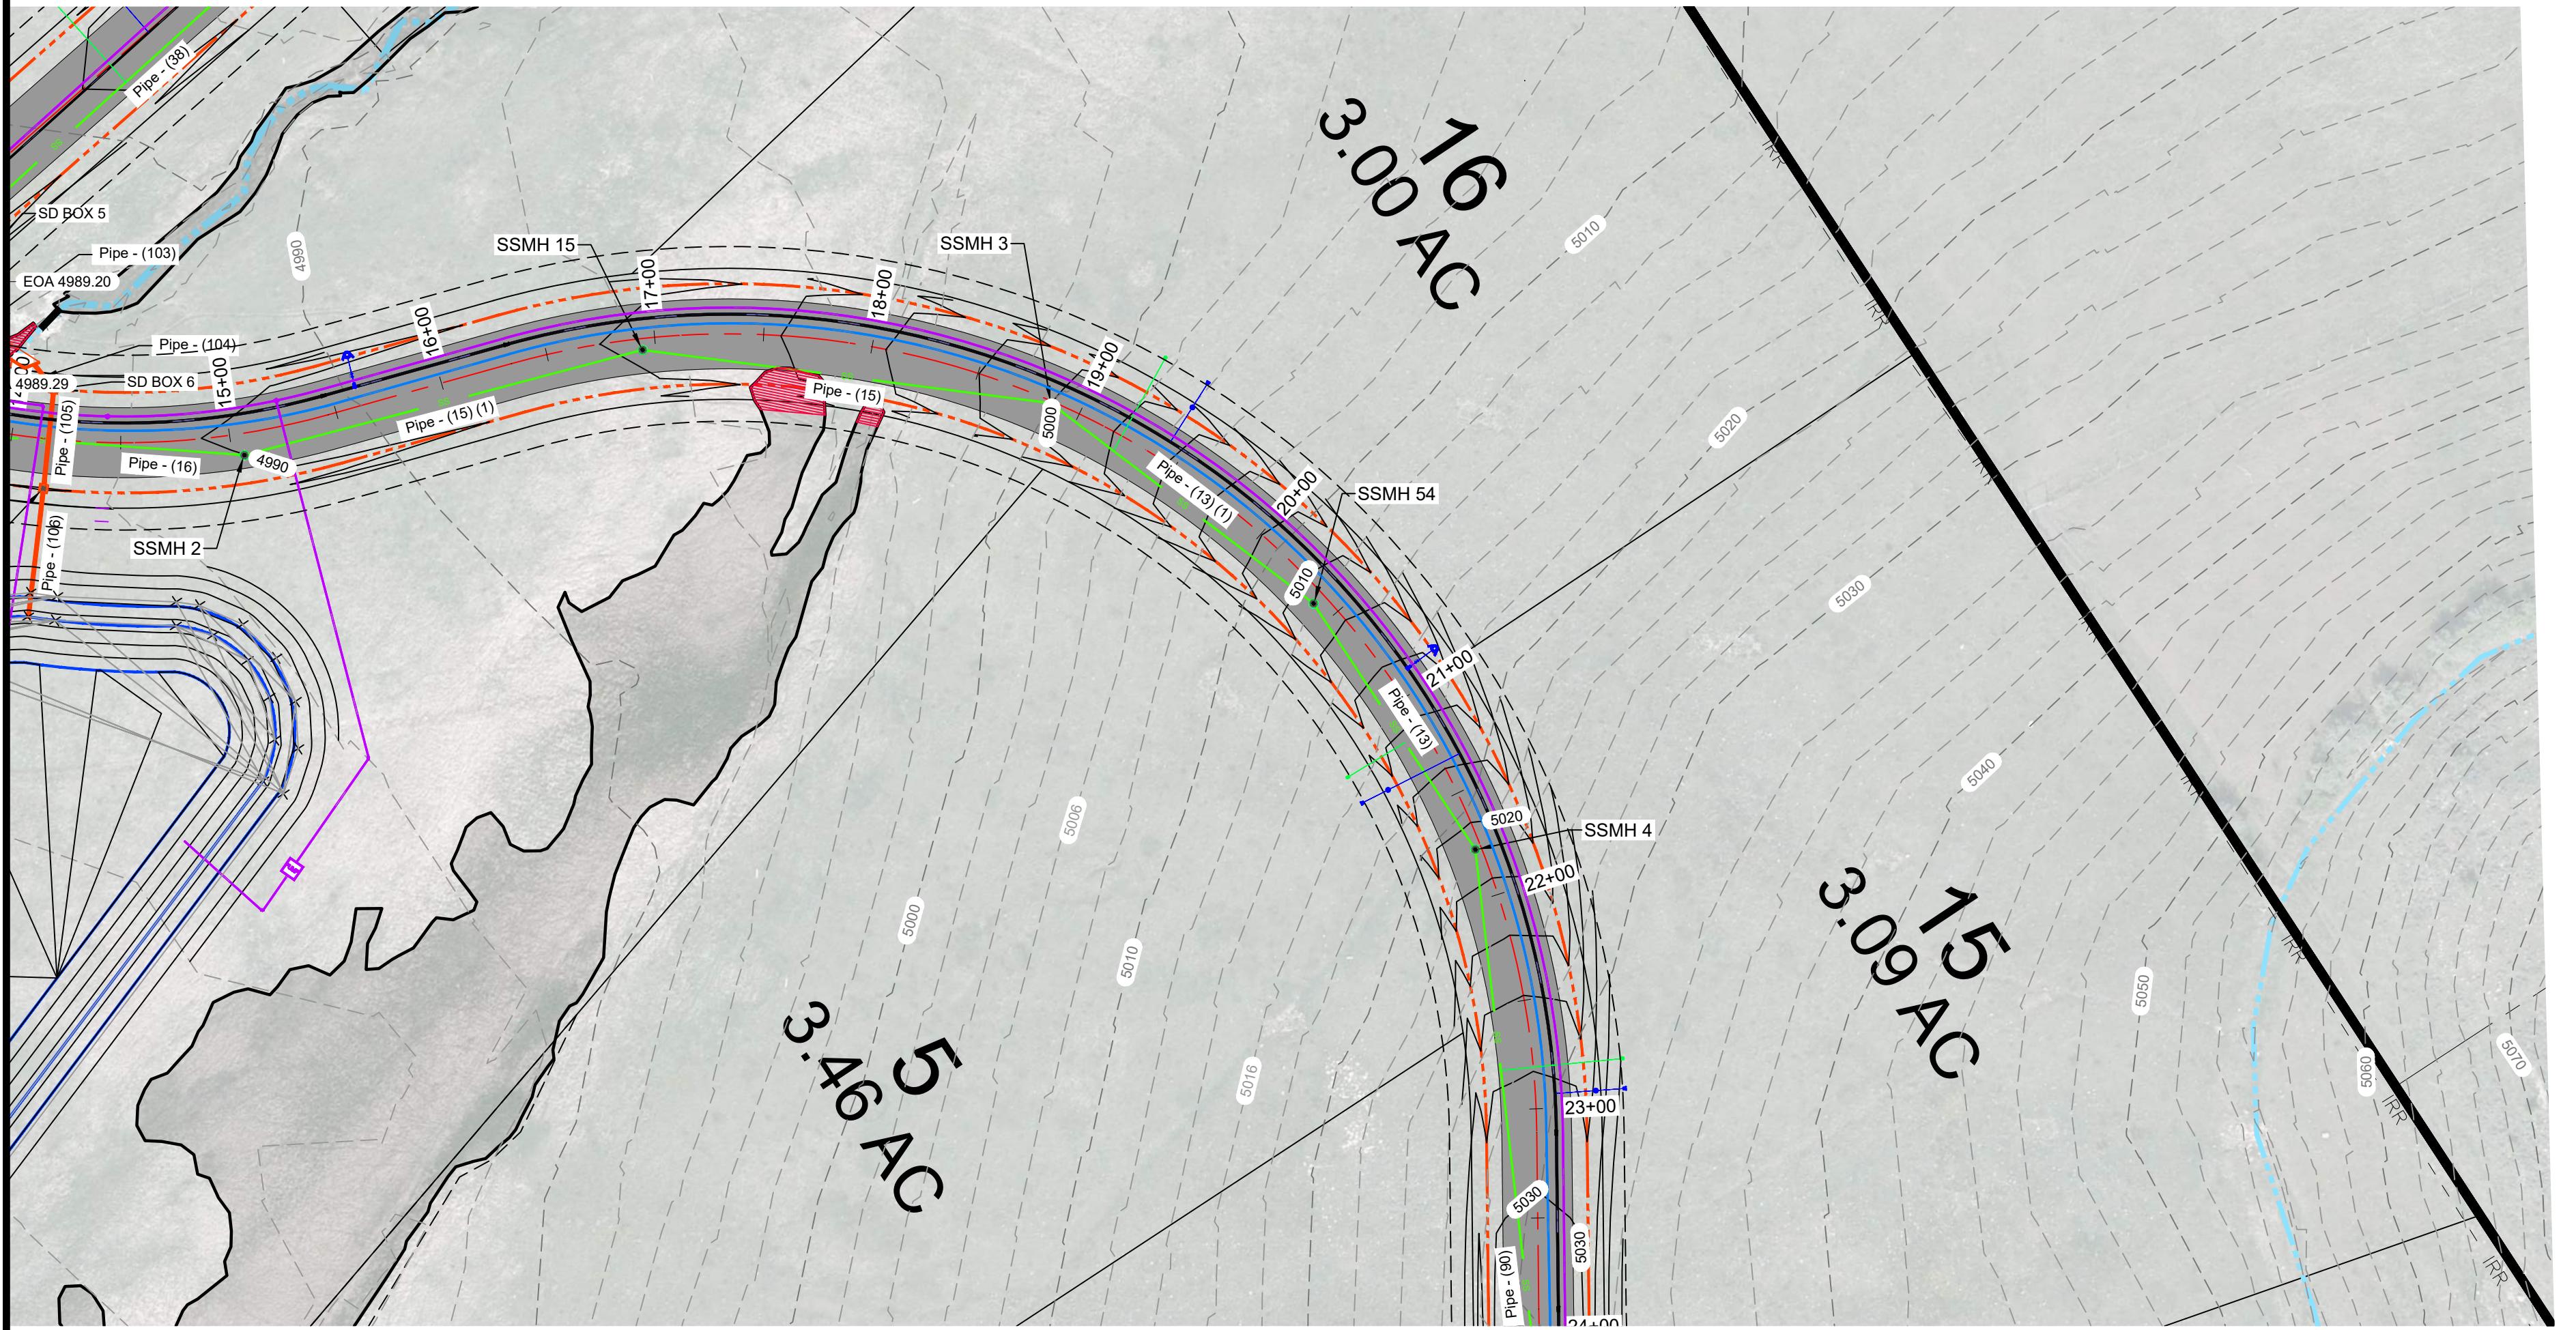

PP2
Scale in Feet
1" = 60'



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PP2


PLAN AND PROFILE
COBABE RANCH
SR-158 2800 N
EDEN, WEBER, UTAH

REVISIONS	DESCRIPTION
DATE	DATE
DESIGN	KANJH
DRAWN	KANJH
CHECKED	RC
DWG:	
SCALE	1" = 60'
DATE	8-20-25
DESIGN	KANJH
DRAWN	KANJH
CHECKED	RC

PLAN AND PROFILE

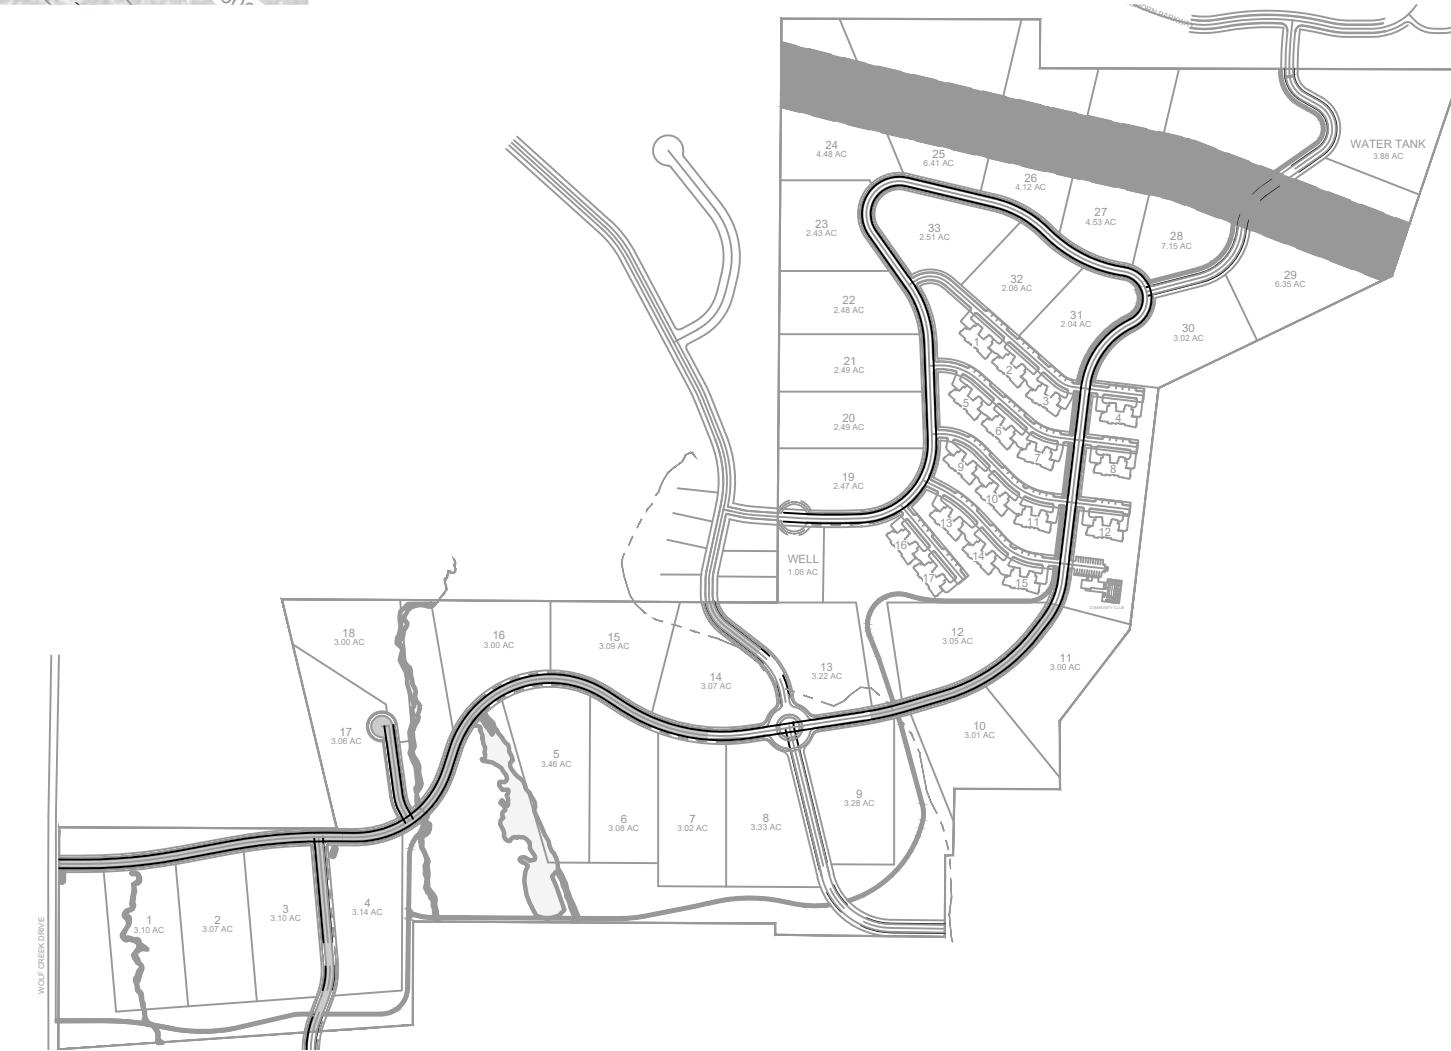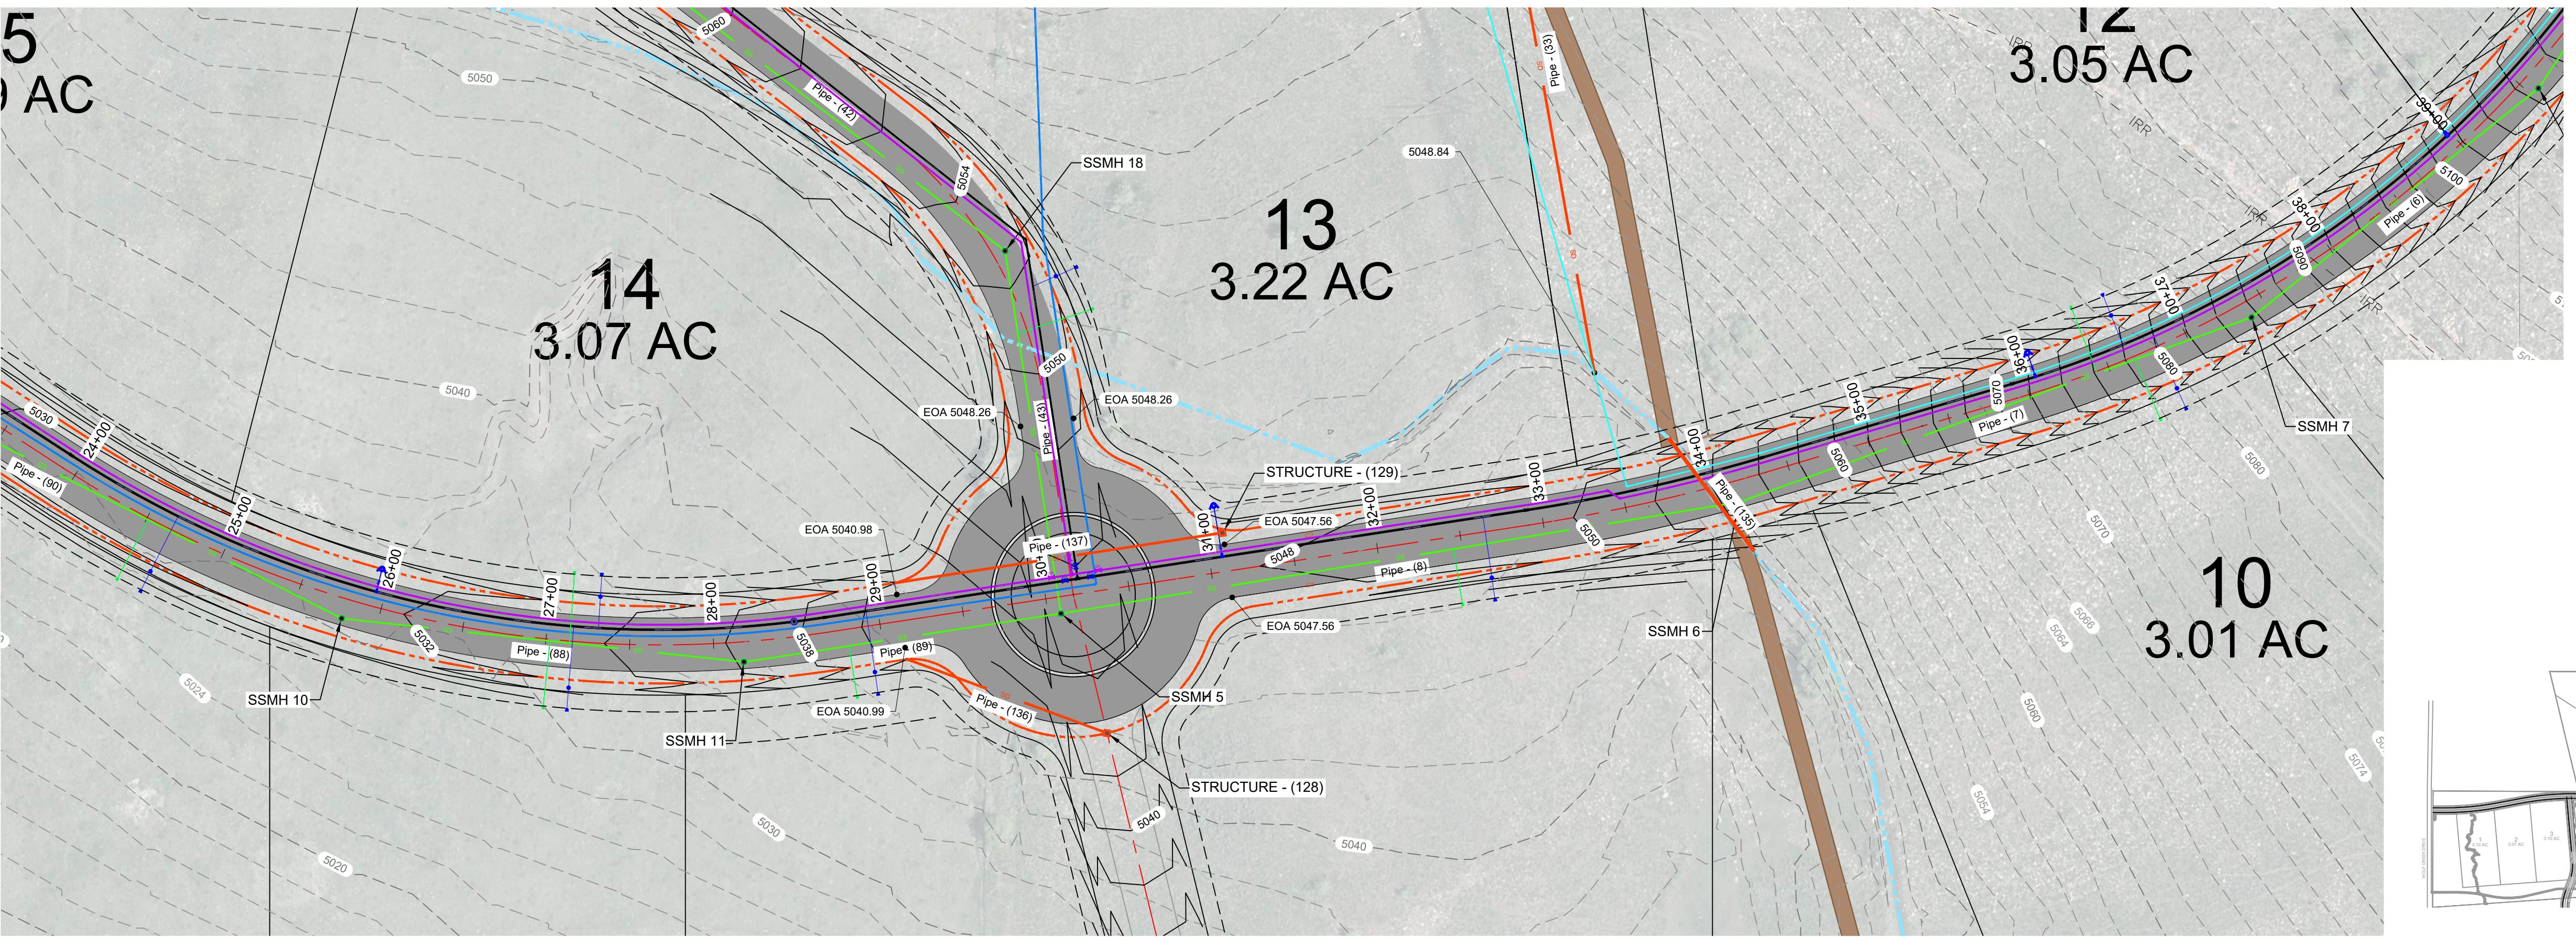


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DATE: 8-20-25
DESIGN: KANJKH
DRAWN: KANJKH
CHECKED: RC

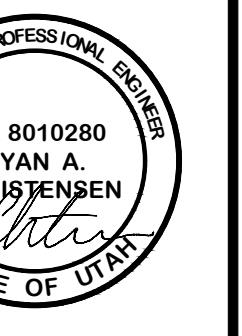


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PLAN AND PROFILE
COBABE RANCH
SR-158 2800 N
EDEN, WEBER, UTAH



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0' 30' 60' 120' 180'
Scale in Feet
1" = 60'

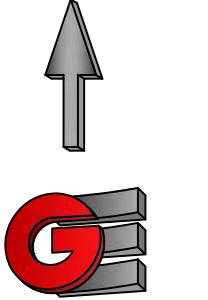



PLAN AND PROFILE

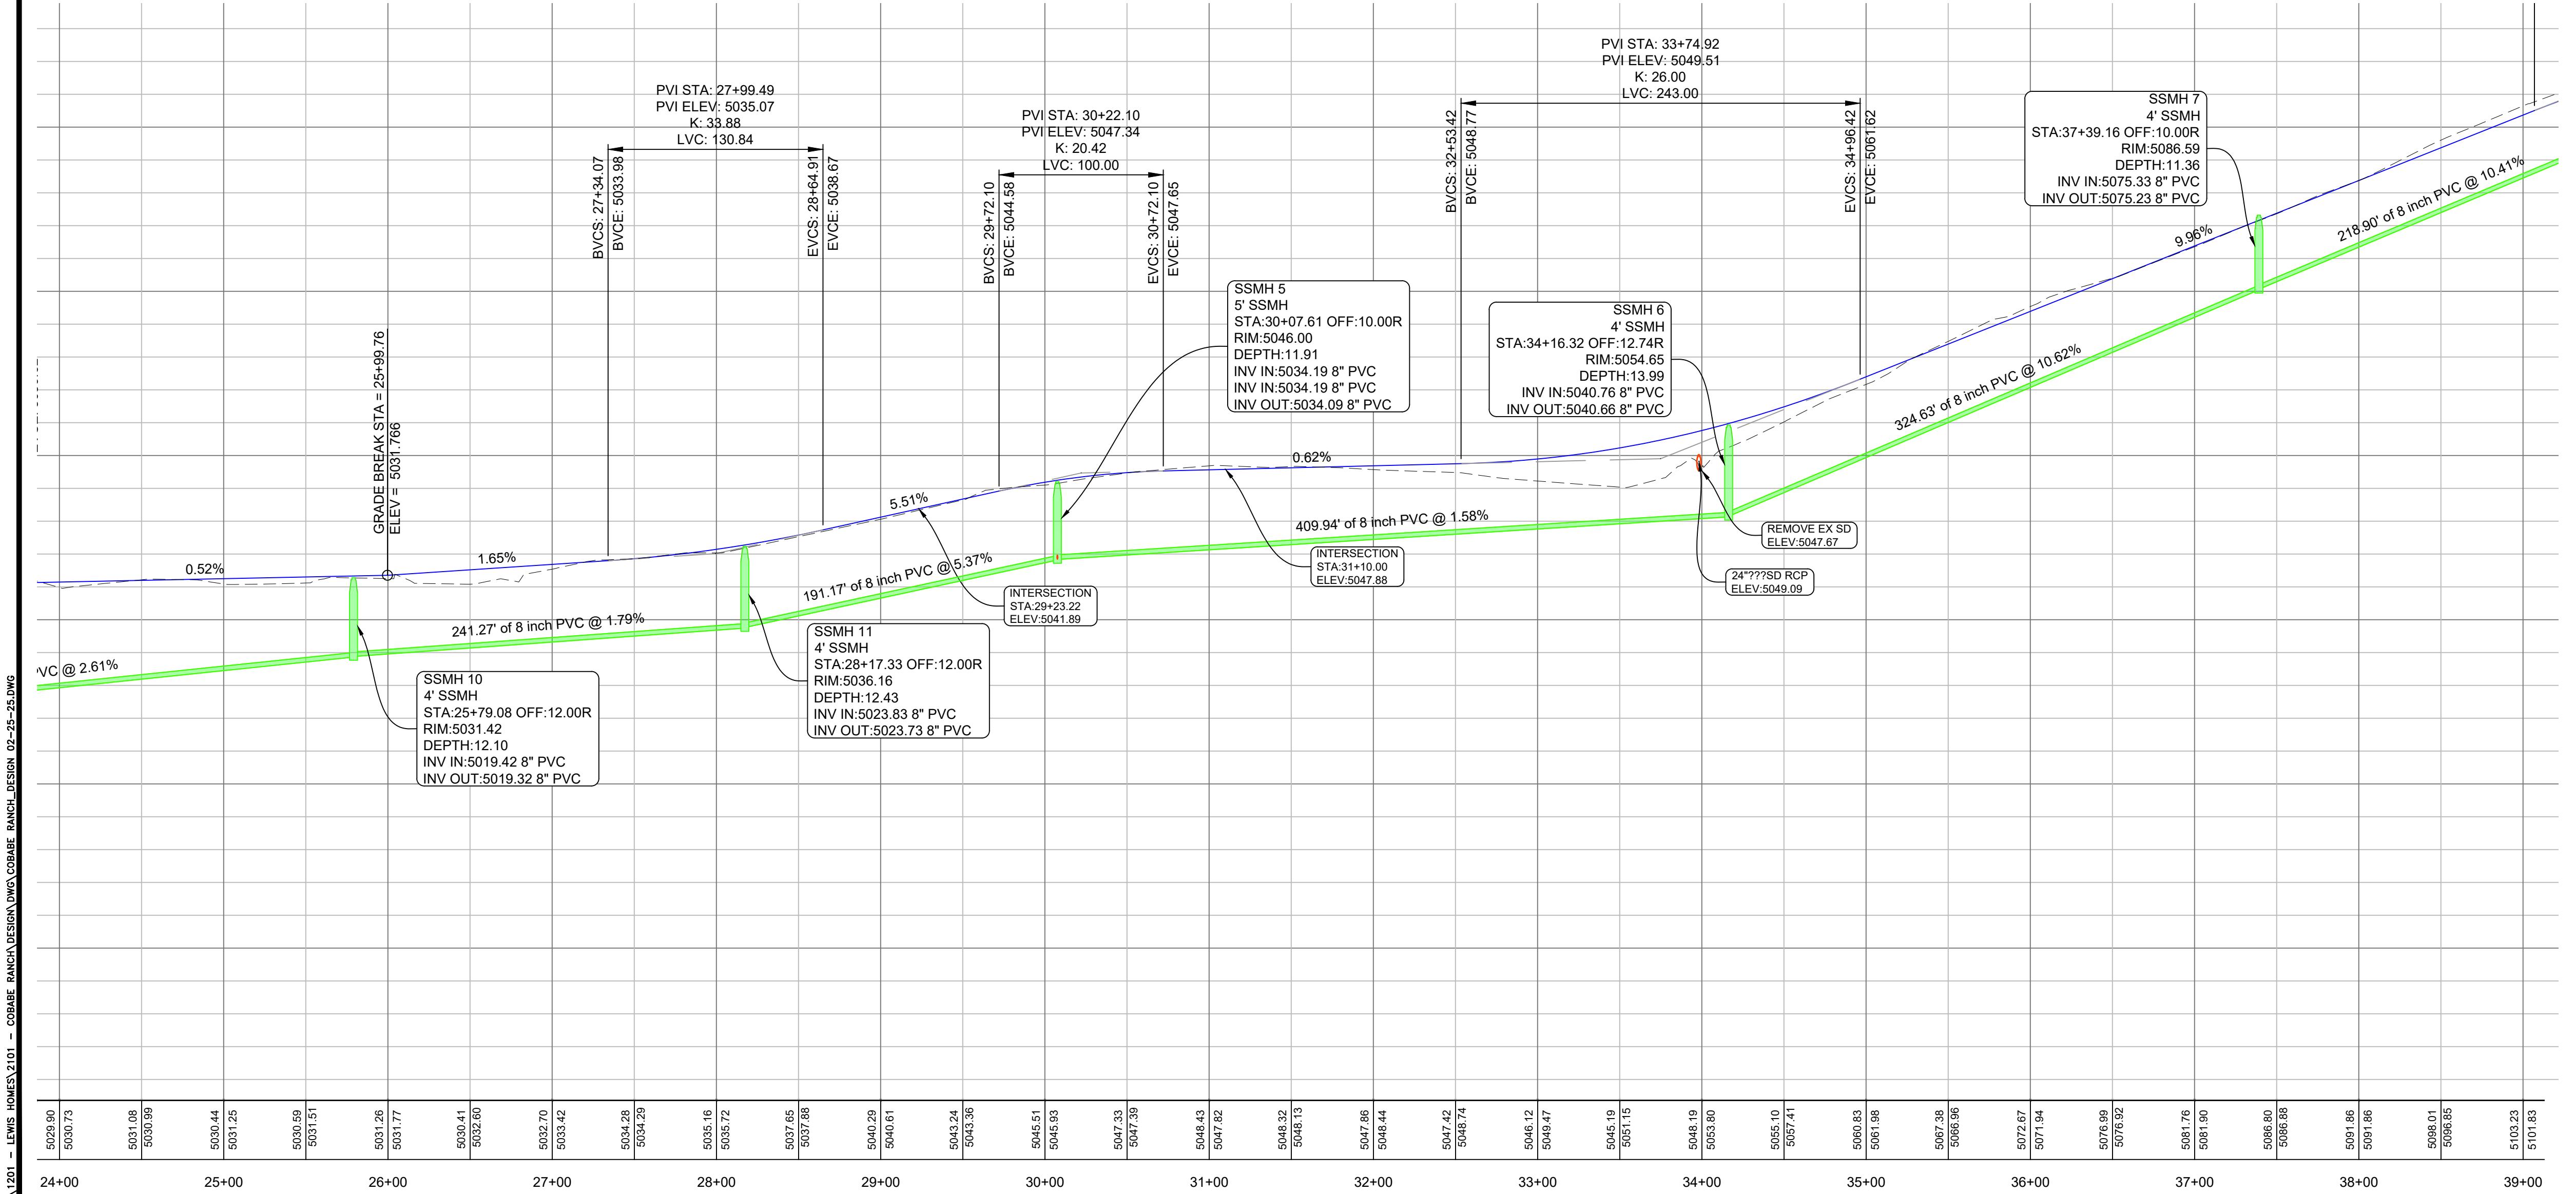

REVISIONS	DESCRIPTION
DATE	DATE
DESIGN	DESIGN
DRAWN	DRAWN
CHECKED	CHECKED
DWG:	DWG:

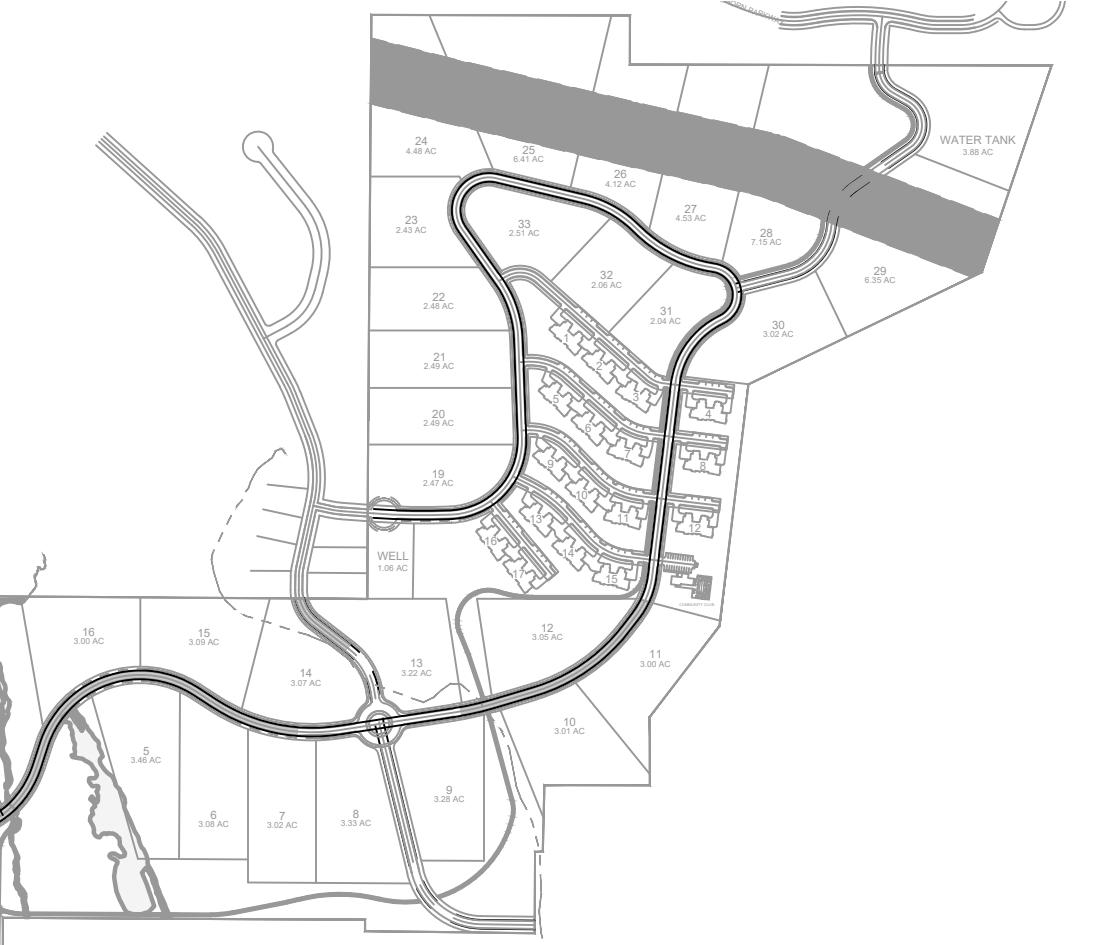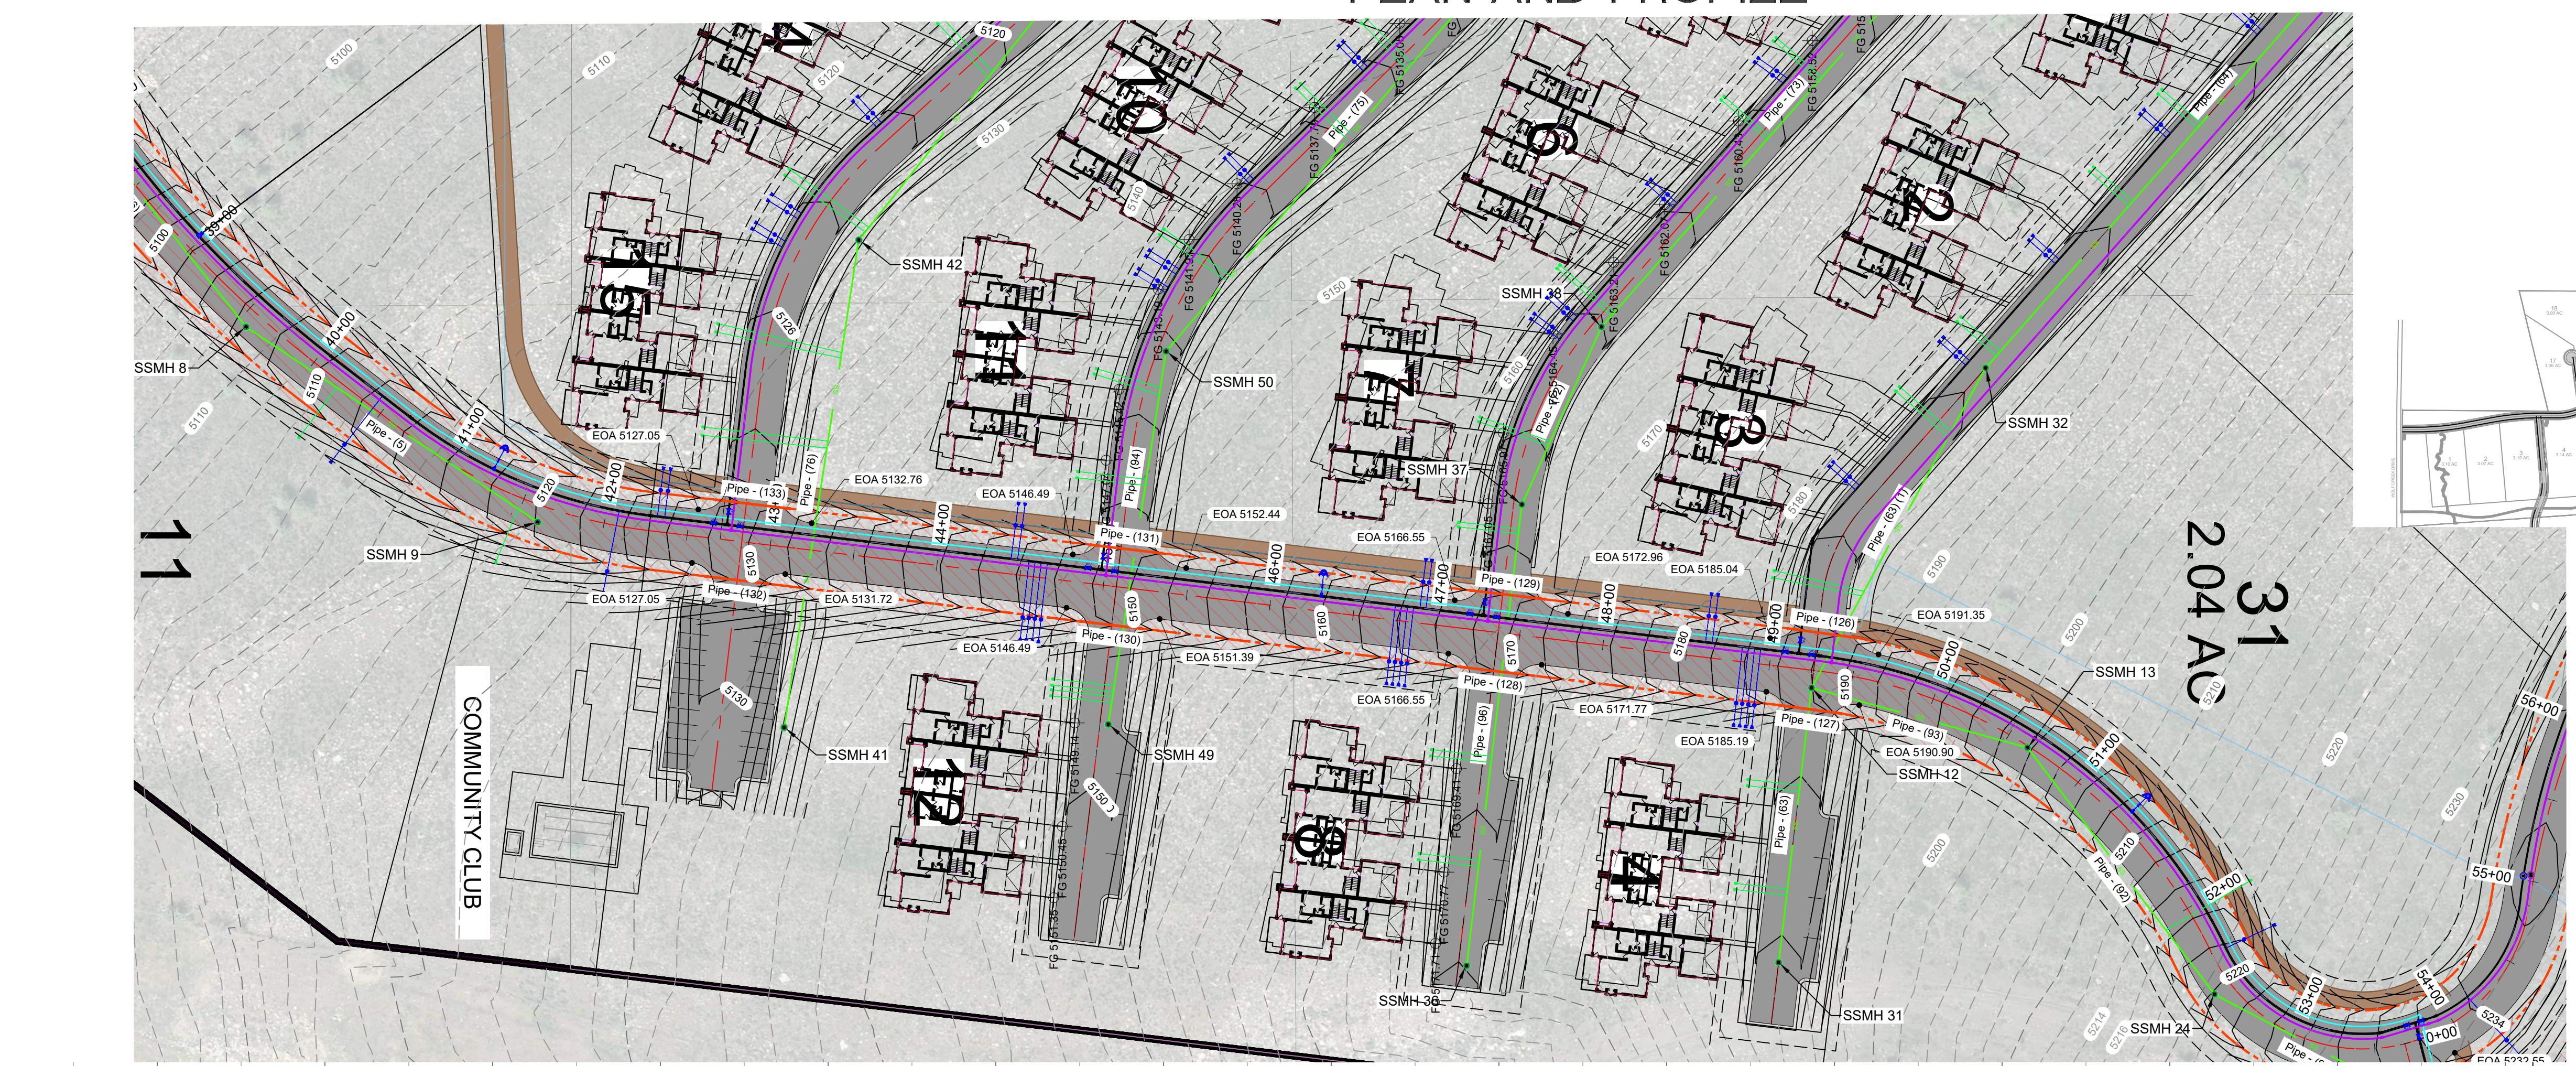REGISTERED PROFESSIONAL ENGINEER
No. 8010280
RYAN A.
CHRISTENSEN
STATE OF UTAH
[Signature]



PLAN AND PROFILE
COBABE RANCH
SR-158 2800 N
EDEN, WEBER, UTAH

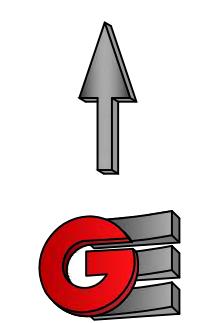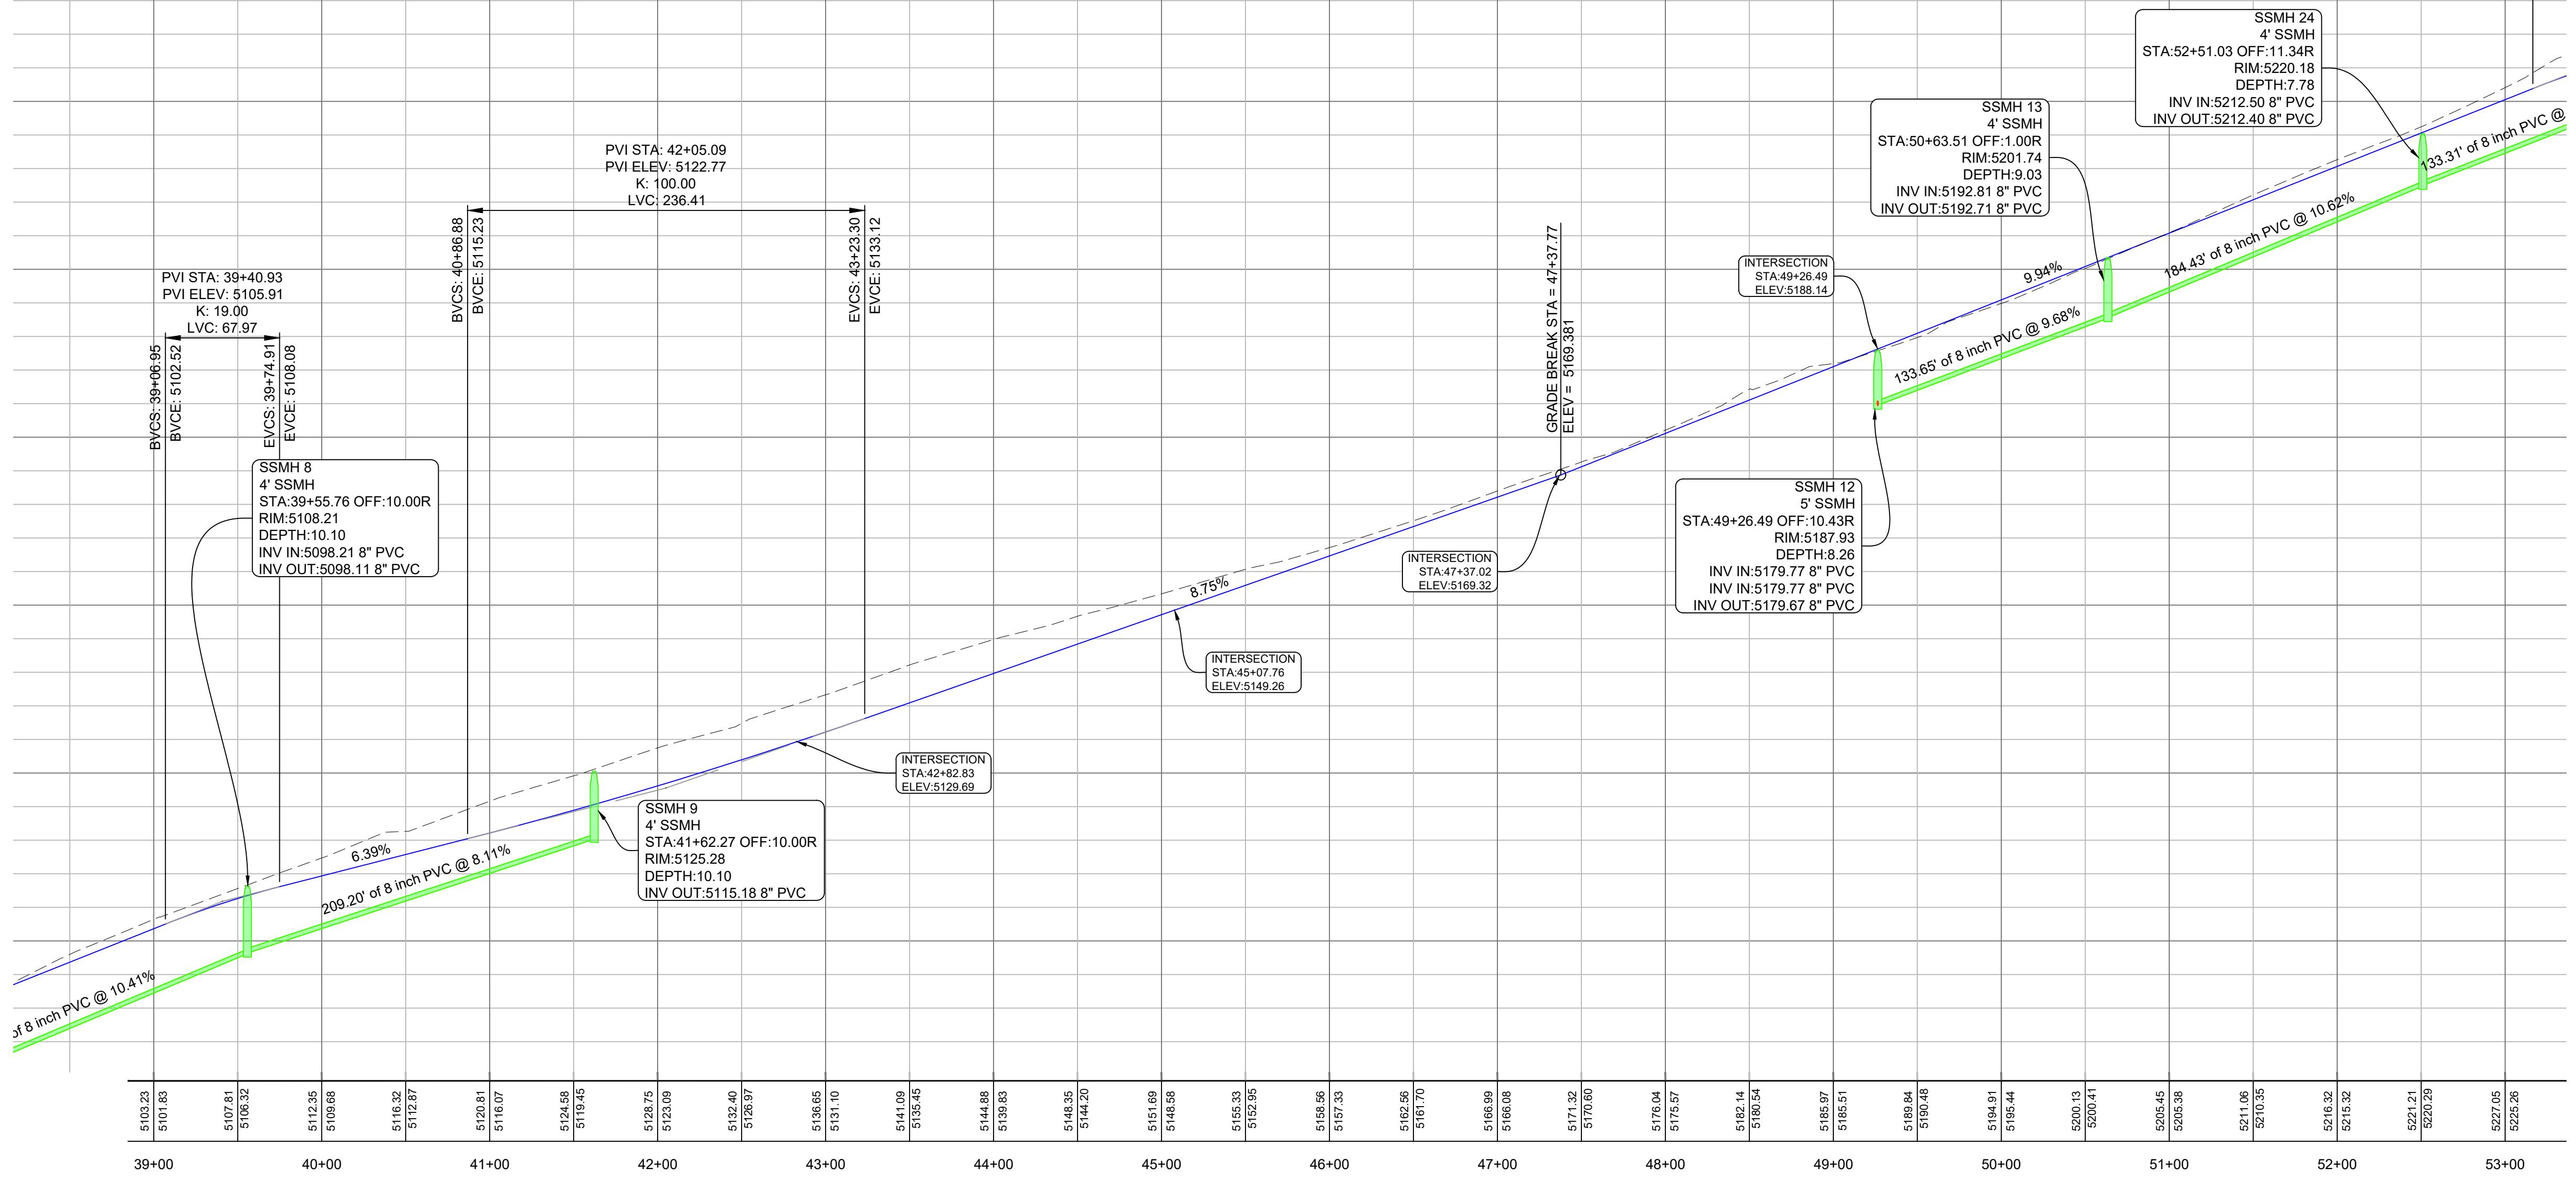


PP4
Scale in Feet
1" = 60'

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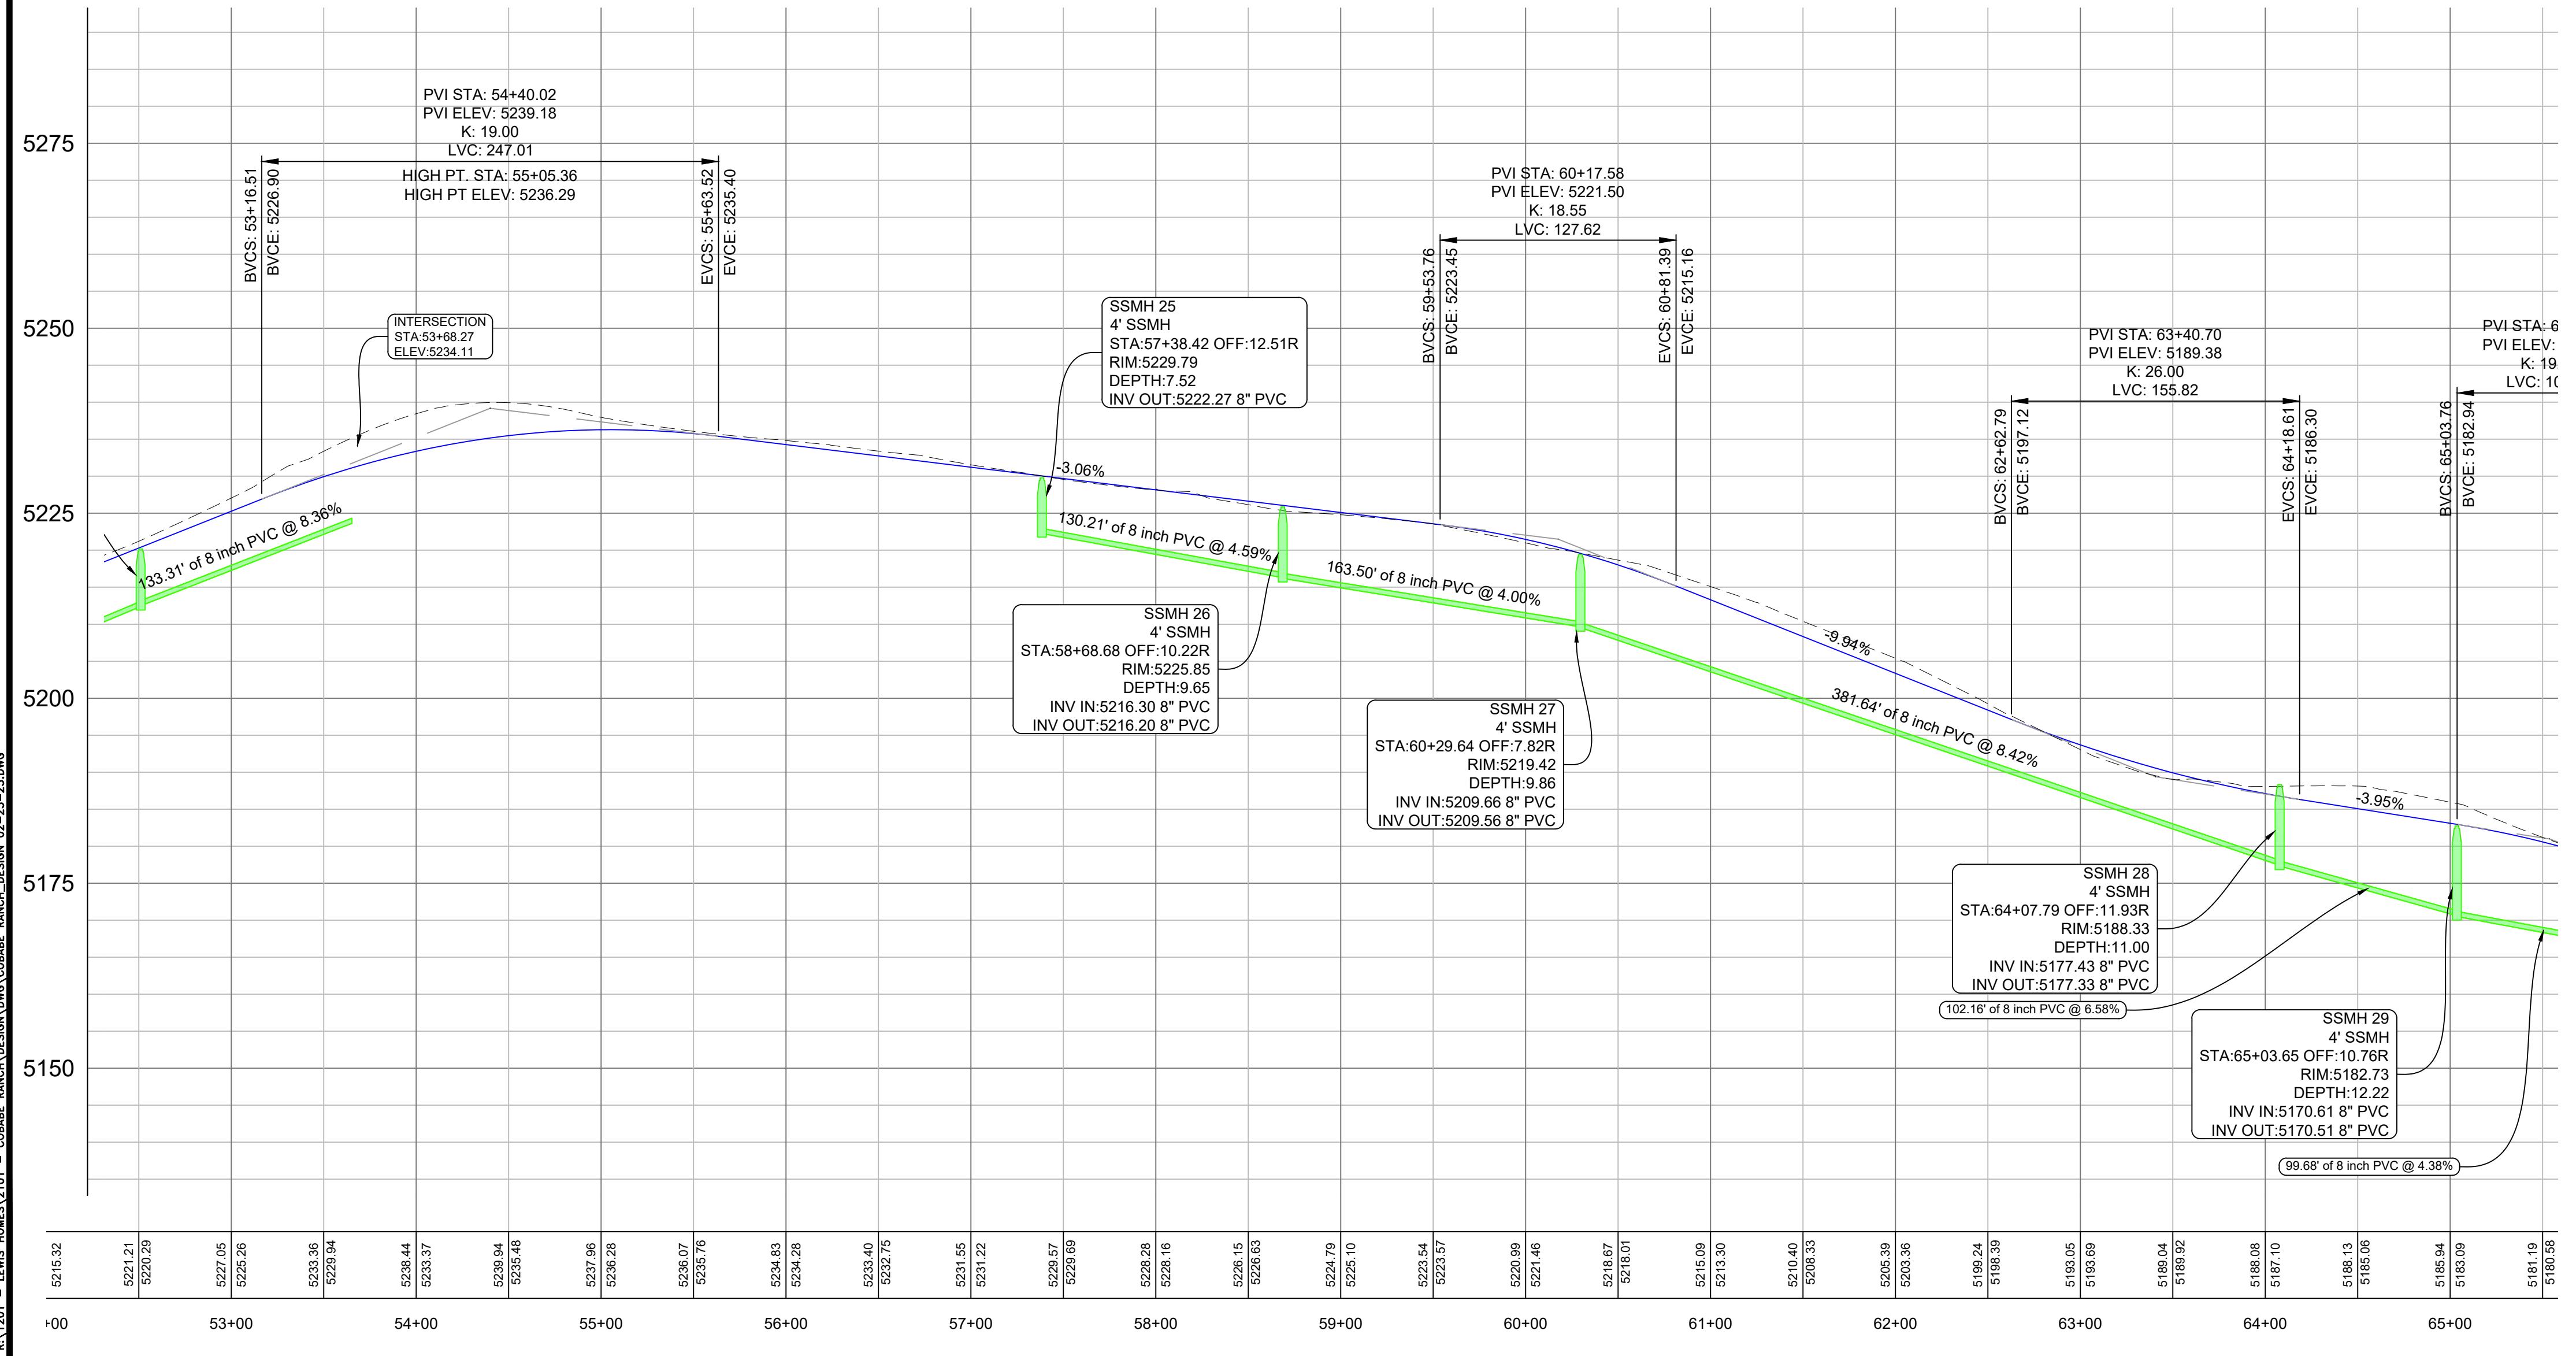
PLAN AND PROFILE

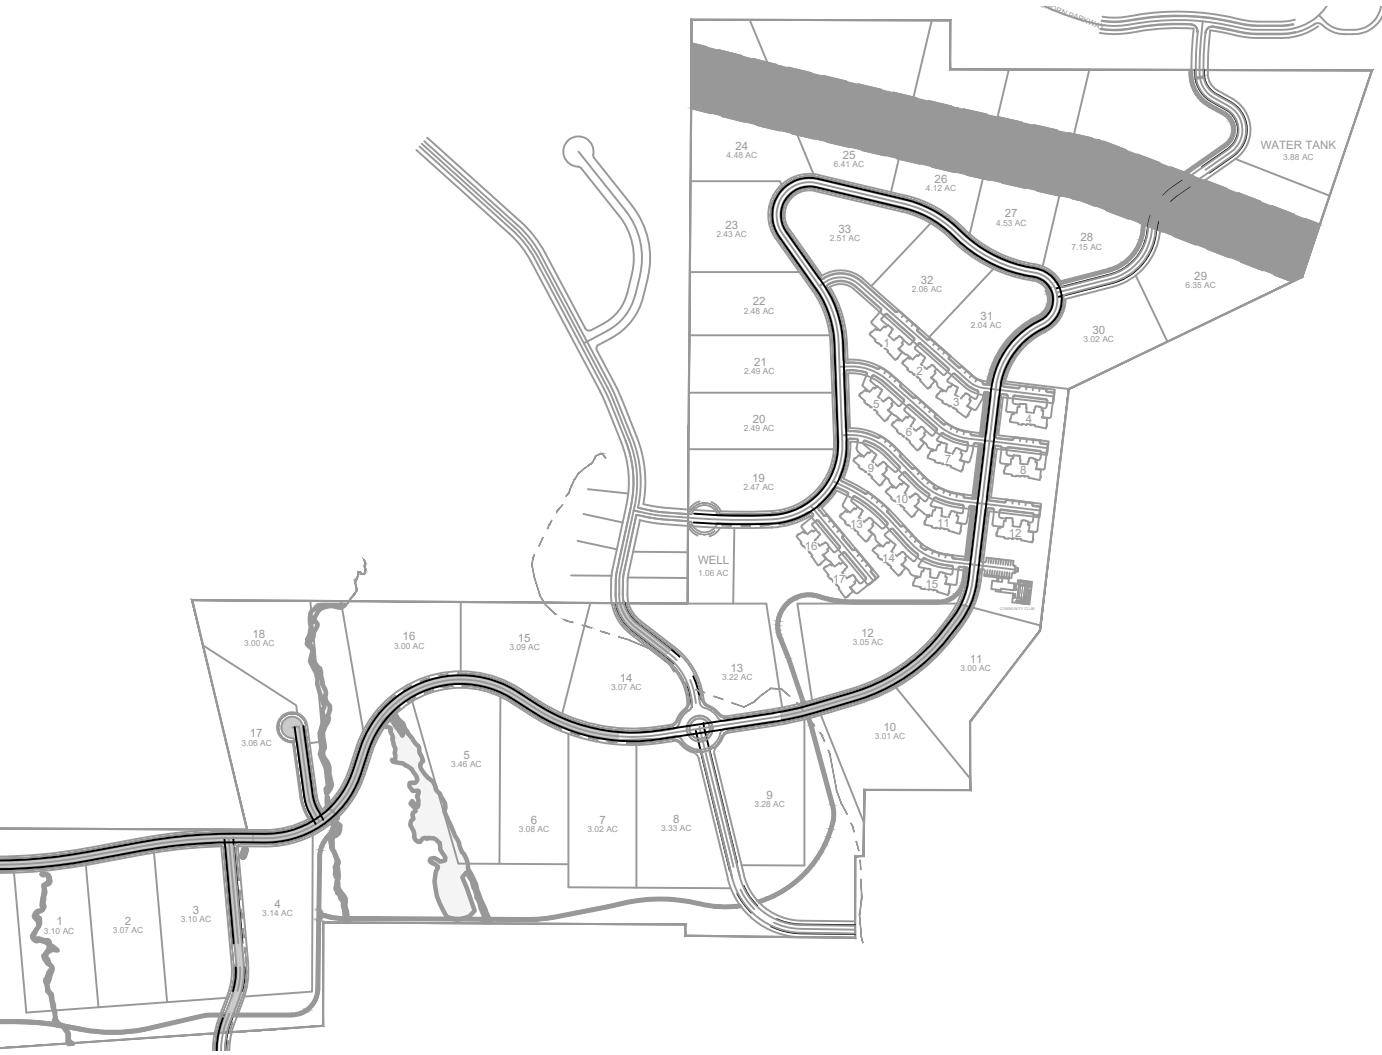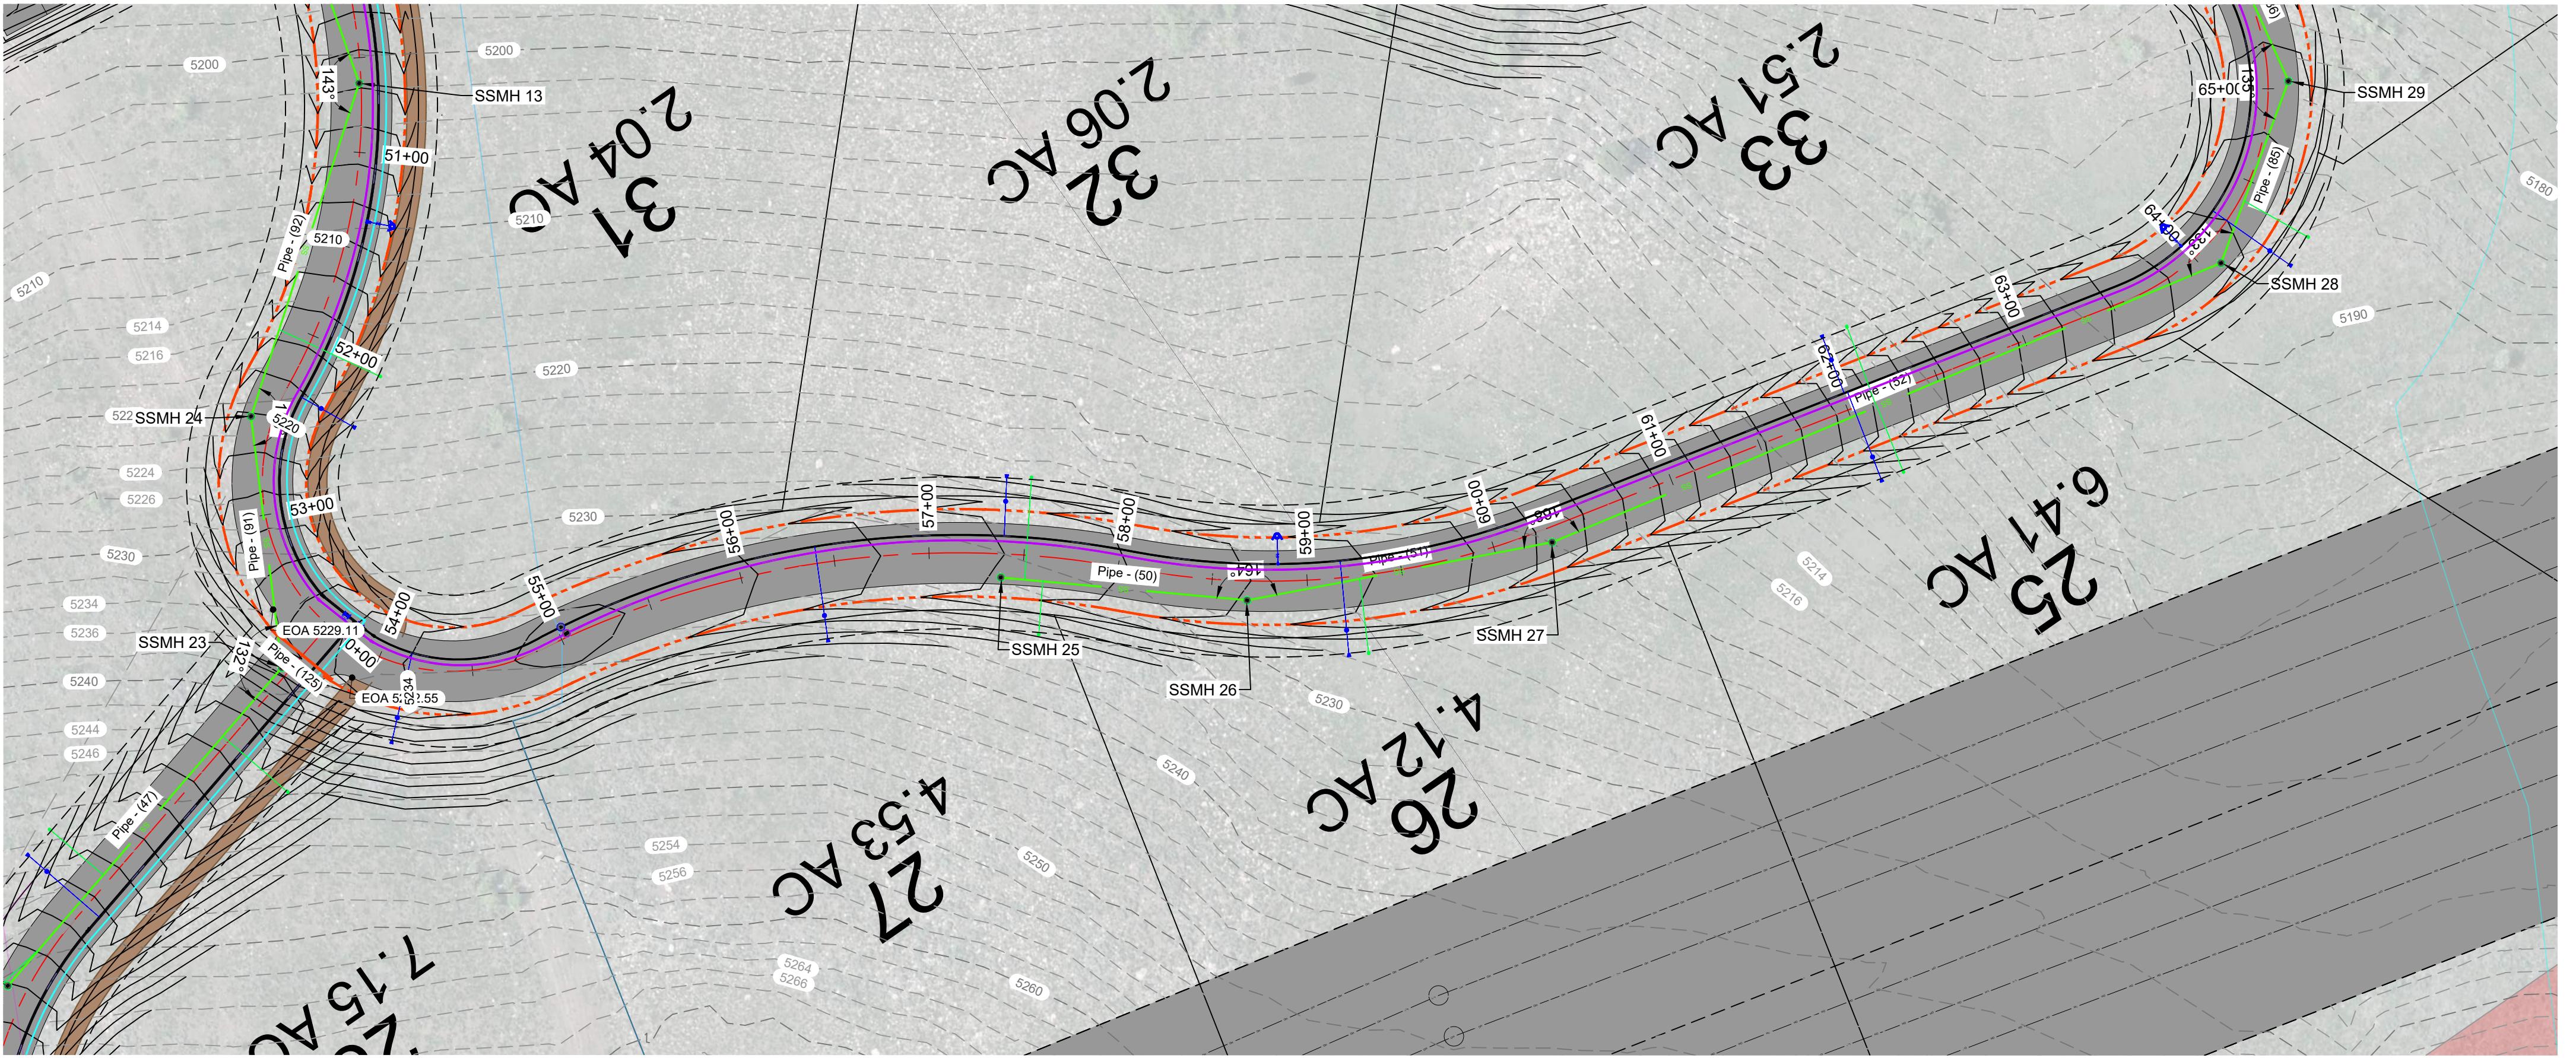



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DATE: 8-20-25
DESIGN: KANJH
DRAWN: KANJH
CHECKED: RC

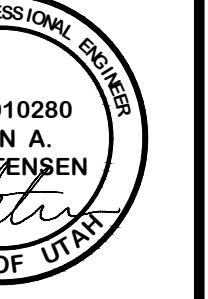


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PLAN AND PROFILE




SCALE: 1" = 60'	DATE: 8-20-25
DESIGN: KANJH	DRAWN: KANJH
CHECKED: RC	DWG:

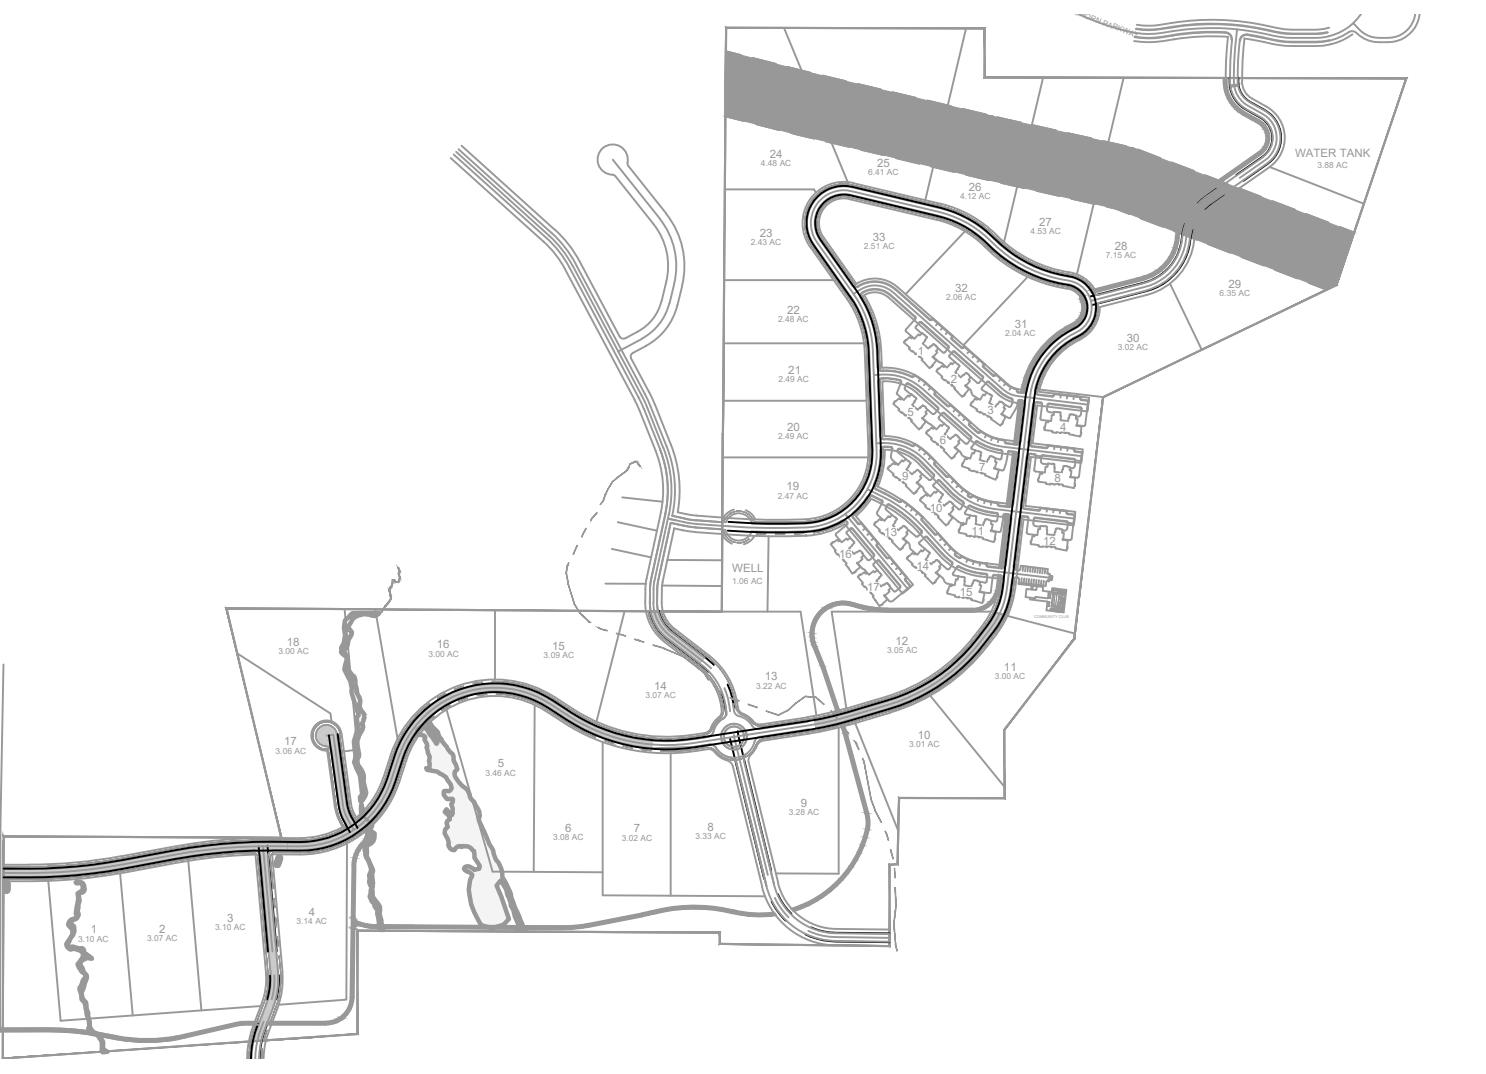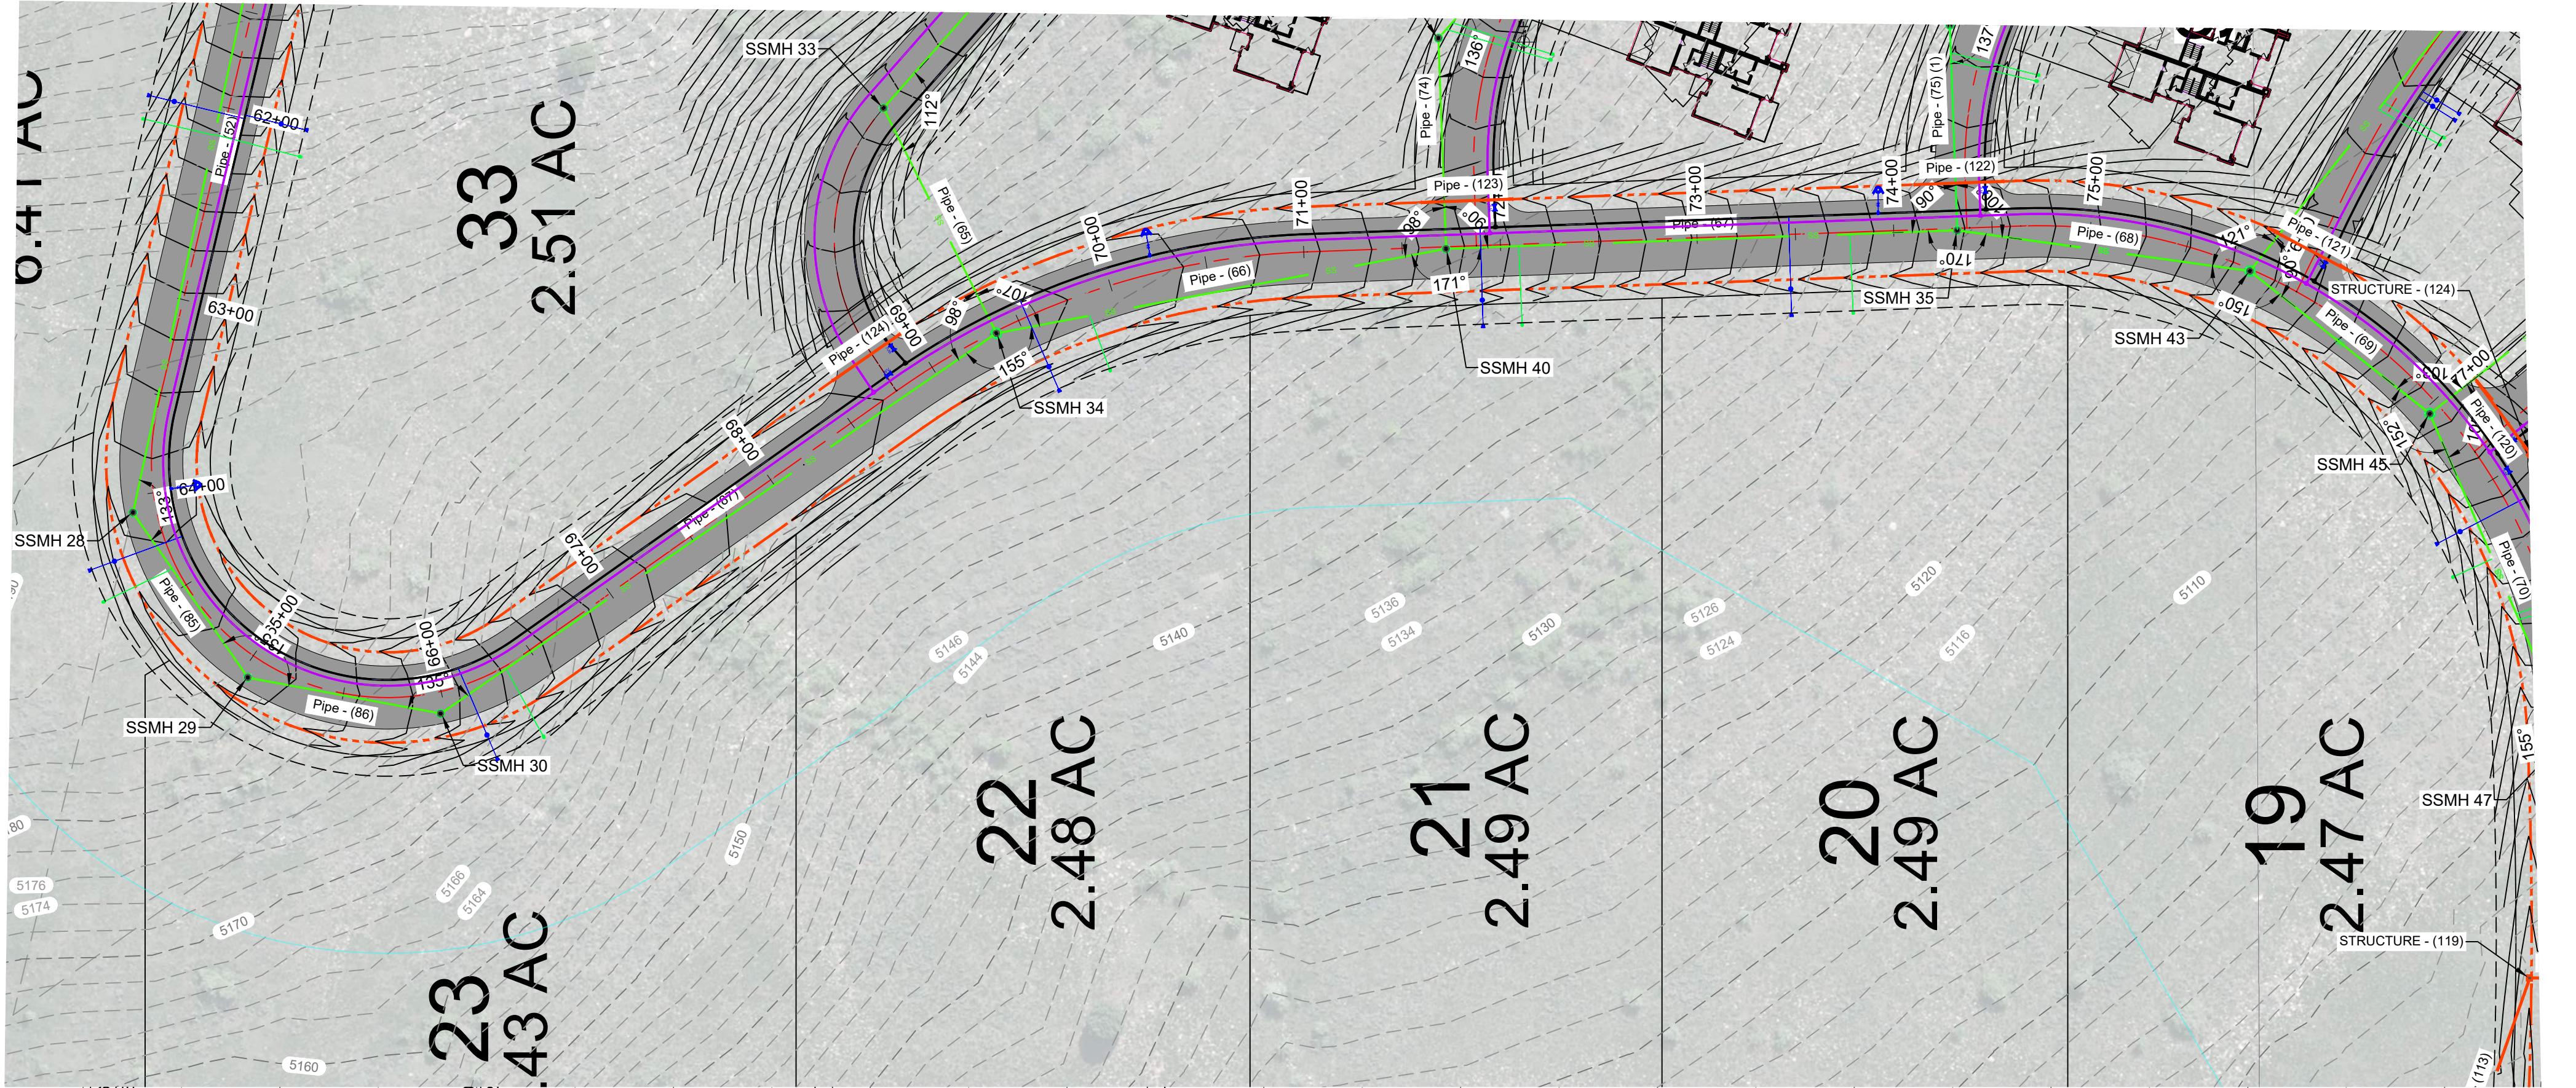

No. 8010280
RYAN A.
CHRISTENSEN
STATE OF UTAH
[Signature]


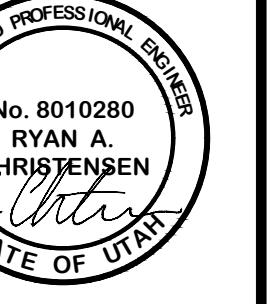
PLAN AND PROFILE
COBABE RANCH
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PP6

PLAN AND PROFILE

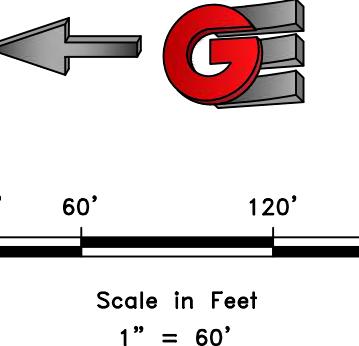


REVISIONS	DESCRIPTION
DATE	DATE
DESIGN	KAN/JKH
DRAWN	KAN/JKH
CHECKED	RC
DWG:	

REGISTERED PROFESSIONAL ENGINEER
No. 8010280
RYAN A.
CHRISTENSEN
STATE OF UTAH
[Signature]

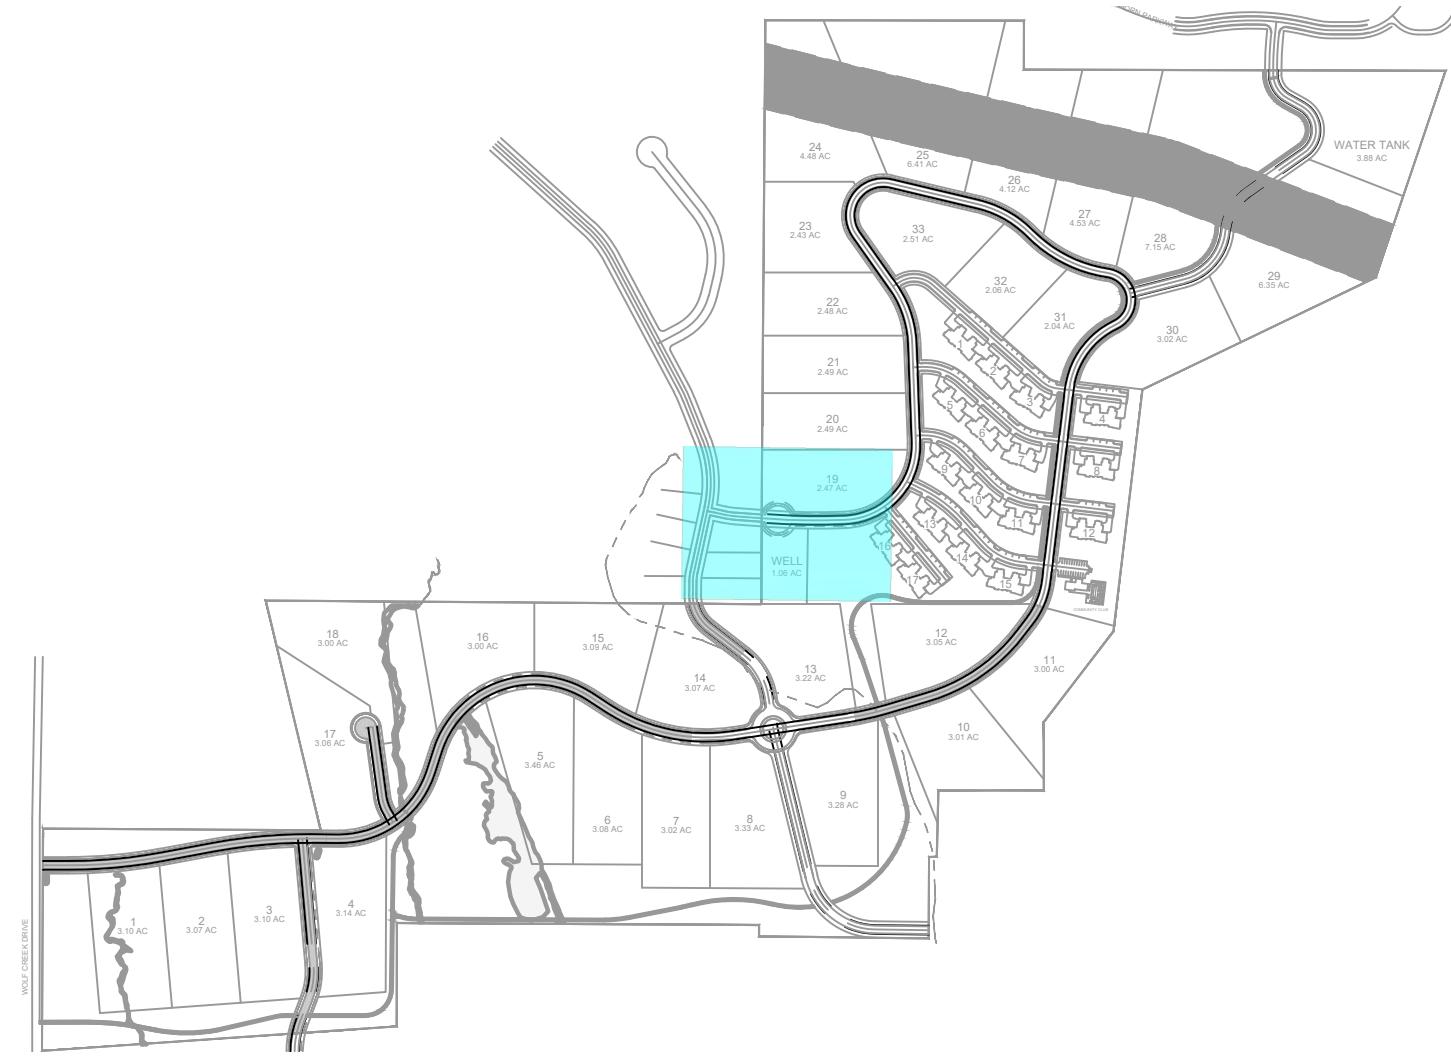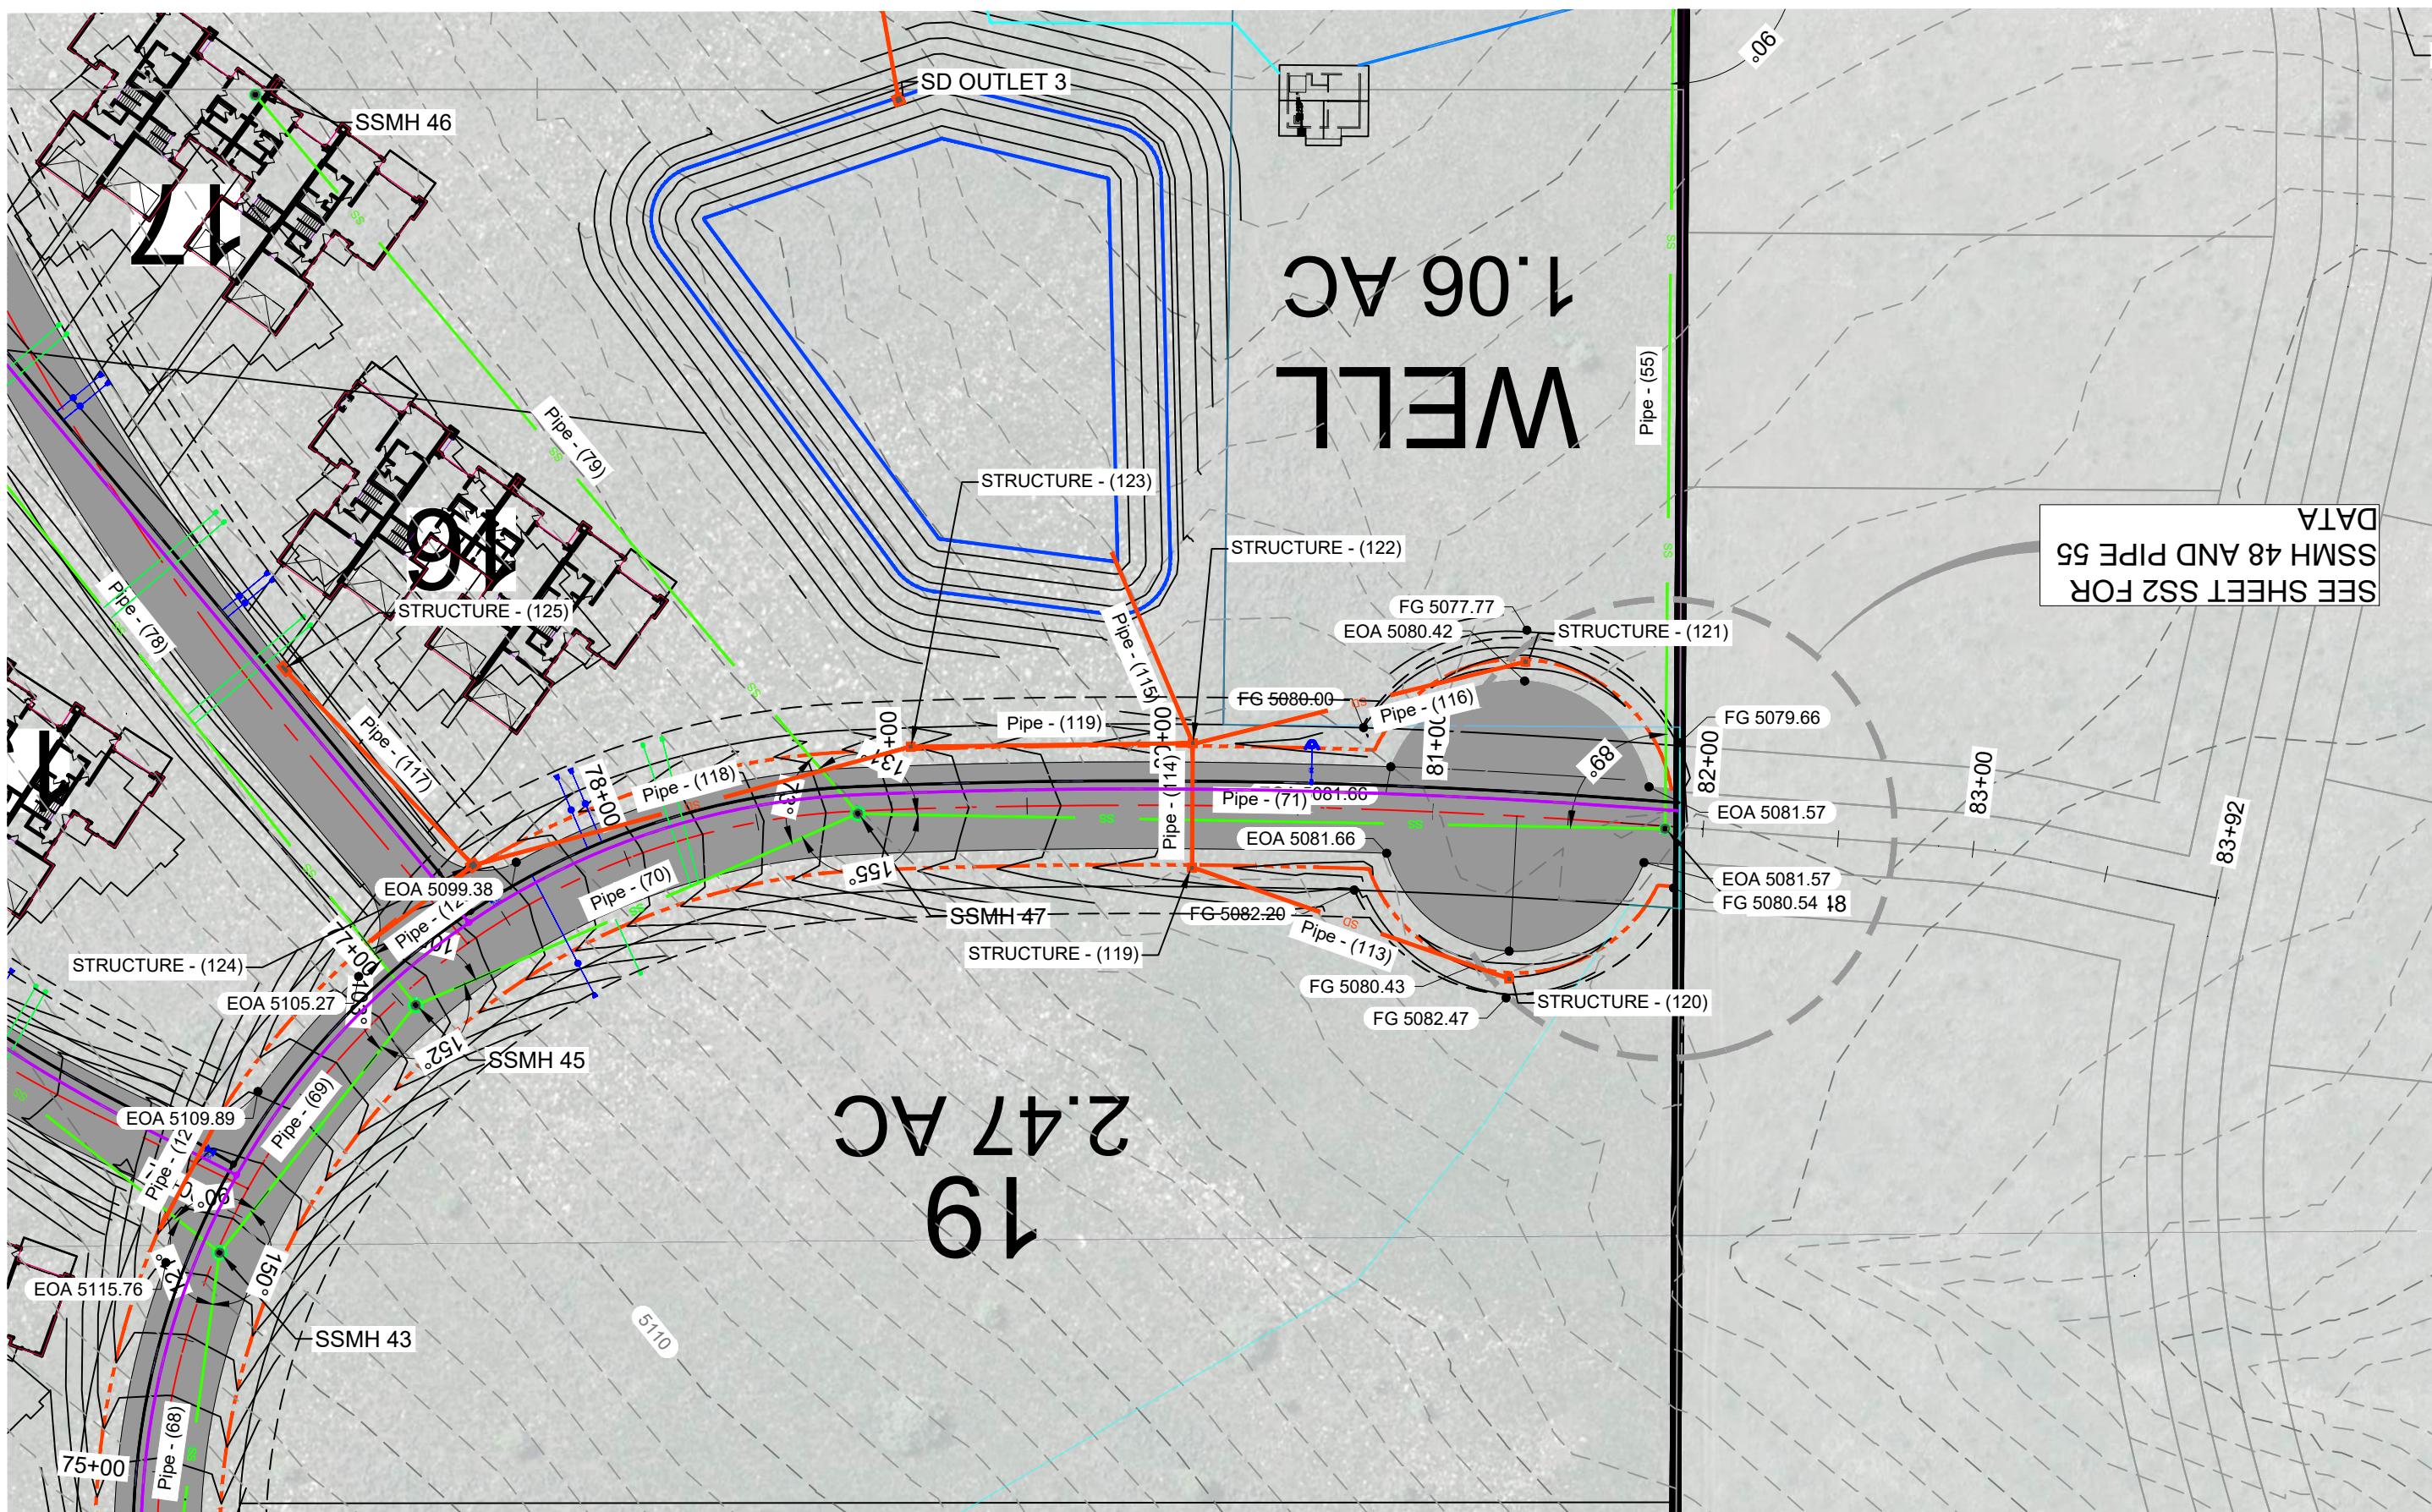
PLAN AND PROFILE
COBABE RANCH
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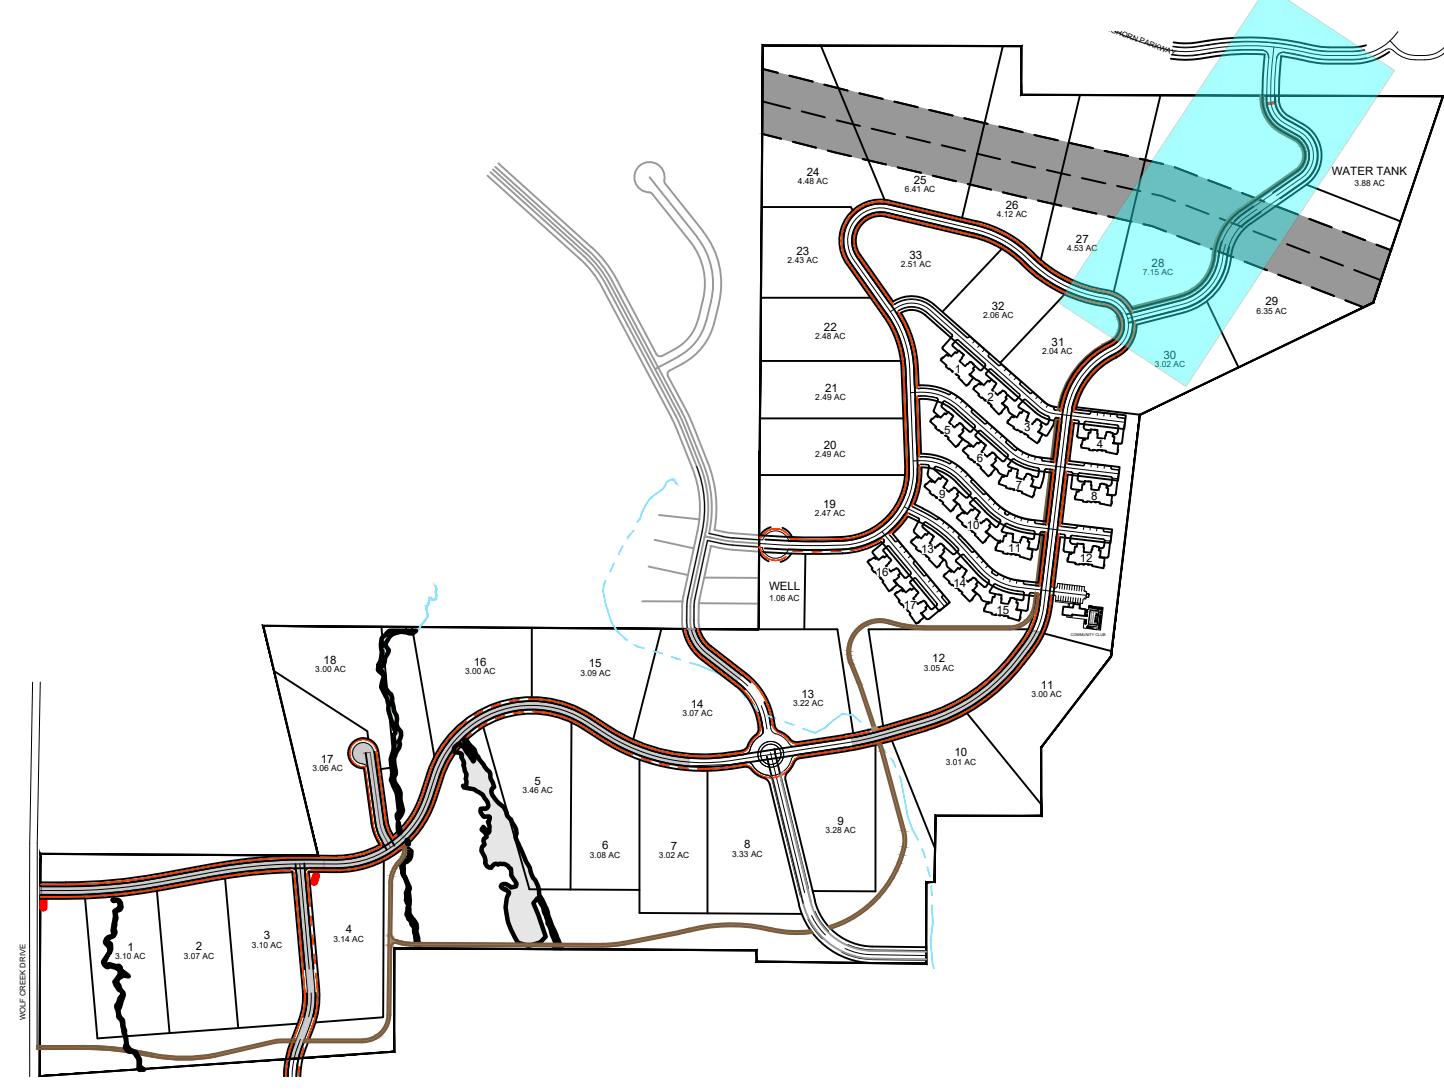
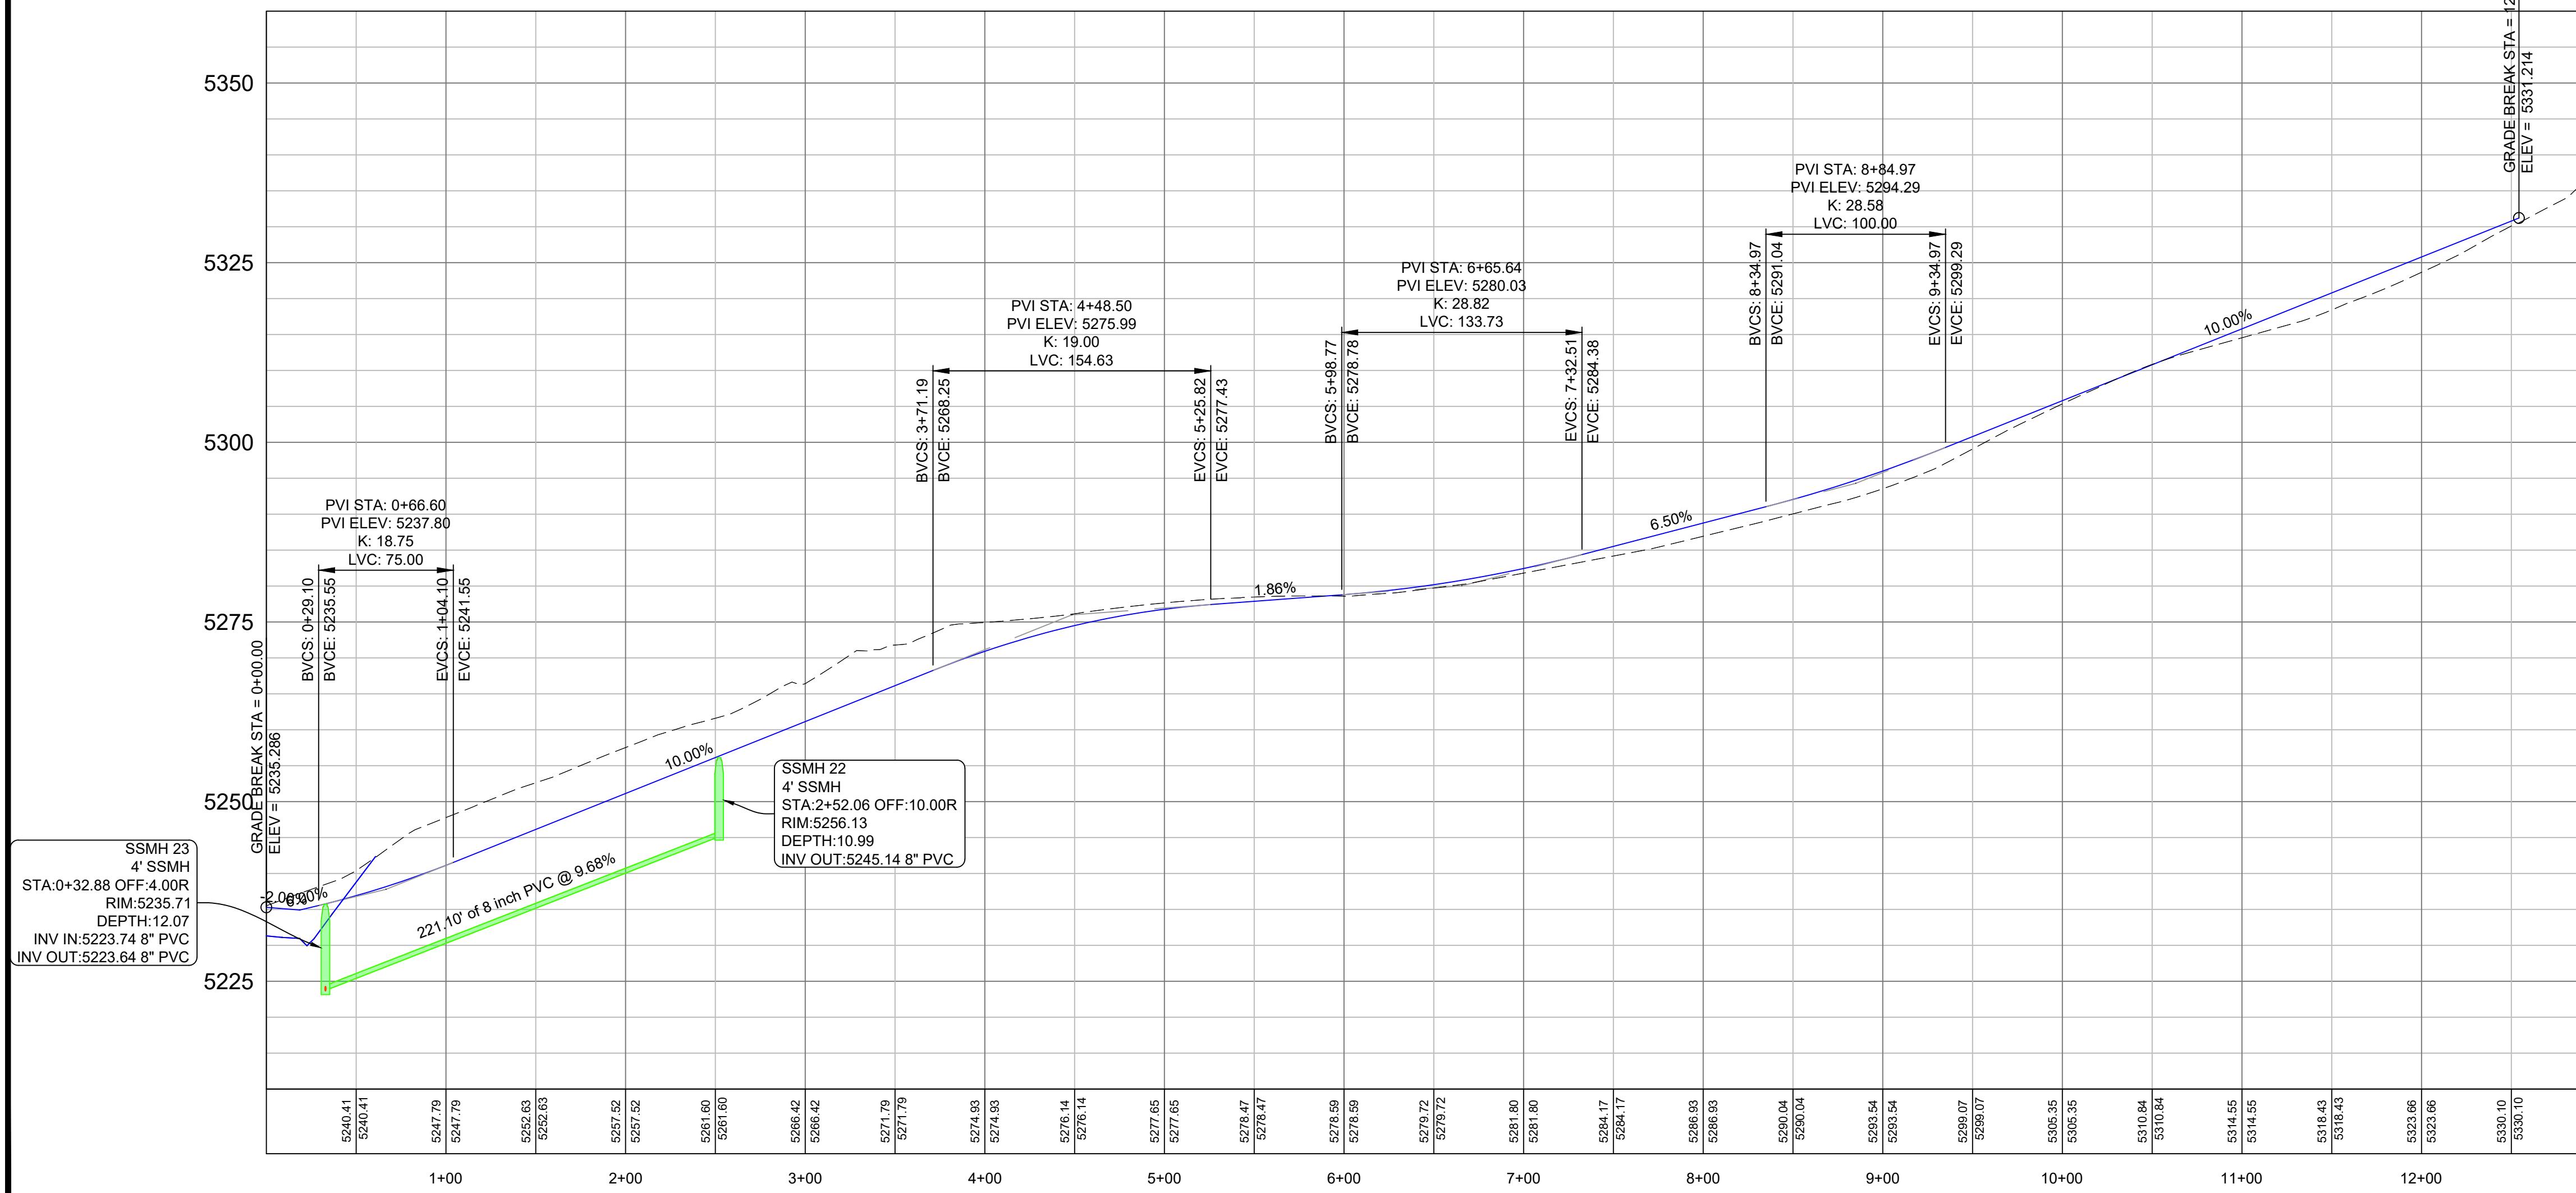
PP7



PLAN AND PROFILE

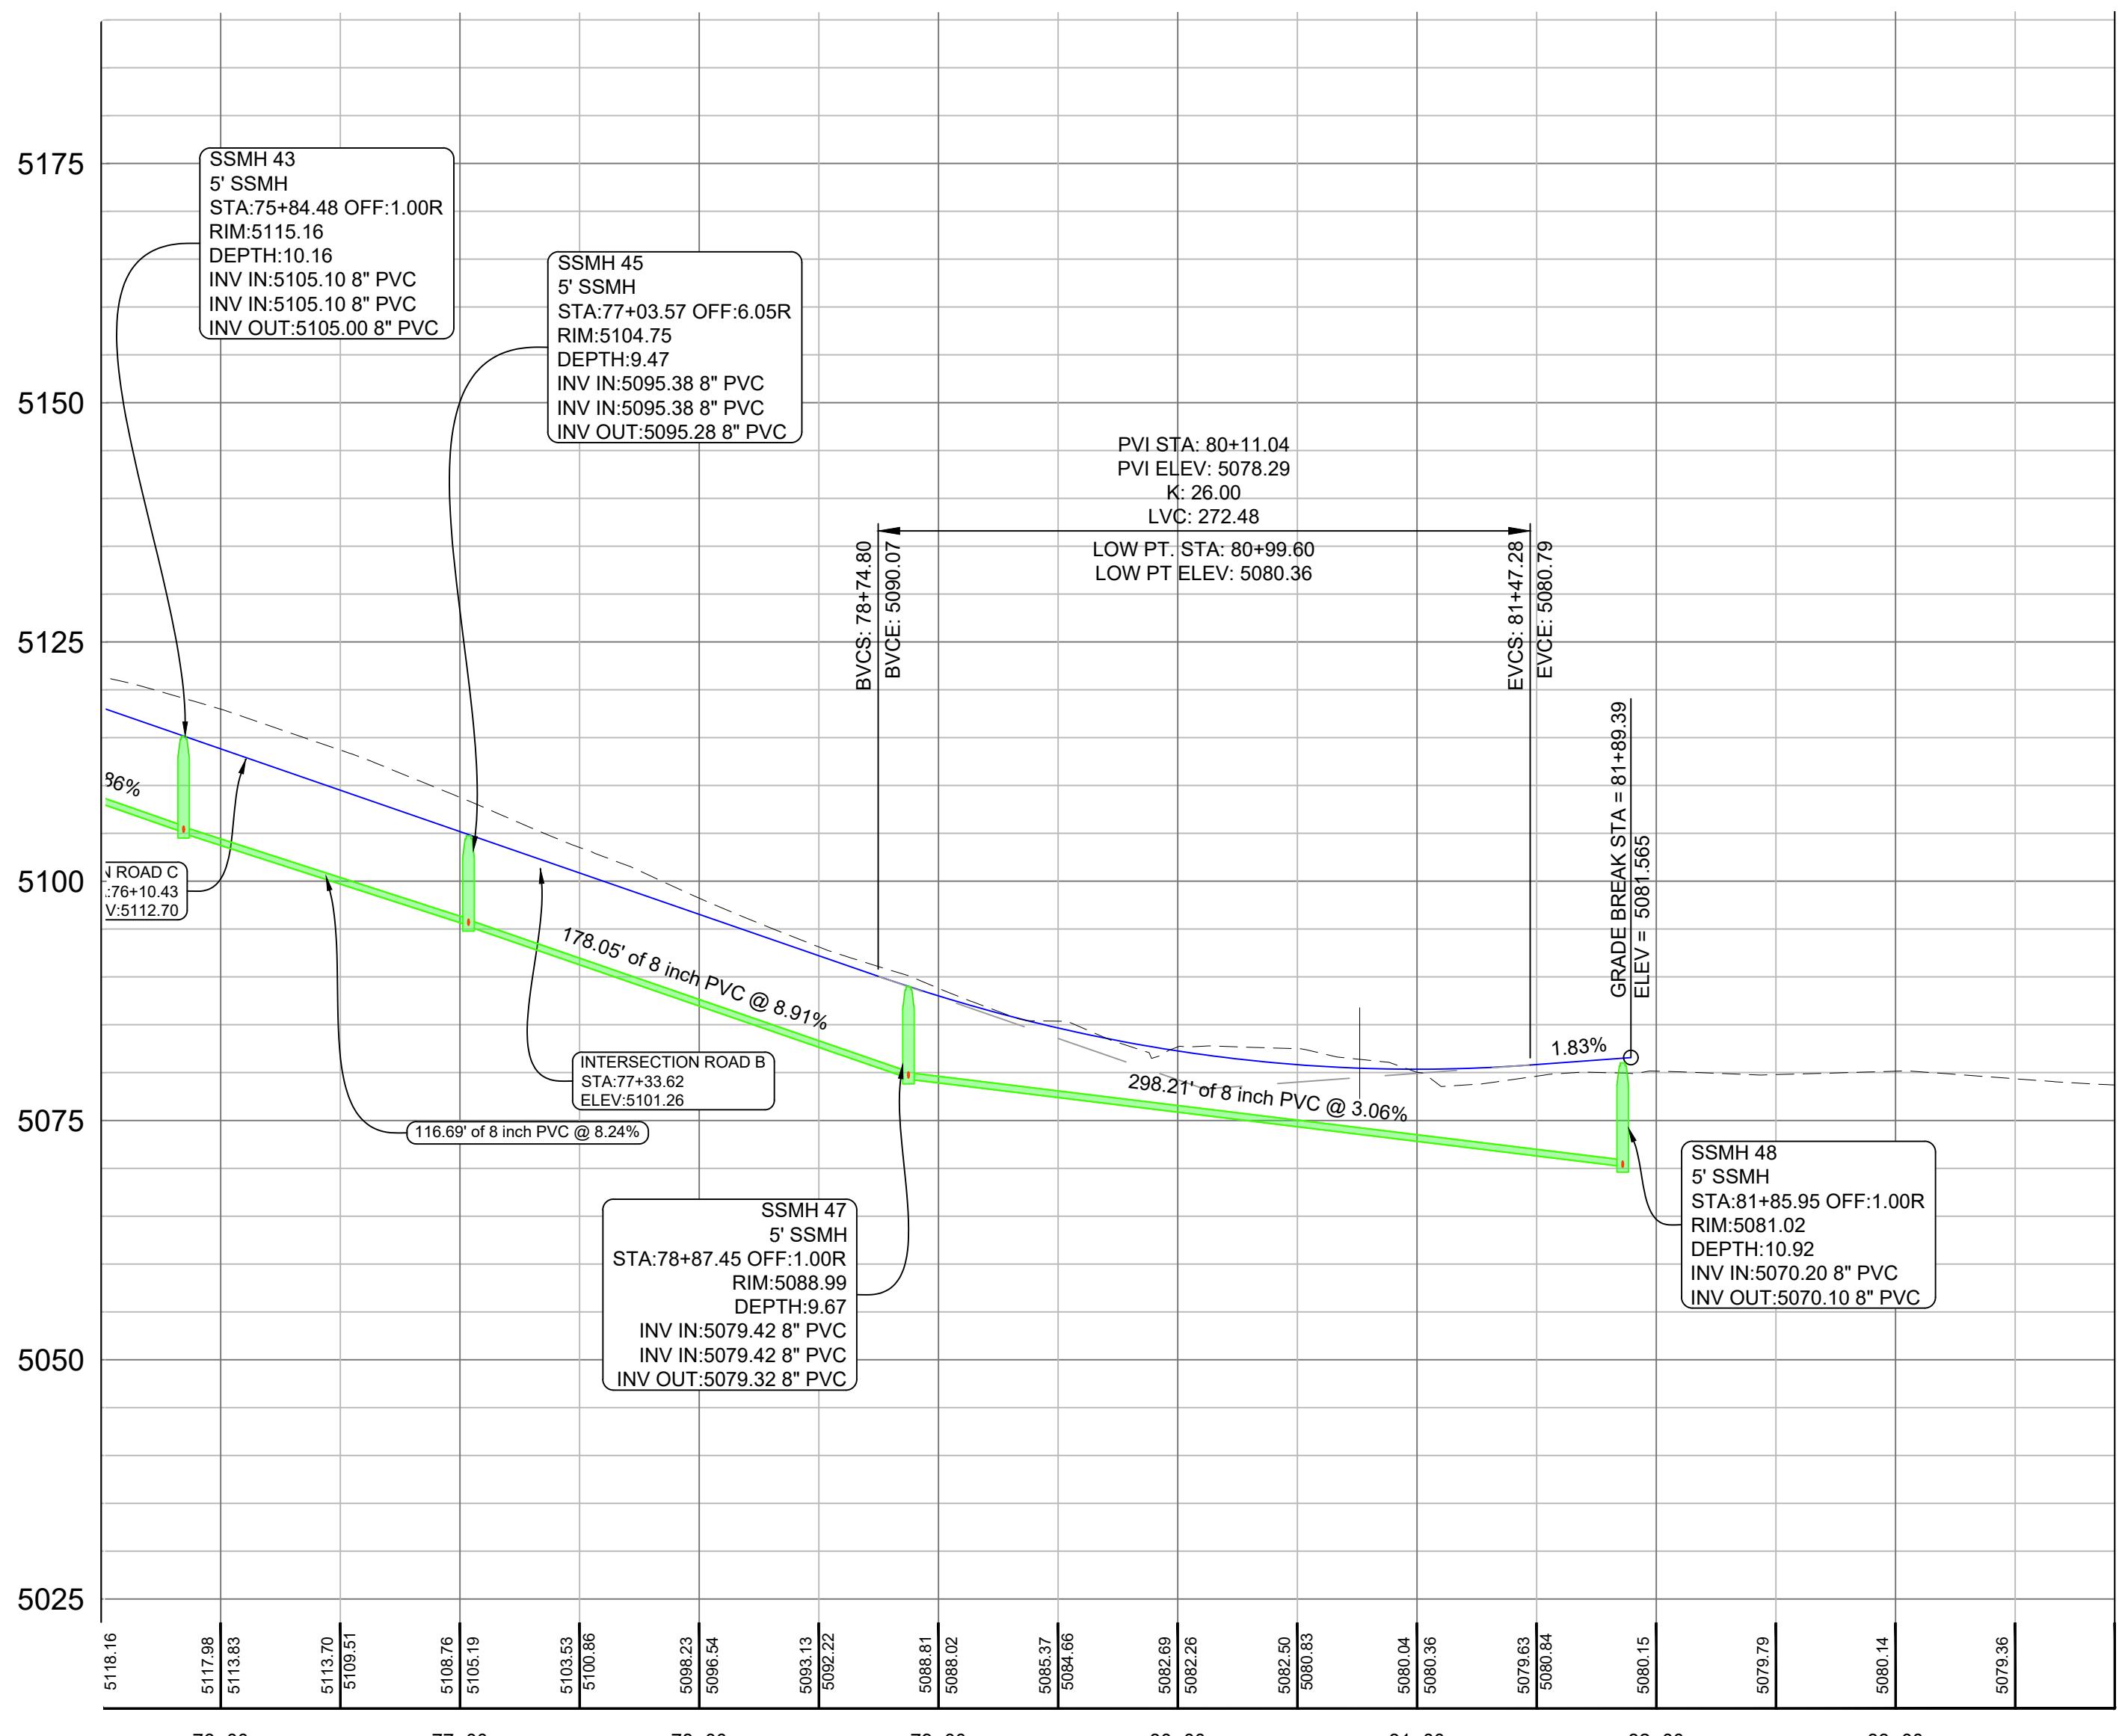

Cobabe to Trappers 3

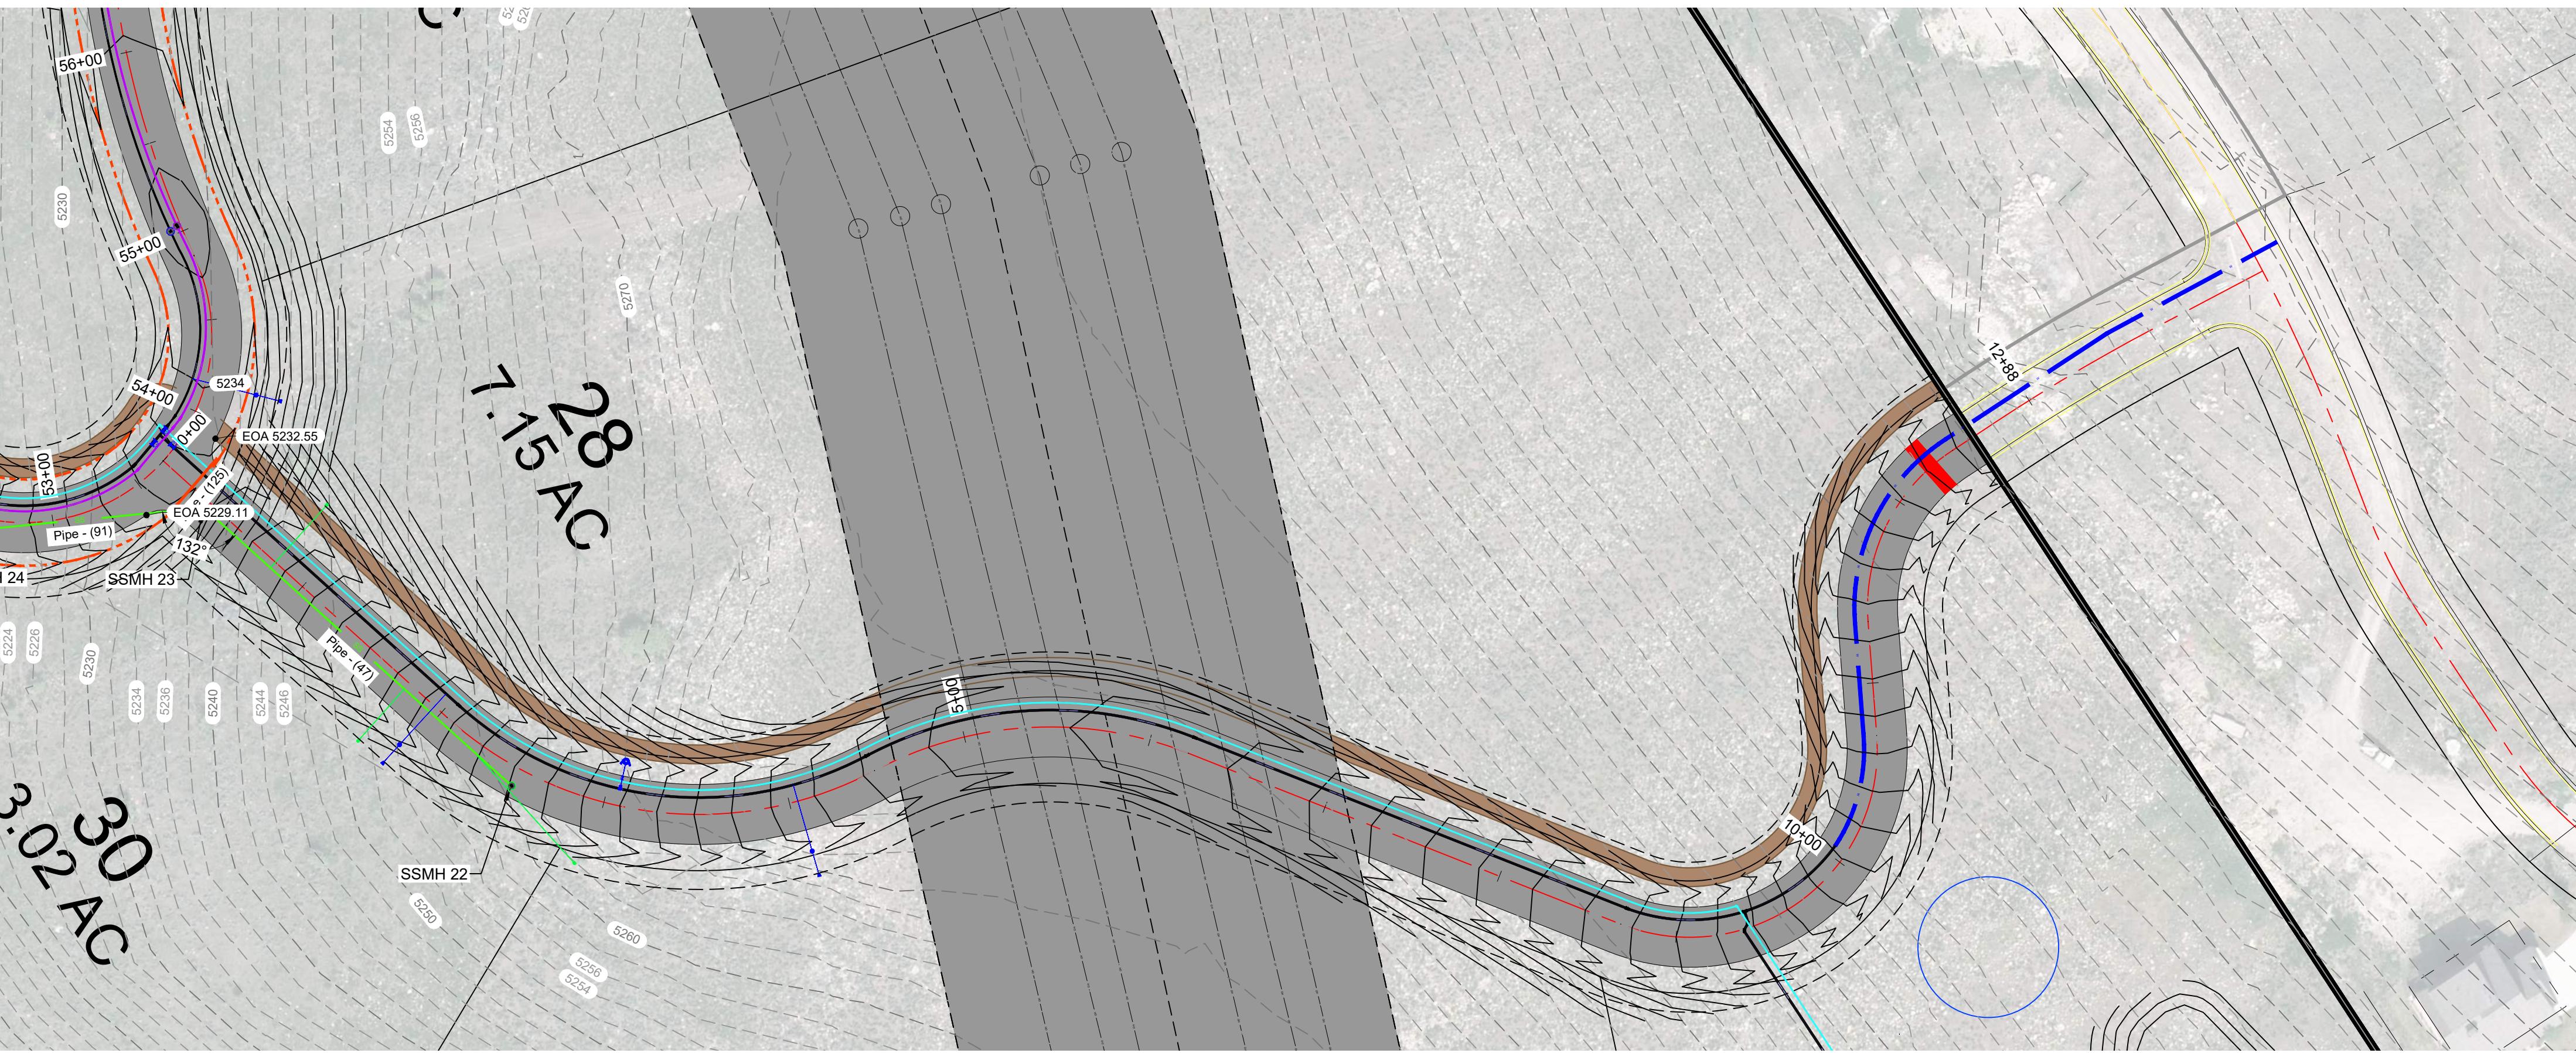


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PP8

REVISIONS	DATE	DESCRIPTION

SCALE: 1" = 60'
DATE: 8-20-25
DESIGN: KANJH
DRAWN: KANJH
CHECKED: RC

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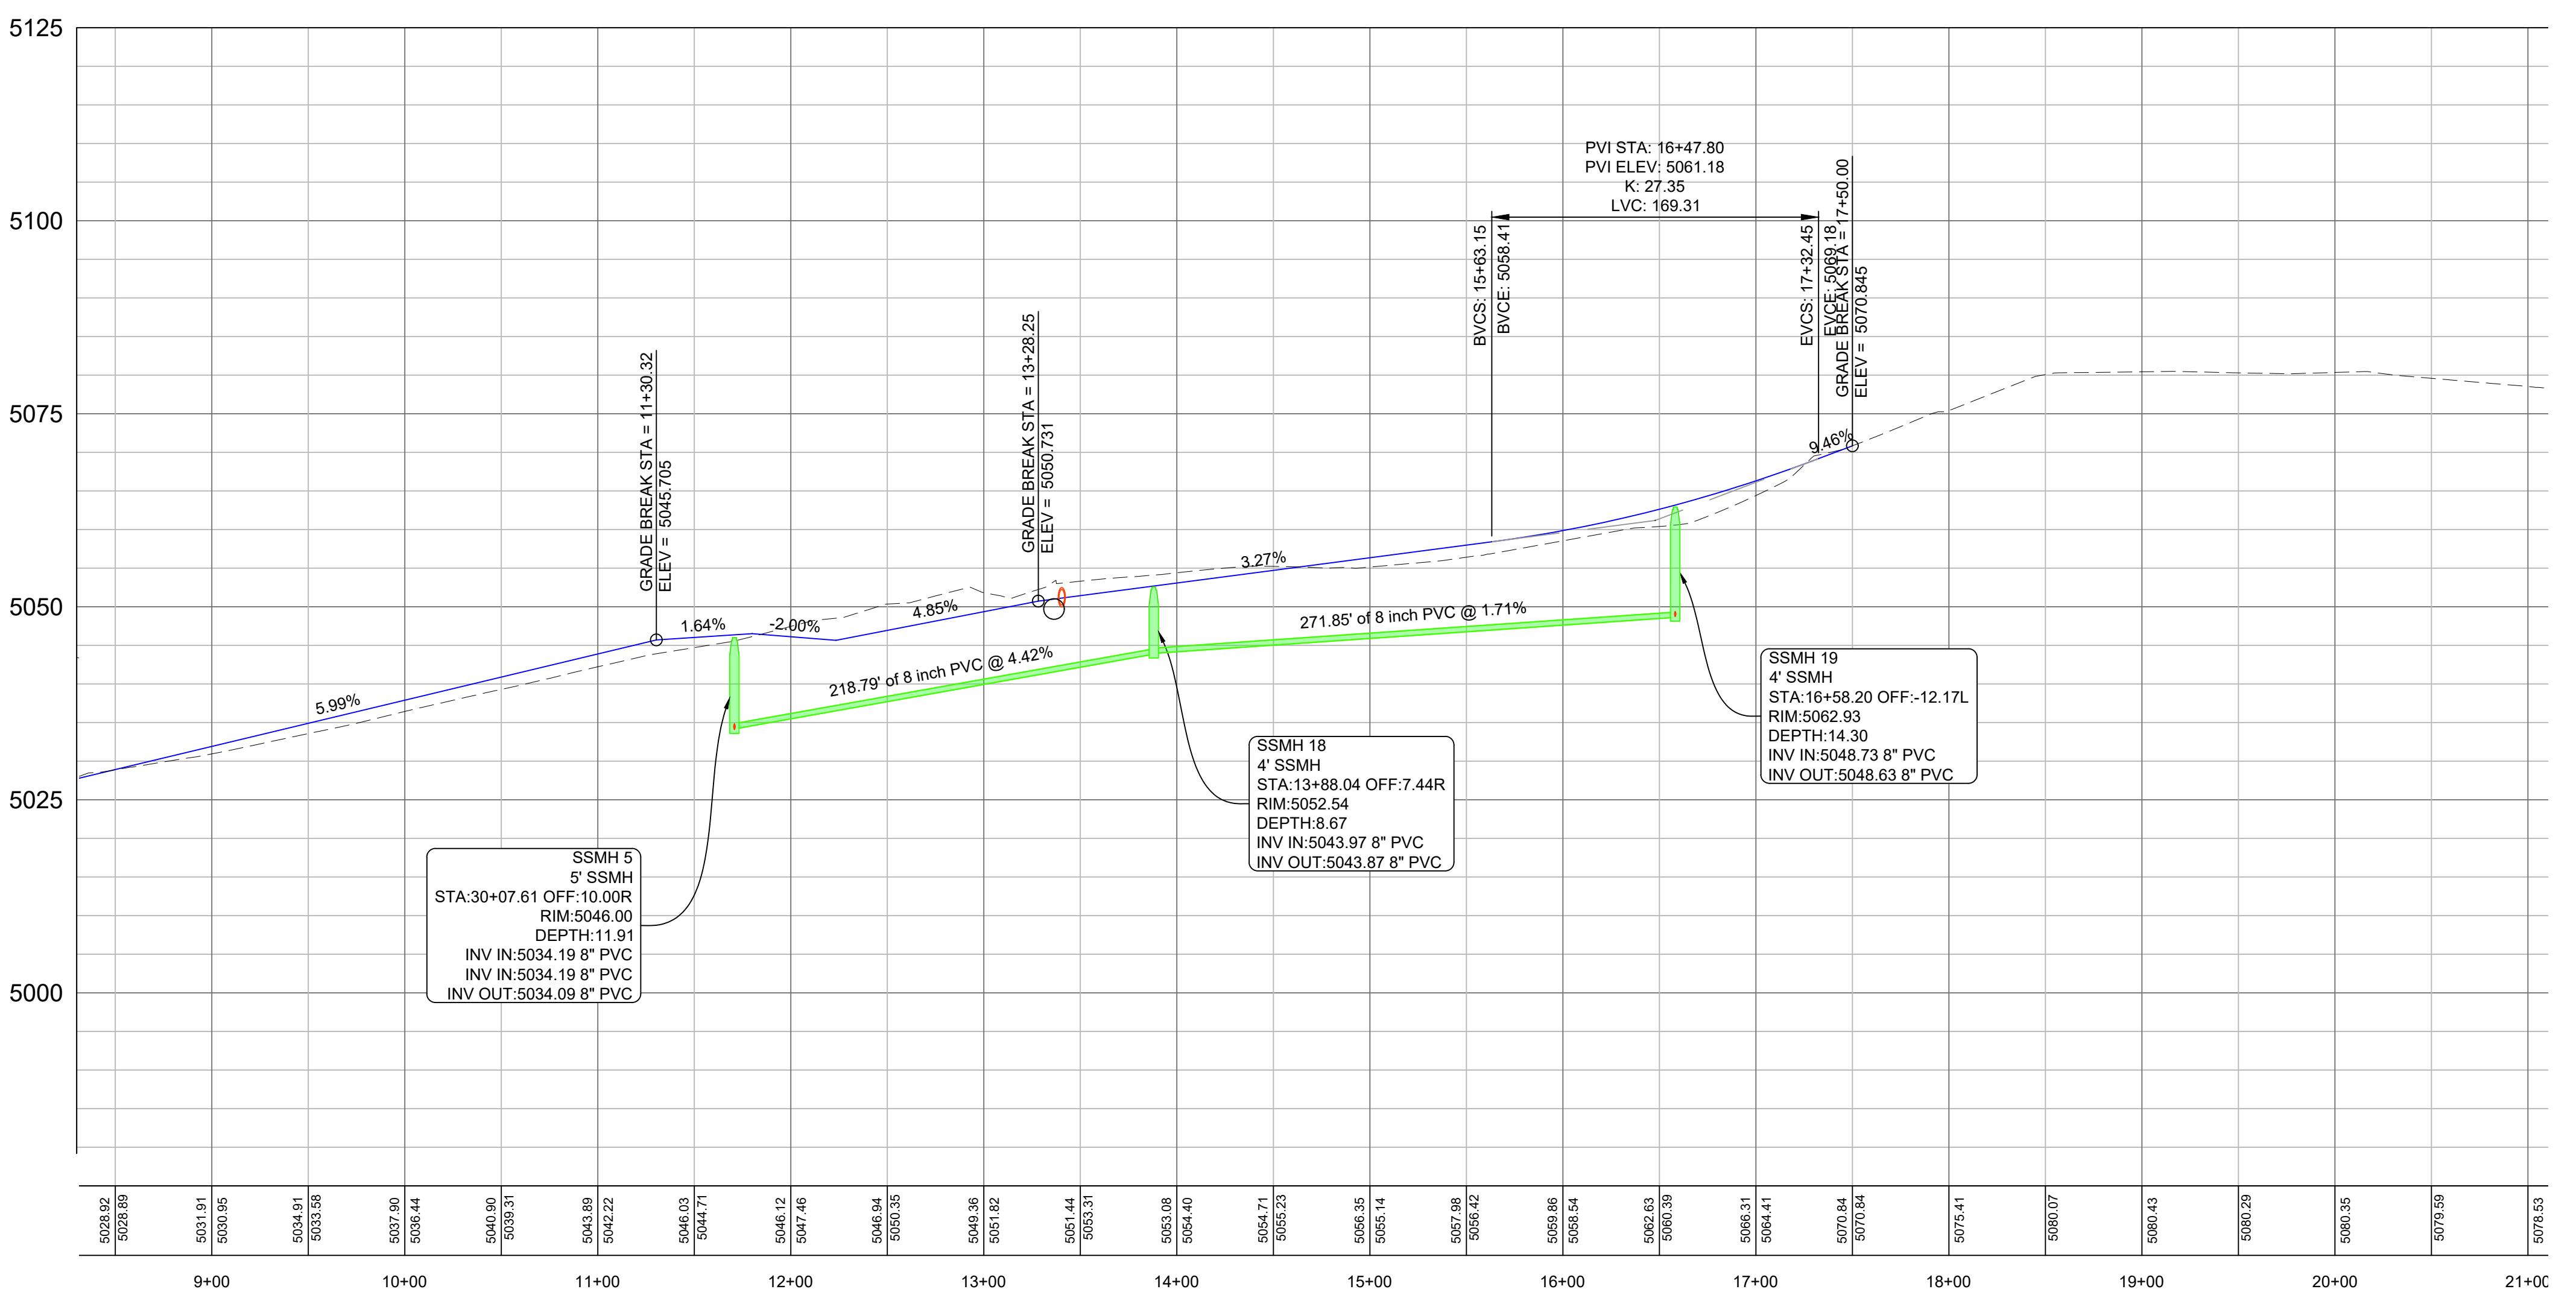
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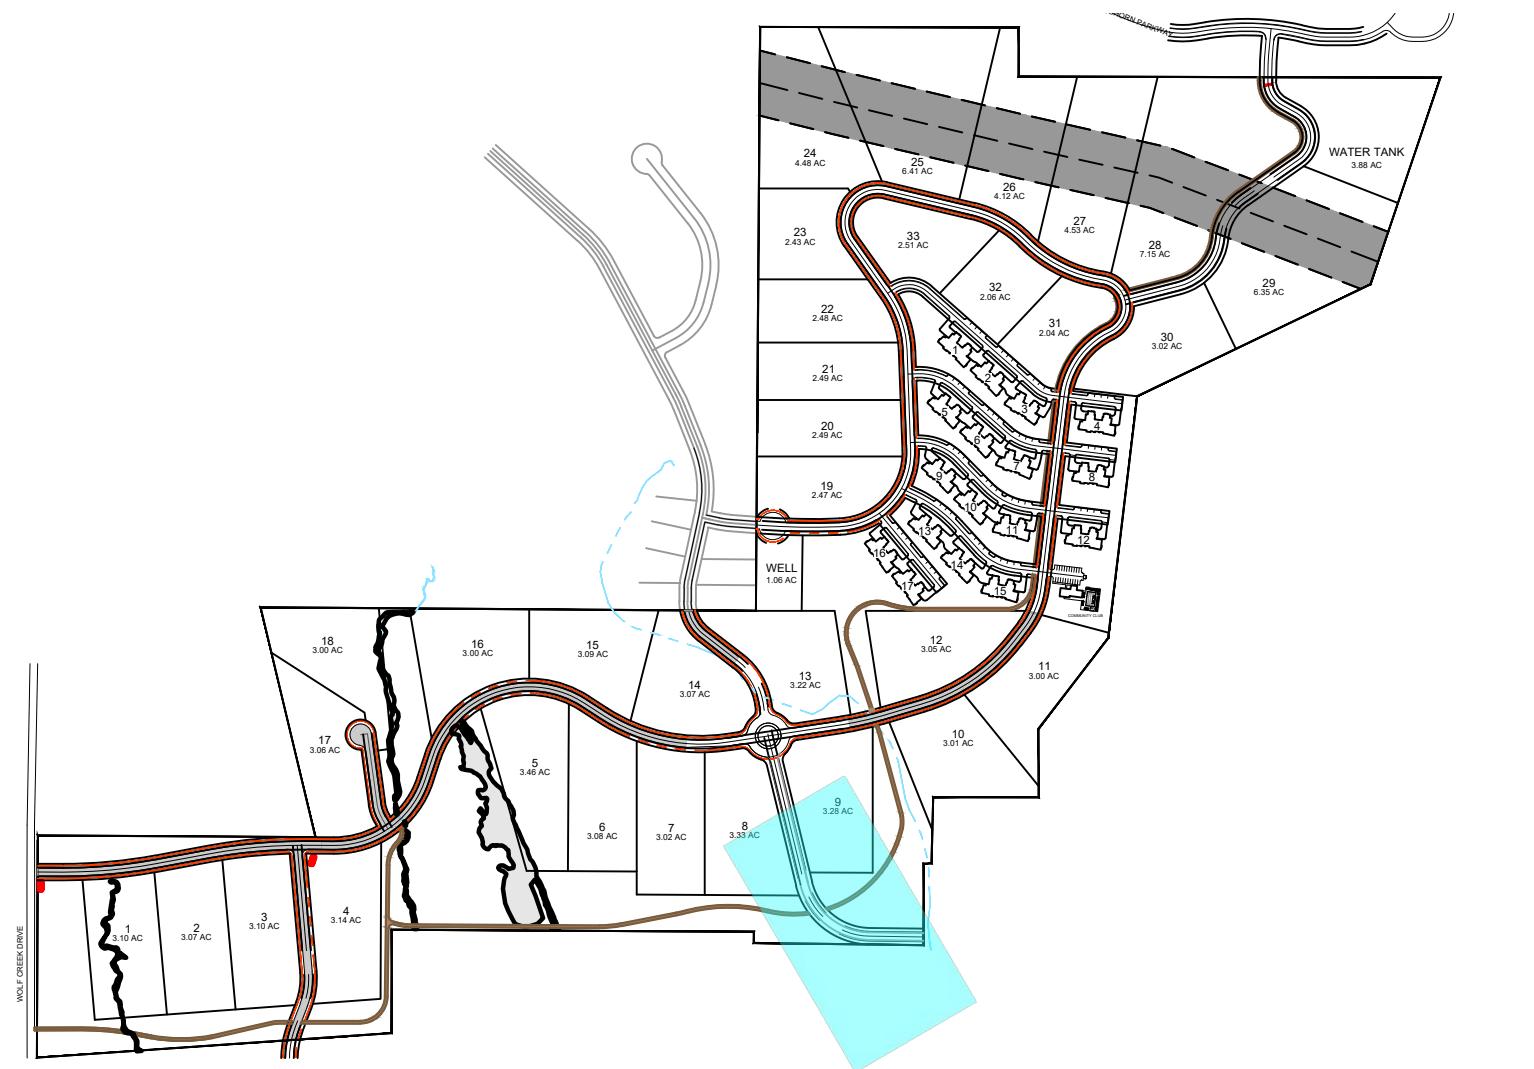
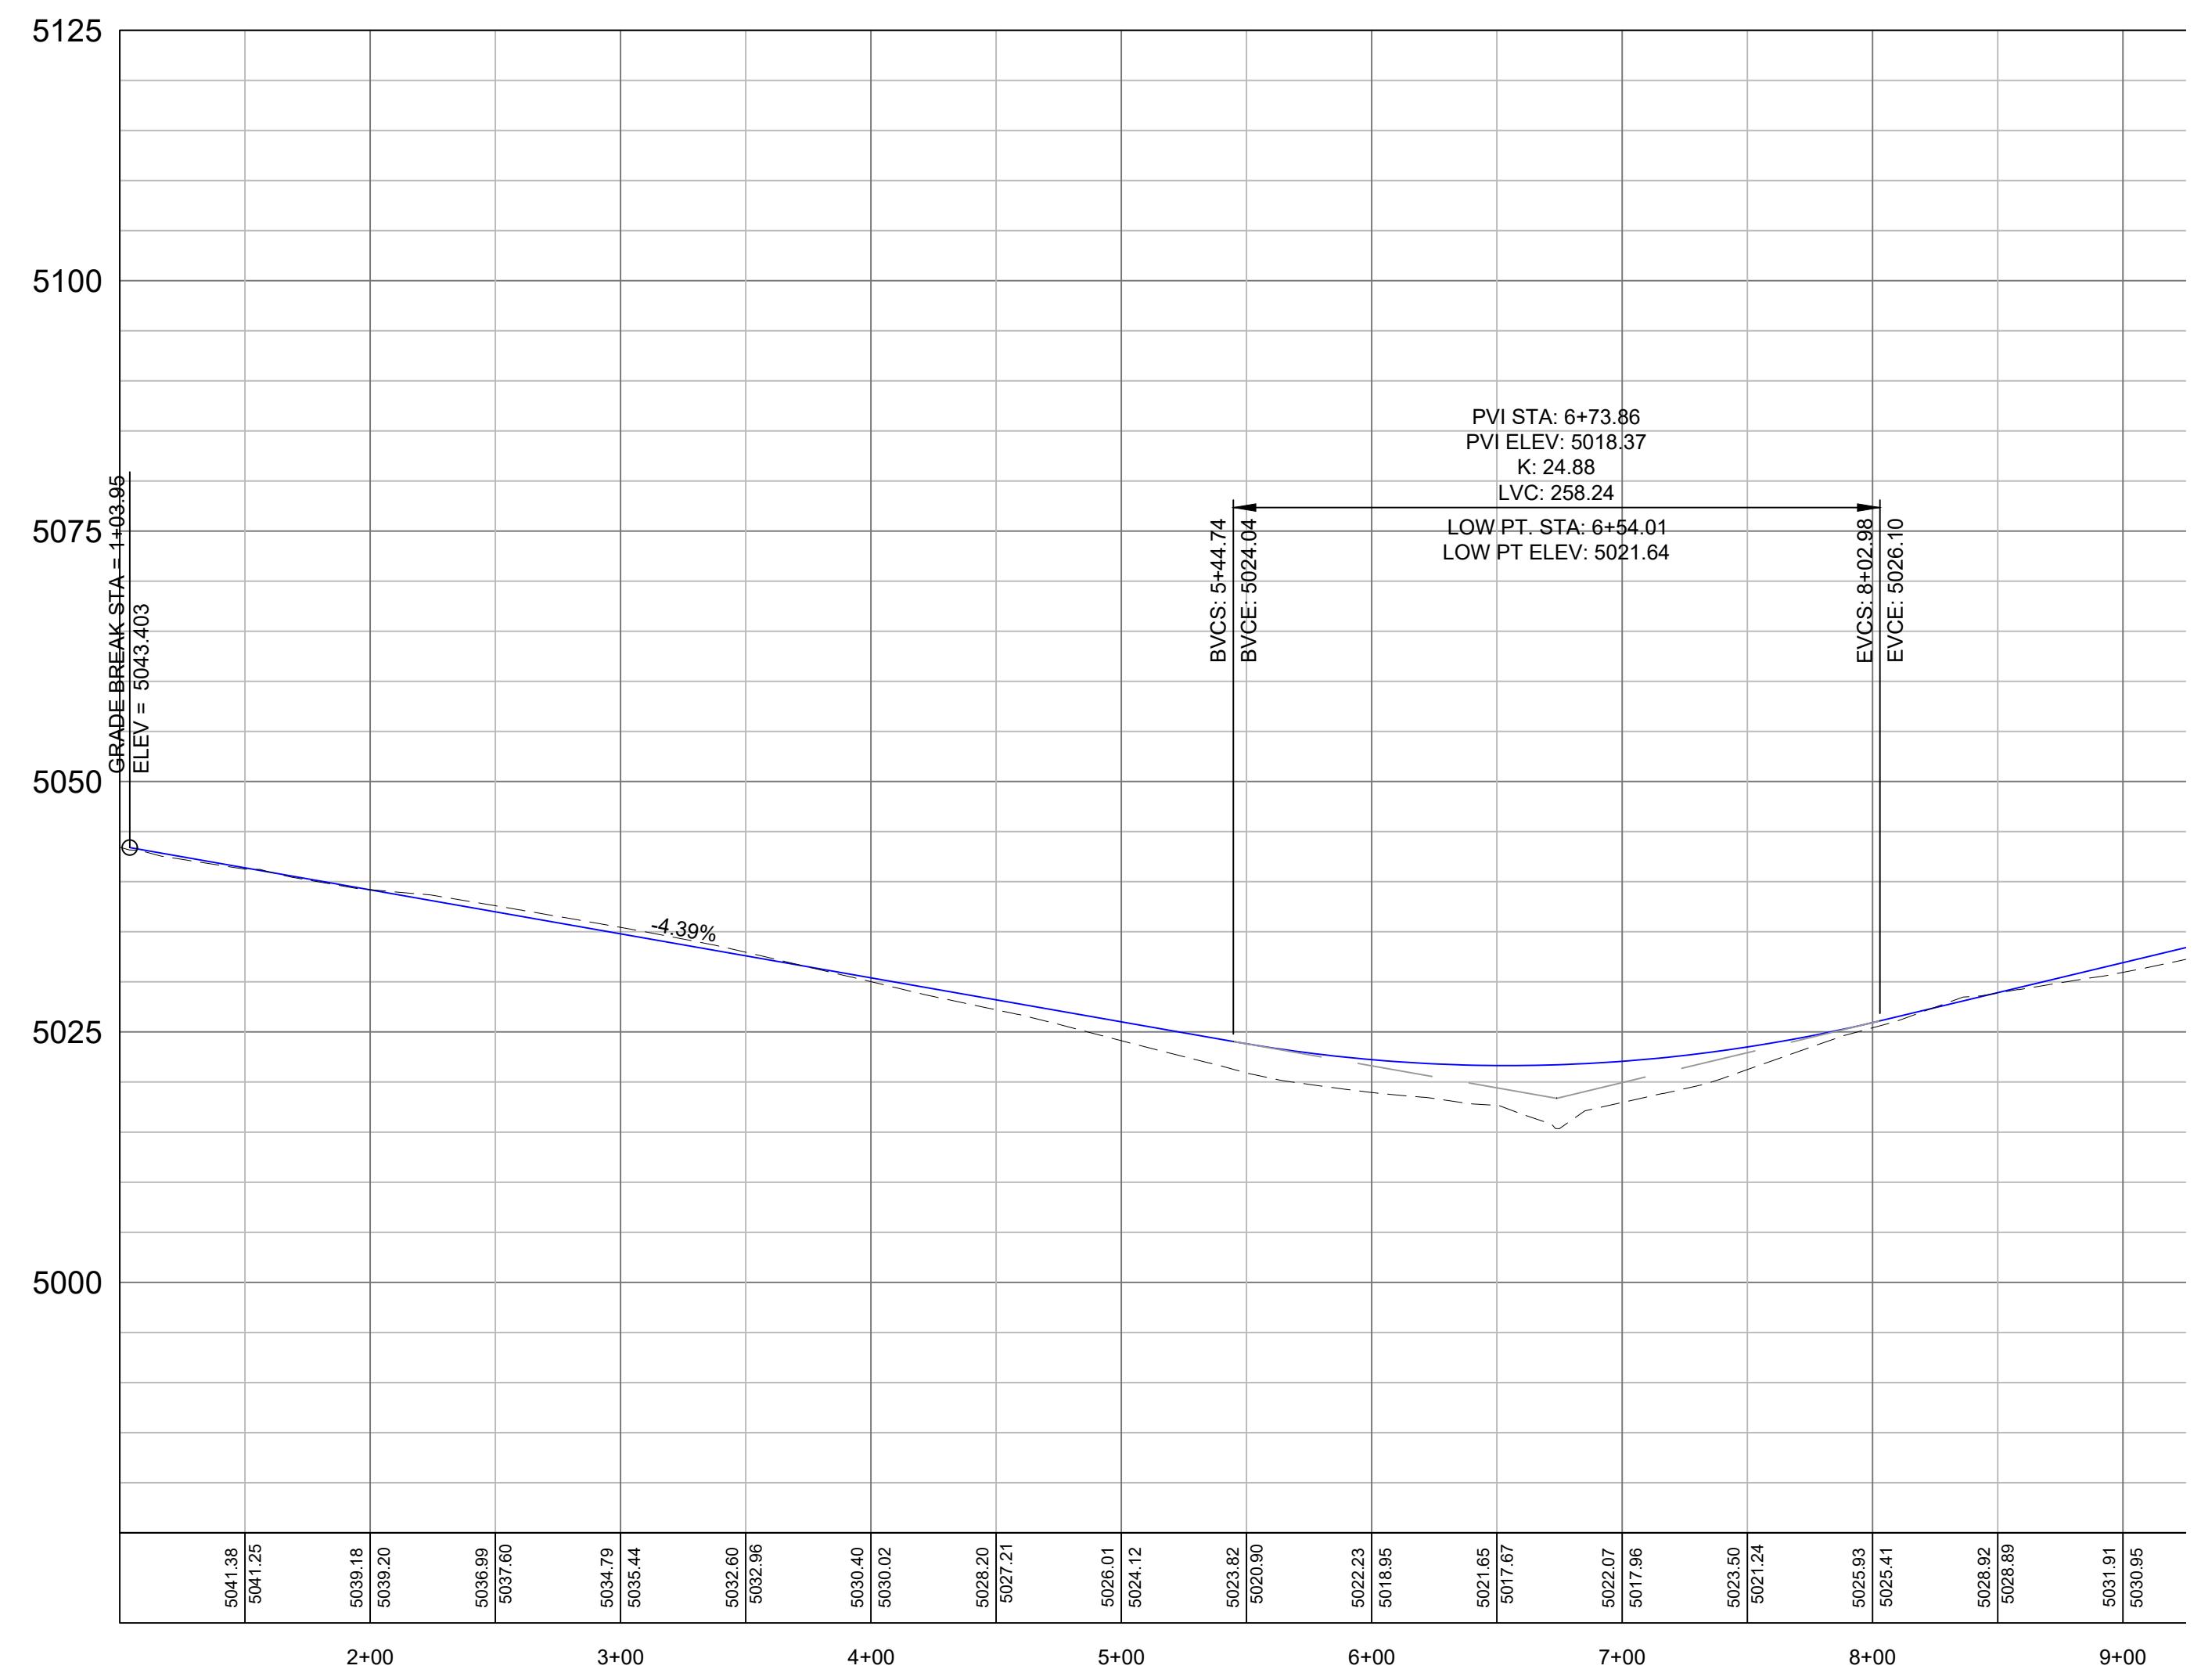
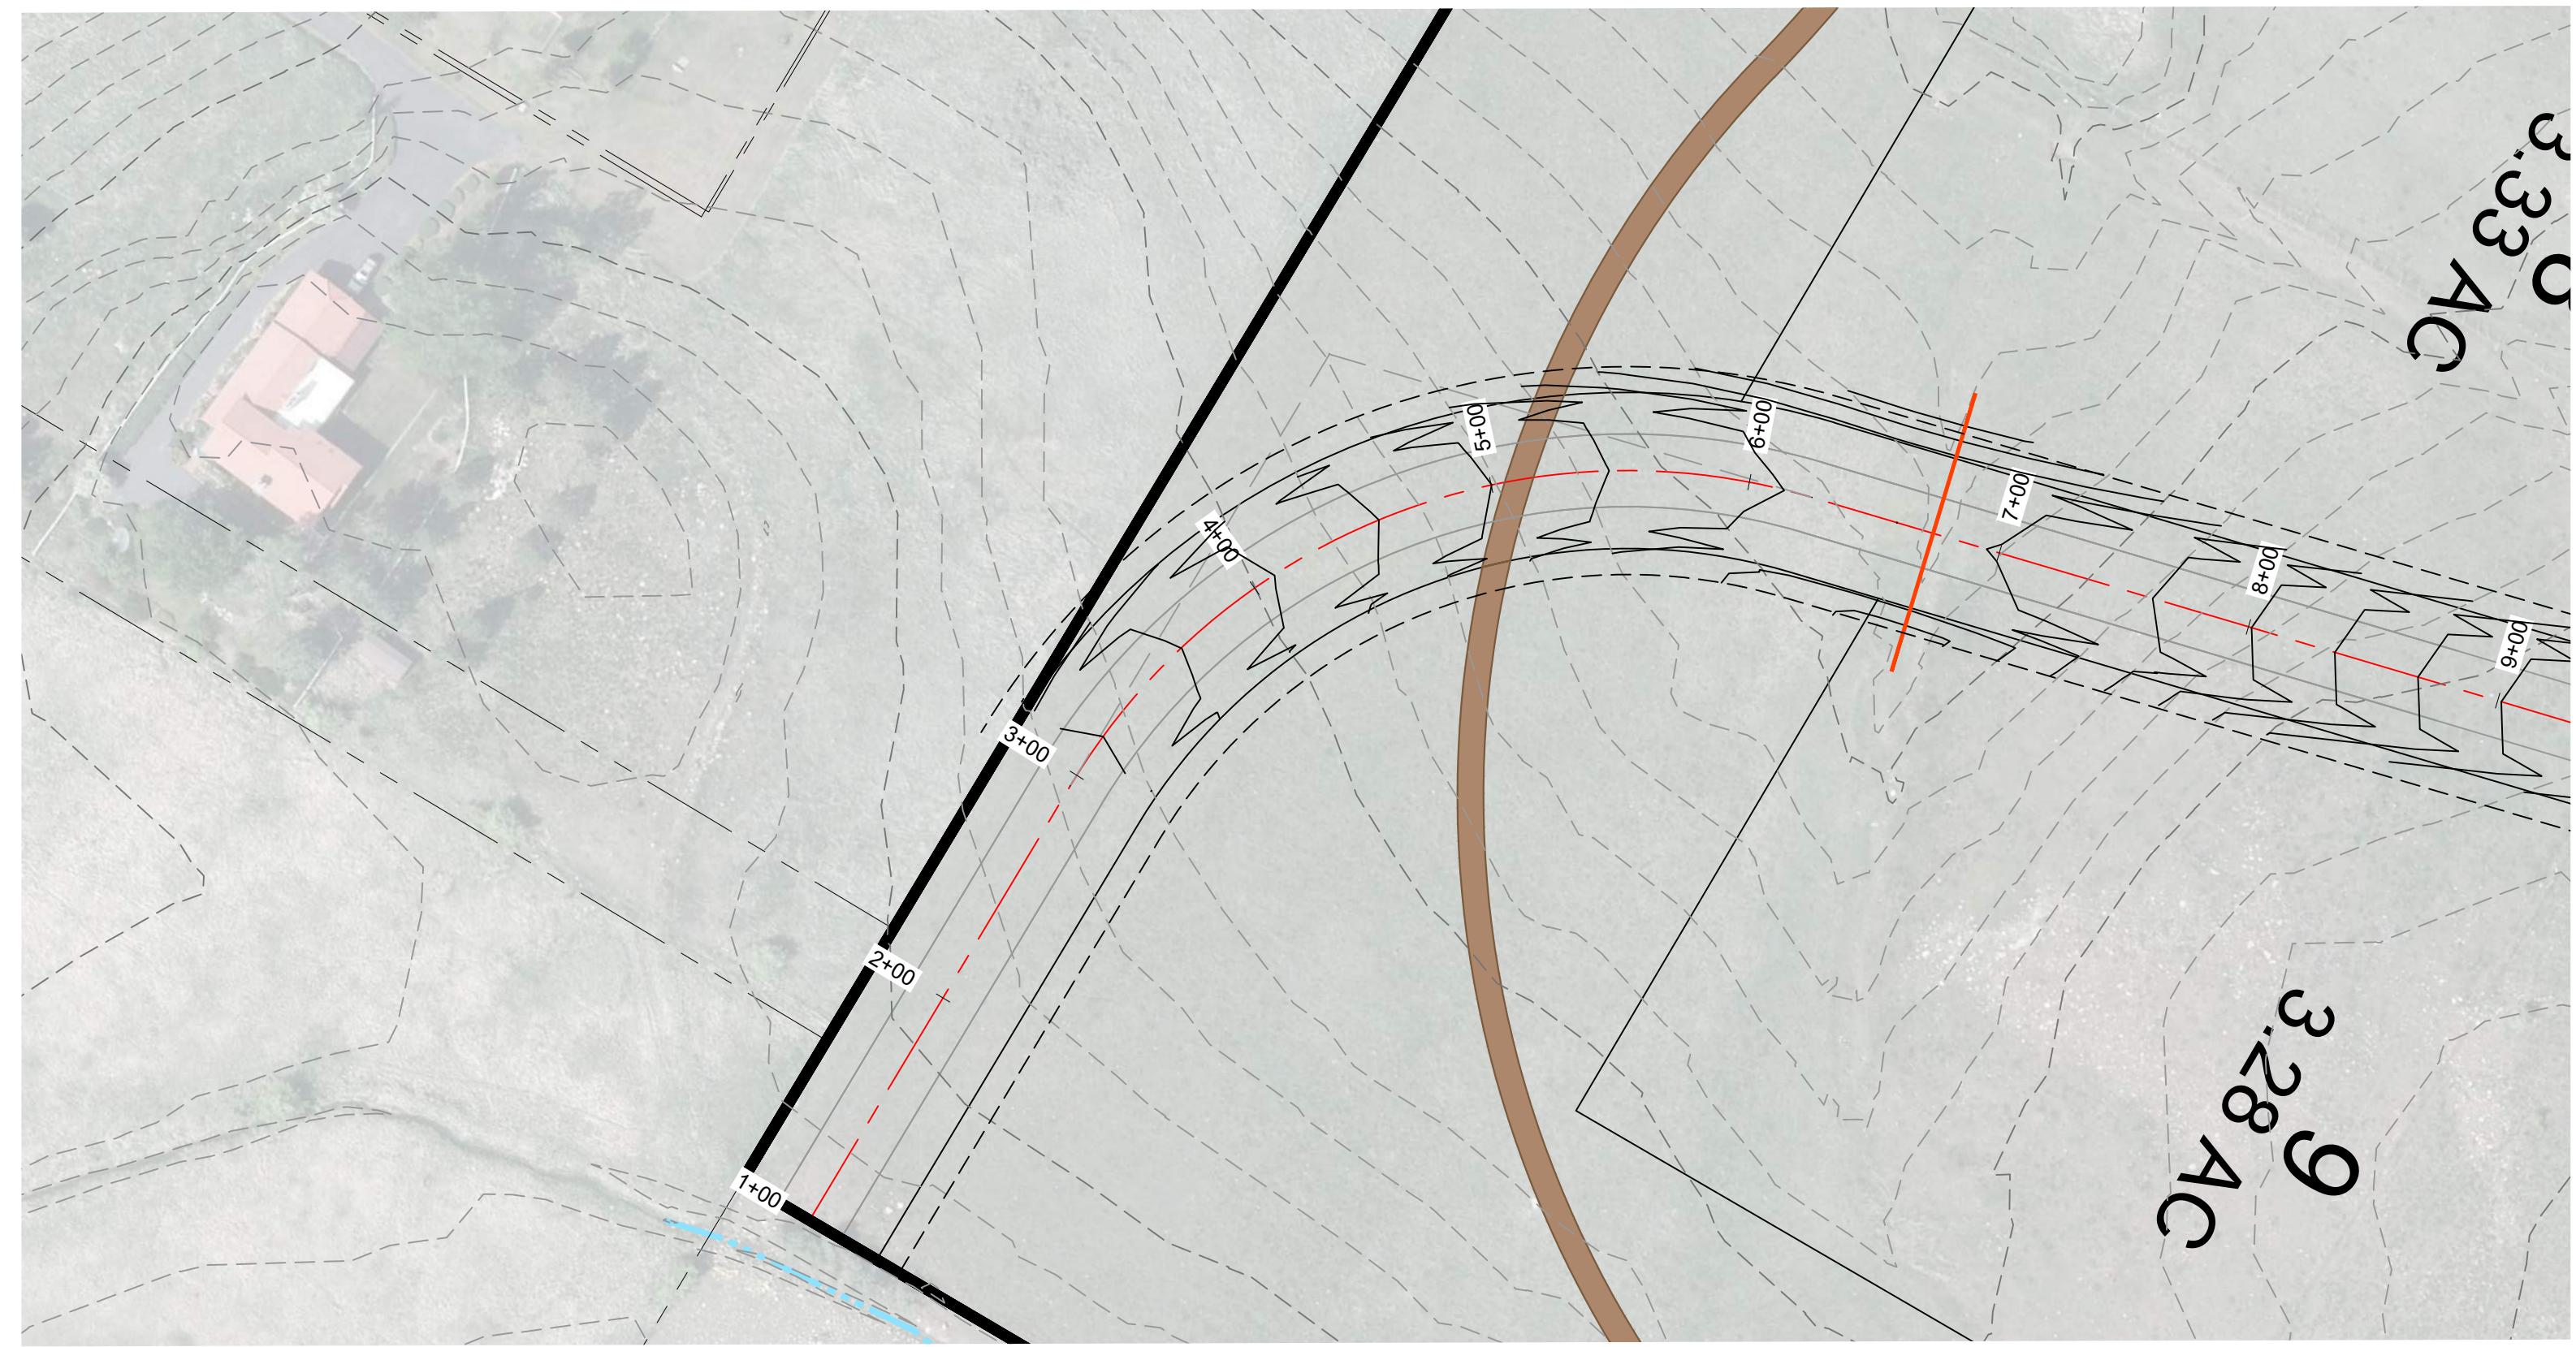
PPA

PLAN AND PROFILE ROAD A
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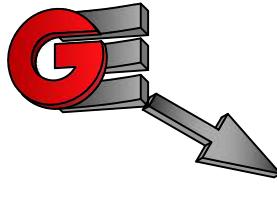
REVISIONS	DATE	DESCRIPTION
SCALE: 1" = 60'	DATE: 8-20-25	DESIGN: KANJ/KH
DRAWN: KANJ/KH	CHECKED: RC	

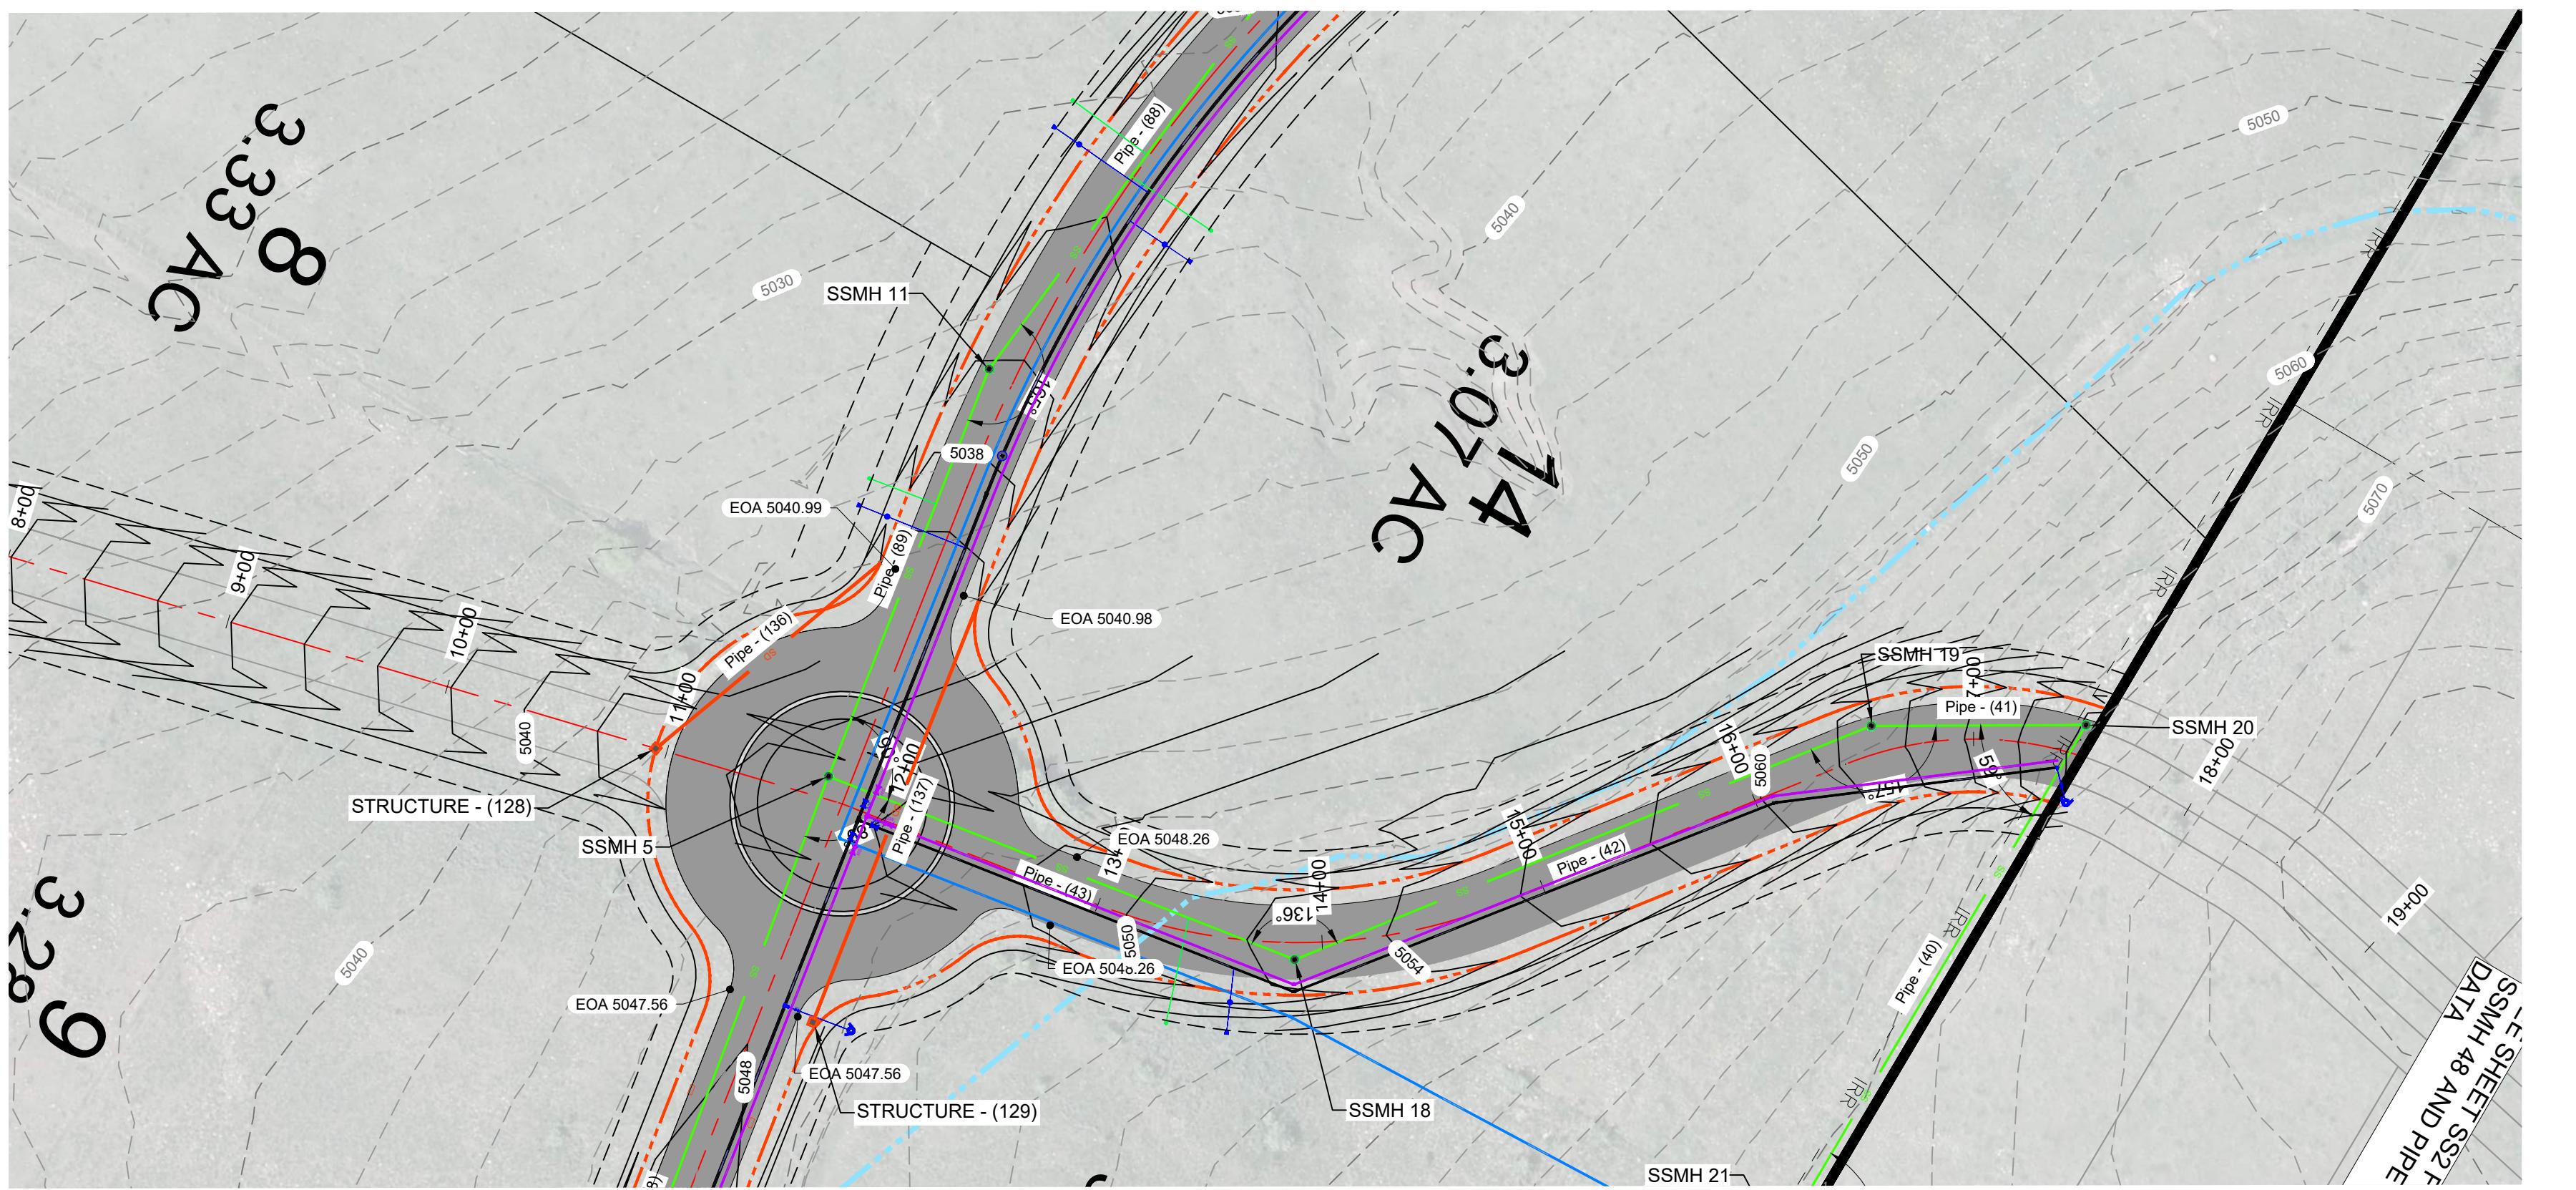DWG:






0' 30' 60' 120' 180'
Scale in Feet
1" = 60'



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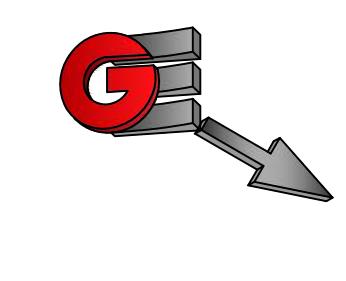
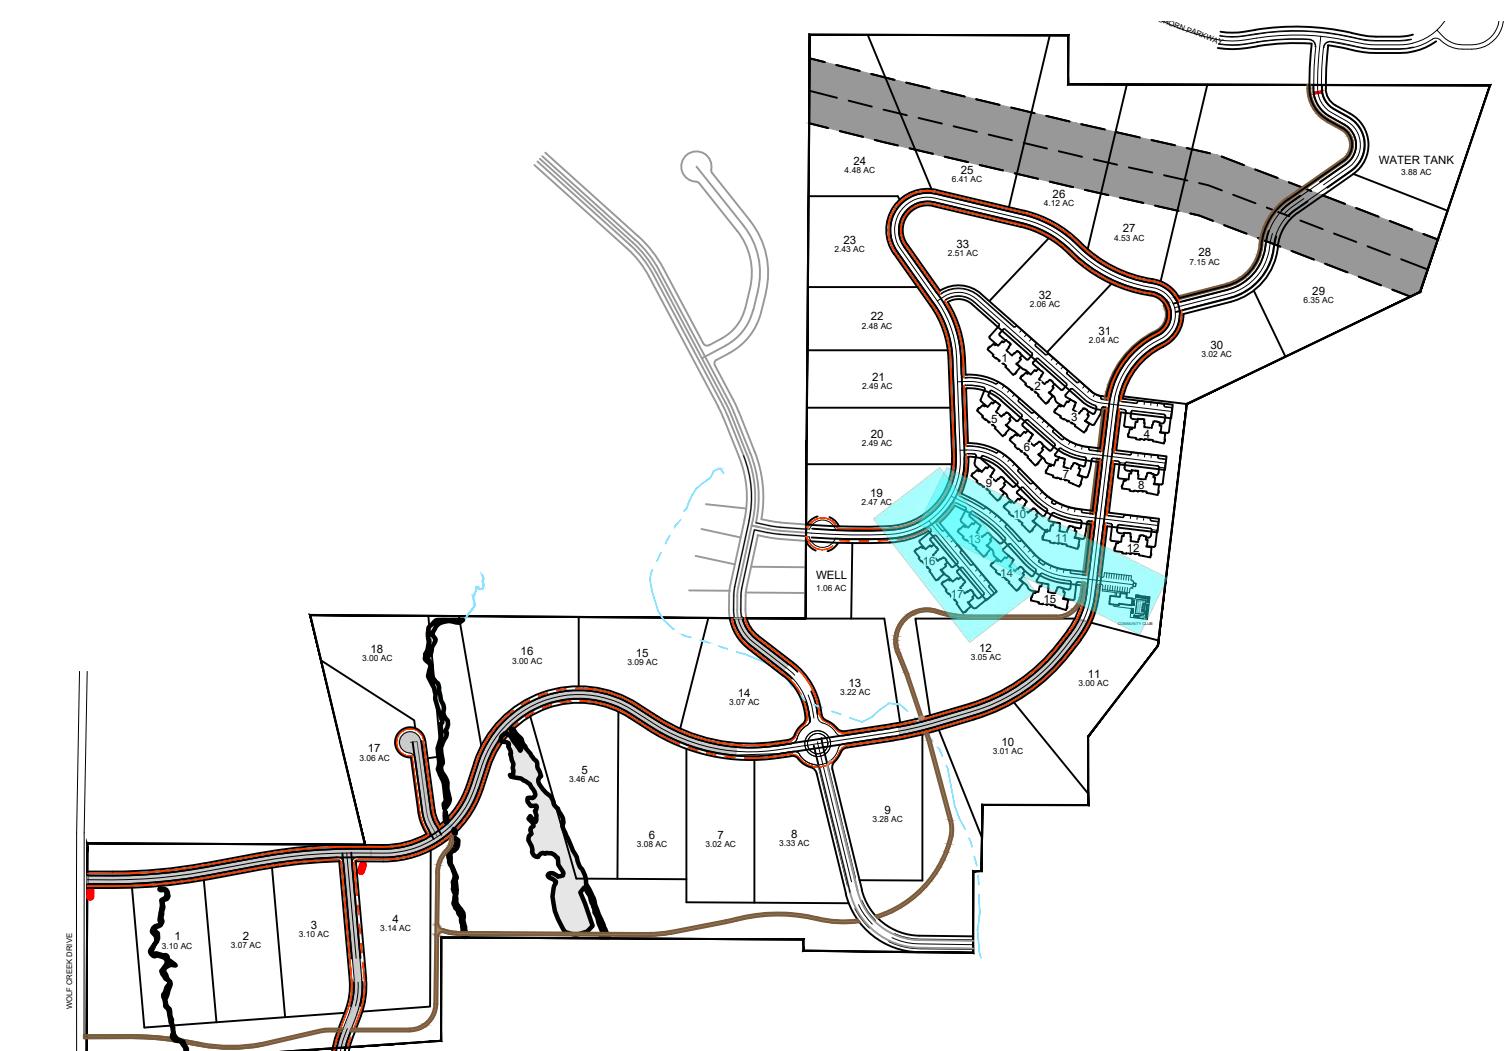
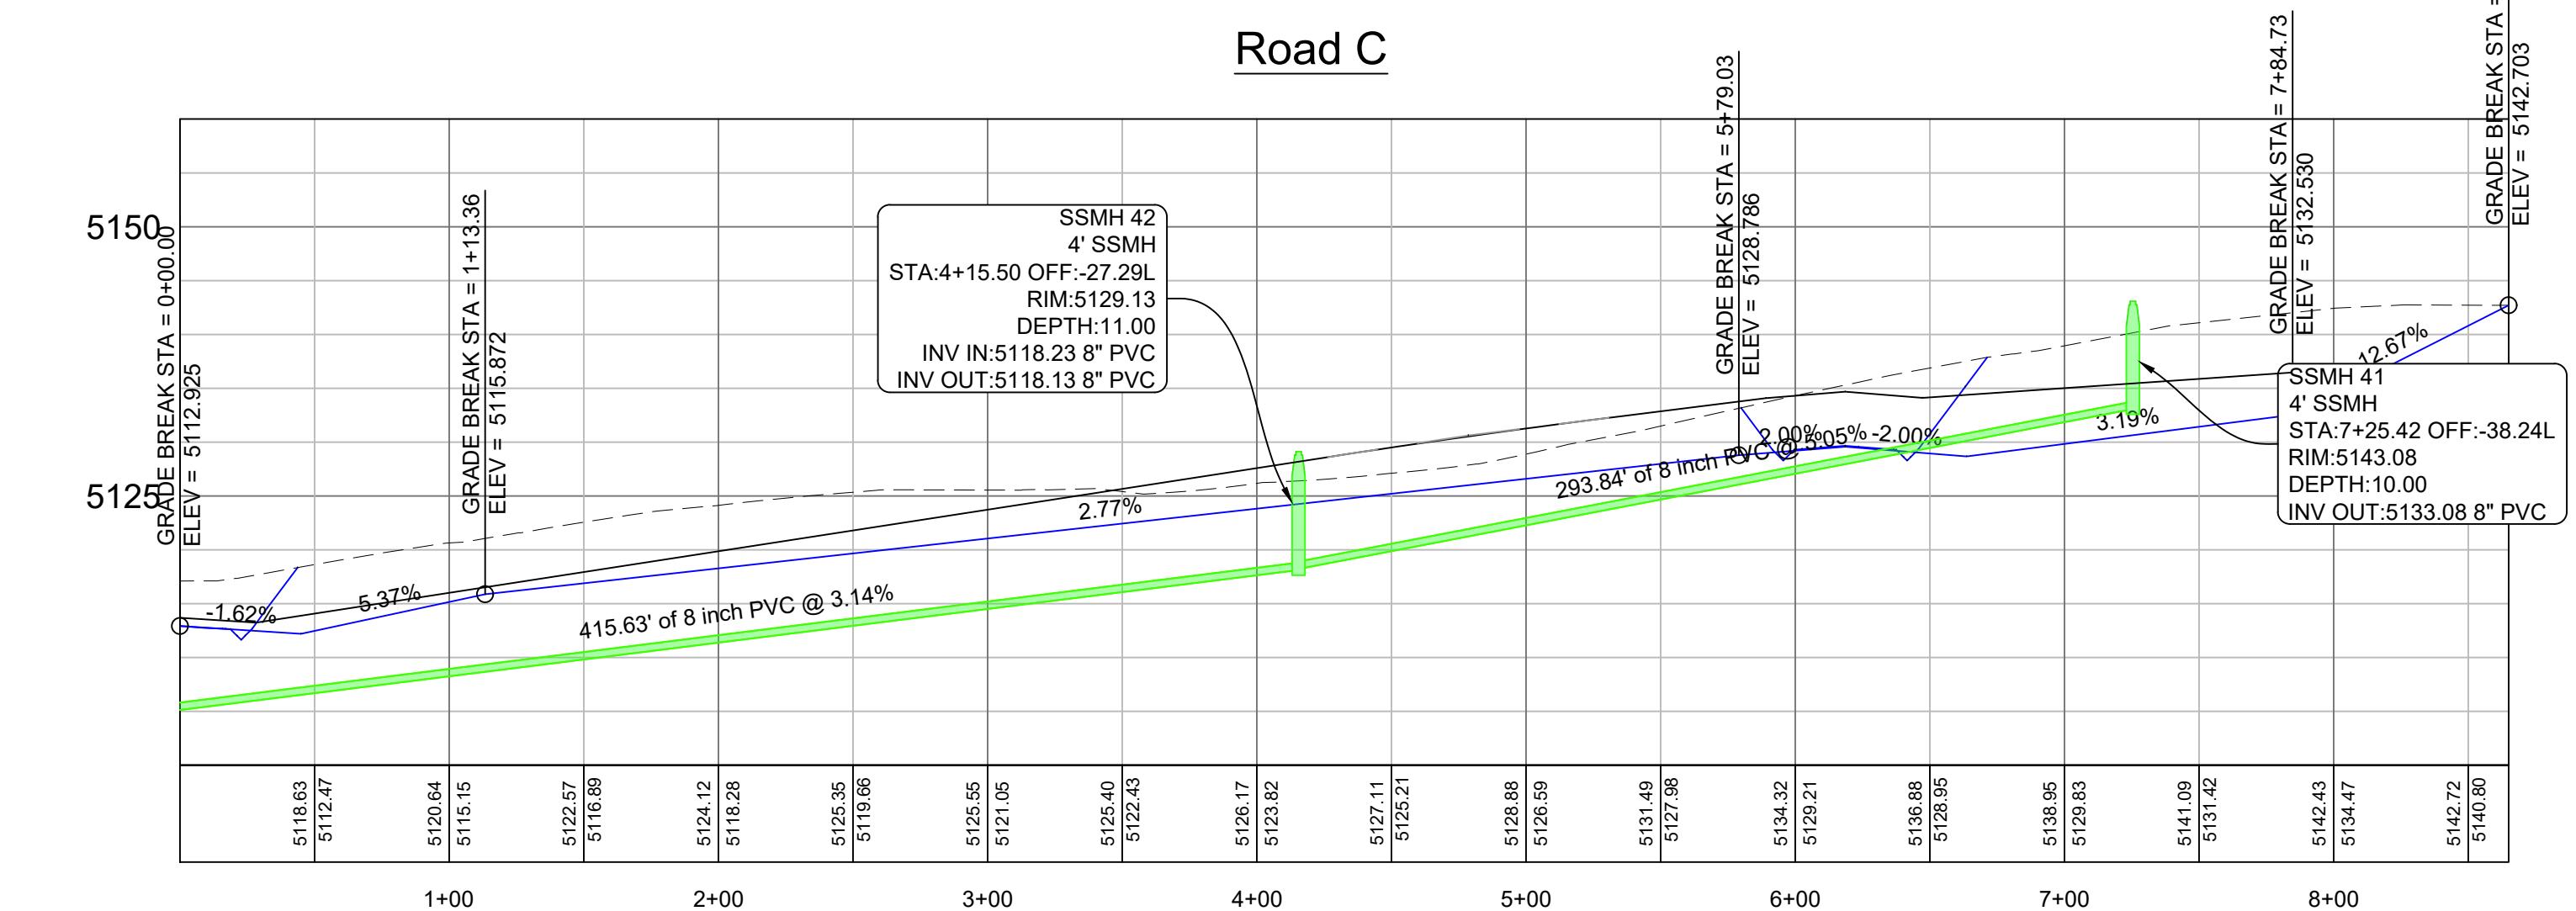
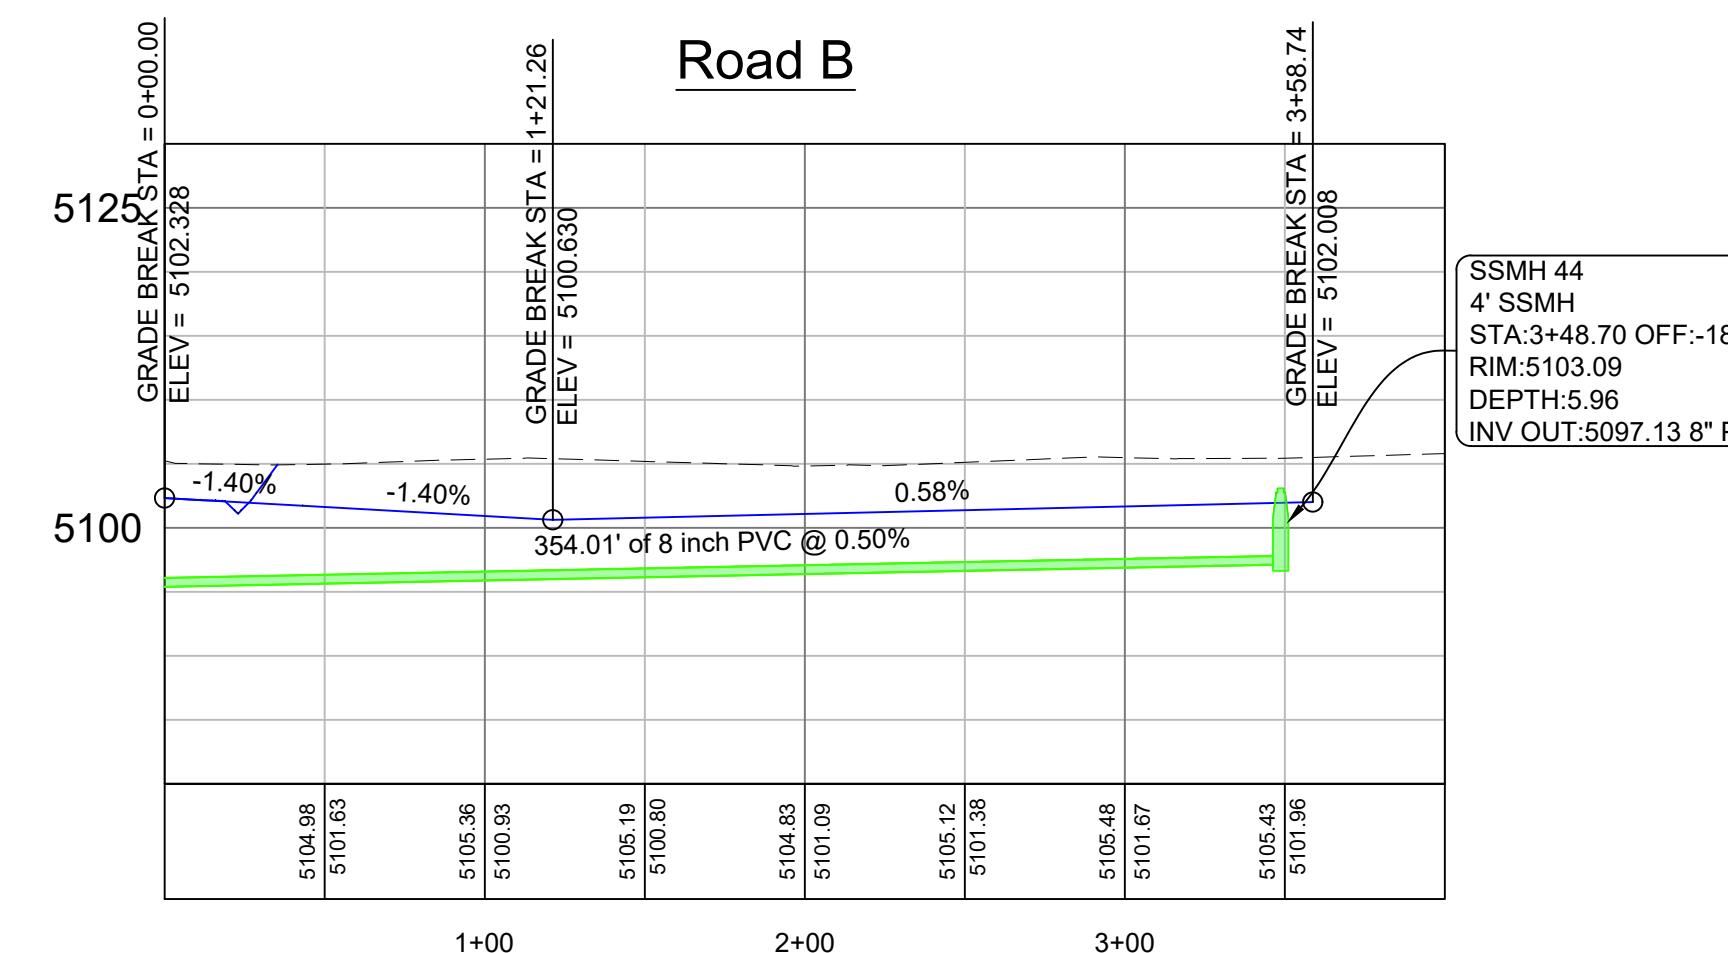
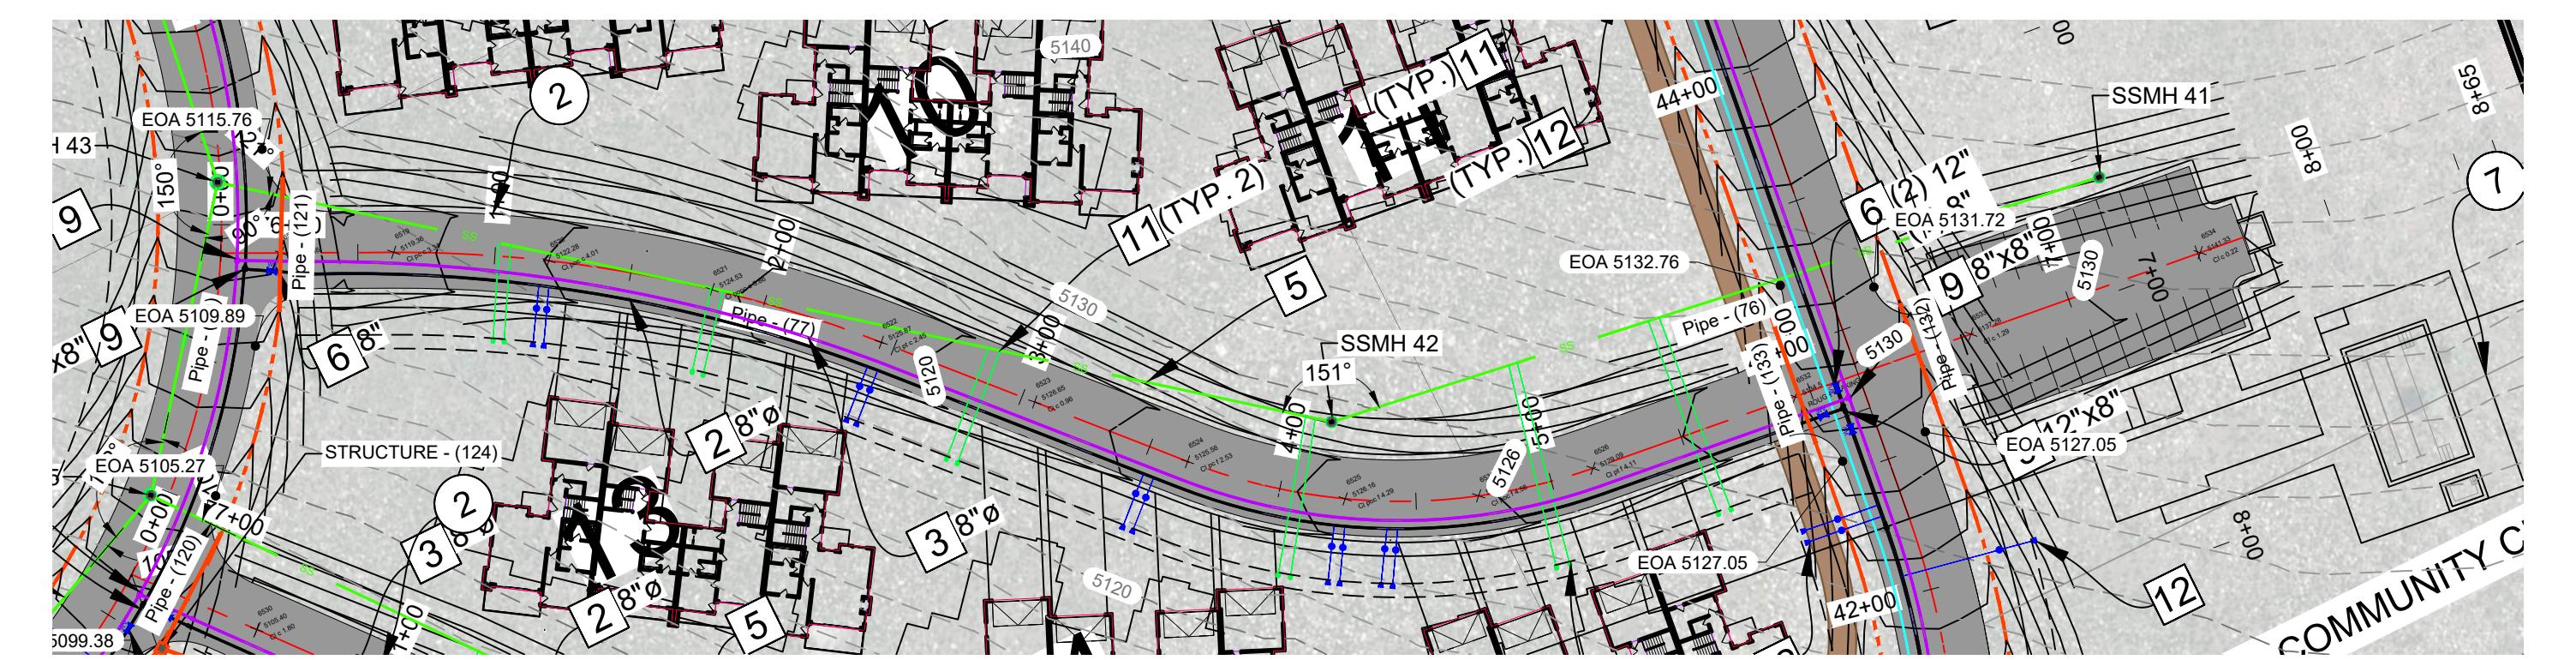
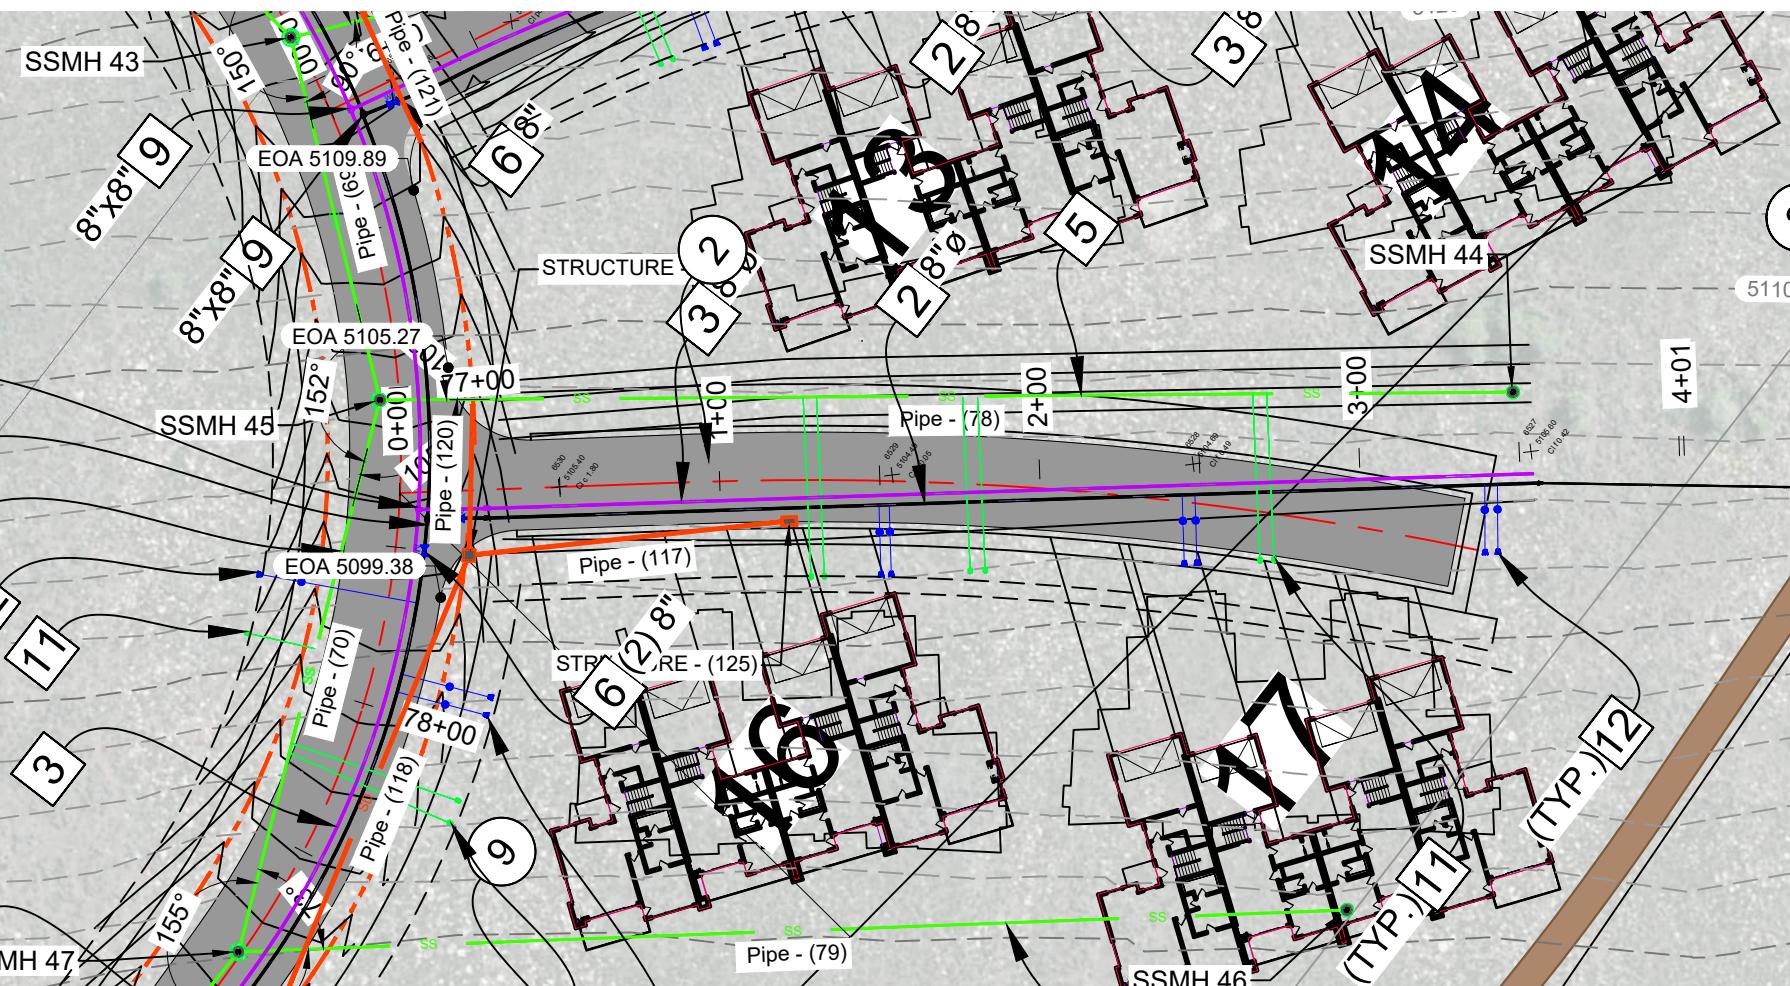
PPA

REVISIONS	DESCRIPTION
DATE	DATE
DESIGN	DESIGN
DRAWN	DRAWN
CHECKED	CHECKED
DWG:	

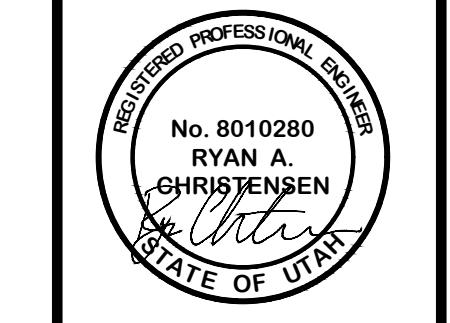

COBABE RANCH
SR-158 2800 N
EDEN, WEBER, UTAH

SCALE 1" = 60'	DATE 8-20-25
DESIGN KANJ/KH	DRAWN KANJ/KH
CHECKED RC	
DWG:	





PPB
Scale in Feet
1" = 60'

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PPB



REGISTERED PROFESSIONAL ENGINEER STATE OF UTAH No. 8010280 RYAN A. CHRISTENSEN <i>[Signature]</i>	SCALE 1" = 60'
DATE 8-20-25	DATE
DESIGN KANJKH	DRAWN KANJKH
CHECKED RC	DWG:

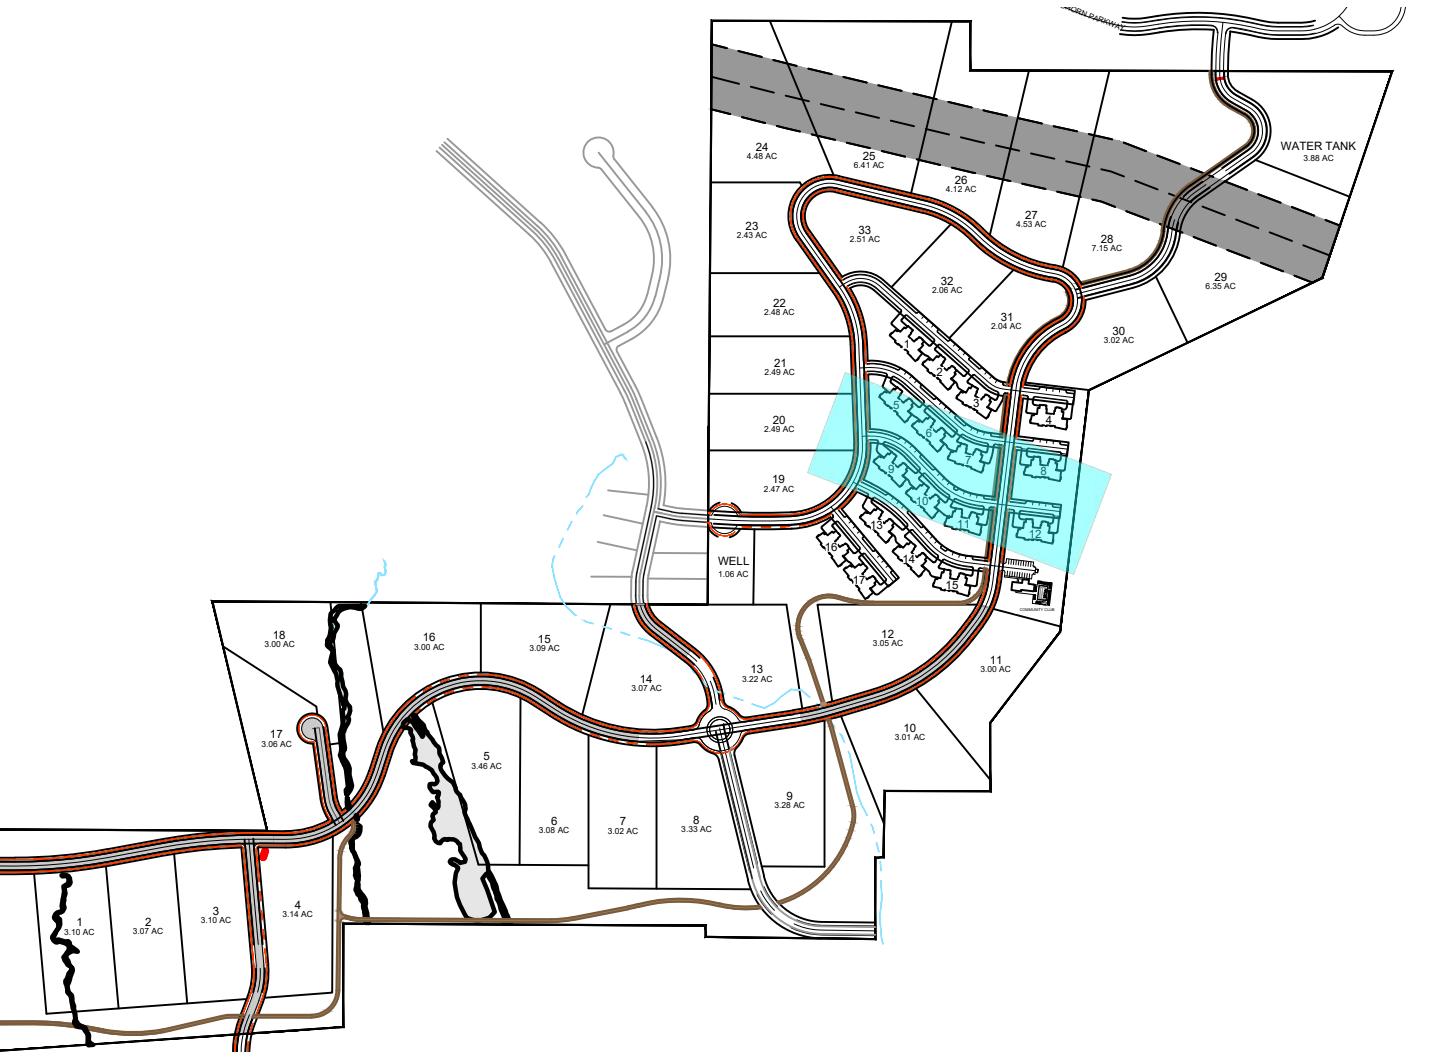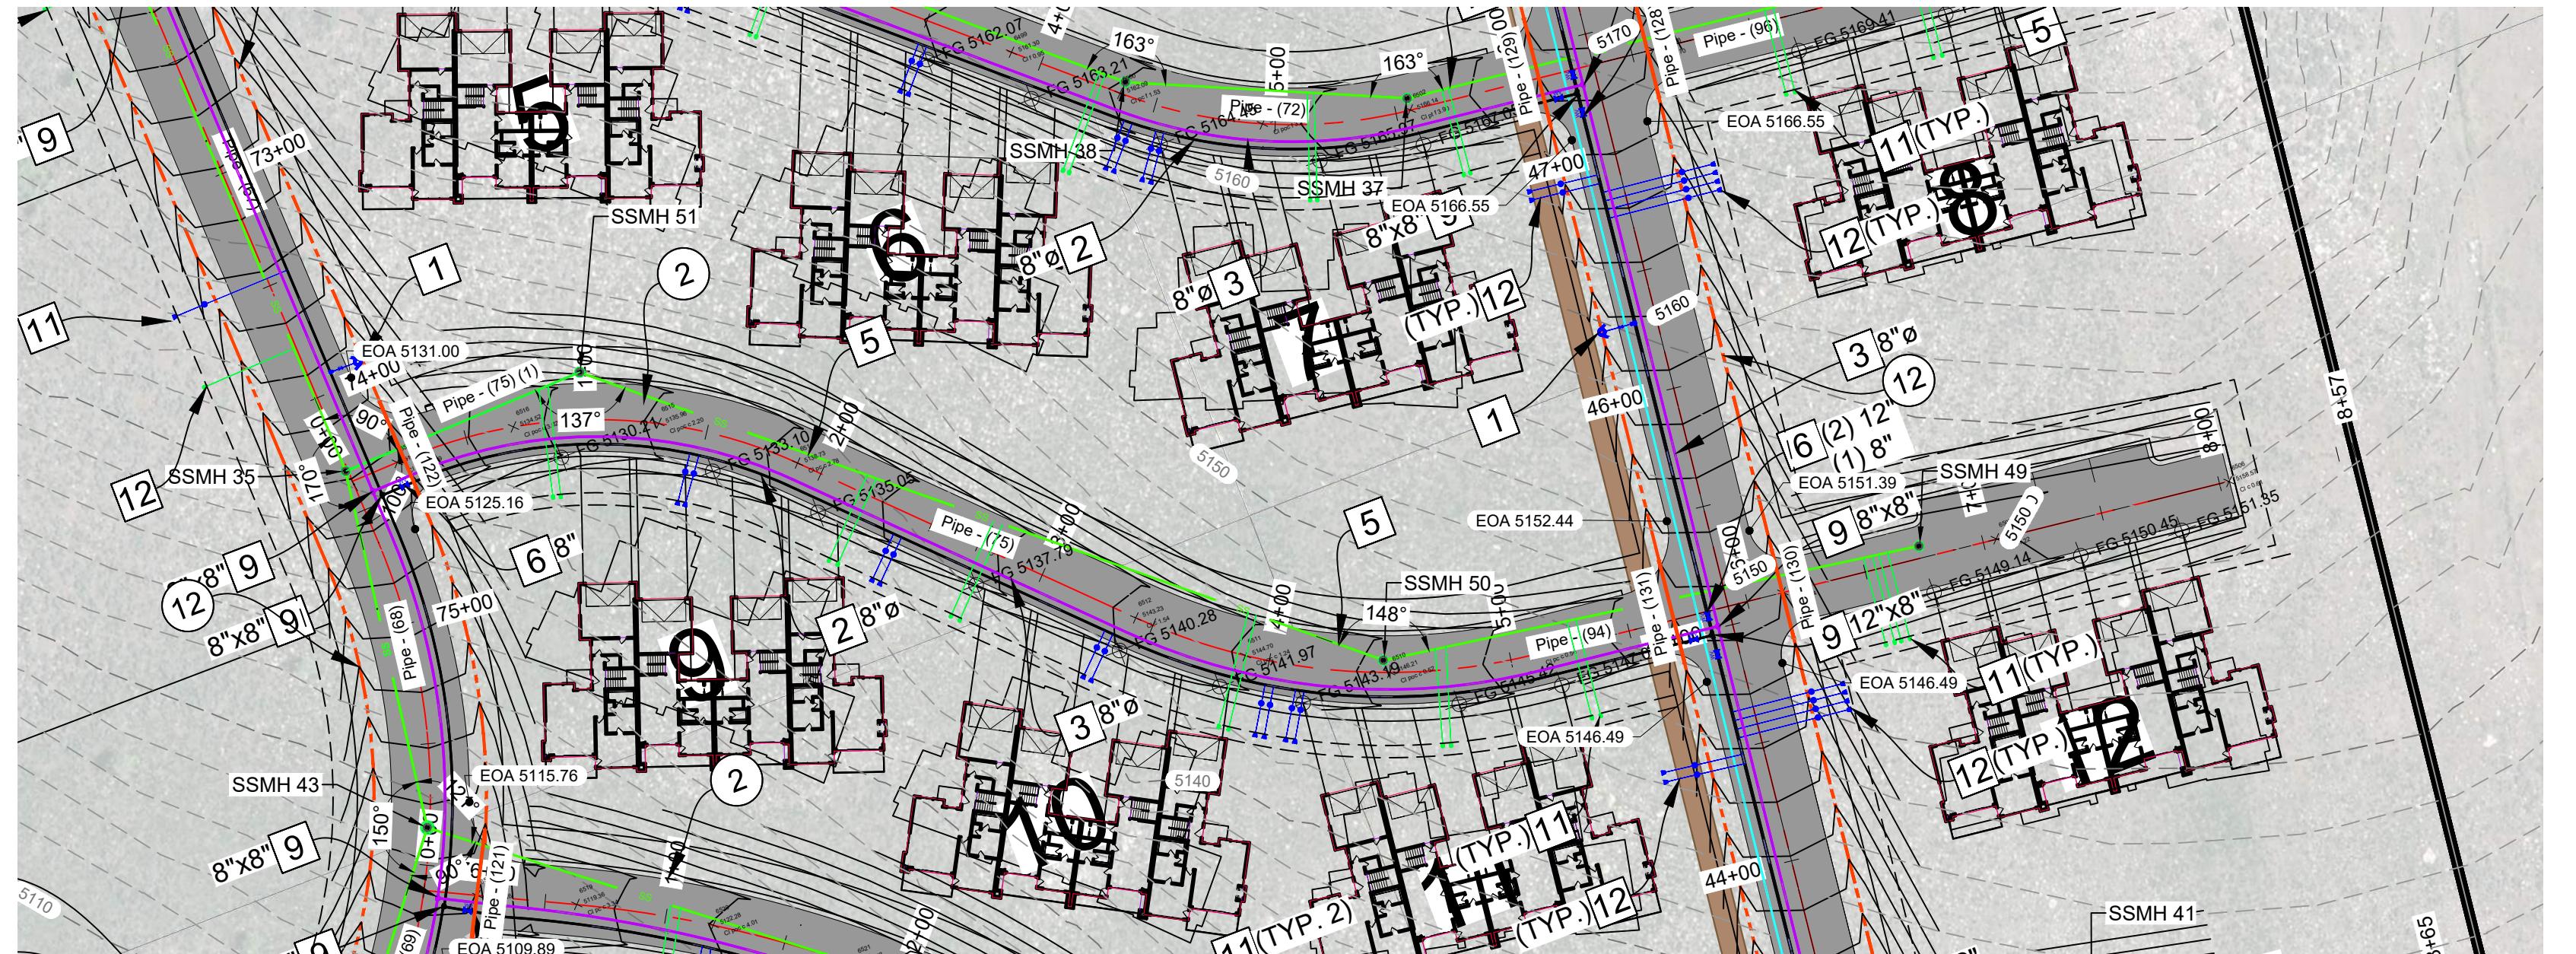

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FAX: 801-476-0202



PPD

PLAN AND PROFILE ROAD D
COBABE RANCH
SR-158 2800 N
EDEN, WEBER, UTAH

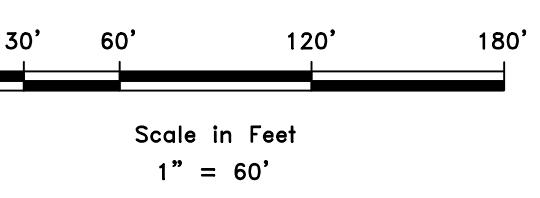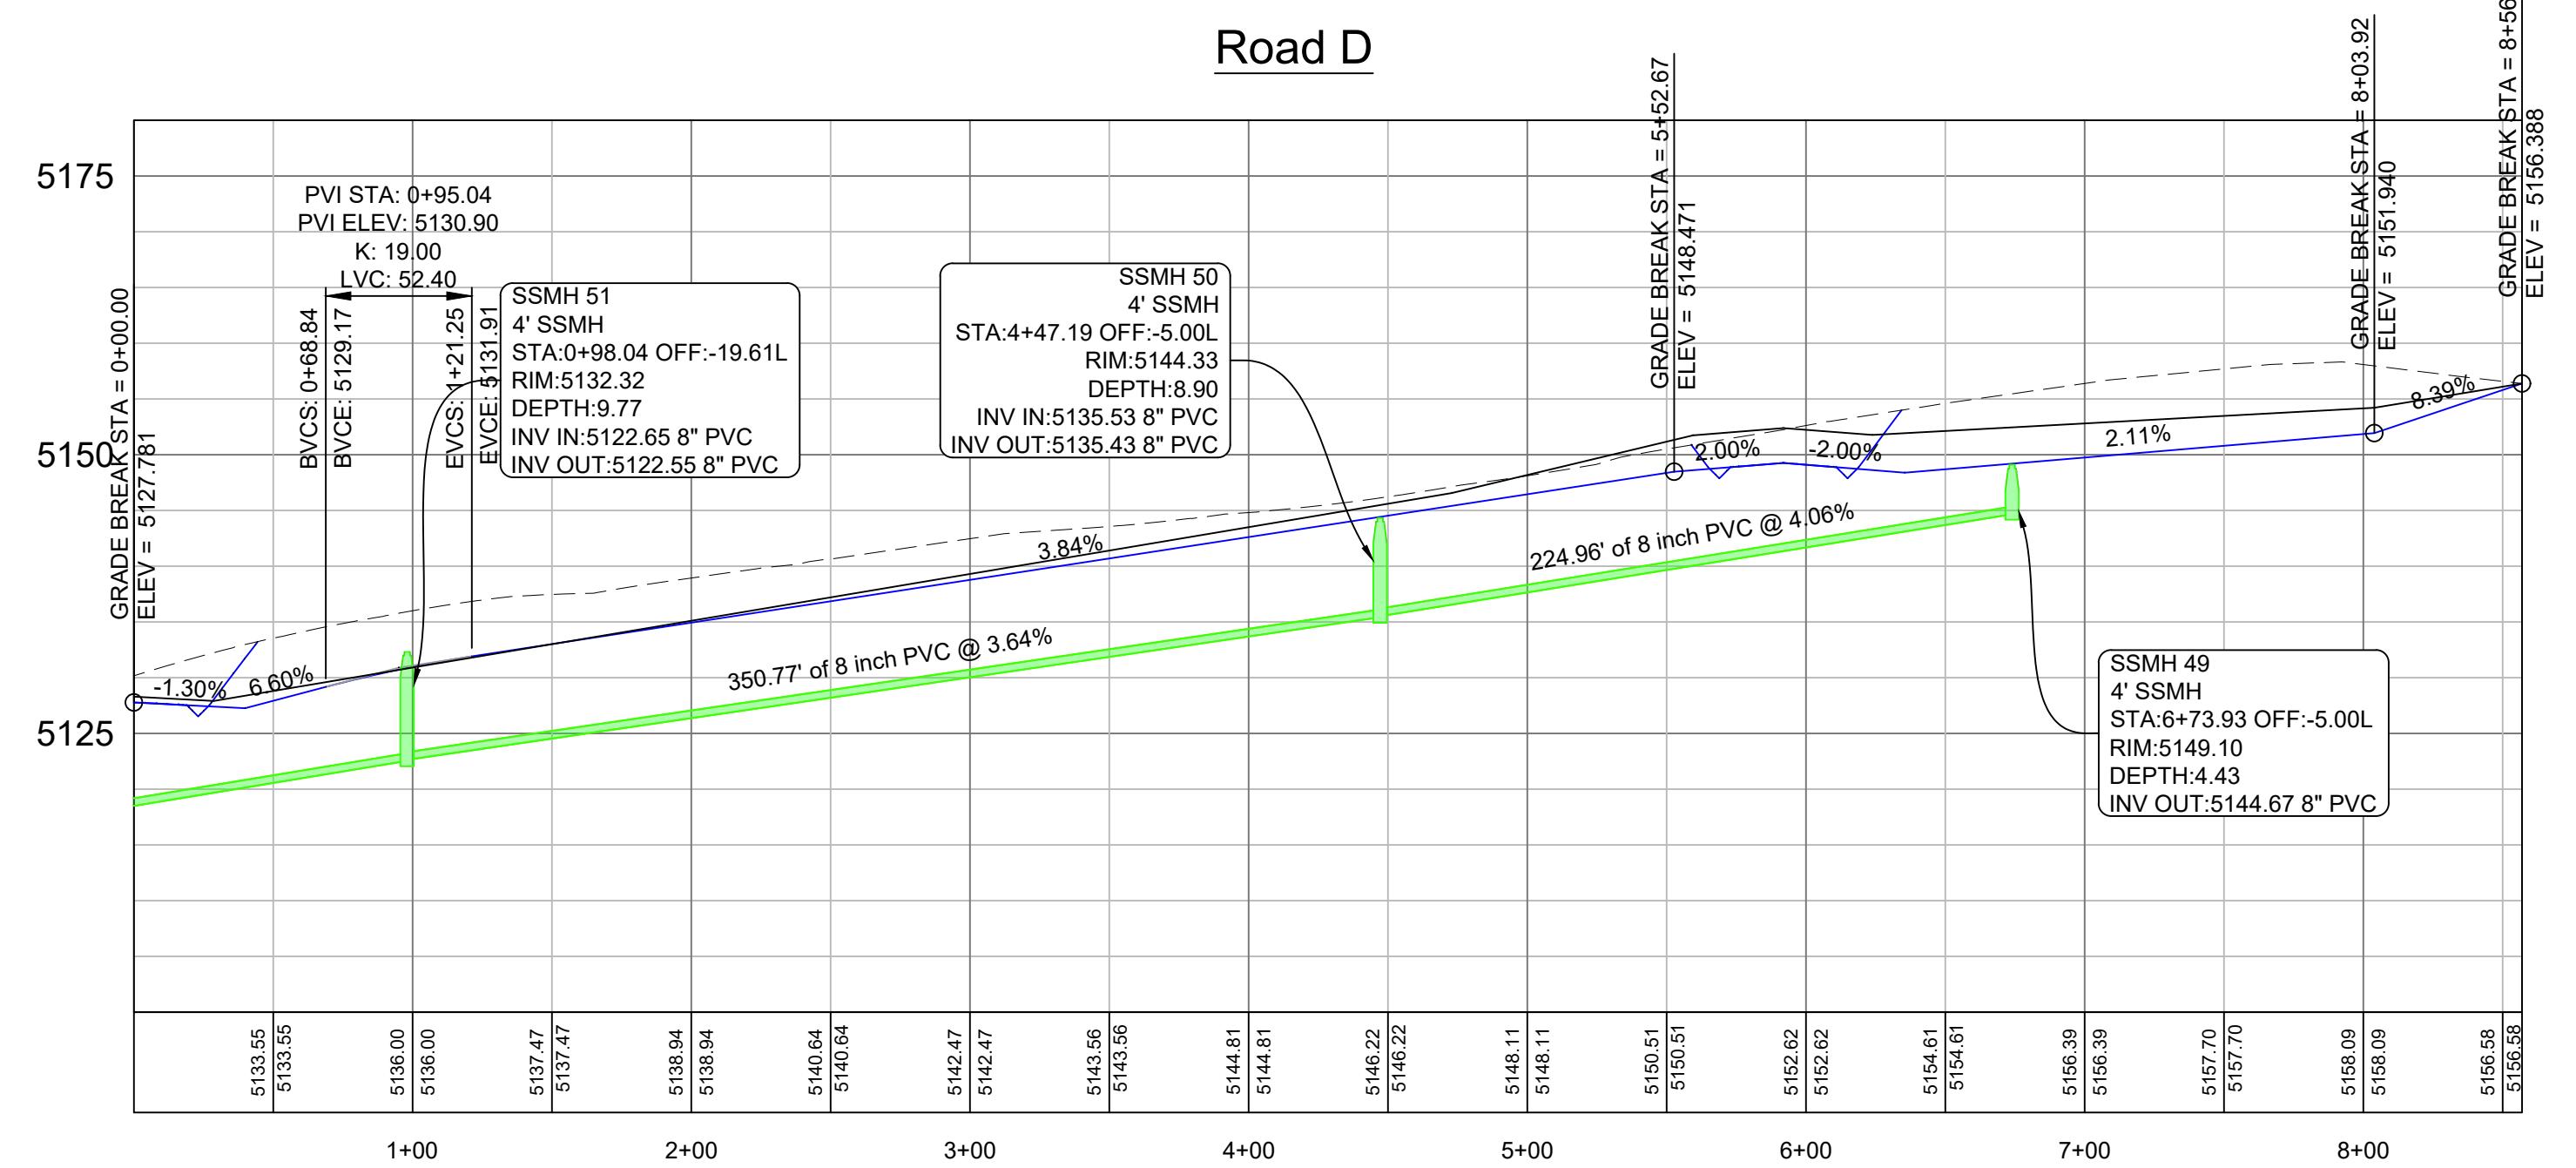

REVISIONS	DATE	DESCRIPTION	SCALE 1" = 60'
			DATE 8-20-25
			DESIGN KANJ/KH
			DRAWN KANJ/KH
			CHECKED RC
DWG: DWG:			

REGISTERED PROFESSIONAL ENGINEER
No. 8010280
RYAN A.
CHRISTENSEN
STATE OF UTAH
Chas.

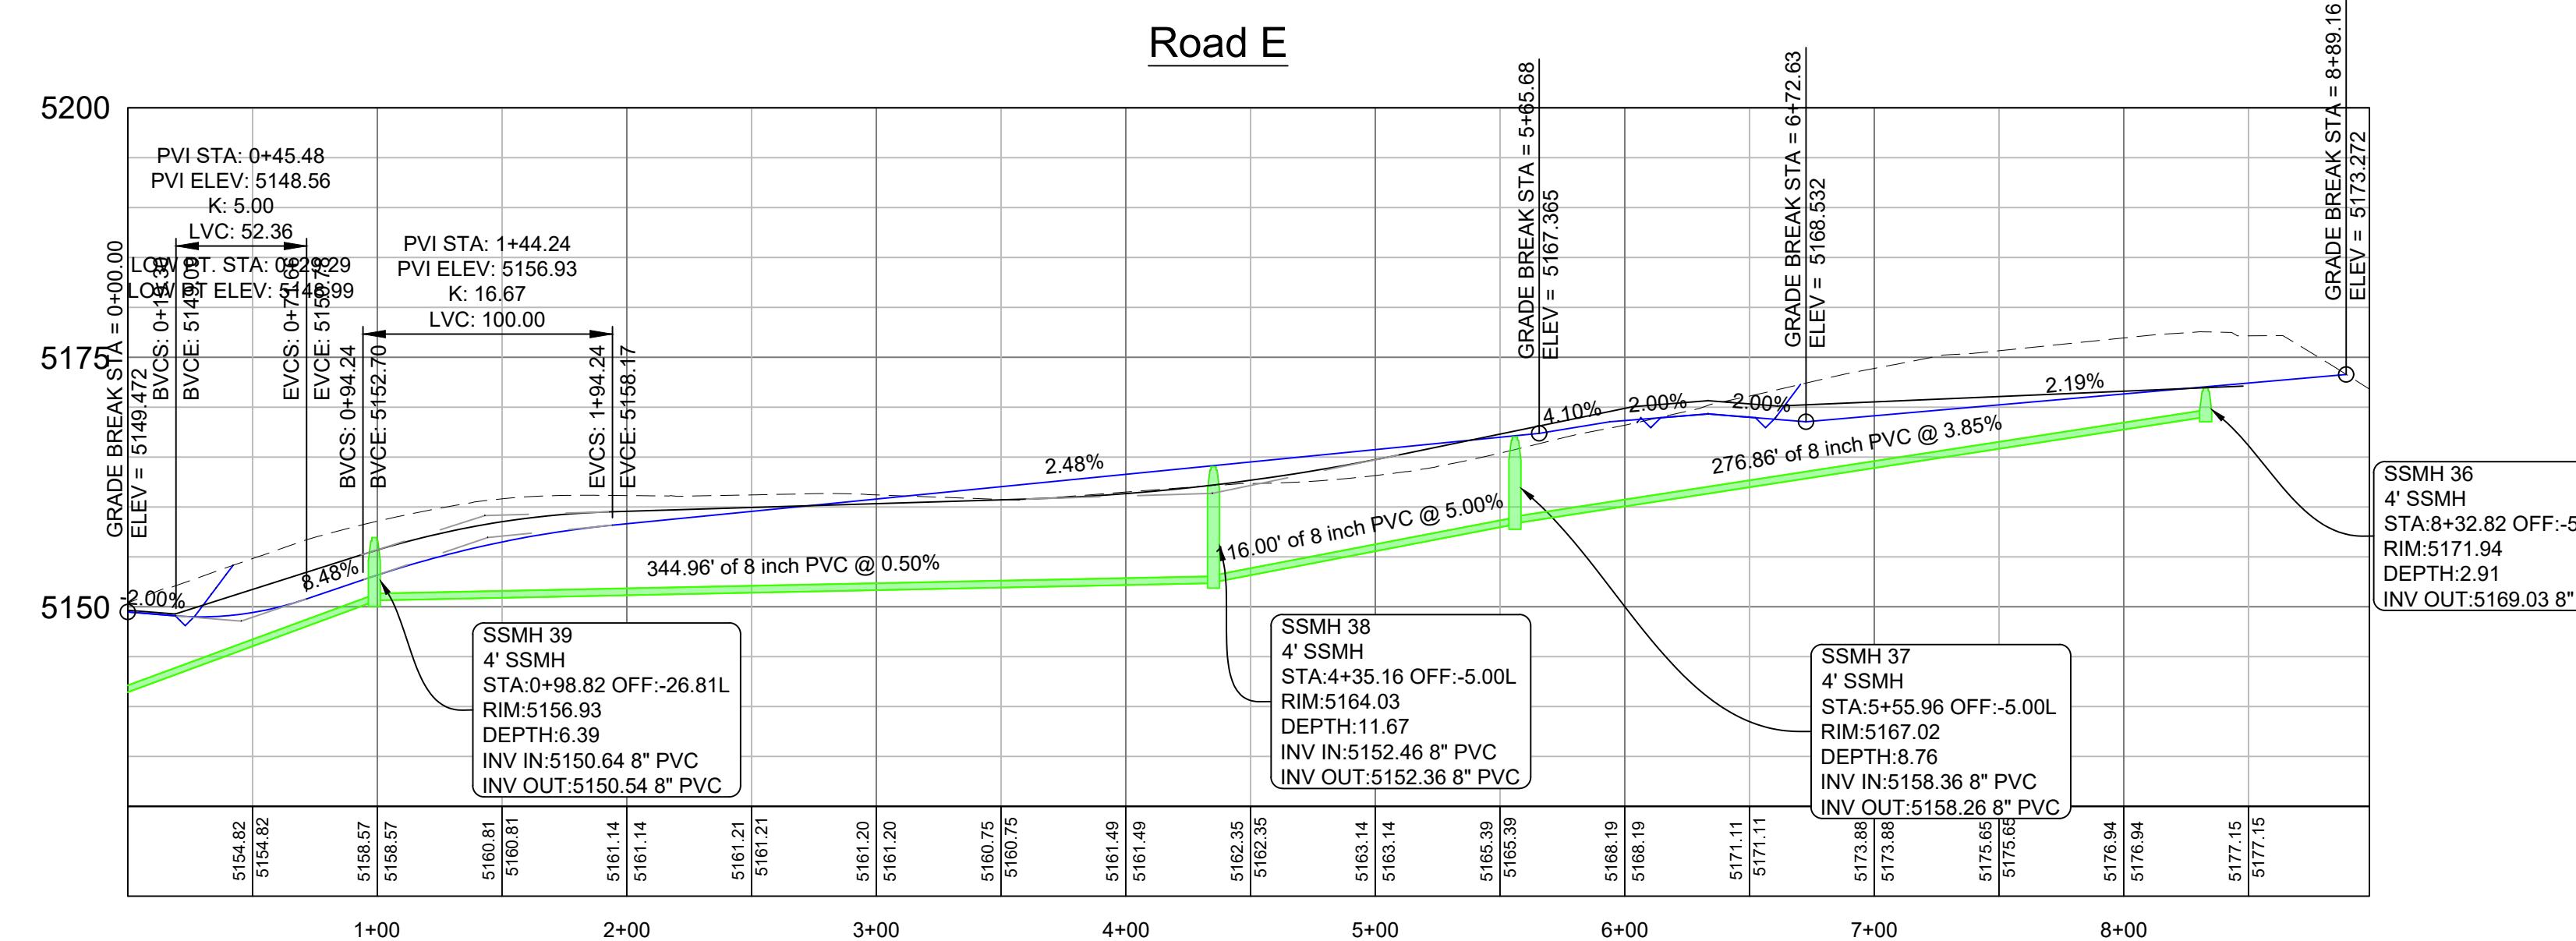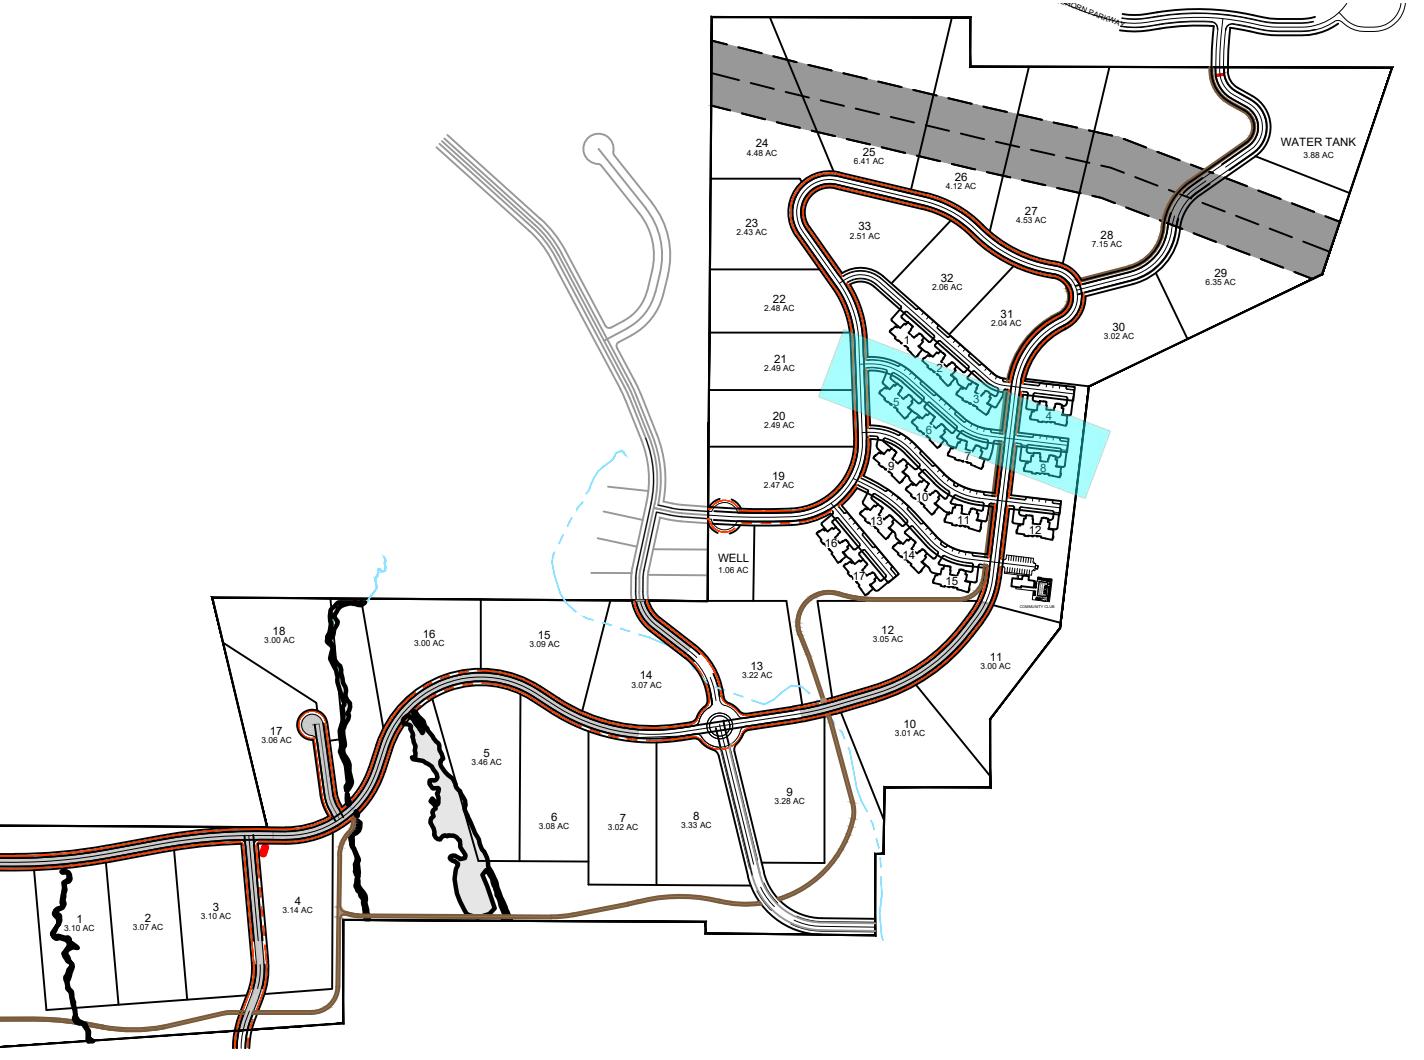



PP
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REVISIONS	DATE	DESCRIPTION

SCALE: 1" = 60'
DATE: 8-20-25
DESIGN: KANJ/KH
DRAWN: KANJ/KH
CHECKED: RC

PLAN AND PROFILE ROAD E
COBABE RANCH
SR-158 2800 N
EDEN, WEBER, UTAH



SCALE: 1" = 60'	DATE: 8-20-25
DESIGN: KANJH	DRAWN: KANJH
CHECKED: RC	DWG:

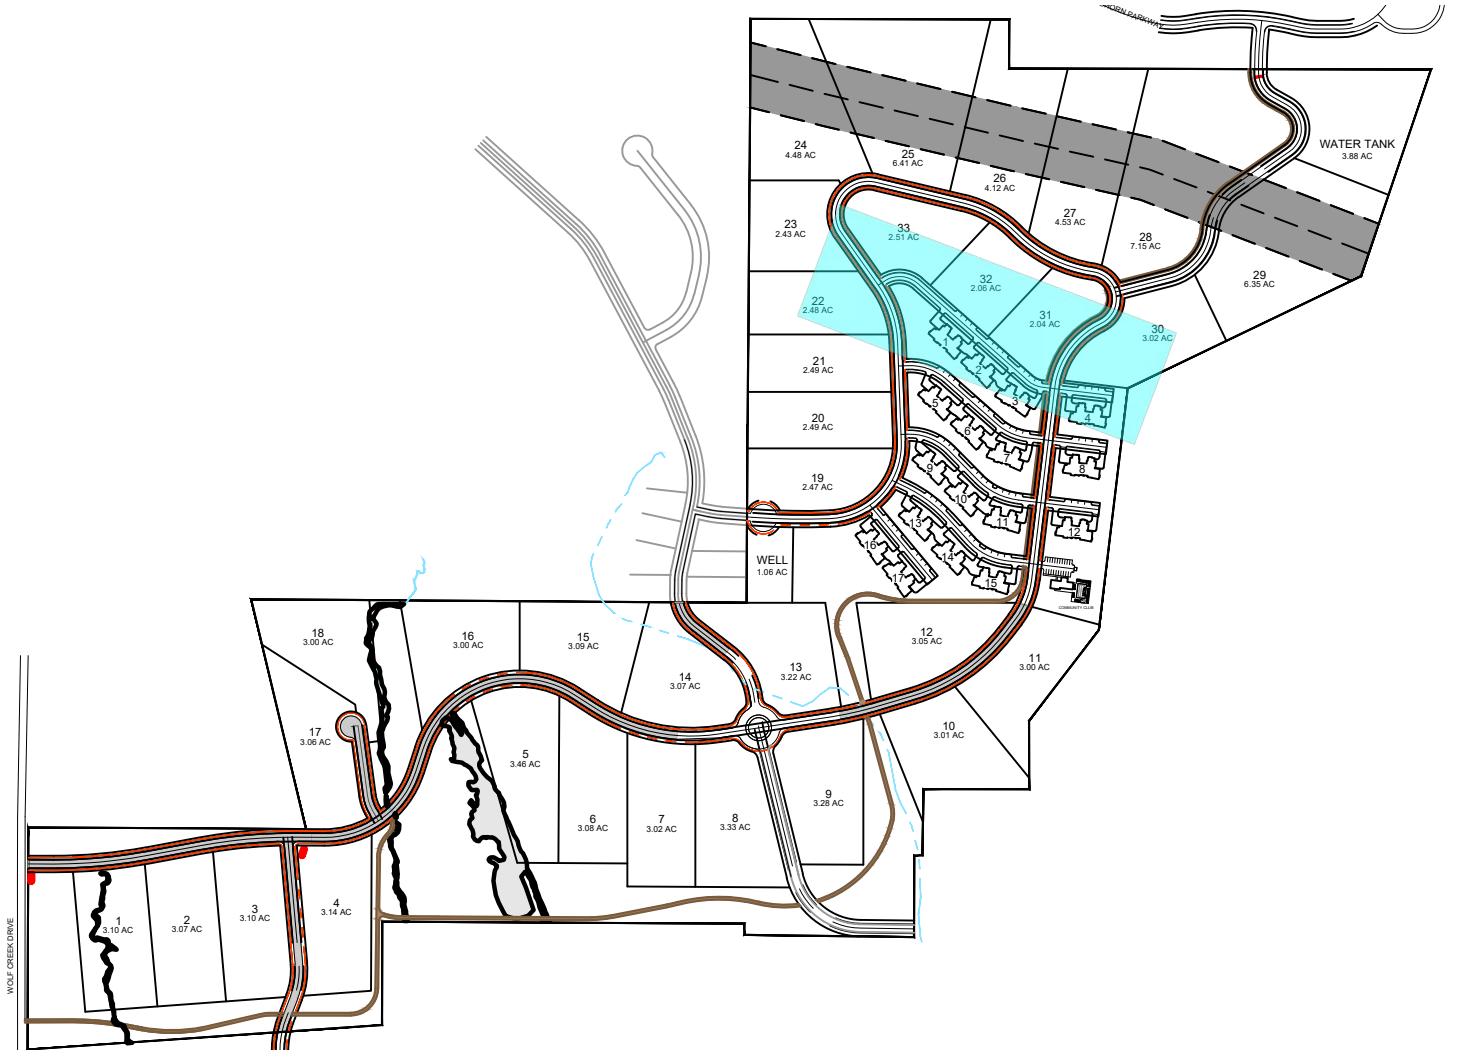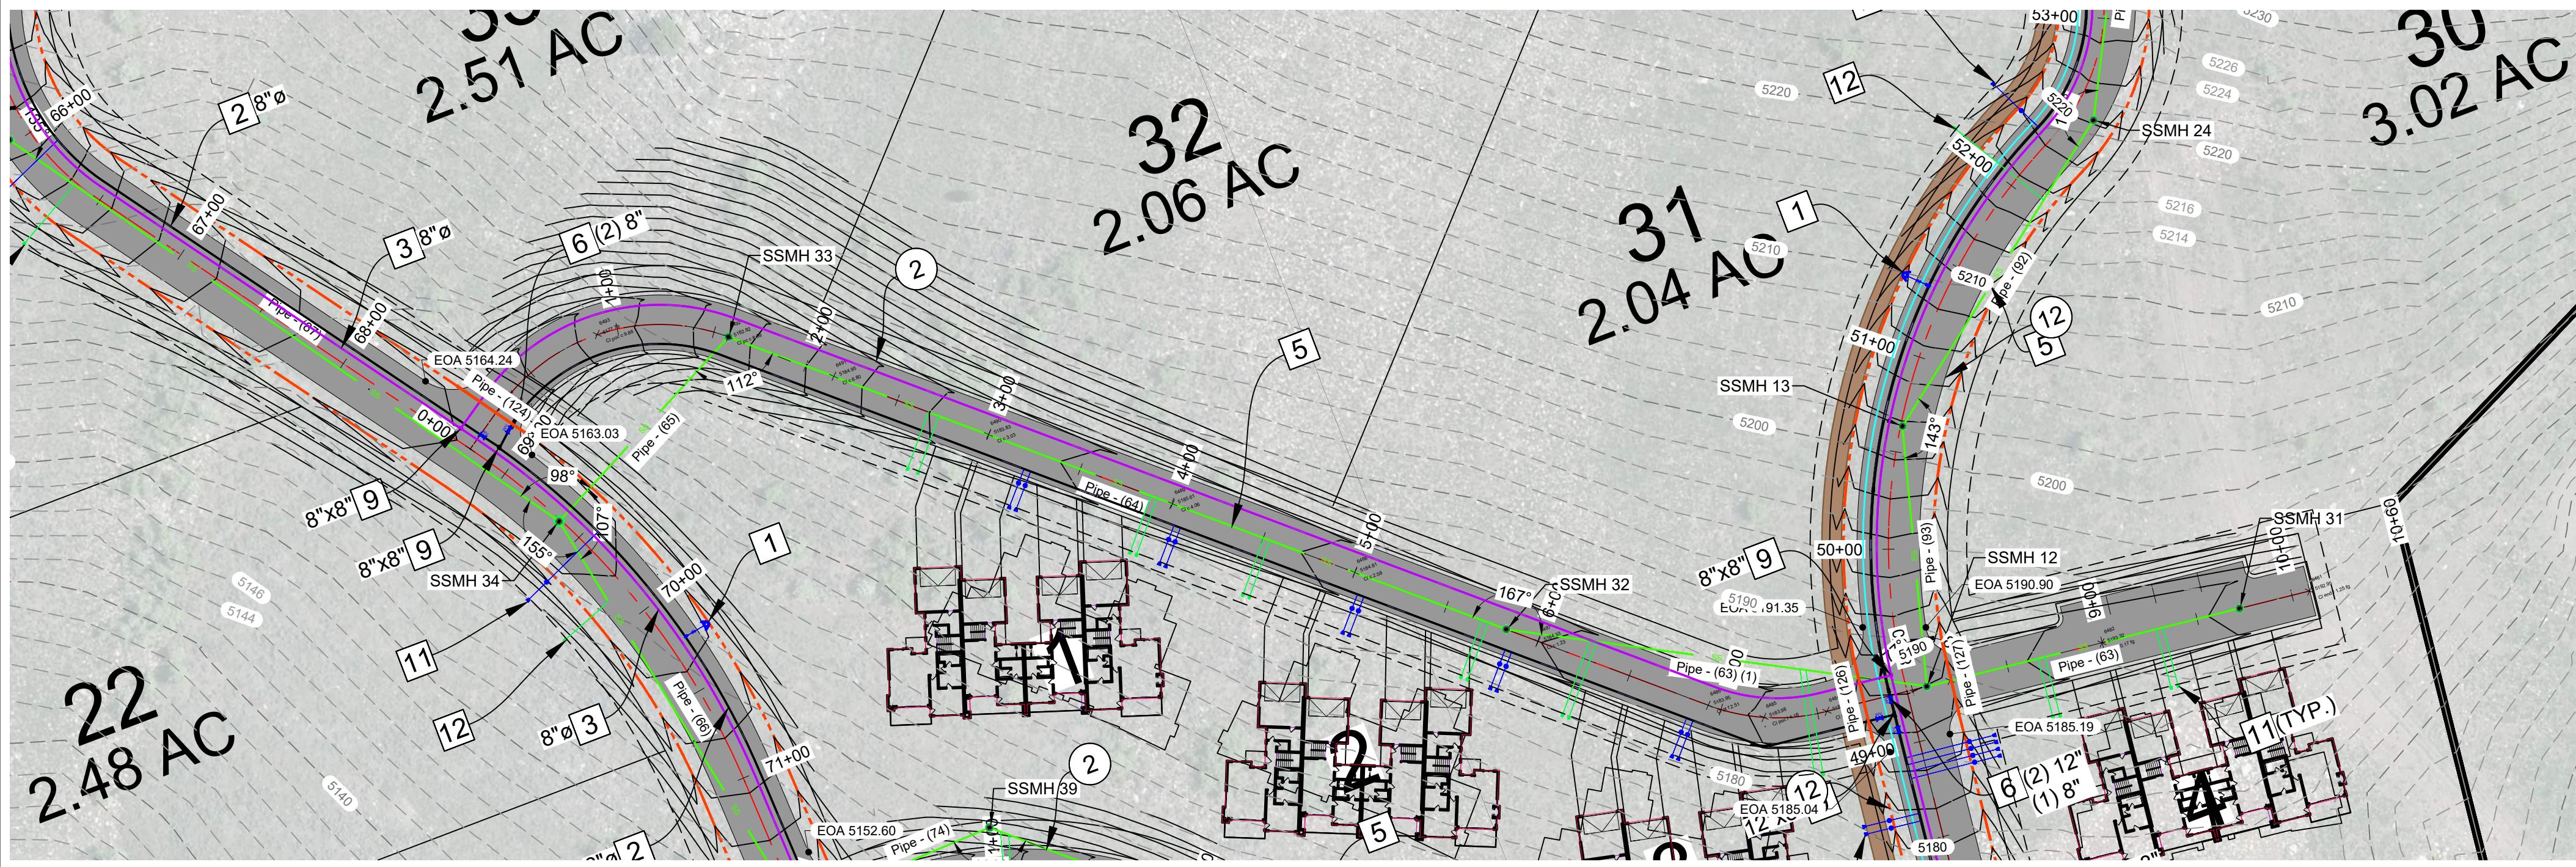REGISTERED PROFESSIONAL ENGINEER
No. 8010280
RYAN A.
CHRISTENSEN
STATE OF UTAH
[Signature]

PLAN AND PROFILE ROAD F
COBABE RANCH
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PPF

Road F

