



AMERICAN TOWER®

ATC SITE NAME: OGDEN - I-15

ATC SITE NUMBER: 9097

T-MOBILE SITE NAME: SL04748B

T-MOBILE SITE NUMBER: SL04748B

SITE ADDRESS: OFF OF 12TH STREET;

SECTION 18, TOWNSHIP 6 NORTH

RANGE 3 WEST, SALT I OGDEN, UT 84404-9760


T-MOBILE MICROWAVE PLAN MW RECIPIENT FROM: SL01312A



LOCATION MAP

								$\overline{}$
COMPLIANCE CODE	PROJECT	SUMMARY	PROJECT DESCRIPTION	SHEET INDEX				
ALL WORK SHALL BE PERFORMED AND MATERIALS INSTALLED IN ACCORDANCE WITH THE CURRENT EDITIONS OF THE		DDRESS:	THE PROPOSED PROJECT INCLUDES MODIFYING GROUND BASED AND TOWER MOUNTED EQUIPMENT AS INDICATED PER BELOW:	SHEET NO:	DESCRIPTION:	REV:	DATE:	BY:
FOLLOWING CODES AS ADOPTED BY THE LOCAL GOVERNMENT AUTHORITIES. NOTHING IN THESE PLANS IS TO		WNSHIP 6 NORTH	TOWER WORK:	G-001	TITLE SHEET	0	08/08/25	RMJ
BE CONSTRUED TO PERMIT WORK NOT CONFORMING TO THESE CODES.	RANGE 3 V	VEST, SALT I	INSTALL (1) PIPE MOUNT(S), (2) STIFF ARM(S), (1) MICROWAVE DISH(ES), (2) ODU(s), (2) 0.39" (10mm) FIBER TRUNK(S), AND (2) 0.39"	G-002	GENERAL NOTES	0	08/08/25	RMJ
1. 2021 INTERNATIONAL BUILDING CODE (IBC)	OGDEN, U	T 84404-9760	(10mm) CONTROL CABLE(S).	C-001	OVERALL SITE PLAN	0	08/08/25	RMJ
2. 2020 NATIONAL ELECTRIC CODE (NEC) 3. LOCAL BUILDING CODE	COUNTY	Y: WEBER	GROUND WORK: INSTALL IDU(s) IN CABINET.	C-101	DETAILED SITE PLAN	0	08/08/25	RMJ
4. CITY/COUNTY ORDINANCES	GEOGRAPHIC	COORDINATES:		C-201	TOWER ELEVATION	0	08/08/25	RMJ
		E: 41.25507		C-401	MICROWAVE INFORMATION & SCHEDULE	0	08/08/25	RMJ
		E: -112.23656		C-501	CONSTRUCTION DETAILS	0	08/08/25	RMJ
		TION: 4,683' AMSL		E-101	GROUNDING PLAN	0	08/08/25	RMJ
		FORMATION:		R-601	SUPPLEMENTAL		00/00/20	Tavio
PROJECT LOCATION DIRECTIONS		WEBER COUNTY D: 100390001		R-602	SUPPLEMENTAL			+
TROCEST EGONTION BINESTIONS		CT TEAM	-	R-603	SUPPLEMENTAL			+
	PROJEC	OT TEAW			-			+
FROM 8960 NE ALDERWOOD RD., PORTLAND OR 97002: GET ON I-205 S FROM NE CASCADES PKWY AND NE AIRPORT	TOWER OWNER:	APPLICANT:		R-604	SUPPLEMENTAL			+
WAY, FOLLOW I-84 E TO MARRIOTT-SLATERVILLE. TAKE EXIT 344 FROM I-84 E (722 MI). CONTINUE ON UT-39 W TO YOUR	AMERICAN TOWER 10 PRESIDENTIAL WAY	T-MOBILE WEST LLC 8960 NE ALDERWOOD RD.		R-605	SUPPLEMENTAL			+
DESTINATION (11.9 MI).	WOBURN, MA 01801	PORTLAND, OR 97002	PROJECT NOTES	R-606	SUPPLEMENTAL			
	ENGINEER:	PROPERTY OWNER:						
UTILITY COMPANIES	TEP	AMERICAN TOWERS LLC	THE FACILITY IS UNMANNED. A TECHNICIAN WILL VISIT THE SITE APPROXIMATELY ONCE A					
POWER COMPANY: PACIFICORP PHONE: (888) 221-7070	326 TRYON ROAD RALEIGH, NC 27603-3530	PO BOX 723597 ATLANTA, GA 31139-0597	MONTH FOR ROUTINE INSPECTION AND MAINTENANCE. 3. THE PROJECT WILL NOT RESULT IN ANY SIGNIFICANT LAND DISTURBANCE OR EFFECT OF STORM WATER DRAINAGE.					
TELEPHONE COMPANY: CENTURYLINK PHONE: (800) 244-1111	PLANNING APPLICANT / SITE ACQ:	T-MOBILE MW PM: PEGGY OWEN	4. NO SANITARY SEWER, POTABLE WATER OR TRASH DISPOSAL IS REQUIRED. 5. HANDICAP ACCESS IS NOT REQUIRED. 6. THE PROJECT DEPICTED IN THESE PLANS QUALIFIES AS AN					
Know what's below.	RACHEL BRUIN RBRUIN@DERNAGRP.COM 805-215-9444	PEGGY.OWEN@T-MOBILE.COM	6. THE PROJECT DEPICTED IN THESE PLANS QUALIFIES AS AN ELIGIBLE FACILITIES REQUEST ENTITLED TO EXPEDITED REVIEW UNDER 47 U.S.C. § 1455(A) AS A MODIFICATION OF AN EXISTING WIRELESS TOWER THAT INVOLVES THE COLLOCATION, REMOVAL, AND/OR REPLACEMENT OF TRANSMISSION EQUIPMENT THAT IS NOT A SUBSTANTIAL					

CHANGE UNDER CFR § 1.61000 (B)(7).

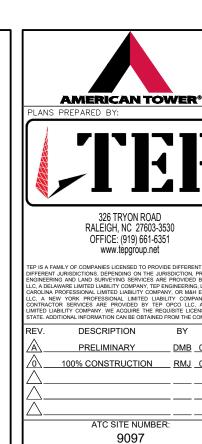

ATC SITE NAME:


OGDEN - I-15

T-MOBILE SITE NAME:

SL04748B

SITE ADDRESS:

OFF OF 12TH STREET; SECTION 18, TOWNSHIP 6 NORTH RANGE 3 WEST, SALT I

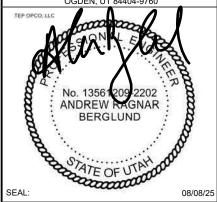

T · · Mobile ·

DATE DRAWN:	08/08/25
ATC JOB NO:	15342242
CUSTOMER NAME:	SL04748B
CUSTOMER ID:	SL04748B

TITLE SHEET

SHEET NUMBER

G-001

0

GENERAL CONSTRUCTION NOTES:

- OWNER FURNISHED MATERIALS, T-MOBILE "THE COMPANY" WILL PROVIDE AND THE CONTRACTOR WILL INSTALL
- A. BTS EQUIPMENT FRAME (PLATFORM) AND ICEBRIDGE SHELTER (GROUND BUILD/CO-LOCATE ONLY)
- AC/TELCO INTERFACE BOX (PPC)
- ICE BRIDGE (CABLE TRAY WITH COVER) (GROUND BUILD/CO-LOCATE ONLY, GC TO FURNISH AND INSTALL FOR ROOFTOP INSTALLATION)
- D. TOWERS, MONOPOLES
- TOWER LIGHTING
- GENERATORS & LIQUID PROPANE TANK
- G. ANTENNA STANDARD BRACKETS, FRAMES AND PIPES FOR MOUNTING
- ANTENNAS (INSTALLED BY OTHERS)
- TRANSMISSION LINE
- TRANSMISSION LINE JUMPERS
- TRANSMISSION LINE CONNECTORS WITH WEATHERPROOFING KITS
- TRANSMISSION LINE GROUND KITS
- HANGERS
- HOISTING GRIPS
- O. BTS EQUIPMENT
- THE CONTRACTOR IS RESPONSIBLE TO PROVIDE ALL OTHER MATERIALS FOR THE COMPLETE INSTALLATION OF THE SITE INCLUDING, BUT NOT LIMITED TO, SUCH MATERIALS AS FENCING, STRUCTURAL STEEL SUPPORTING SUB-FRAME FOR PLATFORM, ROOFING LABOR AND MATERIALS GROUNDING RINGS GROUNDING WIRES COPPER-CLAD OR XIT CHEMICAL GROUND ROD(S), BUSS BARS, TRANSFORMERS AND DISCONNECT SWITCHES WHERE APPLICABLE, TEMPORARY ELECTRICAL POWER, CONDUIT, LANDSCAPING COMPOUND STONE, CRANES, CORE DRILLING, SLEEPERS AND RUBBER MATTING, REBAR, CONCRETE CAISSONS, PADS AND/OR AUGER MOUNTS, MISCELLANEOUS FASTENERS, CABLE TRAYS, NON-STANDARD ANTENNA FRAMES AND ALL OTHER MATERIAL AND LABOR REQUIRED TO COMPLETE THE JOB ACCORDING TO THE DRAWINGS AND SPECIFICATIONS. IT IS THE POSITION OF T-MOBILE TO APPLY FOR PERMITTING AND CONTRACTOR RESPONSIBLE FOR PICKUP AND PAYMENT OF REQUIRED
- ALL WORK SHALL CONFORM TO ALL CURRENT APPLICABLE FEDERAL, STATE, AND LOCAL CODES, INCLUDING ANSI/EIA/TIA-222, AND COMPLY WITH ATC CONSTRUCTION
- CONTRACTOR SHALL CONTACT LOCAL 811 FOR IDENTIFICATION OF UNDERGROUND
- CONTRACTOR SHALL BE RESPONSIBLE FOR COORDINATING ALL REQUIRED
- ALL DIMENSIONS TO, OF, AND ON EXISTING BUILDINGS, DRAINAGE STRUCTURES, AND SITE IMPROVEMENTS SHALL BE VERIFIED IN FIELD BY CONTRACTOR WITH ALL DISCREPANCIES REPORTED TO THE ENGINEER.
- DO NOT CHANGE SIZE OR SPACING OF STRUCTURAL ELEMENTS
- DETAILS SHOWN ARE TYPICAL: SIMILAR DETAILS APPLY TO SIMILAR CONDITIONS UNLESS
- THESE DRAWINGS DO NOT INCLUDE NECESSARY COMPONENTS FOR CONSTRUCTION SAFETY WHICH SHALL BE THE SOLE RESPONSIBILITY OF THE CONTRACTOR
- CONTRACTOR SHALL BRACE STRUCTURES UNTIL ALL STRUCTURAL ELEMENTS NEEDED FOR STABILITY ARE INSTALLED. THESE ELEMENTS ARE AS FOLLOWS: LATERAL BRACING,
- CONTRACTOR SHALL DETERMINE EXACT LOCATION OF EXISTING UTILITIES, GROUNDS DRAINS, DRAIN PIPES, VENTS, ETC, BEFORE COMMENCING WORK
- INCORRECTLY FABRICATED, DAMAGED, OR OTHERWISE MISFITTING OR NONCONFORMING MATERIALS OR CONDITIONS SHALL BE REPORTED TO THE T-MOBILE REP PRIOR TO REMEDIAL OR CORRECTIVE ACTION, ANY SUCH REMEDIAL ACTION SHALL REQUIRE WRITTEN APPROVAL BY THE T-MOBILE REP PRIOR TO PROCEEDING.
- EACH CONTRACTOR SHALL COOPERATE WITH THE T-MOBILE REP, AND COORDINATE HIS WORK WITH THE WORK OF OTHERS.
- CONTRACTOR SHALL REPAIR ANY DAMAGE CAUSED BY CONSTRUCTION OF THIS PROJECT TO MATCH EXISTING PRE-CONSTRUCTION CONDITIONS TO THE SATISFACTION OF THE T-MOBILE CONSTRUCTION MANAGER.
- ALL CABLE/CONDUIT ENTRY/EXIT PORTS SHALL BE WEATHERPROOFED DURING INSTALLATION LISING A SILICONE SEALANT
- WHERE EXISTING CONDITIONS DO NOT MATCH THOSE SHOWN IN THIS PLAN SET. CONTRACTOR SHALL NOTIFY THE T-MOBILE REP AND ENGINEER OF RECORD
- CONTRACTOR SHALL ENSURE ALL SUBCONTRACTORS ARE PROVIDED WITH A COMPLETE AND CURRENT SET OF DRAWINGS AND SPECIFICATIONS FOR THIS PROJECT
- CONTRACTOR SHALL REMOVE ALL RUBBISH AND DEBRIS FROM THE SITE AT THE END OF
- CONTRACTOR SHALL COORDINATE WORK SCHEDULE WITH AMERICAN TOWER CORPORATION (ATC) AND TAKE PRECAUTIONS TO MINIMIZE IMPACT AND DISRUPTION OF OTHER OCCUPANTS OF THE FACILITY.
- CONTRACTOR SHALL FURNISH T-MOBILE AND AMERICAN TOWER CORPORATION (ATC) /ITH A PDF MARKED UP AS-BUILT SET OF DRAWINGS UPON COMPLETION OF WOR
- PRIOR TO SUBMISSION OF BID. CONTRACTOR SHALL COORDINATE WITH T-MOBILE REP TO DETERMINE WHAT, IF ANY, ITEMS WILL BE PROVIDED. ALL ITEMS NOT PROVIDED SHALL BE PROVIDED AND INSTALLED BY THE CONTRACTOR. CONTRACTOR WILL INSTALL

- 22. PRIOR TO SUBMISSION OF BID, CONTRACTOR SHALL COORDINATE WITH T-MOBILE REP TO DETERMINE IF ANY PERMITS WILL BE OBTAINED BY CONTRACTOR. ALL REQUIRED PERMITS NOT OBTAINED BY T-MOBILE MUST BE OBTAINED, AND PAID FOR, BY THE
- 23. CONTRACTOR SHALL INSTALL ALL SITE SIGNAGE IN ACCORDANCE WITH T-MOBILE SPECIFICATIONS AND REQUIREMENTS.
- 24. CONTRACTOR SHALL SUBMIT ALL SHOP DRAWINGS TO T-MOBILE FOR REVIEW AND
- ALL EQUIPMENT SHALL BE INSTALLED ACCORDING TO MANUFACTURER'S SPECIFICATIONS AND LOCATED ACCORDING TO T-MOBILE SPECIFICATIONS, AND AS SHOWN IN THESE PLANS
- 26. THE CONTRACTOR SHALL SUPERVISE AND DIRECT THE PROJECT DESCRIBED HEREIN. THE CONTRACTOR SHALL BE SOLELY RESPONSIBLE FOR ALL THE CONSTRUCTION MEANS, METHODS, TECHNIQUES, SEQUENCES AND PROCEDURES AND FOR COORDINATING ALL PORTIONS OF THE WORK UNDER THE CONTRACT.
- CONTRACTOR SHALL NOTIFY T-MOBILE REP A MINIMUM OF 48 HOURS IN ADVANCE OF POURING CONCRETE OR BACKFILLING ANY UNDERGROUND UTILITIES, FOUNDATIONS OR SEALING ANY WALL, FLOOR OR ROOF PENETRATIONS FOR ENGINEERING REVIEW AND
- WHEN THE PROJECT SCOPE REQUIRES THE USE OF THE SAFETY CLIMB, THE GENERAL CONTRACTOR SHALL ENSURE THE SAFETY CLIMB IS FREE OF OBSTRUCTIONS, NOT RUBBING ON OR TRAPPED BY ANY INSTALLED CUSTOMER EQUIPMENT, IS VISUALLY AUT, MEETS MANUFACTURER INSTALLATION SPECIFICATIONS, AND IS FIRMLY SECURED AT ALL CABLE GUIDE LOCATIONS UPON PROJECT COMPLETION
- COMPLETION OF PROJECT SHALL NOT OBSTRUCT, TRAP, LOOSEN, OR OTHERWISE CAUSE FAILURE TO MEET MANUFACTURER INSTALLATION REQUIREMENTS FOR THE SAFETY CLIMB.
- CONTRACTOR SHALL BE RESPONSIBLE FOR SITE SAFETY INCLUDING COMPLIANCE WITH ALL APPLICABLE OSHA STANDARDS AND RECOMMENDATIONS AND SHALL PROVIDE ALL NECESSARY SAFETY DEVICES INCLUDING PPE AND PPM AND CONSTRUCTION DEVICES SUCH AS WELDING AND FIRE PREVENTION, TEMPORARY SHORING, SCAFFOLDING, TRENCH BOXES/SLOPING, BARRIERS, ETC.
- THE CONTRACTOR SHALL PROTECT AT HIS OWN EXPENSE. ALL EXISTING FACILITIES AND SUCH OF HIS NEW WORK LIABLE TO INJURY DURING THE CONSTRUCTION PERIOD. ANY DAMAGE CAUSED BY NEGLECT ON THE PART OF THIS CONTRACTOR OR HIS DAMMAGE CAUSED 51 NEGLECT ON THE PART OF THIS CONTRACTOR OR HIS
 REPRESENTATIVES, OR BY THE ELEMENTS DUE TO NEGLECT ON THE PART OF THIS
 CONTRACTOR OR HIS REPRESENTATIVES, EITHER TO THE EXISTING WORK, OR TO HIS
 WORK OR THE WORK OF ANY OTHER CONTRACTOR, SHALL BE REPAIRED AT HIS EXPENSE TO THE OWNER'S SATISFACTION
- ALL WORK SHALL BE INSTALLED IN A FIRST CLASS, NEAT AND WORKMANLIKE MANNER BY MECHANICS SKILLED IN THE TRADE INVOLVED. THE QUALITY OF WORKMANSHIP SHALL BE SUBJECT TO THE APPROVAL OF THE T-MOBILE REP. ANY WORK FOUND BY THE T-MOBILE REP TO BE OF INFERIOR QUALITY AND/OR WORKMANSHIP SHALL BE REPLACED AND/OR REWORKED AT CONTRACTOR EXPENSE UNTIL APPROVAL IS
- IN ORDER TO ESTABLISH STANDARDS OF QUALITY AND PERFORMANCE, ALL TYPES OF MATERIALS LISTED HEREINAFTER BY MANUFACTURER'S NAMES AND/OR MANUFACTURER'S CATALOG NUMBER SHALL BE PROVIDED BY THESE MANUFACTURERS
- T-MOBILE FURNISHED EQUIPMENT SHALL BE PICKED-UP AT THE T-MOBILE WAREHOUSE, NO LATER THAN 48HR AFTER BEING NOTIFIED INSURED, STORED, UNCRATE, PROTECTED AND INSTALLED BY THE CONTRACTOR WITH ALL APPLIETENANCES REQUIRED TO PLACE THE EQUIPMENT IN OPERATION, READY FOR USE. THE CONTRACTOR SHALL BE RESPONSIBLE FOR THE EQUIPMENT AFTER PICKING IT UP.
- 35. T-MOBILE OR HIS ARCHITECT/ENGINEER RESERVES THE RIGHT TO REJECT ANY EQUIPMENT OR MATERIALS WHICH, IN HIS OWN OPINION ARE NOT IN COMPLIANCE WITH THE CONTRACT DOCUMENTS, EITHER BEFORE OR AFTER INSTALLATION AND THE EQUIPMENT SHALL BE REPLACED WITH EQUIPMENT CONFORMING TO THE REQUIREMENTS OF THE CONTRACT DOCUMENTS BY THE CONTRACTOR AT NO COST TO

SPECIAL CONSTRUCTION ANTENNA INSTALLATION NOTES:

- WORK INCLUDED:
 - ANTENNA AND COAXIAL CABLES ARE FURNISHED BY T-MOBILE UNDER A SEPARATE CONTRACT. THE CONTRACTOR SHALL ASSIST ANTENNA INSTALLATION CONTRACTOR IN TERMS OF COORDINATION AND SITE ACCESS. ERECTION SUBCONTRACTOR SHALL BE RESPONSIBLE FOR THE PROTECTION OF
 - B. INSTALL ANTENNAS AS INDICATED ON DRAWINGS AND T-MOBILE
 - C. INSTALL GALVANIZED STEEL ANTENNA MOUNTS AS INDICATED ON DRAWINGS.
 - D. INSTALL FURNISHED GALVANIZED STEEL OR ALUMINUM WAVEGUIDE
 - CONTRACTOR SHALL PROVIDE FOUR (4) SETS OF SWEEP TESTS USING ANRITZU-PACKARD 8713B RF SCALAR NETWORK ANALYZER. SUBMIT FREQUENCY DOMAIN REFLECTOMETER(FDR) TESTS RESULTS TO THE PROJECT MANAGER. SWEEP TESTS SHALL BE AS PER ATTACHED RES "MINIMUM FIELD TESTING RECOMMENDED FOR ANTENNA AND HELIAX COAXIAL CABLE SYSTEMS" DATED 10/5/93. TESTING SHALL BE PERFORMED BY AN INDEPENDENT TESTING SERVICE AND BE BOLIND AND SUBMITTED WITHIN ONE WEEK OF WORK COMPLETION
 - INSTALL COAXIAL CABLES AND TERMINATING BETWEEN ANTENNAS AND EQUIPMENT PER MANUFACTURER'S RECOMMENDATIONS, WEATHERPROOF ALL CONNECTIONS BETWEEN THE ANTENNA AND EQUIPMENT PER MANUFACTURER'S

REQUIREMENTS, TERMINATE ALL COAXIAL CABLE THREE (3) FEET IN EXCESS OF ENTRY PORT LOCATION UNLESS OTHERWISE STATED

- G. ANTENNA AND COAXIAL CABLE GROUNDING:
- ALL EXTERIOR #6 GREEN GROUND WIRE "DAISY CHAIN" CONNECTIONS ARE TO BE WEATHER SEALED WITH RFS CONNECTORS/SPLICE WEATHERPROOFING KIT #221213 OR
- ALL COAXIAL CABLE GROUNDING KITS ARE TO BE INSTALLED ON STRAIGHT RUNS OF

ALL DISCREPANCIES FROM WHAT IS SHOWN ON THESE CONSTRUCTION DRAWINGS SHALL BE COMMUNICATED TO ATC ENGINEERING IMMEDIATELY FOR CORRECTION OR RE-DESIGN. FAILURE TO COMMUNICATE DIRECTLY WITH ATC ENGINEERING OR ANY CHANGES FROM THE DESIGN CONDUCTED WITHOUT PRIOR APPROVAL FROM ATC ENGINEERING SHALL BE THE SOLE RESPONSIBILITY OF THE GENERAL CONTRACTOR.





RALEIGH, NC 27603-3530 OFFICE: (919) 661-6351 www.tèpgroup.net

EP IS A FAMILY OF COMPANIES LICENSED TO PROVIDE DIFFERENT SERVICES IFFERENT JURISDICTIONS. DEPENDING ON THE JURISDICTION, PROFESSION, NGINEERING AND LAND SURVEYING SERVICES ARE PROVIDED BY TEP OPC ENGINEERING AND LAND SURVEYING SERVICES ARE PROVIDED BY TEP OPC LUC, A DELAWARE LIMITED LIABILITY COMPANY, TEP ENGINEERING, LLC, A NORT CAROLINA PROFESSIONAL LIMITED LIABILITY COMPANY, OR MAI ENGINEERIN LUC, A NEW YORK PROFESSIONAL LIMITED LIABILITY COMPANY, GENER CONTRACTOR SERVICES ARE PROVIDED BY TEP OPCO LUC, A DELAWAR LIMITED LIABILITY COMPANY. WE ACQUIRE THE REQUISITE LICENSES IN EAC STATE. ADDITIONAL INFORMATION CAN BE OBTAINED FROM THE COMPANY.

REV.	DESCRIPTION	BY	DATE
\mathbb{A}_{-}	PRELIMINARY	<u>DMB</u>	07/09/25
<u> </u>	100% CONSTRUCTION	RMJ	08/08/25
$\overline{\wedge}$			
$\overline{\wedge}^{-}$			
$\overline{\wedge}$			
	ATO CITE NILIMBED.		
	ATC SITE NUMBER:		

9097

ATC SITE NAME:


OGDEN - I-15

T-MOBILE SITE NAME:

SL04748B

SITE ADDRESS:

OFF OF 12TH STREET SECTION 18, TOWNSHIP 6 NORTH RANGE 3 WEST, SALT I

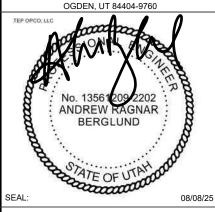


DATE DRAWN: 08/08/25 ATC JOB NO: 15342242 CUSTOMER NAME: SL04748B CUSTOMER ID: SI 04748B

GENERAL NOTES

SHEET NUMBER:

G-002

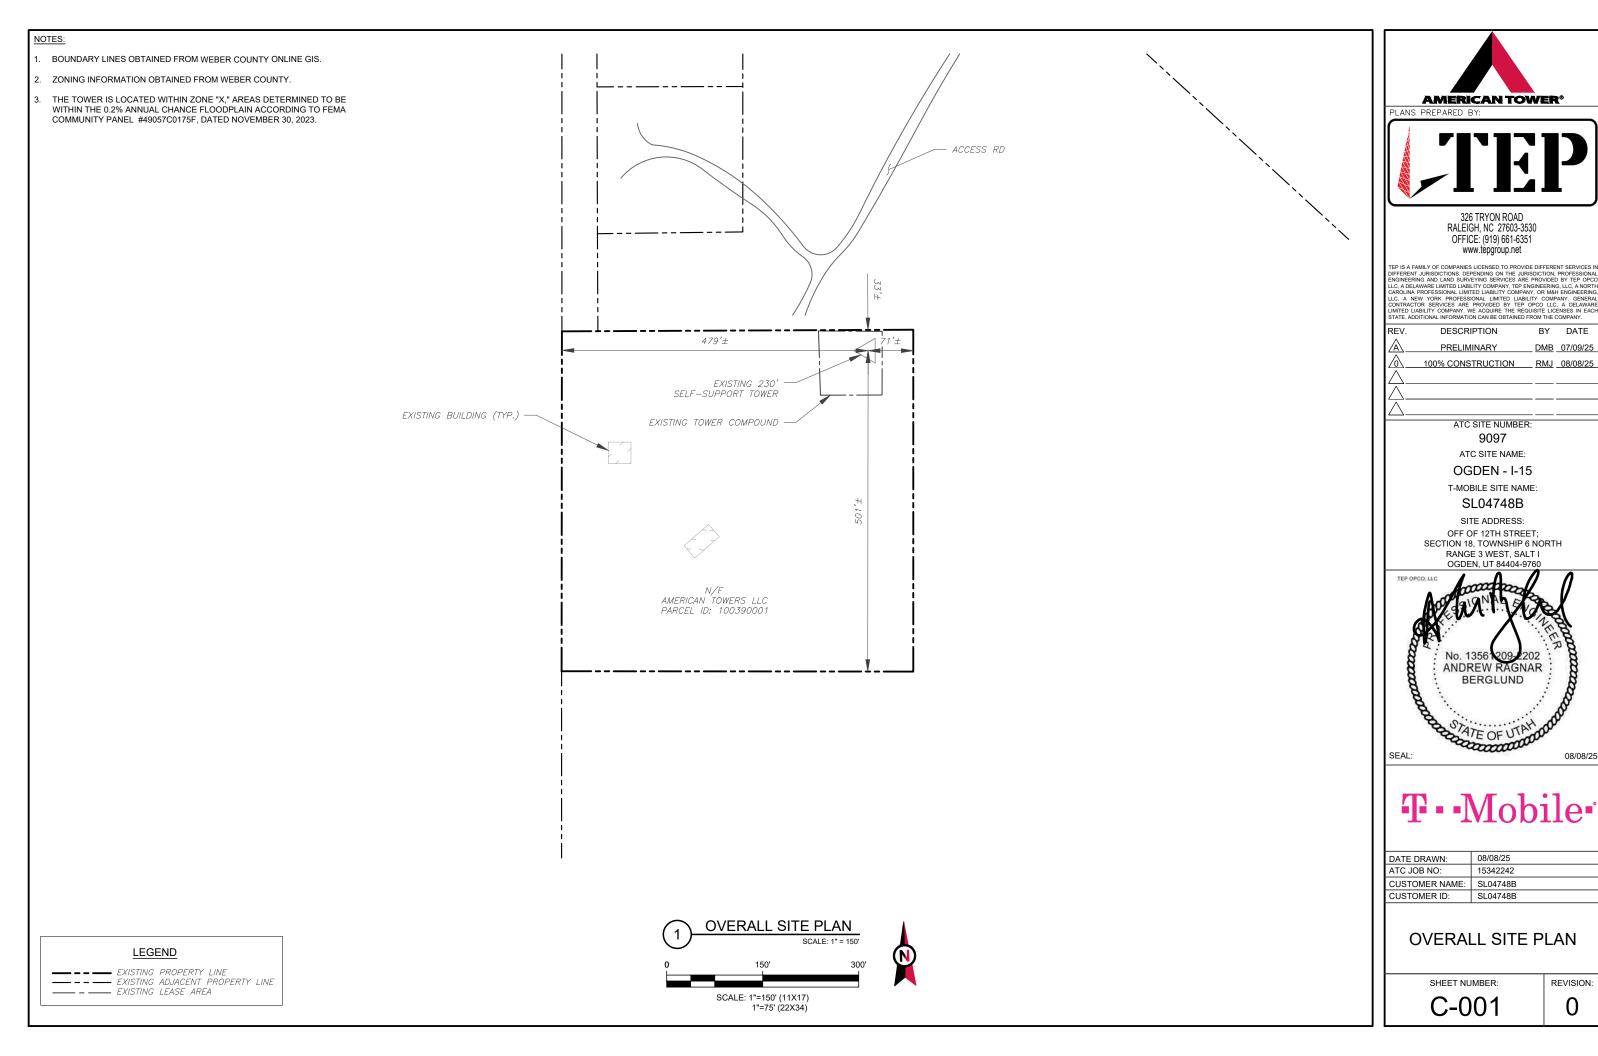

DMB 07/09/25

REVISION:

0


SITE PLAN NOTES:


- 1. THIS SITE PLAN REPRESENTS THE BEST PRESENT KNOWLEDGE AVAILABLE TO THE ENGINEER AT THE TIME OF THIS DESIGN. THE CONTRACTOR SHALL VISIT THE SITE PRIOR TO CONSTRUCTION AND VERIFY ALL EXISTING CONDITIONS RELATED TO THE SCOPE OF WORK FOR THIS PROJECT.
- 2. ICE BRIDGE, CABLE LADDER, COAX PORT, AND COAX CABLE ARE SHOWN FOR REFERENCE ONLY. CONTRACTOR SHALL CONFIRM THE EXACT LOCATION OF ALL PROPOSED AND EXISTING EQUIPMENT AND STRUCTURES DEPICTED ON THIS PLAN. BEFORE UTILIZING EXISTING CABLE SUPPORTS, COAX PORTS, INSTALLING NEW PORTS OR ANY OTHER EQUIPMENT, CONTRACTOR SHALL VERIFY ALL ASPECTS OF THE COMPONENTS MEET THE ATC SPECIFICATIONS.

LEGEND 8 GROUNDING TEST WELL ATS AUTOMATIC TRANSFER SWITCH BOLLARD В CSC CELL SITE CABINET D DISCONNECT Ε ELECTRICAL **FIBER** GEN **GENERATOR** G GENERATOR RECEPTACLE HH, V HAND HOLE, VAULT ΙB ICE BRIDGE KENTROX BOX Κ LIGHTING CONTROL LC РΒ PULL BOX PP POWER POLE TELCO TRN TRANSFORMER CHAINLINK FENCE

PROPOSED CABLE NOTES:

- ESTIMATED LENGTH OF PROPOSED CABLE IS <u>250</u>'. ESTIMATED LENGTH OF CABLE WAS PROVIDED BY CUSTOMER OR CALCULATED BY ADDING THE RAD CENTER AND THE DISTANCE FROM THE SHELTER ENTRY PLATE TO THE TOWER (ALONG THE ICE BRIDGE) AND A SAFETY FACTOR MEASUREMENT OF 15% (OF THE TWO PREVIOUS VALUES), CDS DEFER TO GREATEST CABLE LENGTH.
- 2. ROUTE PROPOSED CABLES ALONG SAME PATH AS EXISTING CABLES AND IN ACCORDANCE WITH STRUCTURAL ANALYSIS. WHERE POSSIBLE UTILIZE EXISTING CABLE SUPPORT STRUCTURES AS PROVIDED FOR CARRIER TO ADEQUATELY SECURE CABLES, USING EITHER APPROPRIATELY SIZED STAINLESS STEEL SNAP-INS OR MOUNTING HARDWARE AND BRACKETS AS SPECIFIED BY CABLE MANUFACTURER. OTHERWISE, ATTACH CABLES TO HORIZONTAL OR DIAGONAL TOWER MEMBERS USING PROPOSED STAINLESS STEEL ADAPTERS (DO NOT ATTACH TO TOWER LEG).

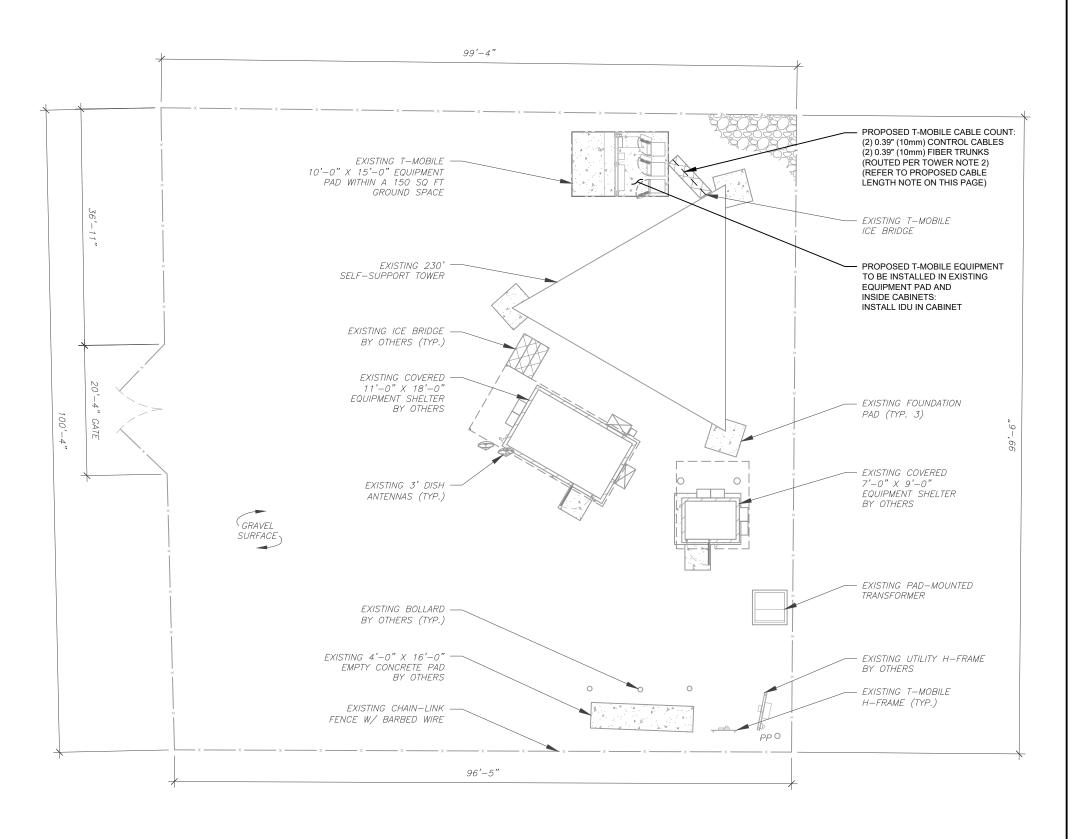

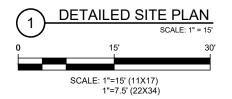





PLANS PREPARED BY:



326 TRYON ROAD RALEIGH, NC 27603-3530 OFFICE: (919) 661-6351 www.tepgroup.net

TEP IS A FAMILY OF COMPANIES LICENSED TO PROVIDE DIFFERENT SERVICES IN DIFFERENT JURISDICTIONS, DEPENDING ON THE JURISDICTION, PROFESSIONAL ENGINEERING AND LAND SURVEYING SERVICES ARE PROVIDED BY TEP OPC. LLC, A DELAWARE LIMITED LABILITY COMPANY, TEP ENGINEERING, LLC, A NORTH CAROLINA PROFESSIONAL LIMITED LABILITY COMPANY, OR MAIN HENDINEERING LLC, A NEW YORK PROFESSIONAL LIMITED LIABILITY COMPANY, GENERAL CONTRACTOR SERVICES ARE PROVIDED BY TEP OPCO LLC. A DELAWARE LIMITED LIABILITY COMPANY WE ADMITTED THE PROFINE LICENSE DE LABILITY COMPANY. WE ADMITTED THE PROFINE LICENSES IN EACH STATE ADDITIONAL INFORMATION CAM BE OBTAINED FROM THE COMPANY.

REV.	DESCRIPTION	BY	DATE
\mathbb{A}_{-}	PRELIMINARY	DMB	07/09/25
$\overline{\wedge}$	100% CONSTRUCTION	RMJ	08/08/25
$\overline{\wedge}$			
$\overline{\wedge}$			
\square			

ATC SITE NUMBER: 9097

ATC SITE NAME:

OGDEN - I-15

T-MOBILE SITE NAME:

SL04748B

SITE ADDRESS:

OFF OF 12TH STREET; SECTION 18, TOWNSHIP 6 NORTH RANGE 3 WEST, SALT I



T · · Mobile ·


DATE DRAWN:	08/08/25
ATC JOB NO:	15342242
CUSTOMER NAME:	SL04748B
CUSTOMER ID:	SL04748B


DETAILED SITE PLAN

SHEET NUMBER:

C-101

0

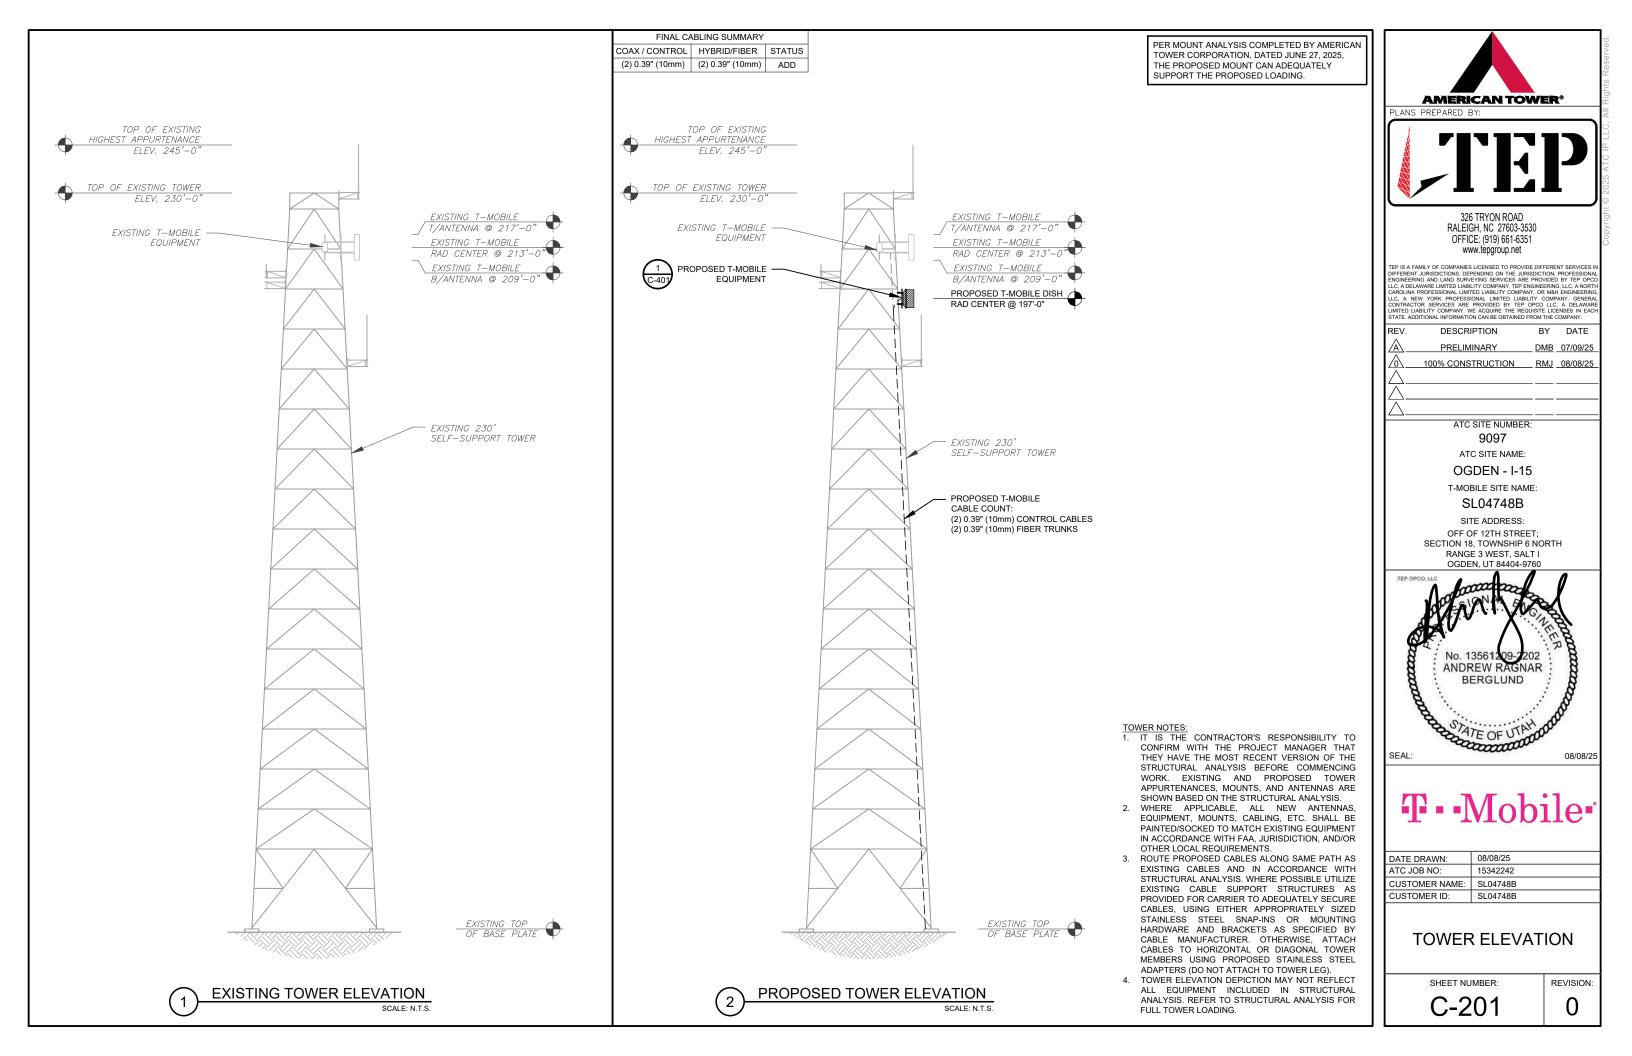

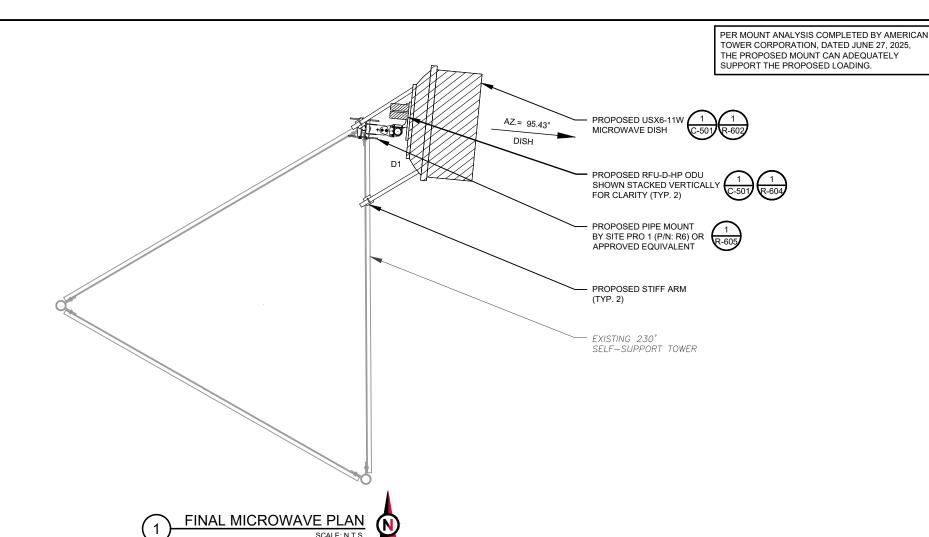

	FINAL MICROWAVE SCHEDULE								
1.	RY	NON MICROWAVE SUMMA	LOCATION MICROWAVE SUMMARY						
3	STATUS	ADDITIONAL TOWER MOUNTED EQUIPMENT	STATUS	BAND	MICROWAVE	POS	AZ	RAD	SECTOR
	ADD	(2) RFU-D-HP	ADD	-	USX6-11W	D1	95.43°	197'	DISH

NOTES CONFIRM WITH T-MOBILE REP FOR APPLICABLE UPDATES/REVISIONS AND MOST RECENT RFDS FOR NSN CONFIGURATION (CONFIG). GC TO CAP ALL UNUSED PORTS.

CONFIRM SPACING OF
PROPOSED EQUIP DOES NOT
CAUSE TOWER CONFLICTS
NOR IMPEDE TOWER CLIMBING

. TEP DID NOT VERIFY THE EXISTING LOADING. LOADING DATA PROVIDED BY ATC AND T-MOBILE.

STATUS ABBREVIATIONS

RMV: TO BE REMOVED RMN: TO REMAIN REL: TO BE RELOCATED ADD: TO BE ADDED

CABLE LENGTHS FOR JUMPERS

JUNCTION BOX TO RRU: 15' RRU TO ANTENNA: 10'

EQUIPMENT SCHEDULES

FINAL FIBER DISTRIBUTION /	OVP BOX	FINAL CABLING SUMMARY		
MODEL NUMBER	STATUS	COAX / CONTROL	HYBRID/FIBER	STATUS
-	-	(2) 0.39" (10mm)	(2) 0.39" (10mm)	ADD





326 TRYON ROAD RALEIGH, NC 27603-3530 OFFICE: (919) 661-6351 www.tepgroup.net

TEP IS A FAMILY OF COMPANIES LICENSED TO PROVIDE DIFFERENT SERVICES IN DIFFERENT JURISDICTIONS. DEPENDING ON THE JURISDICTION, PROFESSIONAL ENGINEERING AND LAND SURVEYING SERVICES ARE PROVIDED BY TEP OPCO LIC, A DELAWARE LIMITED LIABILITY COMPANY, TEP ENGINEERING, LIC, A NORTH CAROLINA PROFESSIONAL LIMITED LIABILITY COMPANY, OR MAH ENGINEERING, LIC, A NEW YORK PROFESSIONAL LIMITED LIABILITY COMPANY, GENERAL CONTRACTOR SERVICES ARE PROVIDED BY TEP OPCO LIC, A DELAWARE LIMITED LIABILITY COMPANY, WE ACQUIRE THE REQUISITE LICENSES IN EACH STATE. ADDITIONAL INFORMATION CAN BE OBTAINED FROM THE COMPANY.

REV.	DESCRIPTION	BY	DATE
\mathbb{A}_{-}	PRELIMINARY	<u>DMB</u>	07/09/25
\wedge	100% CONSTRUCTION	RMJ	08/08/25
$\overline{\wedge}$	•		
$\overline{\square}$			
\square			

ATC SITE NUMBER: 9097

ATC SITE NAME:


OGDEN - I-15

T-MOBILE SITE NAME:

SL04748B

SITE ADDRESS:

OFF OF 12TH STREET; SECTION 18, TOWNSHIP 6 NORTH RANGE 3 WEST, SALT I OGDEN, UT 84404-9760

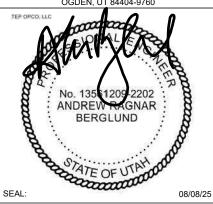



	DATE DRAWN:	08/08/25
	ATC JOB NO:	15342242
	CUSTOMER NAME:	SL04748B
	CUSTOMER ID:	SL04748B


MICROWAVE INFORMATION & SCHEDULE

SHEET NUMBER:

C-401

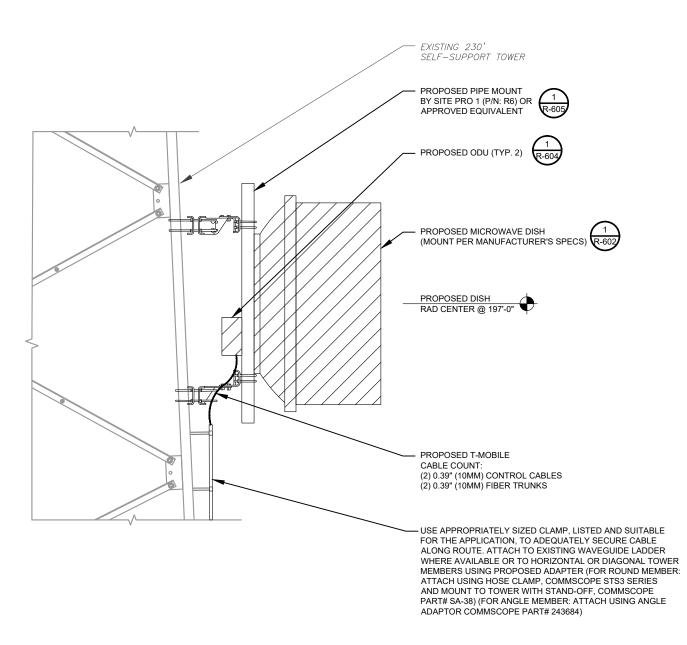

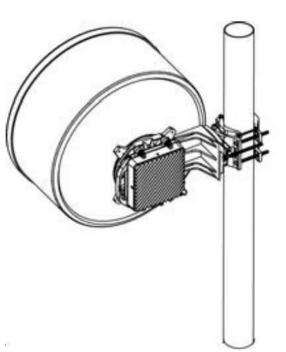

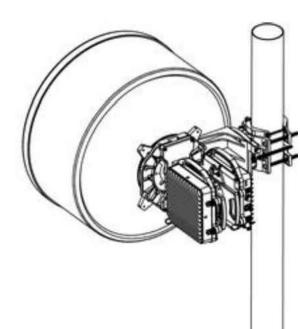

PROPOSED MICROWAVE MOUNTING DETAIL (ELEVATION)

1 PROPOSED ODU MOUNTING DETAIL

SCALE: NOT TO SCALE

AMERICAN TOWER®
PLANS PREPARED BY:



326 TRYON ROAD RALEIGH, NC 27603-3530 OFFICE: (919) 661-6351 www.tepgroup.net

TEP IS A FAMILY OF COMPANIES LICENSED TO PROVIDE DIFFERENT SERVICES IN DIFFERENT SURJISSICTIONS. DEPENDING ON THE JURISDICTION, PROFESSIONAL ENGINEERING AND LAND SURVEYING SERVICES ARE PROVIDED BY TEP OPCO. LIC., A DELAWARE LIMITED LIABILITY COMPANY, TEP PROINTEERING, LIC, A NORTH CARCUNA PROFESSIONAL LIMITED LIABILITY COMPANY, OR MAH ENGINEERING, LIC, A NEW YORK PROFESSIONAL LIMITED LIABILITY COMPANY, OR MAH ENGINEERING, LIC, A NEW YORK PROFESSIONAL LIMITED LIABILITY COMPANY OR SERVICES ARE PROVIDED BY TEP OPCO LIC, A DELAWARE LIMITED LIABILITY COMPANY, WE ACQUIRE THE REQUISITE LICENSES IN EACH

1	REV	. DESCRIPTION	BY	DATE
	A	PRELIMINARY	<u>DMB</u>	07/09/25
	⋒	100% CONSTRUCTION	RMJ	08/08/25
	$\overline{\triangle}$			
	$\overline{\wedge}$			

ATC SITE NUMBER: 9097

ATC SITE NAME:


OGDEN - I-15

T-MOBILE SITE NAME:

SL04748B

SITE ADDRESS:

OFF OF 12TH STREET; SECTION 18, TOWNSHIP 6 NORTH RANGE 3 WEST, SALT I OGDEN, UT 84404-9760

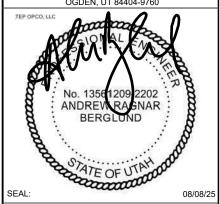

T · · Mobile ·

	DATE DRAWN:	08/08/25
	ATC JOB NO:	15342242
	CUSTOMER NAME:	SL04748B
	CUSTOMER ID:	SL04748B


CONSTRUCTION DETAILS

SHEET NUMBER:

C-501





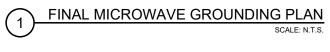





PLANS PREPARED BY:



326 TRYON ROAD RALEIGH, NC 27603-3530 OFFICE: (919) 661-6351 www.tepgroup.net

TEP IS A FAMILY OF COMPANIES LICENSED TO PROVIDE DIFFERENT SERVICES IN DIFFERENT SIXTURISDICTIONS. DEPENDING ON THE JURISDICTION, PROFESSIONAL ENGINEERING AND LAND SURVEYING SERVICES ARE PROVIDED BY TEP OPCO. LIC., A DELAWARE LIMITED LIABILITY COMPANY, TEP ENGINEERING, LIC., A NORTH CAROLINA PROFESSIONAL LIMITED LIABILITY COMPANY, OR MAI HENGINEERING, LIC., A NEW YORK PROFESSIONAL LIMITED LIABILITY COMPANY, OR MAI HENGINEERING, LIC., A NEW YORK PROFESSIONAL LIMITED LIABILITY COMPANY, GENERAL CONTRACTOR SERVICES ARE PROVIDED BY TEP OPCO LIC., A DELAWARE LIMITED LIABILITY COMPANY, WE ACQUIRE THE REQUISITE LICENSES IN EACH

REV.	DESCRIPTION	BY	DATE
\mathbb{A}_{-}	PRELIMINARY	DMB	07/09/25
\wedge _	100% CONSTRUCTION	RMJ	08/08/25
$\overline{\wedge}$			
$\overline{\wedge}^{-}$			
\square			

ATC SITE NUMBER: 9097

3031

ATC SITE NAME:

OGDEN - I-15

T-MOBILE SITE NAME:

SL04748B

SITE ADDRESS:

OFF OF 12TH STREET; SECTION 18, TOWNSHIP 6 NORTH RANGE 3 WEST, SALT I

No. 1356 209 2202
ANDREV RALNAR
BERGLUND

T··Mobile·

	DATE DRAWN:	08/08/25
	ATC JOB NO:	15342242
	CUSTOMER NAME:	SL04748B
	CUSTOMER ID:	SL04748B


GROUNDING PLAN

SHEET NUMBER:


REVISION:

E-101

0

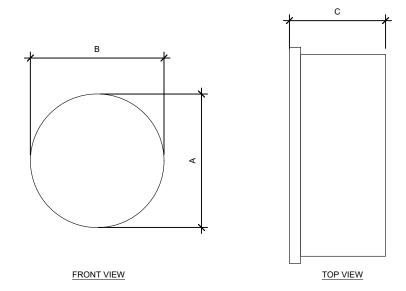

MICROWAVE SPECIFICATIONS				
MICROWAVE MODEL	А	В	С	WEIGHT (LBS)
USX6-11W	6.23'	6.23'	5.02'	198.4

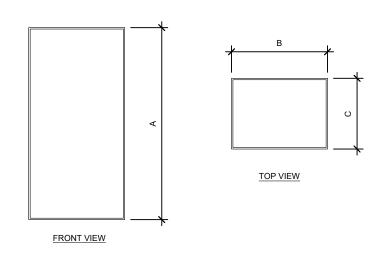

ODU SPECIFICATIONS				
ODU MODEL	Α	В	С	WEIGHT (LBS)
RFU-D-HP	12.6"	11.3"	4.2"	26.5

SUPPLEMENTAL

REVISION:

SHEET NUMBER:

R-601

EQUIPMENT SPECIFICATIONS
SCALE: N.T.S.

USX6-11W



1.8m | 6ft Sentinel® Ultra High Performance, Super High XPD Antenna, dual-polarized, 10.000 – 11.700 GHz

Product Classification

Product Type Microwave antenna **Product Brand** Sentinel®

General Specifications

Antenna Type USX - Sentinel® Ultra High Performance, Super High XPD Antenna, dual-polarized

Polarization Dual Side Struts, Included Side Struts, Optional

Dimensions

Diameter, nominal 1.8 m | 6 ft

Electrical Specifications

10.000 - 11.700 GHz **Operating Frequency Band**

42.9 dBi Gain, Low Band Gain, Mid Band 43.6 dBi 44.3 dBi Gain, Top Band **Boresite Cross Polarization Discrimination (XPD)** 40 dB Front-to-Back Ratio 85 dB Beamwidth, Horizontal 1.1° 1.1 ° Beamwidth, Vertical Return Loss 26 dB 1.1

Radiation Pattern Envelope Reference (RPE) 7375 | 7402


Electrical Compliance ACMA FX03_10a | ACMA FX03_11a | Canada

SRSP 310.5 | Canada SRSP 310.7 Part A | Canada SRSP 310.7 Part B | ETSI 302 217

Page 1 of 7

USX6-11W

Antenna Dimensions and Mounting Information

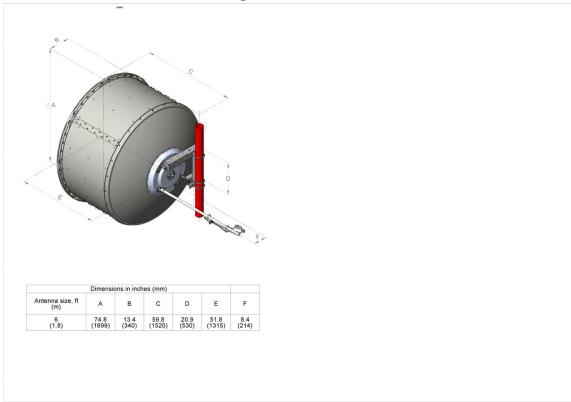

Wind Forces at Wind Velocity Survival Rating

Axial Force (FA) 6960 N | 1,564.671 lbf Angle α for MT Max -130° Side Force (FS) 2049 N | 460.634 lbf Twisting Moment (MT) 4948 N-m | 43,793.488 in lb Force on Inboard Strut Side 6187 N | 1,390.893 lbf Zcg without Ice 498 mm | 19.606 in Zcg with 1/2 in (12 mm) Radial Ice 689 mm | 27.126 in Weight with 1/2 in (12 mm) Radial Ice 291 kg | 641.544 lb

Page 3 of 7

©2023 CommScope, Inc. All rights reserved. CommScope and the CommScope logo are registered trademarks of CommScope and/or its affiliates in the U.S. and other countries. For additional trademark information see https://www.commscope.com/trademarks. All product names, trademarks and registered trademarks are property of their respective owners. Revised: June 6, 2023



©2023 CommScope, Inc. All rights reserved. CommScope and the CommScope logo are registered trademarks of CommScope and/or its affiliates in the U.S. and other countries. For additional trademark information see https://www.commscope.com/trademarks. All product names, trademarks and registered trademarks are property of their respective owners. Revised: June 6, 2023



SUPPLEMENTAL

SHEET NUMBER:


R-602

REVISION

NOTE: THIS SHEET WAS CREATED BY OTHERS AND PROVIDED AT THE REQUEST OF THE CUSTOMER WITHOUT EDIT.

iQ.link — Link Budget Report

Date Printed: [DATE]Link ID: 4010023Region: WestCreate Date: 25-FEB-2025Link Name: SL01312A_SL04748BCreated By: KSalced20

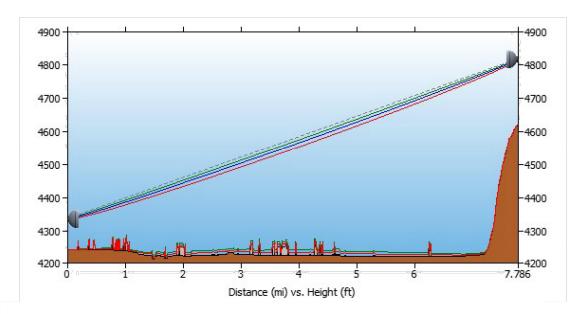

Path length (7.79 mi)

SL01312A		
Latitude:	41-14-39.5 N	
Longitude:	112-05-15.9 W	
Azimuth:	275.52 Deg	
Elevation:	4238.85 ft	
Antenna CL:	95.00 ft AGL	

Frequency (GHz) = 11.00 GHz		
K1:	[PL-K1]	
%F1:	[PL-F1]	
K2:	[PL-K2]	
%F2:	[PL-F2]	
K3:	[PL-K3]	
%F3:	IPL-F31	

SL04748B		
Latitude:	41-15-18.3 N	
Longitude:	112-14-11.6 W	
Azimuth:	95.43 Deg	
Elevation:	4619.42 ft	
Antenna CL:	197.00 ft AGL	

Transmission details SL01312A [CLUSTER_ID_A] WSIF828 QWE500 Selected [1_95_STATUS_A]	SL04748B [CLUSTER_ID_B] WSIF838 1018738 [AAV_CONTRACT_ID_B]
[CLUSTER_ID_A] WSIF828 QWE500 Selected	[CLUSTER_ID_B] WSIF838 1018738 [AAV_CONTRACT_ID_B]
WSIF828 QWE500 Selected	WSIF838 1018738 [AAV_CONTRACT_ID_B]
QWE500 Selected	1018738 [AAV_CONTRACT_ID_B]
Selected	[AAV_CONTRACT_ID_B]
Selected	
[1_95_STATUS_A]	Not Available
	[1_95_STATUS_B]
41-14-39.5 N	41-15-18.3 N
112-05-15.9 W	112-14-11.6 W
275.52 Deg	95.43 Deg
0.63 Up	0.71 Down
4238.85 ft	4619.42 ft
USX6-11W	USX6-11W
ANDREW CORPORATION	ANDREW CORPORATION
291	291
43.60 dBi	43.60 dBi
5.91 ft	5.91 ft
95.00 ft AGL	197.00 ft AGL
5.10 dB/5.10 dB	4.60 dB/4.60 dB
0.00 dB	0.00 dB
11.00	GHz
7.79	9 mi
135.2	24 dB
0.18	3 dB
0.00 dB	(oLOS)
1.00) dB
58.92 dB	58.92 dB
4+0/DP/RM	4+0/DP/DM
IP20D-HP11-80X-A_4501	IP20D-HP11-80X-A_4501
Ceragon Networks	Ceragon Networks
	112-05-15.9 W 275.52 Deg 0.63 Up 4238.85 ft USX6-11W ANDREW CORPORATION 291 43.60 dBi 5.91 ft 95.00 ft AGL 5.10 dB/5.10 dB 11.00 7.79 135.2 0.18 0.00 dB 1.00 58.92 dB 4+0/DP/RM IP20D-HP11-80X-A_4501

SUPPLEMENTAL

SHEET NUMBER:

REVISION:

R-603

TRANSMISSION DETAILS
SCALE: N.T.S.




RFU-D HP Overview and Wiring Diagram

Refer to the RFU-D Installation Guide for instructions on proper grounding of the RFU-D, Lightning Protector and Ethernet cabling. Information can also be found in the Installation Guide on proper cable installation.

Follow the below guidelines for maximum cable lengths.

Interface	Cable Type	Maximum Length
Optical	Fiber	300m
Electrical	CAT-5e (24 AWG)	150m
Electrical	CAT-6a (22 AWG)	150m
	DC (14 AWG)	100m
DC Power	DC (12 AWG)	180m
	DC (10 AWG)	101m-300m

RFU-D HP Interfaces

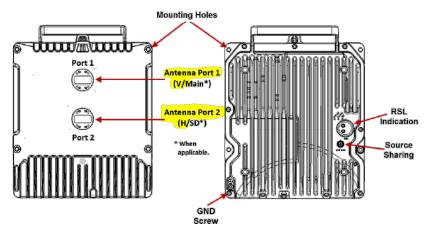

- PWR: DC power interface (-48VDC)
- P1: RFU Interface (RJ-45)
- P2: RFU Interface (SFP)
- P3: Data Sharing
- P4: Reserved for future use.

Note: Note that in RFU-D-HP, Port 1 is the upper port, located closest to the handle, and Port 2 is the lower port, located closest to the Ethernet ports.

Ceragon Networks Proprietary and Confidential
Page 6 of 10
March 2021

Table 178: RFU-D Mechanical Specifications (including diplexer unit)

RFU-D Dimensions
Height: 9.05 inches
Width: 9.17 inches
Depth: 3.85 inches
Weight: 14.33 lbs.

Table 179: RFU-D-HP Mechanical Specifications (including diplexer or OCU unit)

RFU-D-HP Dimensions

Height: 12.56 inches

Width: 11.26 inches

Depth: 4.21 inches

Weight: 26.5 lbs.


SUPPLEMENTAL

SHEET NUMBER:

REVISION:

PROPOSED RFU-D-HP DETAIL

SCALE: N.T.S.

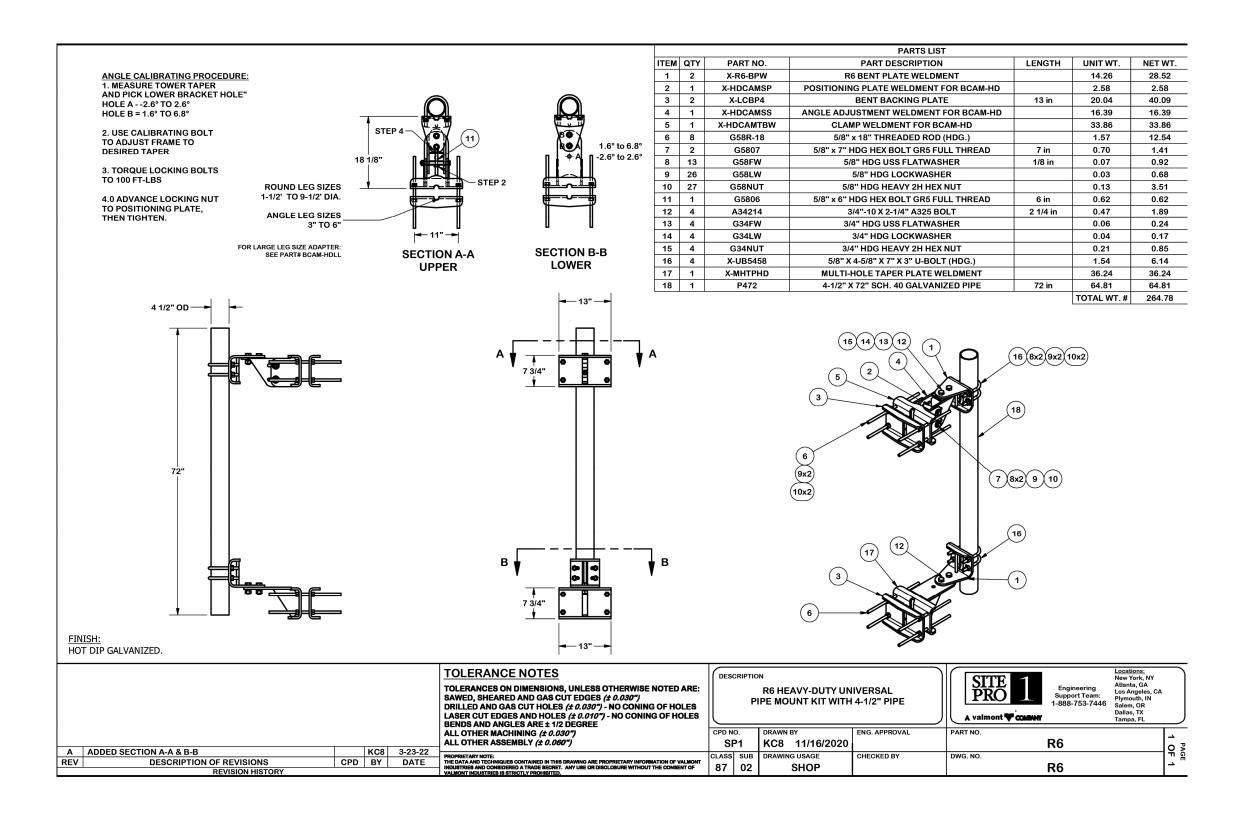

SUPPLEMENTAL

SHEET NUMBER:

REVISION

R-605



Eng. Number 15342242_C8_01 June 27, 2025 Page 2 AMERICAN TOWER®

Eng. Number 15342242_C8_01 June 27, 2025 Page 3

Mount Analysis Report

Mount Type : Stand-Off

ATC Asset Name : OGDEN - I-15

ATC Asset Number : 9097

Engineering Number: 15342242_C8_01

Mount Elevation : 197 ft

Proposed Carrier : T-Mobile

Carrier Site Name : SL04748B

Carrier Site Number : SL04748B

Site Location : Off of 12th Street; Section 18, Township 6 North, Range 3

West, Salt I

Ogden, UT 84404-9760

41.2551, -112.2366

County : Weber

Date : June 27, 2025

Max Usage : 33%
Analysis Result : Pass

Prepared By: Cristian Urquiza Engineering Intern





Introduction

The purpose of this report is to summarize results of the mount analysis performed for T-Mobile at 197 ft.

Supporting Documents

Specifications Sheet:	Site Pro 1 R6, dated November 16, 2020
Radio Frequency Data Sheet:	RFDS ID #SL04748B, dated March 12, 2025
Reference Photos:	Site photos from 2022

Analysis

This mount was analyzed using American Tower Corporation's Mount Analysis Program and RISA-3D

Basic Wind Speed:	103 mph (3-Second Gust)
Basic Wind Speed w/ Ice:	53 mph (3-Second Gust) w/ 0.24" radial ice concurrent
Codes:	ANSI/TIA-222-I / 2021 IBC
Exposure Category:	C
Risk Category:	II .
Topographic Factor Procedure:	Method 1
Feature:	Flat
Crest Height (H):	438 ft
Crest Length (L):	3592 ft
Spectral Response:	Sds = 0.74, Sd1 = 0.48
Site Class:	D - Stiff Soil
Live Loads:	Lm = 500 lbs, Lv = 250 lbs

^{*}Live Load(s) reduction is confirmed to either not govern or not be applicable

Conclusion

Based on the analysis results, the antenna mount meets the requirements per the applicable codes listed above. The mount can support the equipment as described in this report.

• Analysis based on new installation of Site Pro 1 R6 Stand-Off(s).

If you have any questions or require additional information, please reach out to your American Tower contact. If you do not have an American Tower contact and have an Engineering question, please contact

MountAnalysis@americantower.com. Please include the American Tower site name, site number, and engineering number in the subject line for any questions.

ATC Tower Services, LLC - 1 Fenton Main, Suite 300 - Cary, NC 27511 - 919.468.0112 Office - 919.466.5414 Fax - www.americantower.com

ATC Tower Services, LLC - 1 Fenton Main, Suite 300 - Cary, NC 27511 - 919.468.0112 Office - 919.466.5414 Fax - www.americantower.com

- MOUNT ANALYSIS

NOTE: THIS SHEET WAS CREATED BY OTHERS AND PROVIDED AT THE REQUEST OF THE CUSTOMER WITHOUT EDIT. PLEASE REFERENCE THE MOUNT ANALYSIS REPORT FOR COMPLETE MOUNT ANALYSIS CALCULATIONS AND DETAILS. SUPPLEMENTAL PAGES INCLUDED IN THE CONSTRUCTION DRAWINGS ARE FOR REFERENCE ONLY, GENERAL CONTRACTOR IS TO VERIFY THEY HAVE THE MOST RECENT MOUNT ANALYSIS PRIOR TO CONSTRUCTION.

SUPPLEMENTAL

SHEET NUMBER:

R-606

_